

TYPICAL JACK CUTS

TYPICAL END DETAIL

FRONT ELEVATION

ROOF PLAN

BEARING WALL & BEAM HEIGHTS

BEARING WALL & BEAM HEIGHTS	ELEV.
10'-0" A.F.F.	0'-0"
12'-0" A.F.F.	+2'-0"
16'-0" A.F.F.	+6'-0"
12'-1 1/2" A.F.F.	+2'-1 1/2"

DR HORTON HANGER SCHEDULE

USP HUS 28	USP THDH 28-3
(C)	(M)
(F)	(N)
(H)	(P)
(I)	(B)
(V)	(X)

DESIGN CRITERIA

ITEM	VALUE
TOP CHORD LIVE LOAD	20
TOP CHORD DEAD LOAD	20
BOTTOM CHORD LIVE LOAD	10
BOTTOM CHORD DEAD LOAD	10
TOTAL LOAD	50
DURATION FACTOR	1.25
WIND DESIGN SPEED (MPH)	160
ASCE 7-10 CAT II	160
CLOSED	160
MAX. WALL HT FOR WIND LOAD	16'-0"

REMARKS:

- ALL TRUSSES 24" o.c. UNLESS NOTED OTHERWISE
- *****CAUTION*****
- DO NOT ATTEMPT TO ERECT TRUSSES WITHOUT REFERRING TO THE ENGINEERING DWGS.
- IT IS NECESSARY TO REFER TO THE ENGINEERING DRAWINGS FOR MEMBER, BEARING LOCATION, ORIENTATION AND WEB BRACING
- REFER TO WTCA/TP1 BSCI-B1 SUMMARY SHEET FOR HANDLING METHODS & TEMPORARY BRACING, WHICH IS ALWAYS REQUIRED
- BEARING HEIGHTS BASED ON PLANS PROVIDED TO SCOSTA CORP. +/- BEARING DIFFERENCES SHOWN ARE CRITICAL IF ANY HEIGHTS DEVIATE - INFORM SCOSTA CORP.
- HANGER VALUES HAVE BEEN BASED ON 160 COMMON NAILS EXCEPT THE FOLLOWING
| LUS24 - 100 COMMON | THJ426 - 100 x 1-1/2" |

SCOSTA CORP.

WOOD, STEEL OR TIMBER
ROOF & FLOOR TRUSSES






3670 COMMERCE CENTER DRIVE
SEBRING, FL 33870
(883) 365-9242

SCALE: 1/4"=1'-0"
DATE: 07/12/13
JOB ADDRESS: 3692 K
LEE COUNTY



APPROVED BY: _____
DATE: _____ REQUESTED DELIVERY DATE: _____
JOBSITE CONTACT NAME: _____
PHONE #: _____
E-MAIL: _____

CUSTOMER: EMERALD HOMES
JOB #: 45150K

1 OF 1

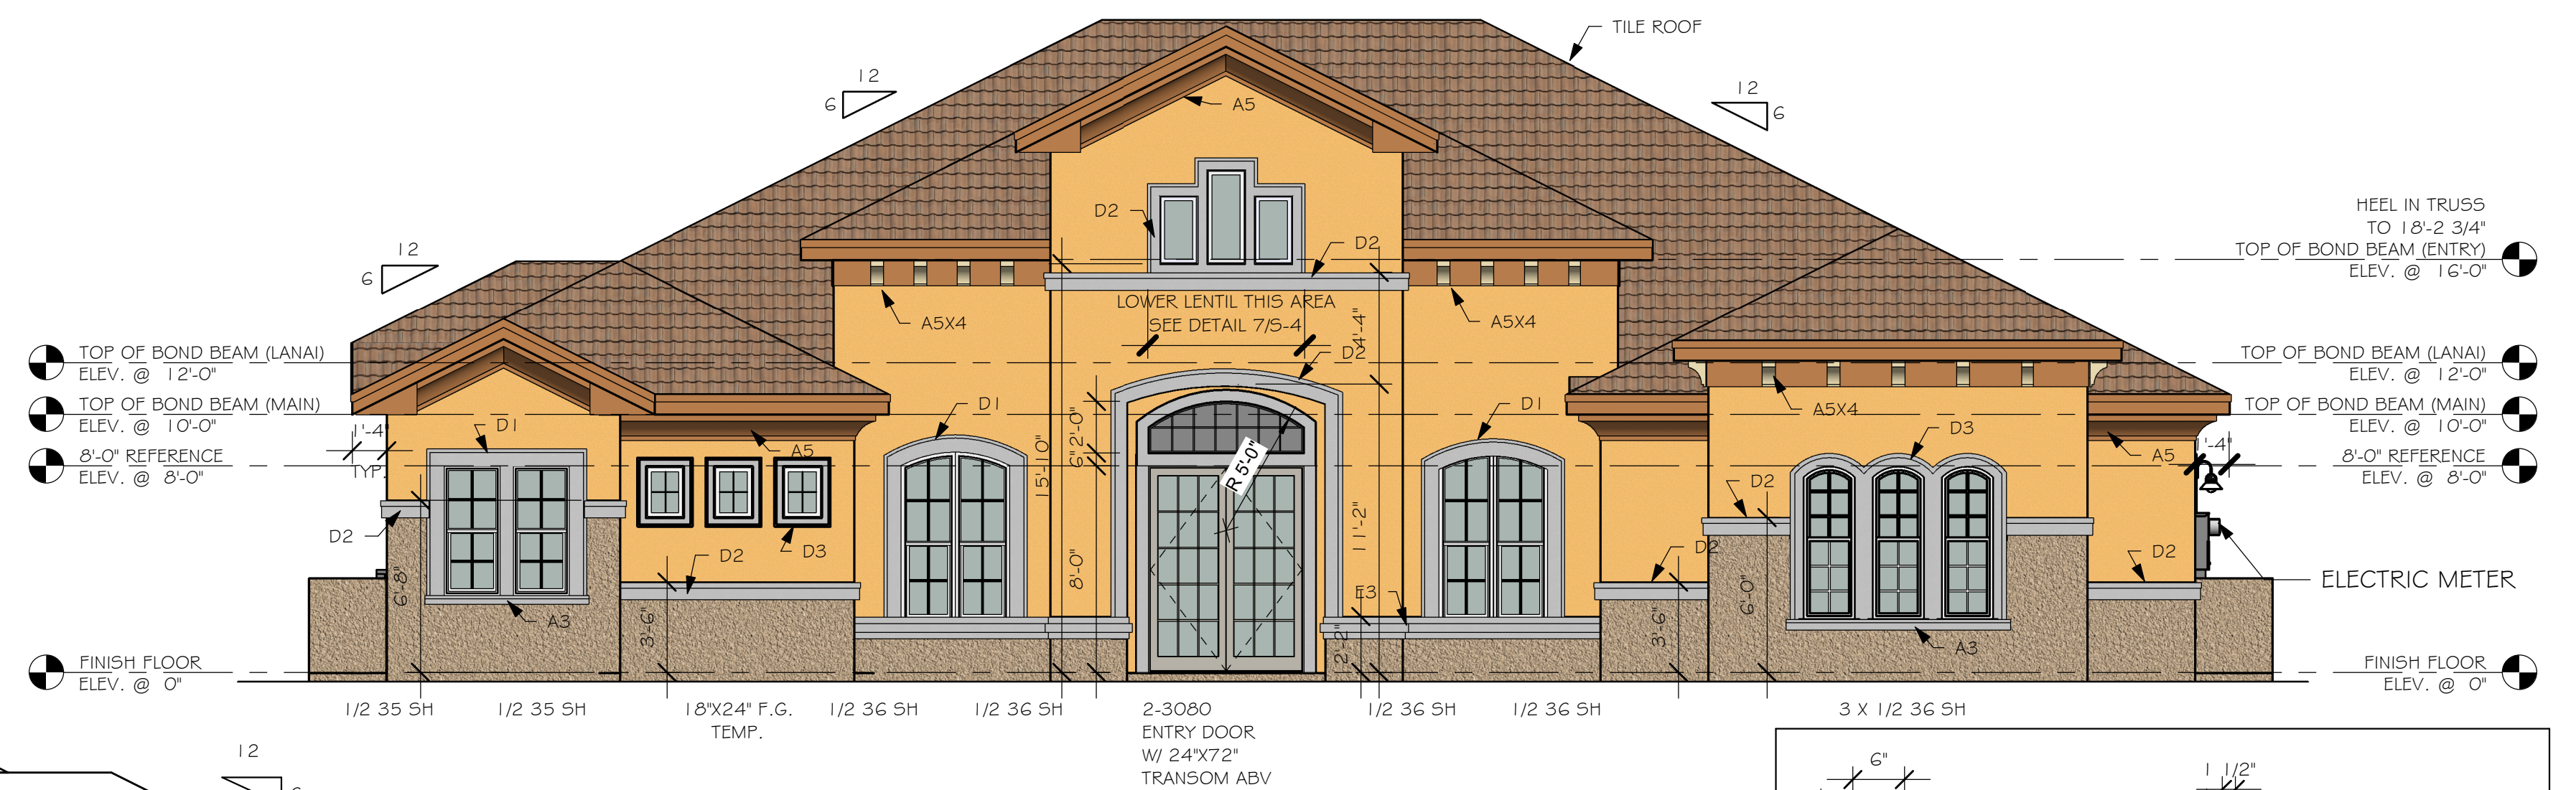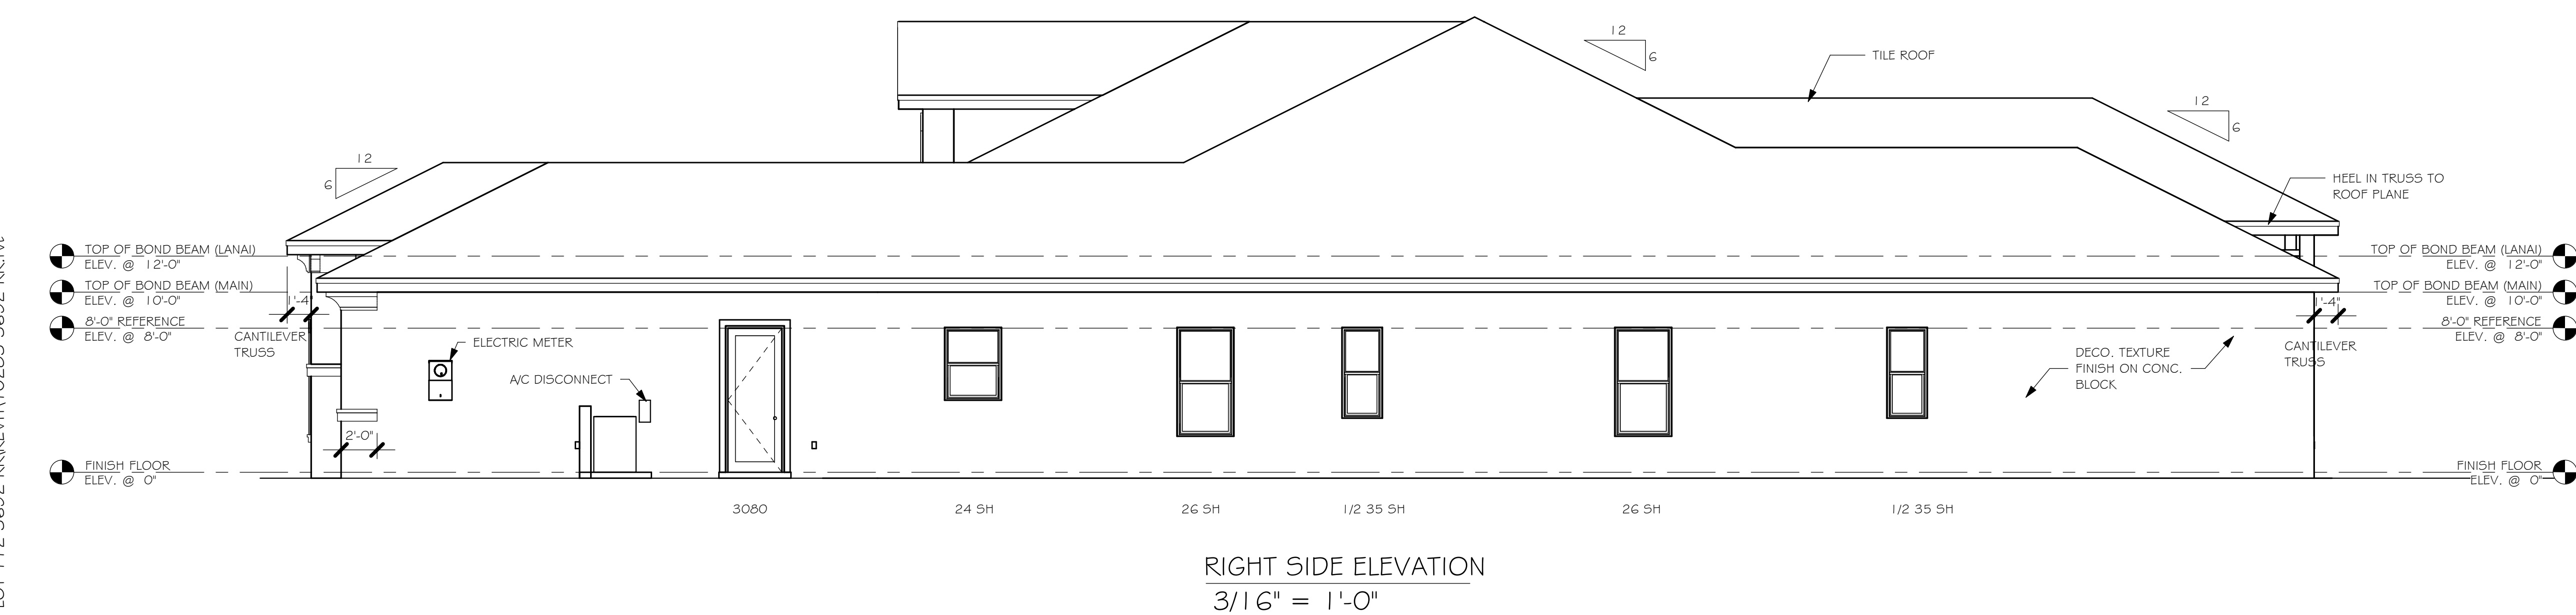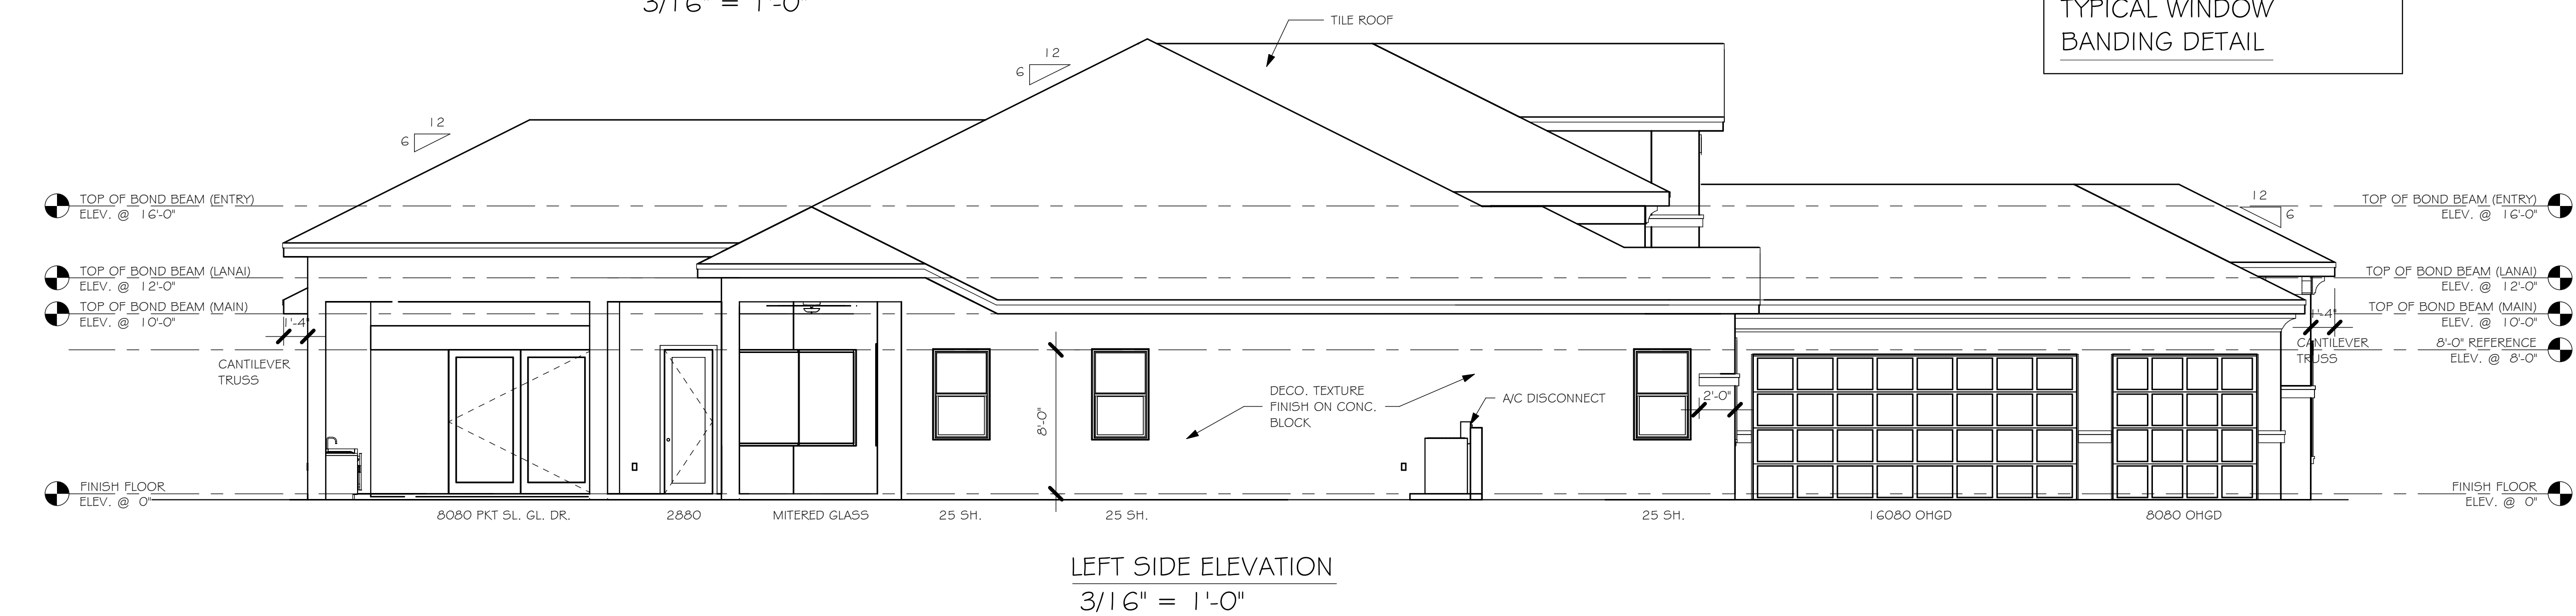
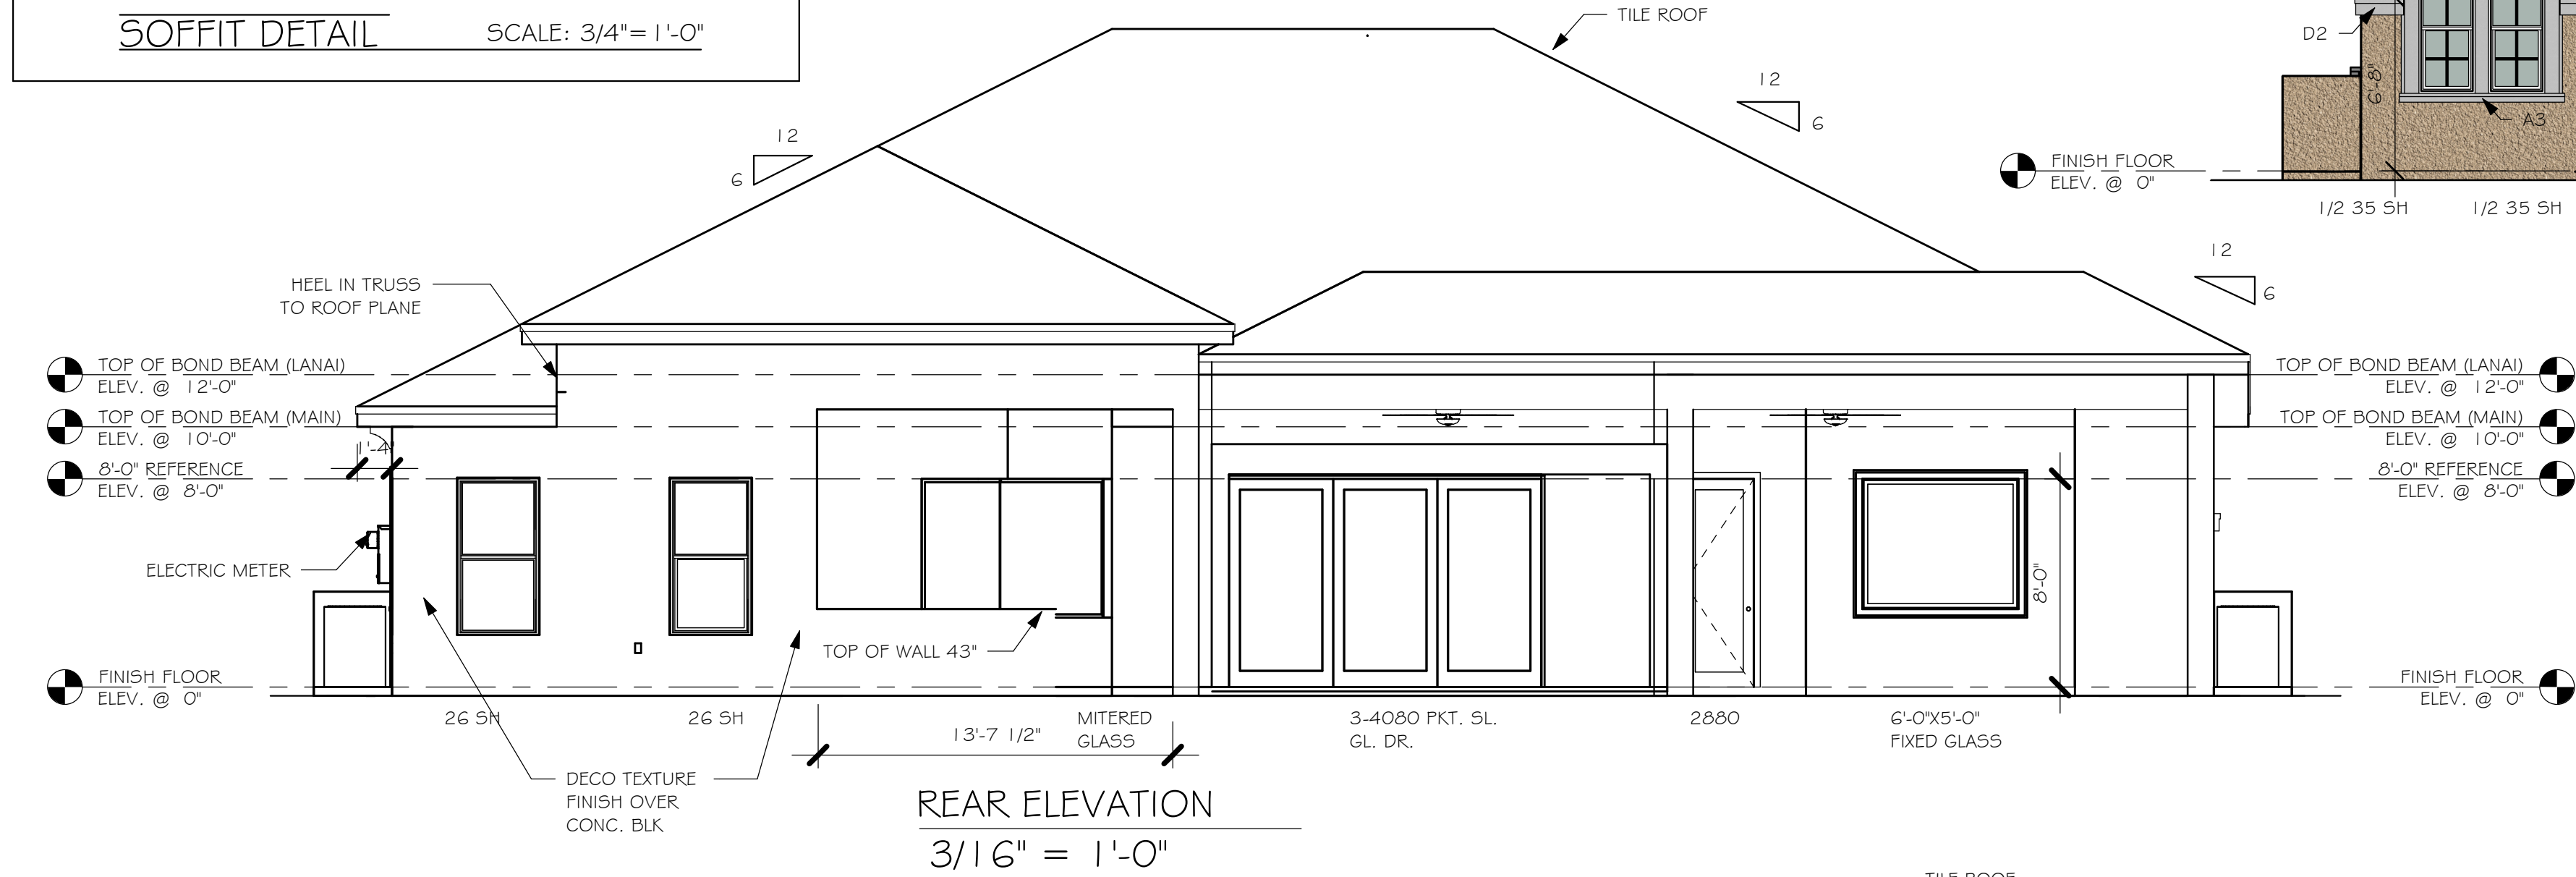
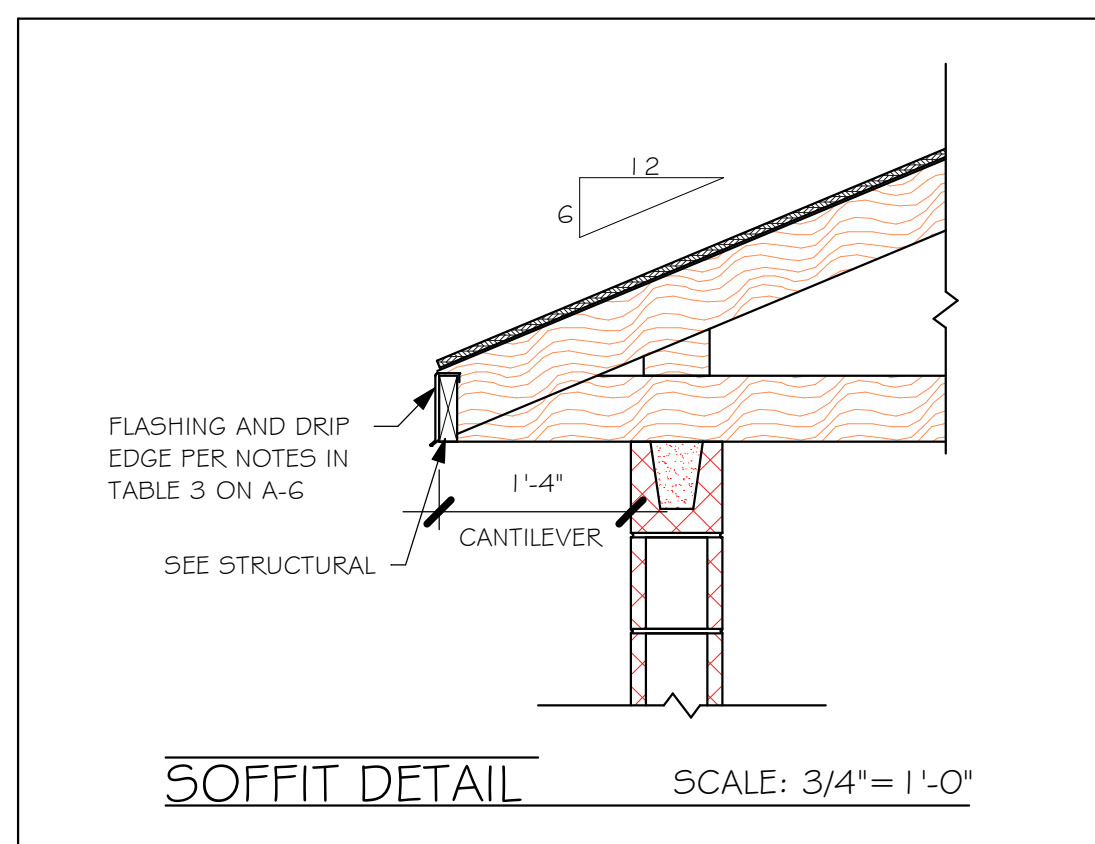


FRONT ELEVATION
 $3/16" = 1'-0"$

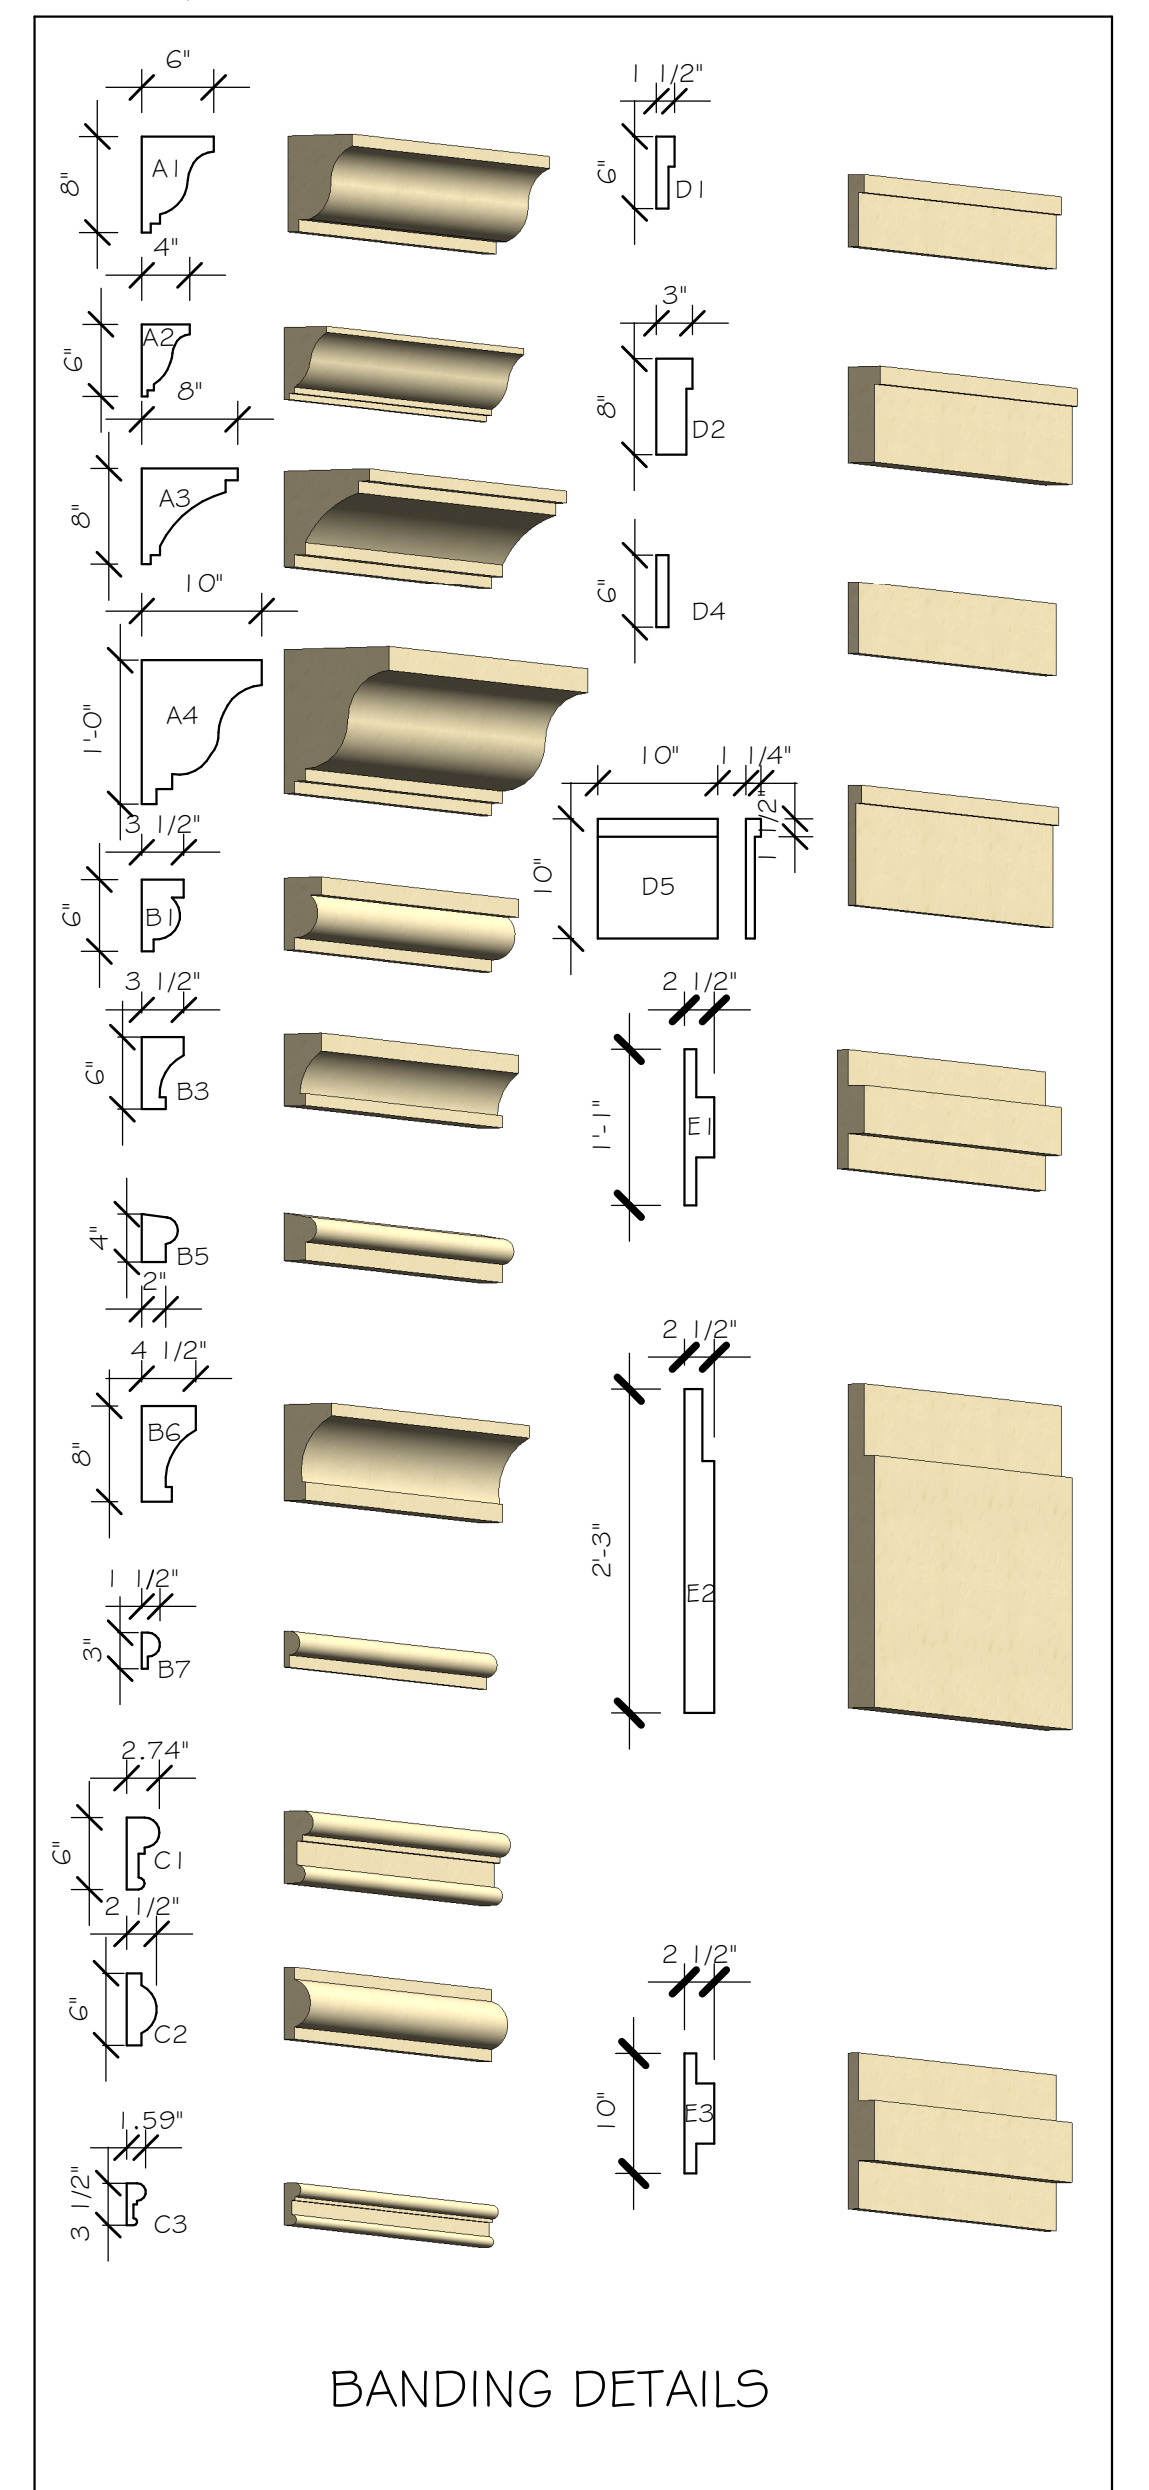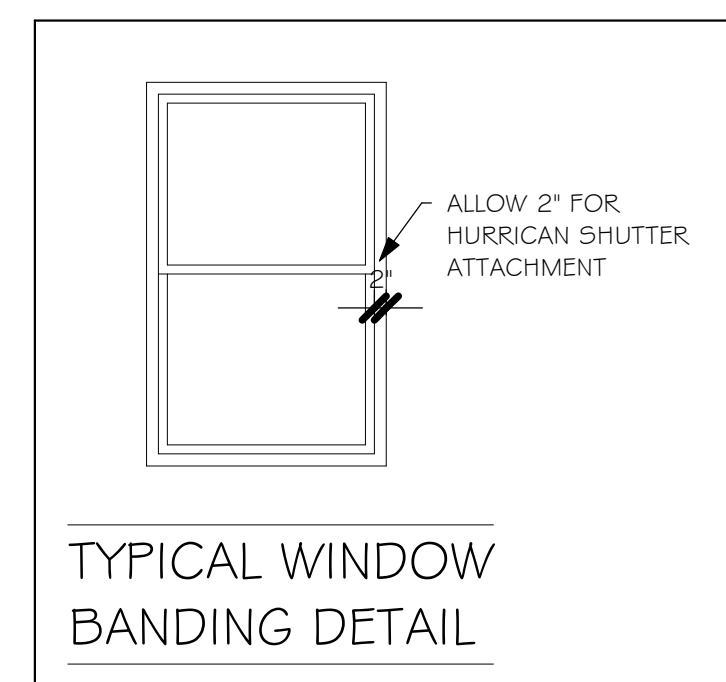

DESIGN IN ACCORDANCE WITH THE RESIDENTIAL
FLORIDA BUILDING CODE 2017 - 6TH EDITION

Z:\MASTER\2018 BUILDERS\2018 DR HORTON\SUBDIVISIONS\TOSCANA ISLES 60'S\10283 LOT 112 3692 KR\REVIT\10283 3692 KR.rvt

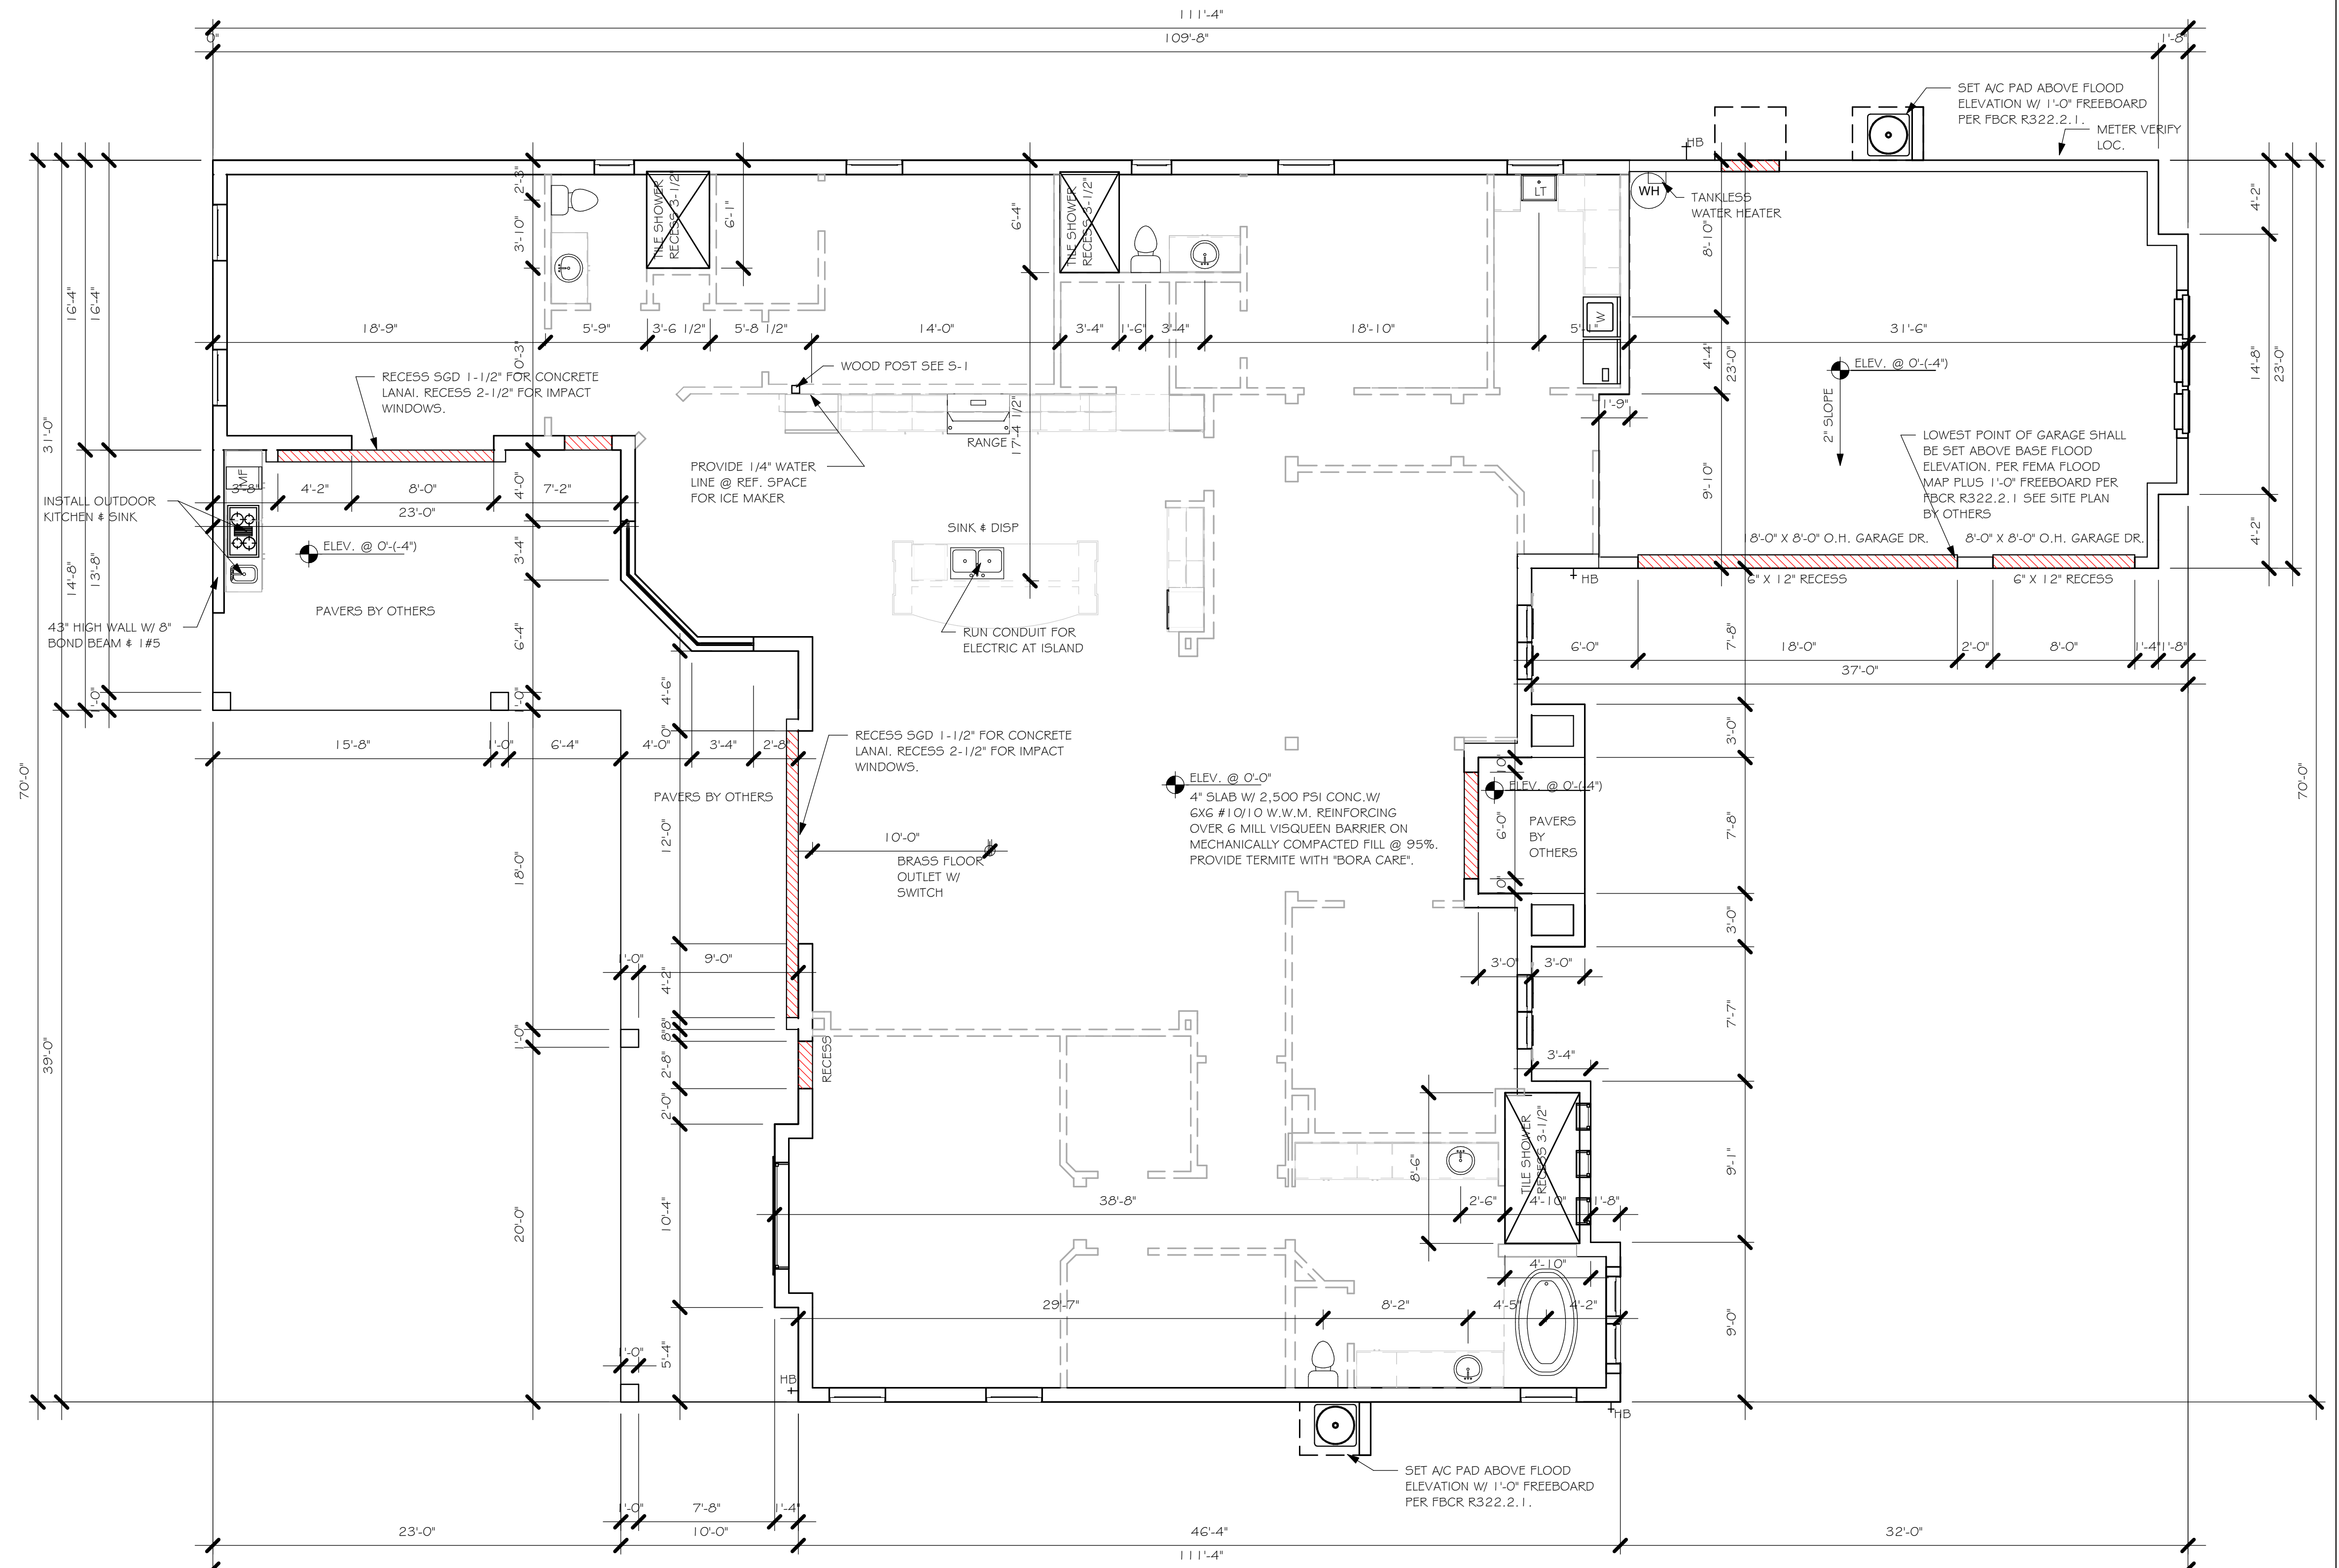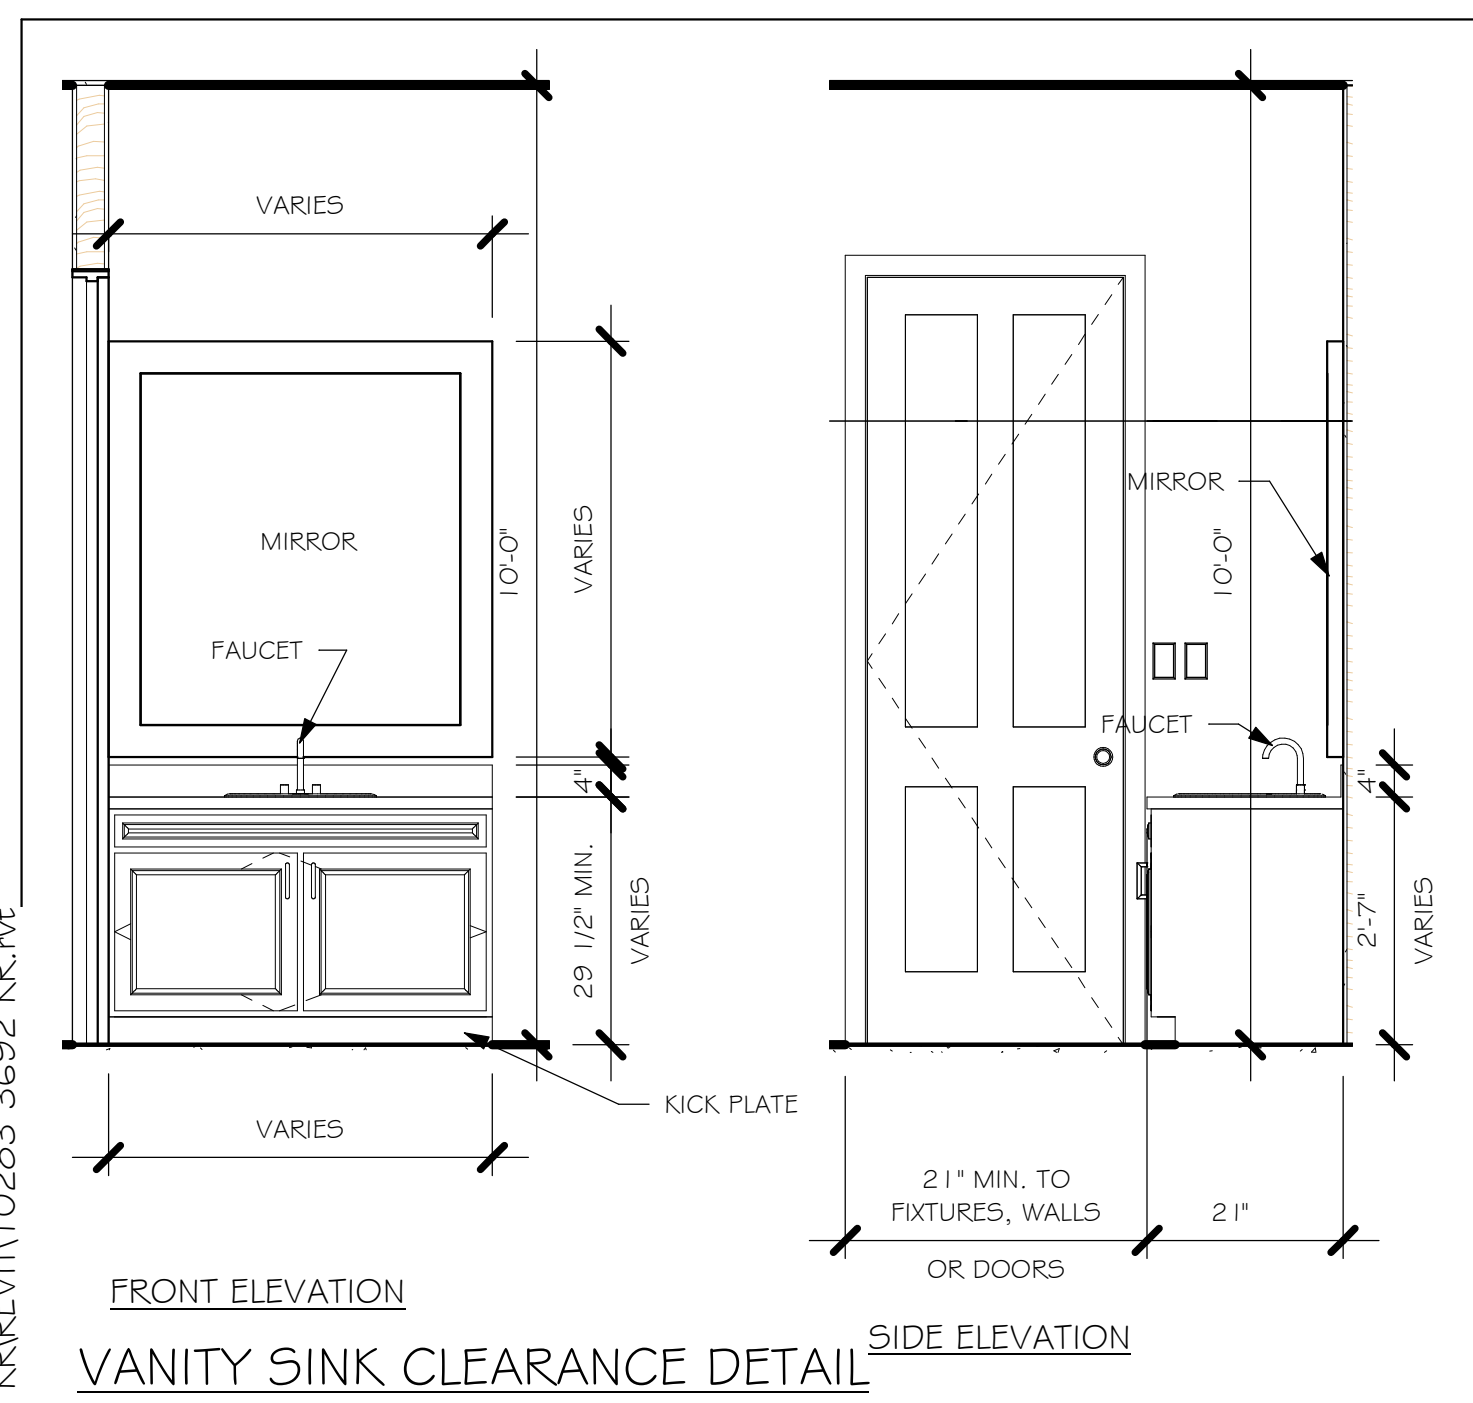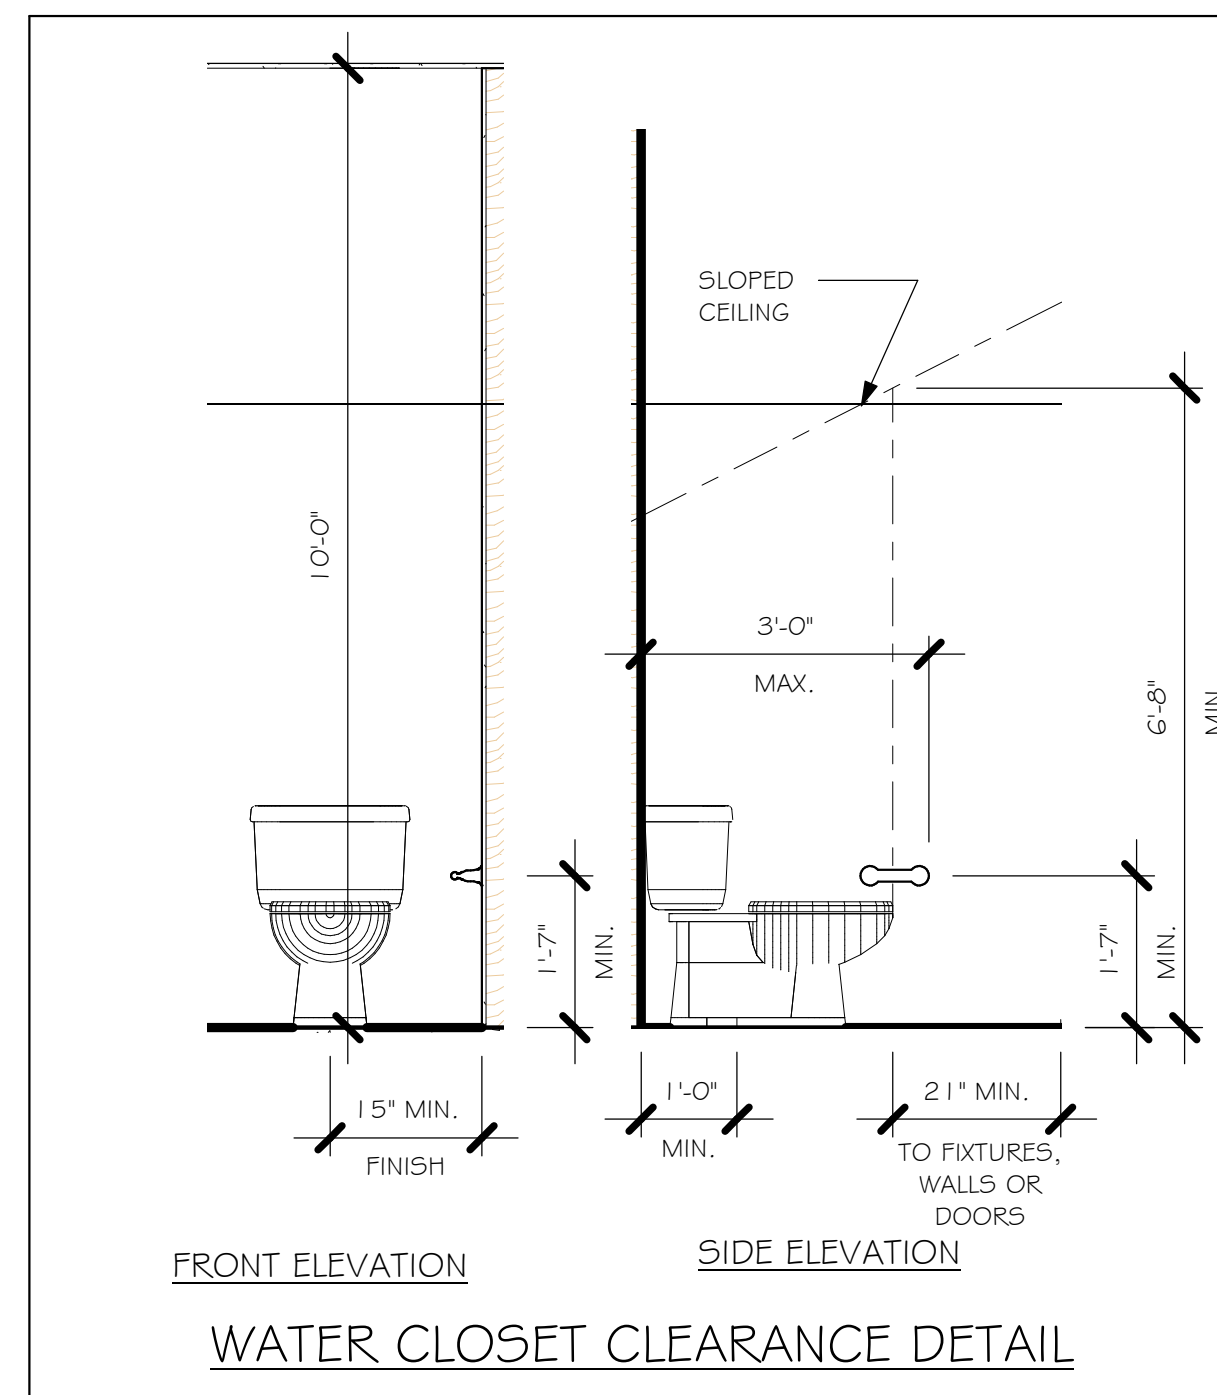

SLAB & PLUMBING PLAN
3/16" = 1'-0"

DESIGN IN ACCORDANCE WITH THE RESIDENTIAL
FLORIDA BUILDING CODE 2017 - 6TH EDITION

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Fort Myers, FL 33913
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Gulf Coast
Drafting & Design, Inc.
EMAIL: PLANS@GULFCOASTDRAFTING.COM
PHONE: 239-540-1822
1515 SE 47TH ST. CAPE CORAL, FL 33904

Project Name		LOT: 112
3692 K		SUBDIVISION: TOSCANA ISLES EMERALD 80's
		ADDRESS: 292 MARAVIVA BLVD
G.C.D. 10283	D.R.H. # 5787800002	
DATE: 8/23/18		
DRAWN BY: JSL		
CHECKED BY: JWC		
REVISED:		
PLAN: SLAB-PLUMBING		
SCALE: As indicated		
A-2 K		

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LOT 112 3692 KRREV\10283 3692 KR.rvt

DOOR HEADERS		
6'-8" BI-FOLD	HEADER HEIGHT	82" A.F.F.
6'-8" SWING	HEADER HEIGHT	82 1/2" A.F.F.
8'-0" SWING	HEADER HEIGHT	98 1/2" A.F.F.

PLAN NOTES

1)

VERIFY ALL ROUGH OPENING DIMENSIONS FOR ALL WINDOWS AND DOORS

2)

PROVIDE SAFETY GLAZING WITHIN 24" FROM EXIT PER FLORIDA BUILDING CODE R 308.4.2.

3)

PROVIDE SAFETY GLAZING AT BATH/ SHOWER PER FLORIDA BUILDING CODE R 308.4.5.

4)

NON BEARING INTERIOR FRAME WALLS SHALL BE FRAMED W/ WOOD OR METAL STUDS. SPACING SHALL NOT EXCEED 24" O.C. (NON BEARING WALLS ONLY)

5)

PROVIDE DEAD WOOD IN ATTIC FOR OVERHEAD GARAGE DOOR HARDWARE

6)

2X6 KITCHEN KNEE WALL 34" TO TOP

7)

WHERE DRYWALL CEILING IS APPLIED TO TRUSSES @ 24" O.C. USE 5/8" DRYWALL OR 1/2" 5AG RESISTANT PER SEC. 702.3.5

8)

THE GARAGE SHALL BE SEPARATED FROM THE RESIDENCE & ATTIC BY NOT LESS THEN 1/2" GYPSUM BOARD APPLIED TO THE GARAGE SIDE. GARAGES BENEATH HABITABLE ROOMS SHALL BE SEPARATED WITH NOT LESS THAN 5/8" TYPE "X" GYPSUM BOARD OR EQUIVALENT. WHERE THE SEPARATION IS A FLOOR - CEILING ASSEMBLY, THE STRUCTURE SUPPORTING THE SEPARATION SHALL ALSO BE PROTECTED BY NOT LESS THAN 1/2" GYPSOM BOARD OR EQUIVALENT

9)

INSTALL 1 - 3/8" THICK SOLID WOOD DOOR BETWEEN LIVING AND GARAGE PER FLORIDA BUILDING CODE R302.1.5,

10)

ALL WINDOWS INSTALLED 72" ABOVE GRADE MUST COMPLY WITH R312.2.1. MIN 24" SILL HEIGHT OR PROVIDED WITH AN APPROVED WINDOW FALL PRVENTION DEVICE

11)

STUB OUT FOR GAS @ OUTDOOR KITCHEN, RANGE, WATER HEATER, AND DRYER. VERIFY WITH CONTRACTOR AND SUBDIV. SPECS. A SEPERATE PERMIT IS REQUIRED FOR GAS PIPING.

VINYL SHELF NOTES:


12)

ALL CLOSET SHELVES TO BE 12". ALL PANTRY & LINEN TO BE (4)-16" SHELVES 18" O.F.F. W/ 15" INCREMENT.

CABINET BACKING		
KITCHEN	UPPER TOP @ 84"	BASE TOP @ 35"
MASTER BATH	UPPER	BASE TOP @ 35"
GUEST BATH	UPPER	BASE TOP @ 31"
LAUNDRY ROOM	UPPER TOP @ 84"	BASE

SQUARE FOOTAGE	
LIVING AREA	3,697
GARAGE AREA	726
LANAI AREA	755
ENTRY AREA	46
TOTAL SQUARE FOOTAGE	5,224


INTERIOR DOOR SCHEDULE		
MARK	DOOR WIDTH	NOTES
1	3'-0"	P.K. = POCKET DOOR
2	2'-8"	B.F. = BI-FOLD DOOR
3	2'-6"	
4	2'-4"	B.P. = BI-PASS DOOR
5	2'-0"	
6	1'-8"	L.V. = LOUVERED DOOR
7	1'-6"	
8	2'-11"	

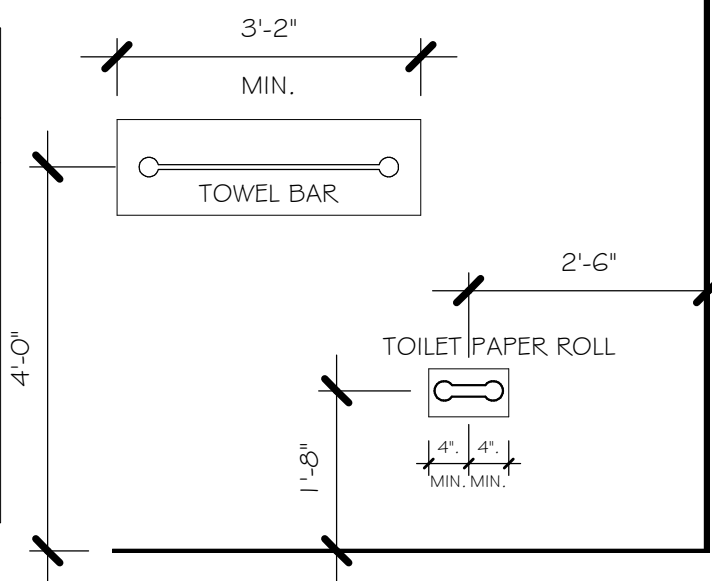

WINDOW SCHEDULE						
MARK	DESCRIPTION	MANUFACTURER	HEIGHT	WIDTH	COMMENTS	COUNT
A	18"x24" FIXED GLASS		2'-0"	1'-6"	IMPACT	3
B	1/2 35 SH		5'-0"	2'-2"	IMPACT	4
C	25 SH		5'-0"	3'-1"	IMPACT	3
D	1/2 36 SH (1/2 ARCH TOP)		6'-0"	2'-0"	IMPACT	4
E	1/2 36 SH RAD TOP		6'-0"	2'-0"	IMPACT	3
F	24 SH		4'-0"	3'-1"	IMPACT	1
G	26 SH		6'-0"	3'-1"	IMPACT	4
H	60"x72" FIXED GLASS		5'-0"	6'-0"	IMPACT	1
I	24"x72" TRANSOM		2'-0"	6'-0"	IMPACT	1
J	MITERED GLASS		5'-4"	3'-0"		1
TOTAL: 25						

DOOR SCHEDULE						
TYPE MARK	DESCRIPTION	MANUFACTURER	HEIGHT	WIDTH	COMMENTS	COUNT
1	2880 ENTRY	DISTINCTION	8'-0"	2'-8"		2
2	3080 ENTRY	DISTINCTION	8'-0"	3'-0"		1
3	(2)-4080 PKT SL. GL. DR.	DISTINCTION	8'-0"	8'-0"		1
4	2-3080 FR. DOORS	DISTINCTION	8'-0"	6'-0"		1
5	(3)-4080 PKT SL. GL. DR.	DISTINCTION	8'-0"	12'-0"		1
6	18080 O.H.G.D	CLOPAY	8'-0"	18'-0"		1
7	8080 O.H.G.D.	CLOPAY	8'-0"	8'-0"		1
TOTAL: 8						

FLOOR PLAN
3/16" = 1'-0"

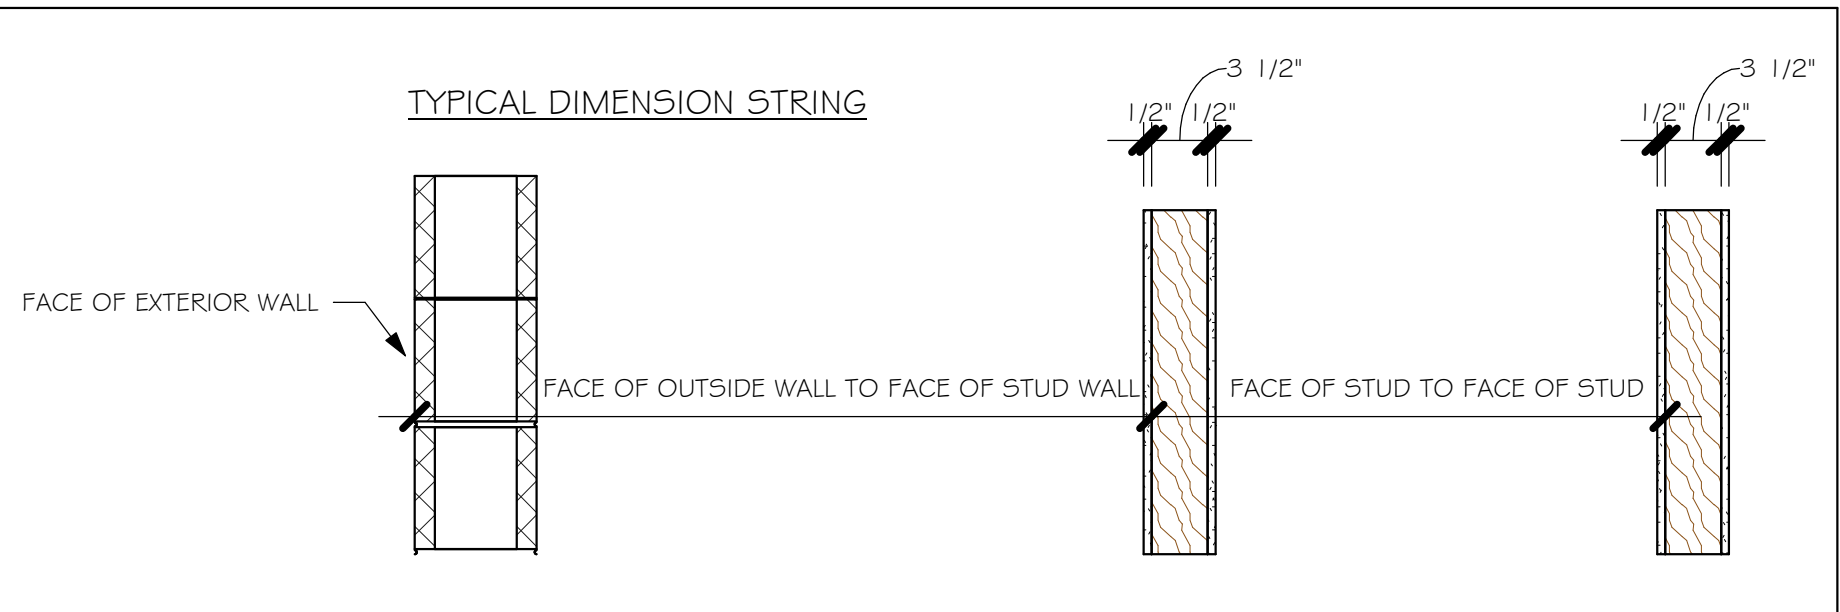

DIMENSION SCHEDULE
1" = 1'-0"

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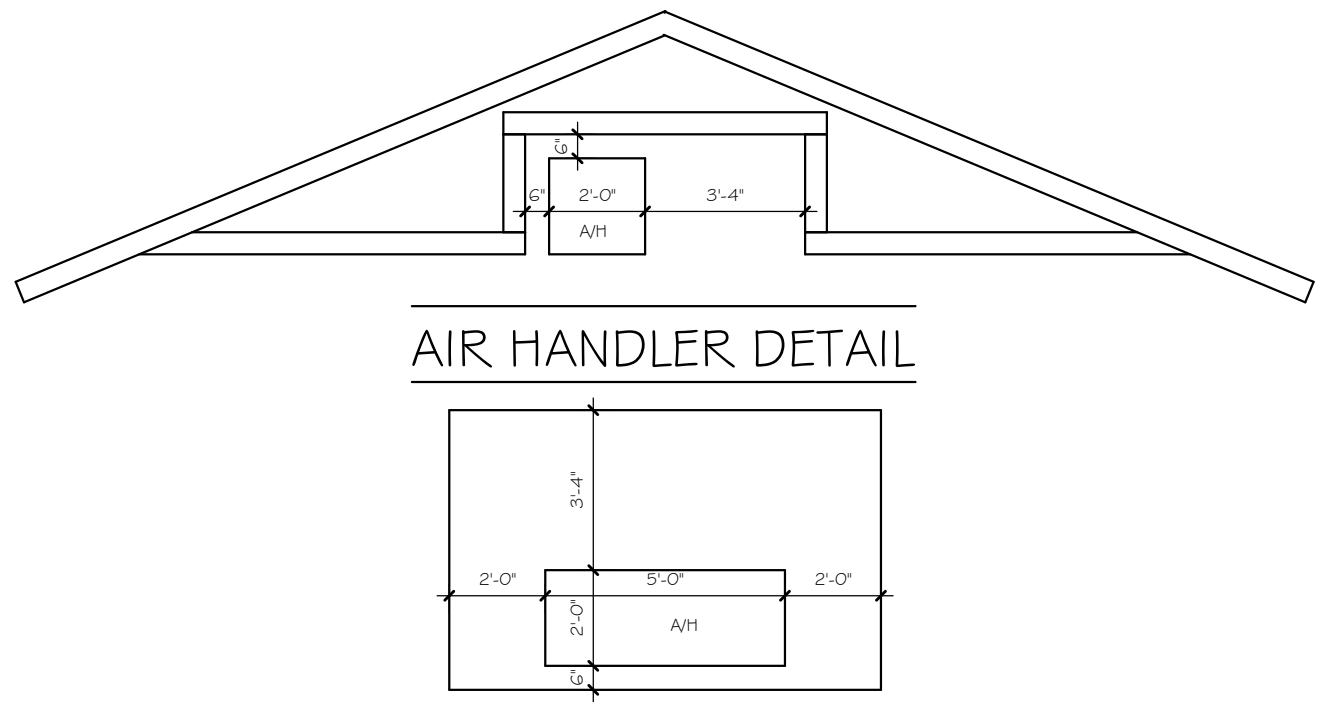
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EMAIL: PLANS@GULFCOASTDRAFTING.COM
PHONE: 239-540-8622
1515 SE 47th ST. CAPE CORAL, FL 33904

LOT: 112	SUBDIVISION: TOSCANA ISLES EMERALD 80's
PROJECT NAME	3692 K
ADDRESS: 292 NARAYANA BLVD	D.R.H. #: 5787800002


DATE:	8/23/18
DRAWN BY:	JSL
CHECKED BY:	JWC
REVISED:	
PLAN:	FLOOR
SCALE:	As indicated
A-3 K	

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ATTIC VENTILATION

VERIFY VENTING REQUIREMENTS WITH ENERGY CALCULATIONS		WITHOUT OFF RIDGE VENTS	WITH OFF RIDGE VENTS (O.R.V.)
ATTIC AREA (FBC R806)		VENTILATION REQUIRED (ATTIC AREA 1/150)	VENTILATION REQUIRED (ATTIC AREA 1/300 INSTALL PER FBC R806; 2 MINIMUM AREA REQUIREMENTS)
MARK	SQUARE FOOTAGE	SOFFIT VENTS	MIN AIR FLOW OF SOFFIT
①	5446 SQ. FT.	36.3 SQ. FT.	MIN AIR FLOW OF SOFFIT
		ATTIC VENTILATION CALCULATION	ATTIC VENTILATION CALCULATION
		ATTIC SQ. FT. / 150 = VENTED SQ. FT.	ATTIC SQ. FT. / 300 = VENTED SQ. FT.
1.45 SQ. FT. FREE AREA		1 SQ. FT. FREE AREA	.36 SQ. FT. FREE AREA
OFF RIDGE EXHAUST VENT SIZES (AREA NET FREE SQUARE FEET)			



CEILING PLAN
3/16" = 1'-0"

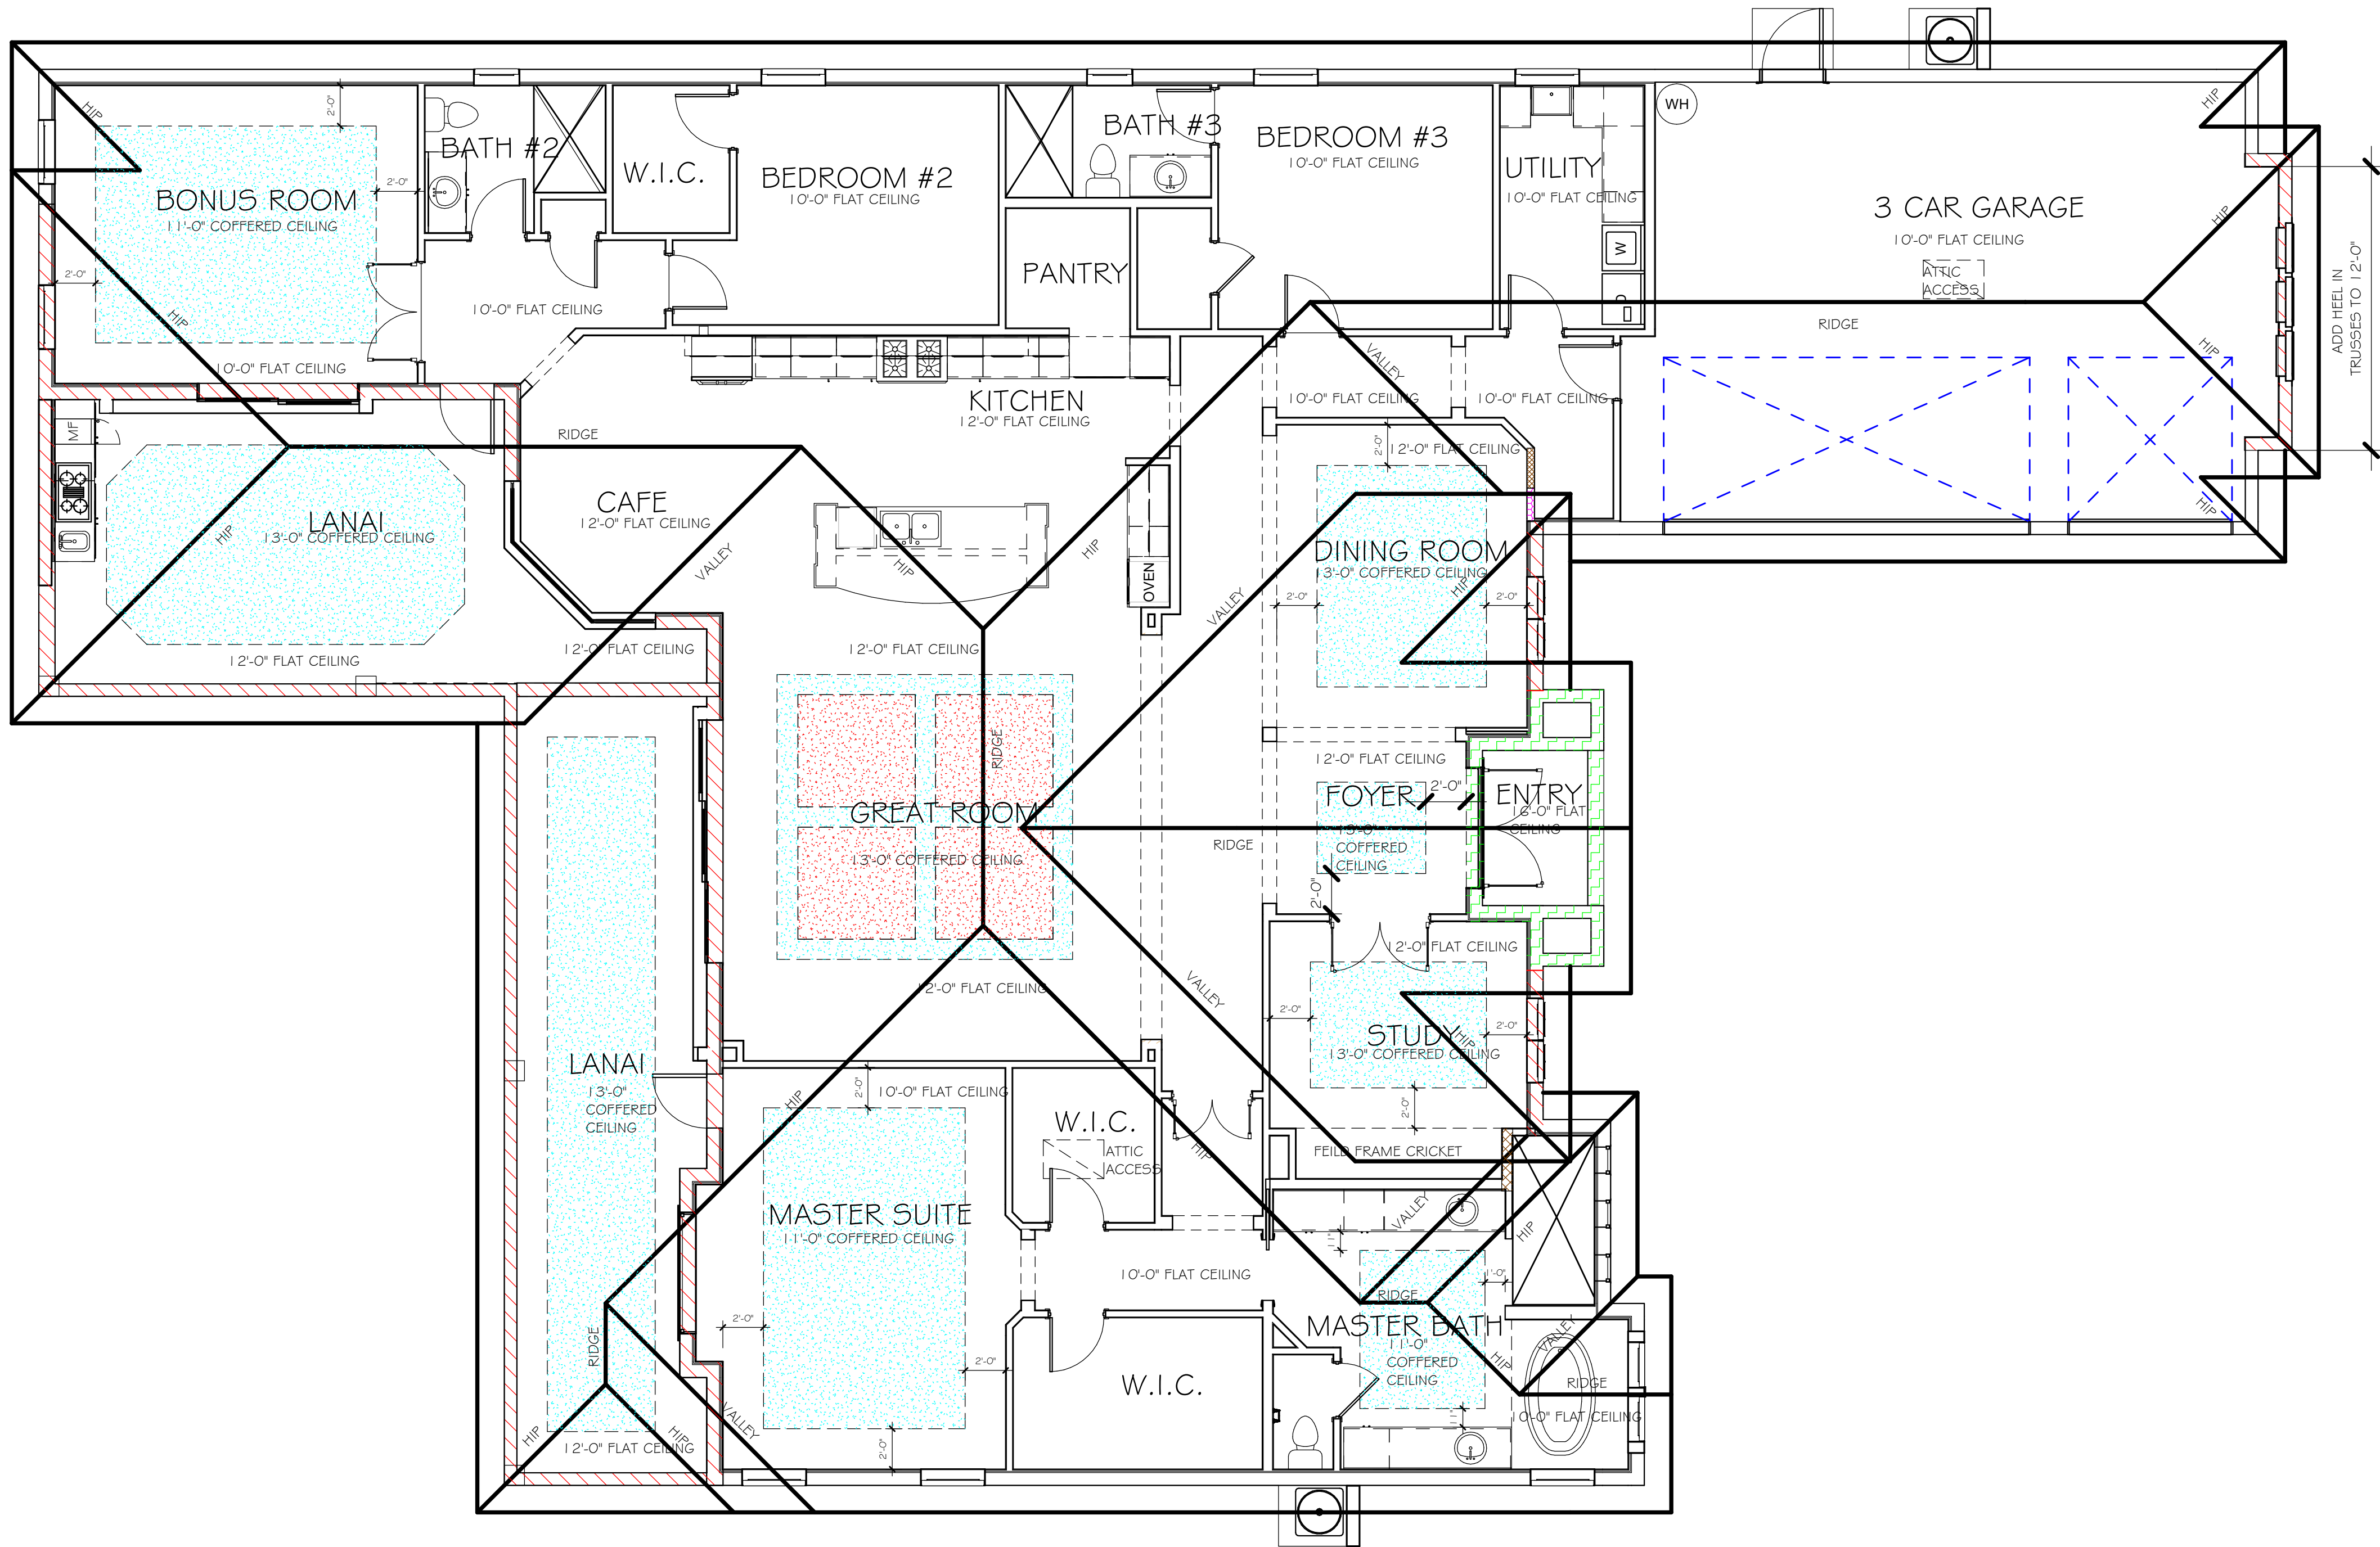BEARING HEIGHT	
	= BEARING @ 10'-0"
	= BEARING @ 12'-0"
	= INTERIOR BEARING @ 12'-0"
	= INTERIOR BEARING @ 12'-1 1/2"
	= INTERIOR BEARING @ 12'-6"
	= BEARING @ 16'-0"

DESIGN IN ACCORDANCE WITH THE RESIDENTIAL FLORIDA BUILDING CODE 2017 - 6TH EDITION



Project Name 3692 K	LOT: 112	DATE: 8/23/18
	SUBDIVISION: TOSCANA ISLES EMERALD 80's	DRAWN BY: JSL
	ADDRS: 292 NARAVIYA BLVD	CHECKED BY: JWC
	D.R.H. #: 5787800002	REVISED:
A-4 K	G.C.D. 10283	PLAN: ROOF
		SCALE: As indicated

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EMAIL: PLANS@GULFCOASTDRAFTING.COM
PHONE: 395-540-822
1515 SE 47th ST. CAPE CORAL, FL 39904

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LOT 112 3692 KRREV\10283 3692 KR.rvt

ELECTRICAL LEGEND	
	ELECTRICAL METER
	ELECTRICAL PANEL
	120 V JUNCTION BOX
	SINGLE RECEPTACLE OUTLET
	220 V RECEPTACLE OUTLET
	4-PLEX RECEPTACLE OUTLET
	DUPLEX RECEPTACLE OUTLET
	1/2 SWITCHED DUPLEX OUTLET
	DUPLEX RECEPTACLE AT ELEV. A.F.F.
	DUPLEX RECEPTACLE - ABOVE COUNTER
	SINGLE POLE SWITCH
	3 WAY SWITCH
	DIMMER SWITCH
	MOTION SENSOR SWITCH
	AC/DC SMOKE DETECTOR TO BE INTERCONNECTED ANY RESIDENT HAVING A FOSSIL-BURNING HEATER OR APPLIANCE, A FIREPLACE, OR AN ATTACHED GARAGE SHALL HAVE AN OPERATIONAL CARBON MONOXIDE ALARM INSTALLED WITHIN 10 FEET OF EACH ROOM USED FOR SLEEPING PERPOSES. PER RULE 9B-3.04.72 SD (SMOKE DETECTOR) SCD (CARBON MONOXIDE/ SMOKE DETECTOR)
	TELEPHONE OUTLET
	TELEVISION RECEPTION OUTLET
	SURFACE MOUNTED CEILING LIGHT
	RECESSED LIGHT
	WALL MTD. BRACKET LIGHT
	DUPLEX FLOOD LIGHT
	EXHAUST FAN
	TRACK MTD. LIGHTS
	A/C DISCONNECT
	PUSH BUTTON (PB) / DOOR BELL (DB)
	INTERCOM
	KEYPAD
	4' FLUORESCENT LIGHT
	2' UNDER COUNTER LIGHT
NOTE: NOT ALL SYMBOLS ARE USED FOR THIS PROJECT.	
ELECTRICAL NOTES:	
ARC-FAULT CIRCUIT-INTERRUPTERS AND TAMPER-RESISTANT RECEPTACLES SHALL BE INSTALLED IN DWELLING UNITS PER N.E.C. 210.12 AND 406.11	
ALL ELECTRICAL EQUIPMENT TO BE SET AT OR ABOVE BASE FLOOD ELEVATION.	
ALL OUTLETS IN WET AREAS AND ALL EXTERIOR OUTLETS TO BE GFI'S.	
INSTALL PHONE AND T.V. PER CONTRACT.	
INSTALL ALL ELECTRICAL PER NEC 2014	

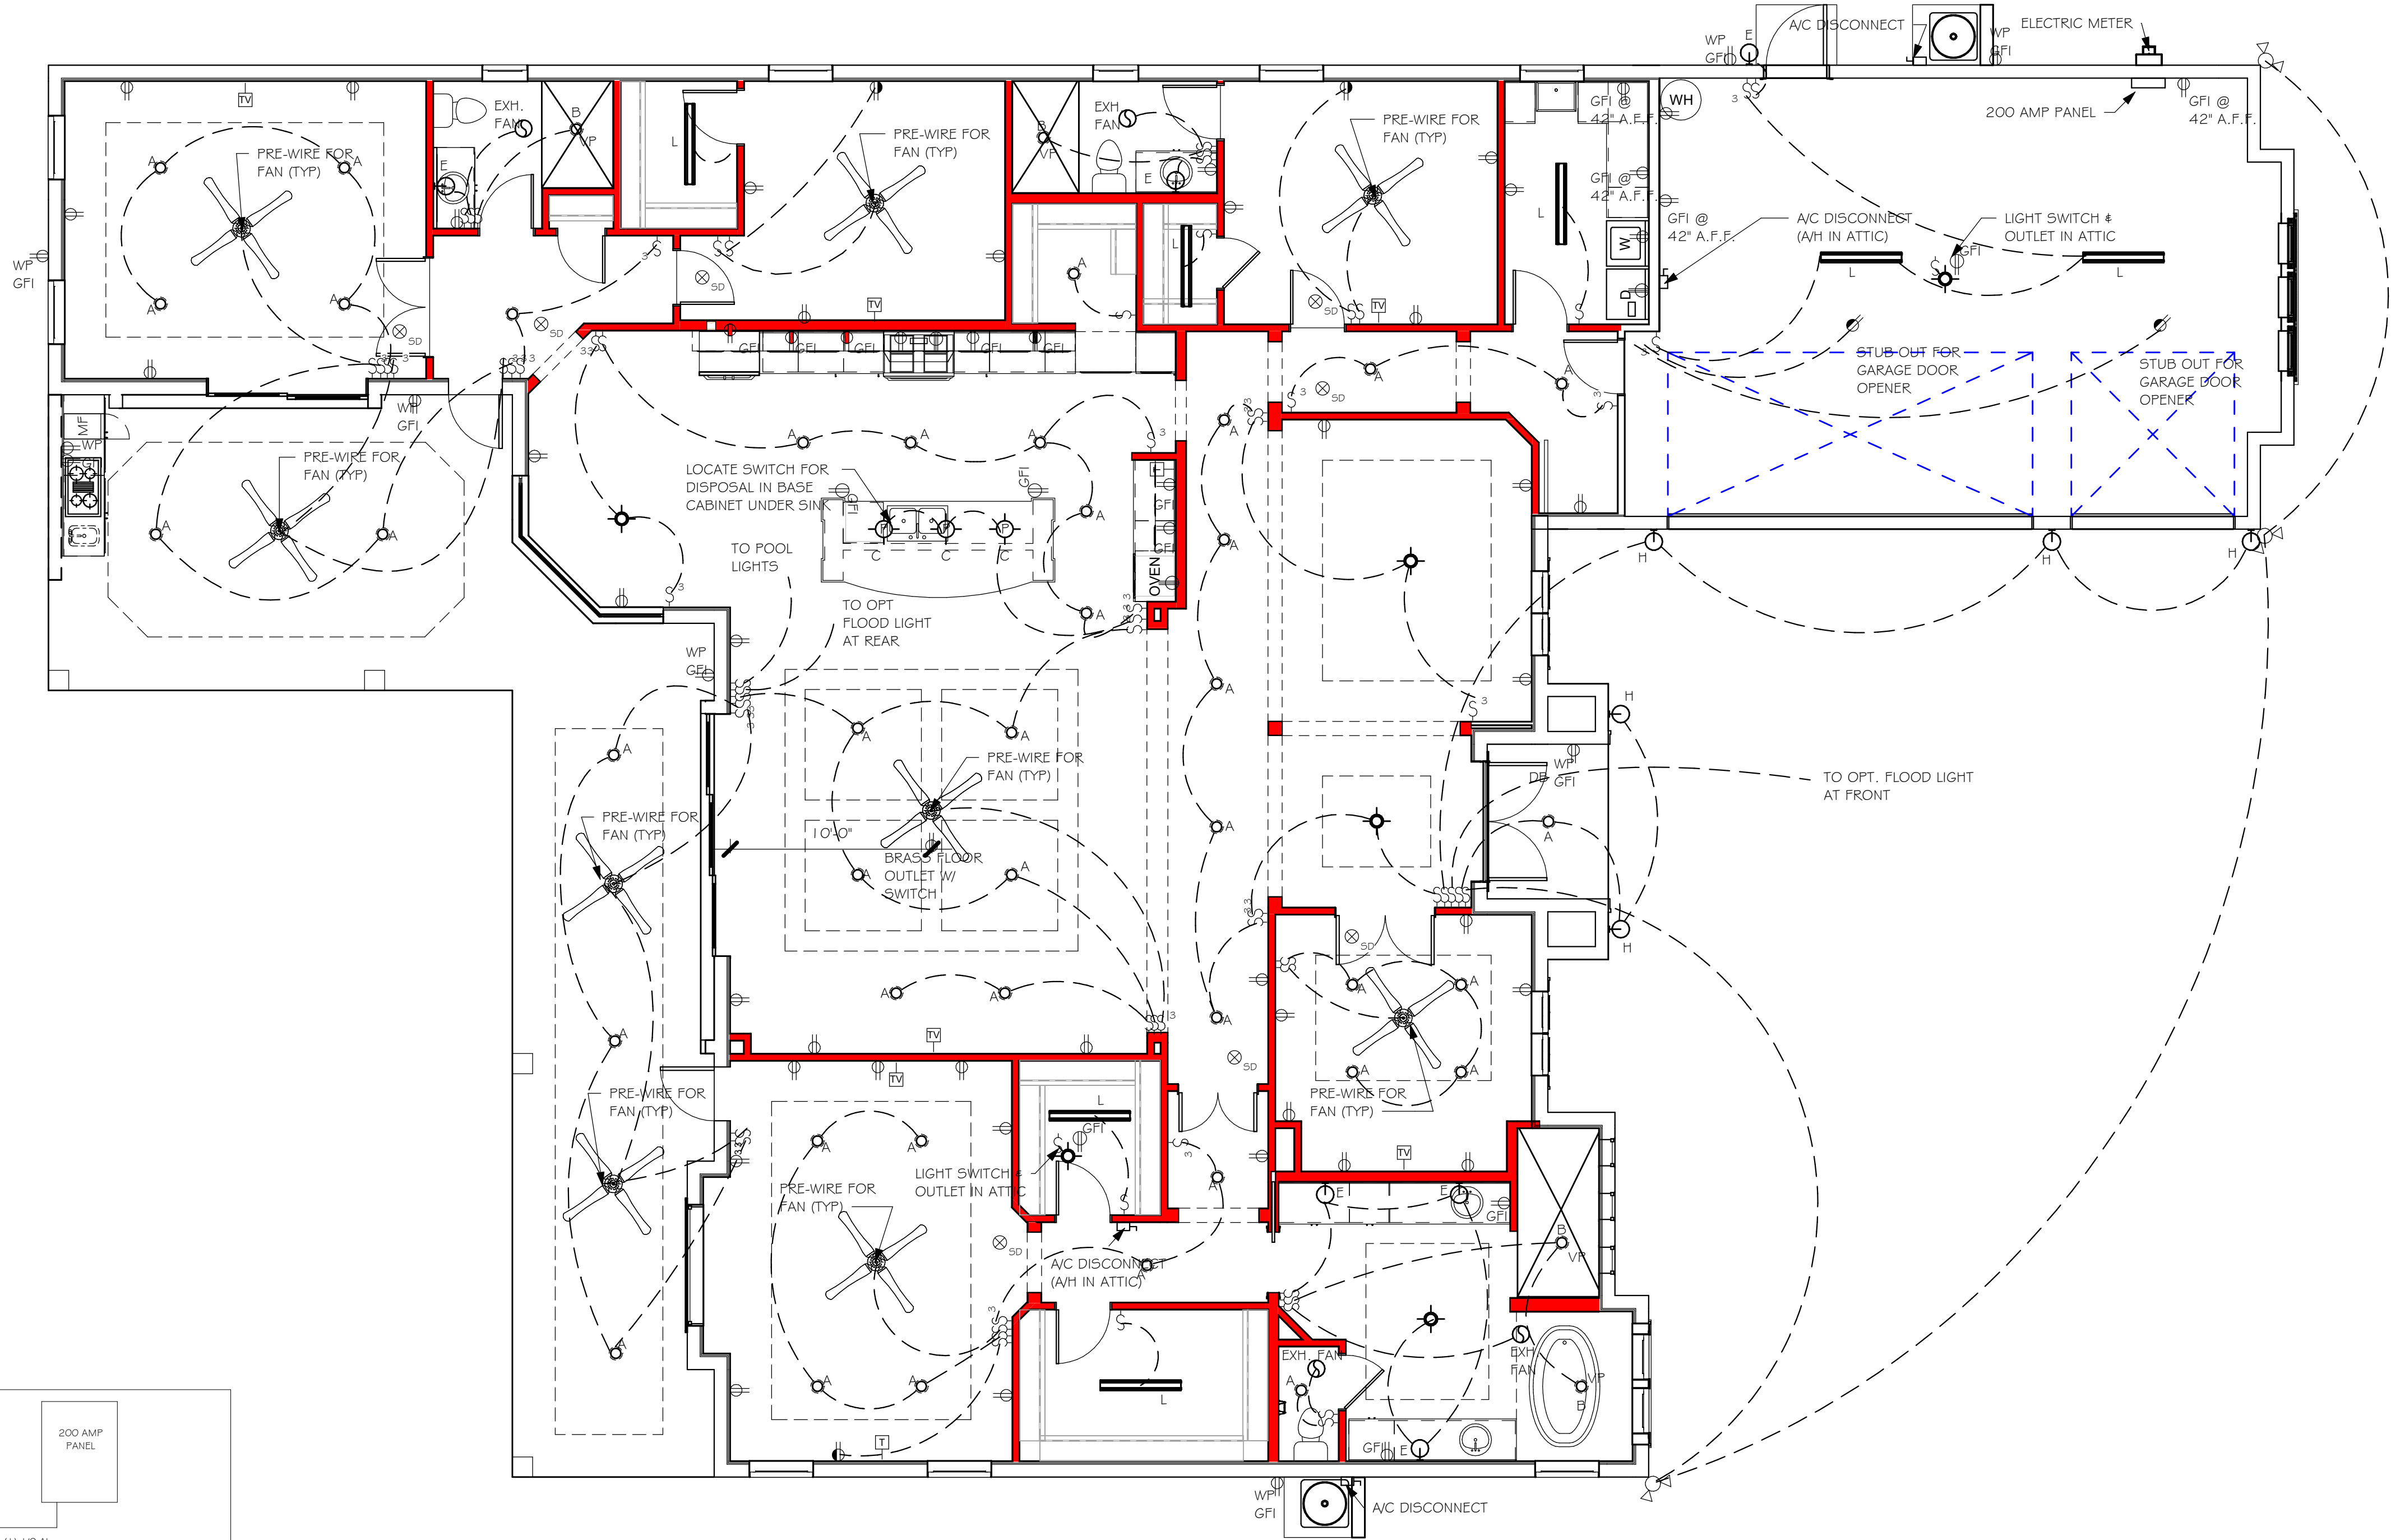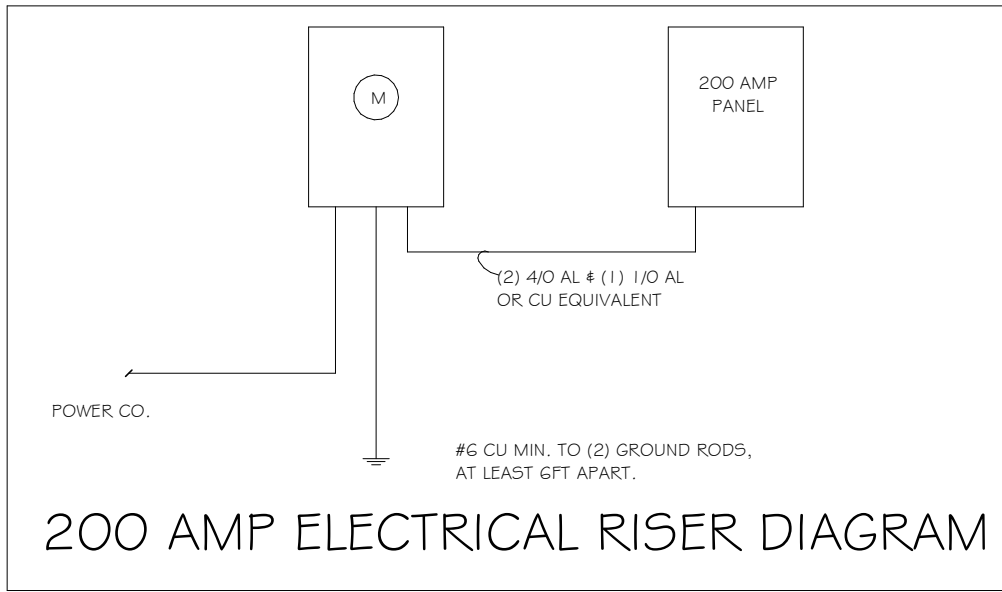

ELECTRICAL
3/16" = 1'-0"

ELECTRICAL PLAN 3692 "K"

200 AMP SERVICE		
TAG	QUANTITY	PRODUCT
A	(42)	(RECESSED CANS)
B	(4)	(VAPORS)
C	(3)	(PENDANT LIGHT
D	(X)	(10" MUSHROOMS)
E	(5)	(24" 3 LT)
F	(X)	(36" 4 LT)
G	(X)	(NOT USED)
H	(4)	(COACH LIGHTS)
I	(X)	(COACH LIGHTS)
J	(X)	(J BOX)
K	(X)	(4' FLUORESCENT)
L	(7)	(2' FLUORESCENT)
M	(X)	(SLT CHANDELIER)
N	(X)	(3 LT)
O	(X)	(PENDANT/ NOOK)
P	(X)	(X)
Q	(X)	(X)

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	SUBDIVISION: TOSCANA ISLES EMERALD 80's
	ADDRESS: 292 NARAVYA BLVD
	D.R.H. #: 5787800002


DATE:	8/23/18
DRAWN BY:	JSL
CHECKED BY:	JWC
REVISED:	
PLAN:	ELECTRICAL
SCALE:	As indicated
A-5 K	

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EMAIL: PLANS@GULFCOASTDRAFTING.COM
PHONE: 239-540-8822
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-LOT 112 3692 KRREV\10283 3692 KR.v4

MID WALL WEEP SCREED DETAIL



WEEP SCREED DETAIL

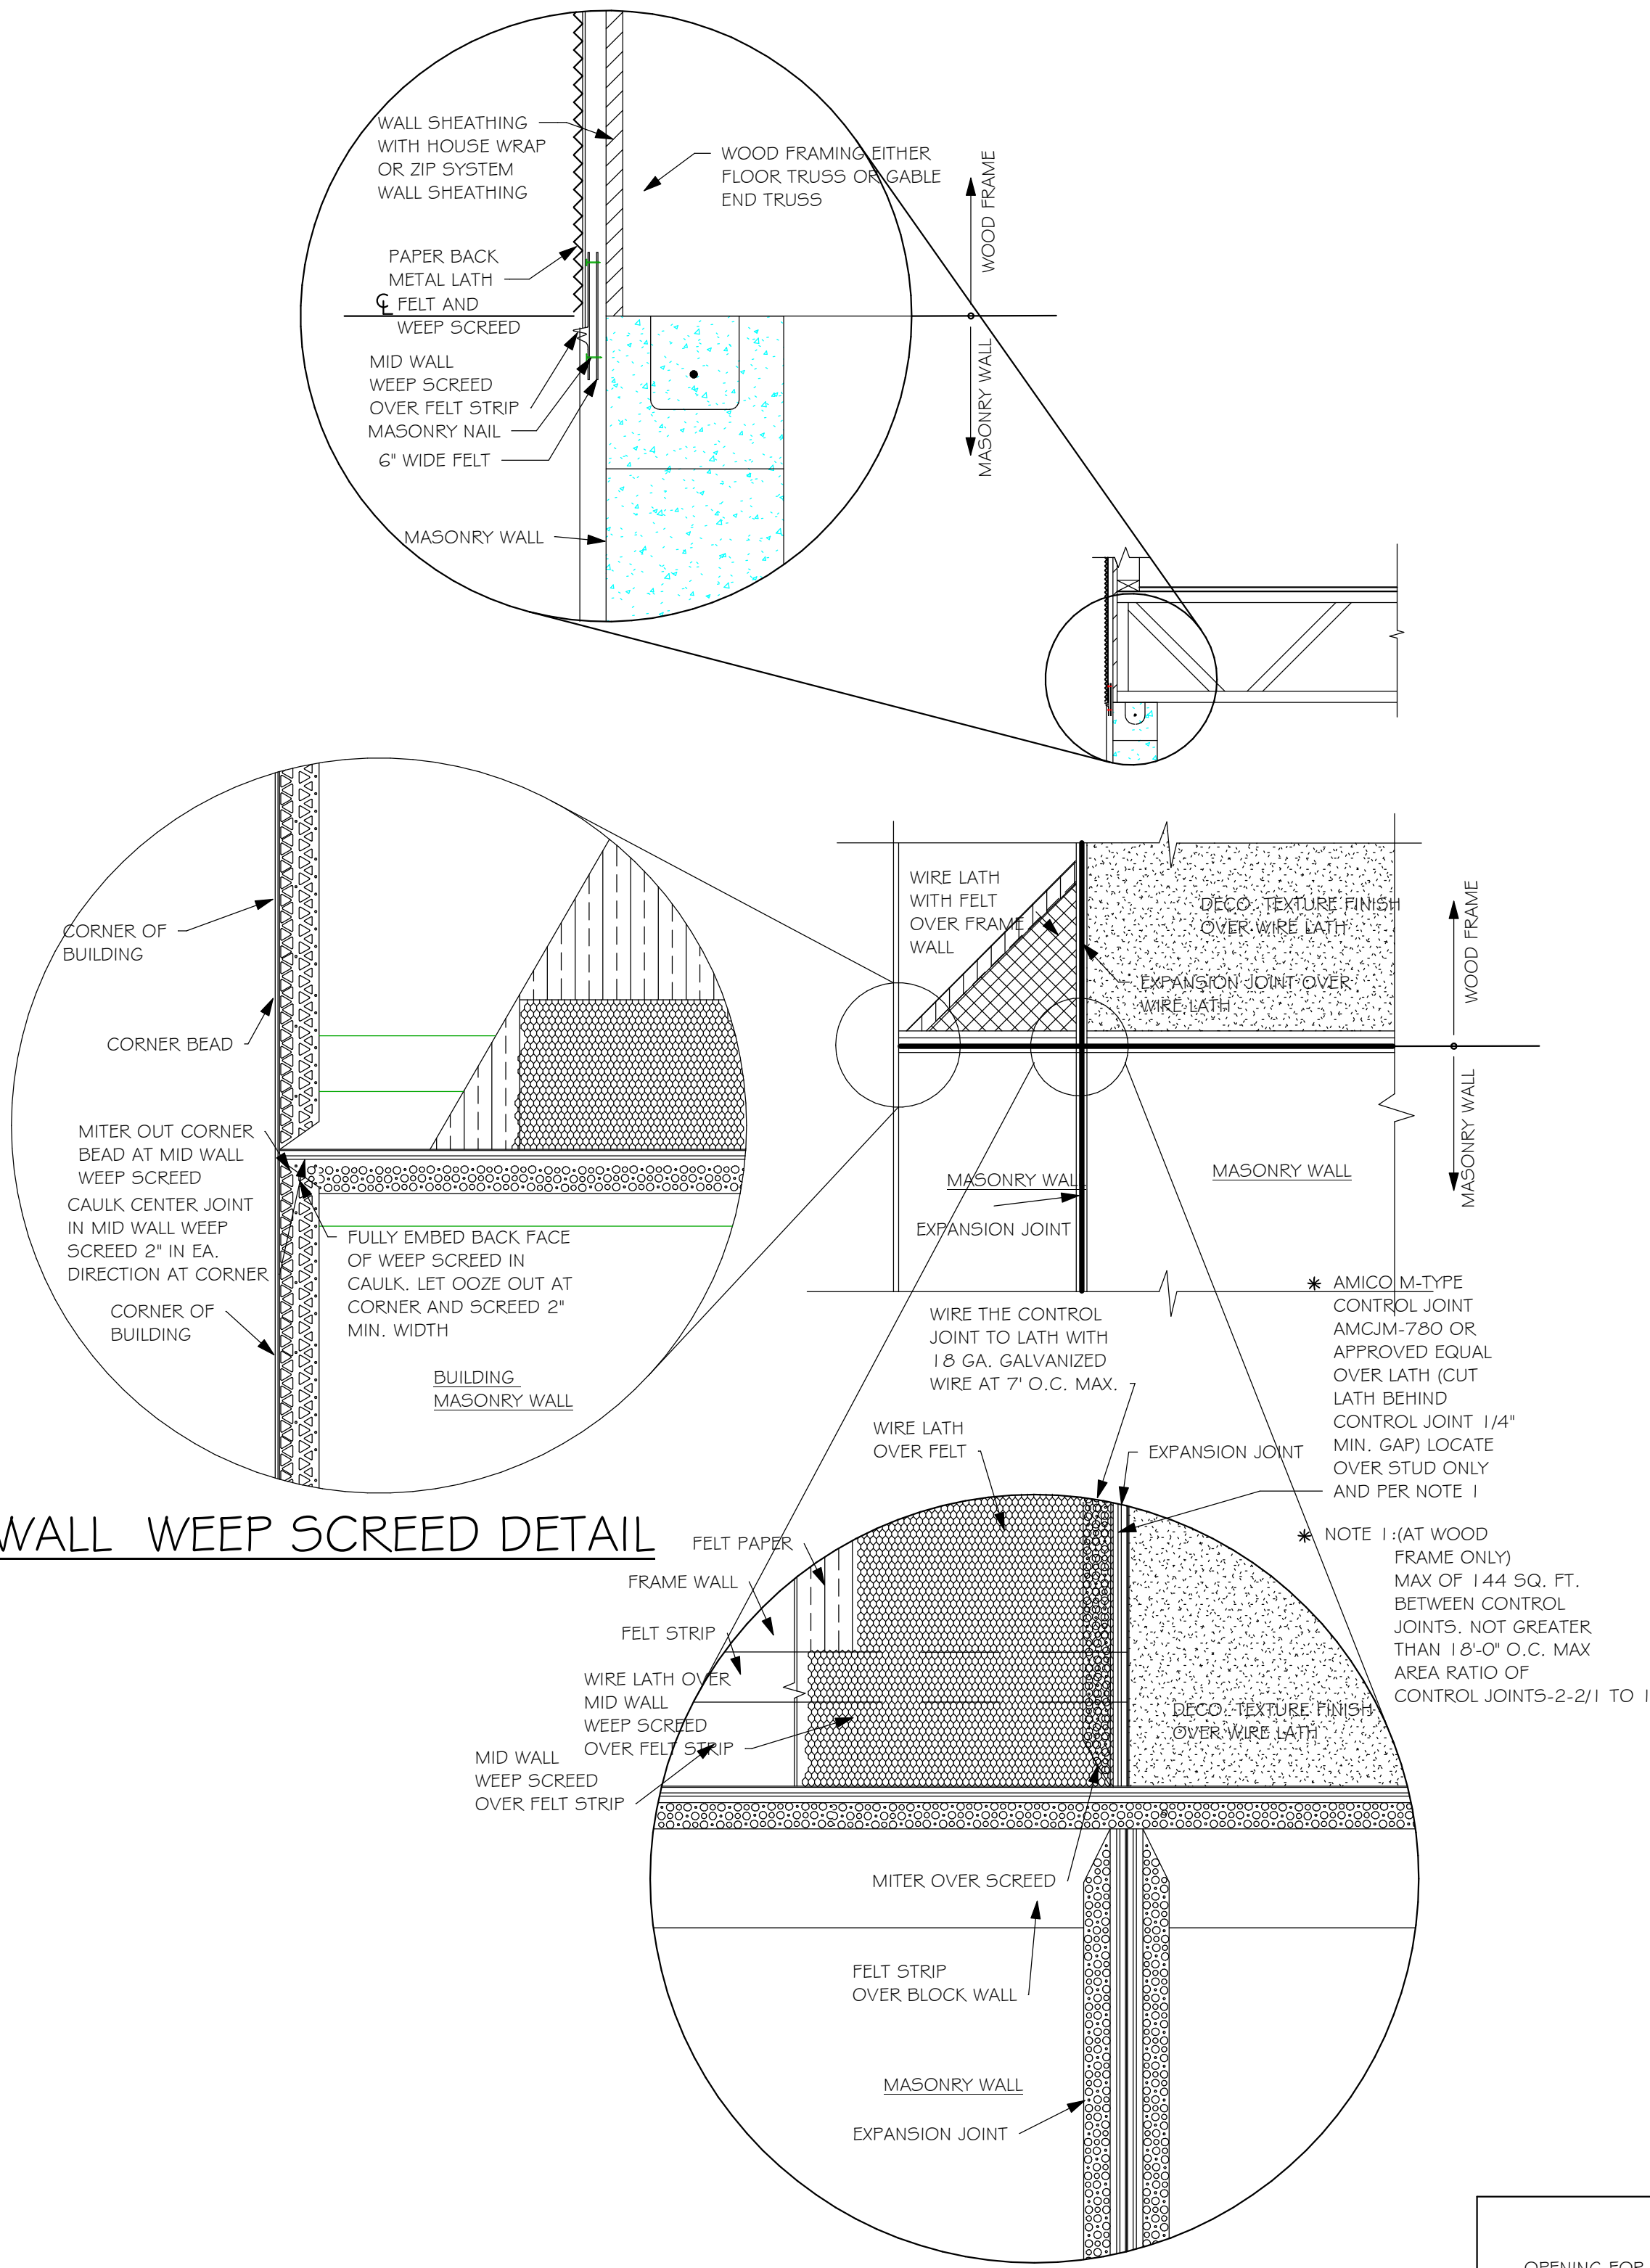INSTALL AT ALL EXTERIOR WALL LOCATIONS WHERE WOOD STUD FRAMING IS ABOVE MASONRY WALLS.

RESIDENTIAL SPECIFICATIONS

GENERAL NOTES

1. THE CONTRACTOR SHALL VERIFY ALL CONDITIONS AND DIMENSIONS AT THE JOB SITE PRIOR TO COMMENCING WORK. THE CONTRACTOR SHALL REPORT ALL DISCREPANCIES BETWEEN THE DRAWINGS AND EXISTING CONDITIONS TO THE DESIGNER PRIOR TO COMMENCING WORK.
2. THE CONTRACTOR SHALL SUPPLY, LOCATE AND BUILD INTO THE WORK ALL INSERTS, ANCHORS, ANGLES, PLATES, OPENINGS, SLEEVES, HANGERS, SLAB DEPRESSIONS AND PITCHES AS MAY BE REQUIRED TO ATTACH AND ACCOMMODATE OTHER WORK.
3. ALL DETAILS AND SECTIONS SHOWN ON THE DRAWINGS ARE INTENDED TO BE TYPICAL AND SHALL BE CONSTRUCTED TO APPLY TO ANY SIMILAR SITUATION ELSEWHERE IN THE WORK EXCEPT WHERE A DIFFERENT DETAIL IS SHOWN.
4. SUBSURFACE SOIL CONDITION INFORMATION IS NOT AVAILABLE FOUNDATIONS ARE DESIGNED FOR A SOIL BEARING CAPACITY OF 2,000 PSF. THE CONTRACTOR SHALL REPORT ANY DIFFERING CONDITIONS TO THE DESIGNER PRIOR TO COMMENCING WORK.
5. STRUCTURAL DRAWINGS SHALL BE USED IN CONJUNCTION WITH JOB SPECIFICATION AND HOUSE PLANS, MECHANICAL, ELECTRICAL, PLUMBING, AND SITE DRAWINGS, CONSULT THESE DRAWINGS FOR SLEEVES, DEPRESSIONS AND OTHER DETAILS NOT SHOWN ON STRUCTURAL DRAWINGS.
6. ALL SPECIFIED FASTENERS MAY ONLY BE SUBSTITUTED IF APPROVED BY THE ENGINEER IN WRITING, THE INSTALLATION OF THE FASTENERS SHALL BE IN ACCORDANCE WITH THE MANUFACTURER'S SPECIFICATIONS. SIMPSON FASTENERS SPECIFIED MAY BE SUBSTITUTED WITH THE SAME QUANTITY AND EQUIVALENT STRENGTH PRODUCT. ALL BOLTS, NUTS, WASHERS, STRAPS AND FASTENERS INCLUDING NAILS, SHALL BE HOT MOPED DIPPED GALVANIZED OR STAINLESS STEEL CONTINUOUS ANCHORAGE SHALL BE PROVIDED BETWEEN ALL TRUSSES, WALL SECTIONS, BEAMS, POSTS AND FOOTINGS WITH USE OF STRAPS AND CONNECTORS AS SPECIFIED HEREIN.
7. TREATED WOOD REQUIREMENTS:- ALL TREATED WOOD EXPOSED TO WEATHER SHALL BE PROTECTED, PRESSURE TREATED, OR NATURALLY RESISTANT TO DECAY. ALL WOOD TOUCHING MASONRY OR CONCRETE SHALL BE ISOLATED, OR PRESSURE TREATED.
8. THE STRUCTURE IS DESIGNED TO BE SELF SUPPORTING AND STABLE AFTER THE BUILDING IS COMPLETE. IT IS THE CONTRACTOR'S SOLE RESPONSIBILITY TO DETERMINE ERECTION PROCEDURES AND SEQUENCES TO ENSURE SAFETY OF THE BUILDING AND ITS COMPONENTS DURING ERECTION. THIS INCLUDES THE NECESSARY SHORING, SHEETING, TEMPORARY BRACING, GUYS, OR TIE DOWNS.
9. CEILING DRYWALL INSTALLED WITHIN THE HOUSE TO TRUSSES SPACED 24" O.C. SHALL BE 5/8" DRYWALL OR 1/2" SAG RESISTANT PER SEC. 702.3.5
10. LANAI CEILINGS * COVERED ENTRY CEILINGS 1X4 STRIPPING @ 16" O.C. FASTENED WITH 2-8d NAILS TO EACH TRUSS, 5/8" EXTERIOR GYP. BOARD CEILING FASTENED WITH 8d NAILS OR 1-5/8" DRYWALL SCREWS @ 6" O.C. EDGE AND FIELD.


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GENERAL ROOF ASSEMBLY

ROOF SHEATHING SHALL BE APA RATED SHEATHING, EXPOSURE 1, SPAN RATING 24/16 OR BETTER. INSTALL PANELS WITH LONG DIMENSION PLACED PERPENDICULAR TO TRUSSES. A 1/8" SPACE BETWEEN ADJACENT SHEETS SHALL BE MAINTAINED. INSTALL "H" CLIPS AT UNSUPPORTED PANEL EDGES. THE ROOF SHEATHING SHALL BE NAILED WITH 8d RING SHANK NAILS @ 4" O.C. EDGE AND 6" O.C. FIELD. ENSURE THAT ALL NAILS PENETRATE THE TOP CHORD OF THE TRUSSES WITHOUT SPLITTING. RING SHANK NAILS PER R803.2.3.1 - 0.113" NOMINAL SHANK DIAMETER, RING DIAMETER OF 0.012" OVER SHANK DIAMETER, 16 TO 20 RINGS PER INCH, 0.280" DIAMETER FULL ROUND HEAD, 2" NAIL LENGTH.

FLASHING FLASHING SHALL BE ALUMINUM, ALUMINUM ZINC COATED STEEL 0.0179" THICK, 26 GAUGE AZ50 ALUM ZINC, OR GALVANIZED STEEL 0.0179" THICK, 26 GAUGE ZINC COATED G90. FLASHING SHALL BE INSTALLED IN ACCORDANCE WITH THE ZIP SYSTEM ROOF SHEATHING MANUFACTURERS PUBLISHED REQUIREMENTS. ALL FLASHING AND INSTALLATION SHALL CONFORM TO SECTION R905.2.8 (1 TO 5).

DRIP EDGE DRIP EDGE SHALL BE PROVIDED AT ALL EAVES AND GABLES OF SHINGLES ROOFS, LAPPED A MINIMUM OF 3" @ JOINTS. THE OUTSIDE EDGE SHALL EXTEND A MINIMUM OF 1/2" BELOW SHEATHING AND THE INSIDE EDGE SHALL EXTEND BACK A MINIMUM OF 2". DRIP EDGE SHALL BE FASTENED AT NO MORE THAN 4" CENTERS. THERE SHALL BE A MINIMUM OF 4" WIDTH OF ROOF CEMENT INSTALLED OVER THE DRIP EDGE FLANGE.

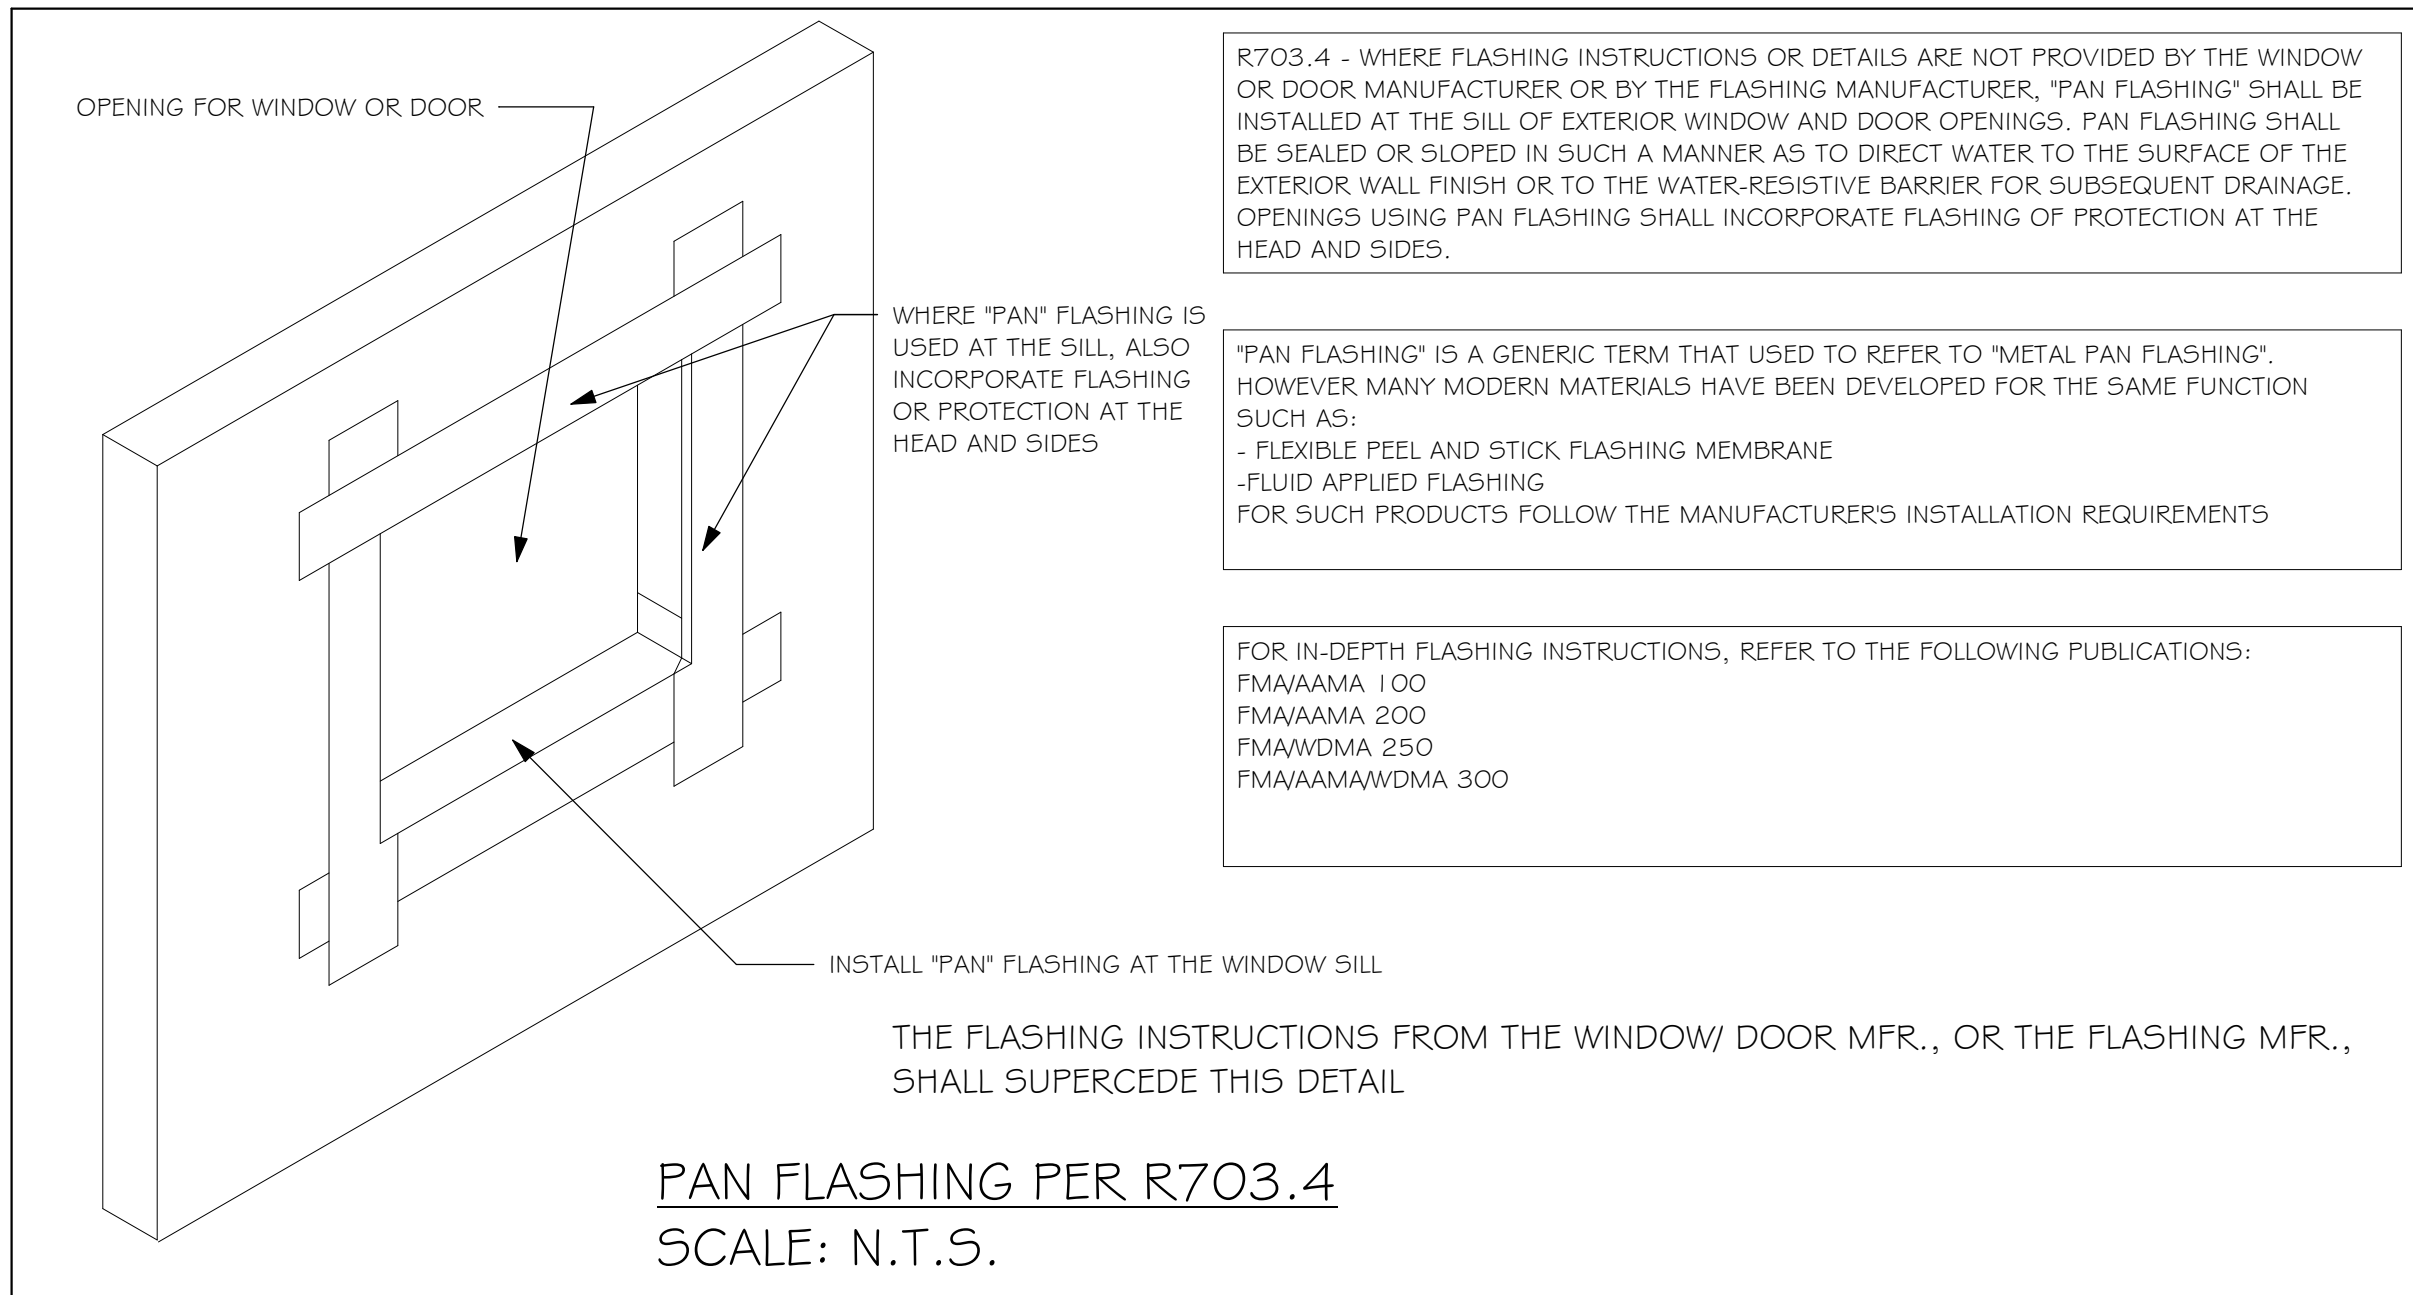

PAN FLASHING PER R703.4

SCALE: N.T.S.

3

ASPHALT SHINGLE ROOF SPECS

SHINGLES

1/4" FELT SHALL BE INSTALLED UNDER ASPHALT SHINGLES. ALL ASPHALT SHINGLES SHALL HAVE SELF-SEALING STRIPS OR BE INTERLOCKING AND COMPLY WITH ASTM D 225 OR D 3462, AND SHALL BE SECURED TO THE ROOF WITH NO LESS THAN 6 FASTENERS PER SHINGLE STRIP, OR A MINIMUM OF 2 FASTENERS PER SHINGLE TAB, AND SHALL IN NO CASE BE FASTENED WITH LESS FASTENERS THAN THAT REQUIRED BY THE MANUFACTURE. INSTALLATION SHALL COMPLY WITH MANUFACTURER'S REQUIREMENTS FOR INSTALLATION IN THE GIVEN FLORIDA WIND ZONE, AS DETERMINED BY ASTM D 3161.

FASTENERS

FASTENERS FOR ASPHALT SHINGLES SHALL COMPLY WITH ASTM F 1667, AND SHALL BE MADE WITH GALVANIZED STEEL, STAINLESS STEEL OR ALUMINUM WITH A MINIMUM SHANK SIZE OF 12 GAUGE (0.105") WITH A MINIMUM 3/8" DIAMETER HEAD SHANK AND SHALL BE A LENGTH TO PENETRATE THE SHEATHING

THE NAIL COMPONENT OF PLASTIC CAP NAILS SHALL MEET OR EXCEED THE REQUIREMENTS OF ASTM A 641, CLASS 1, OR EQUAL, AND SHALL BE CORROSION RESISTANT BY ELECTRO GALVANIZATION, MECHANICAL GALVANIZATION, HOT DIPPED GALVANIZATION OR SHALL BE MADE OF STAINLESS STEEL, NON-FERROUS METAL

4

CLAY AND CONCRETE ROOF TILE SPECS

INSTALL FEEEL AND STICK UNDERLAYMENT APPROVED FOR SINGLE LAYER APPLICATION UNDER TILE ROOF.

THE INSTALLATION OF CLAY AND CONCRETE TILE SHALL COMPLY WITH THE PROVISIONS OF R905.3 F.B.C. MARKING: EACH ROOF TILE SHALL HAVE A PERMANENT MANUFACTURER'S IDENTIFICATION MARK.


APPLICATION SPECIFICATIONS: THE TILE MANUFACTURER'S WRITTEN APPLICATION SPECIFICATIONS SHALL BE AVAILABLE AND SHALL INCLUDED BUT NOT BE LIMITED TO THE FOLLOWING:

1. TILE PLACEMENT AND SPACING,
2. ATTACHMENT SYSTEM NECESSARY TO COMPLY WITH CURRENT WIND CODE.
- A. AMOUNT AND PLACEMENT OF MORTART
- B. AMOUNT AND PLACEMENT OF ADHESIVE
- C. TYPE, NUMBER, SIZE AND LENGTH OF FASTENERS AND CLIPS.
3. UNDERLAYMENT
4. SLOPE REQUIREMENT.


5

FLOOR SHEATHING AT 2ND FLOOR

A.P.A. RATED STURDI-FLOOR, EXPOSURE 1, TONGUE & GROOVE EDGES SPAN RATING 48/24 OR BETTER, GLUED AND NAILED

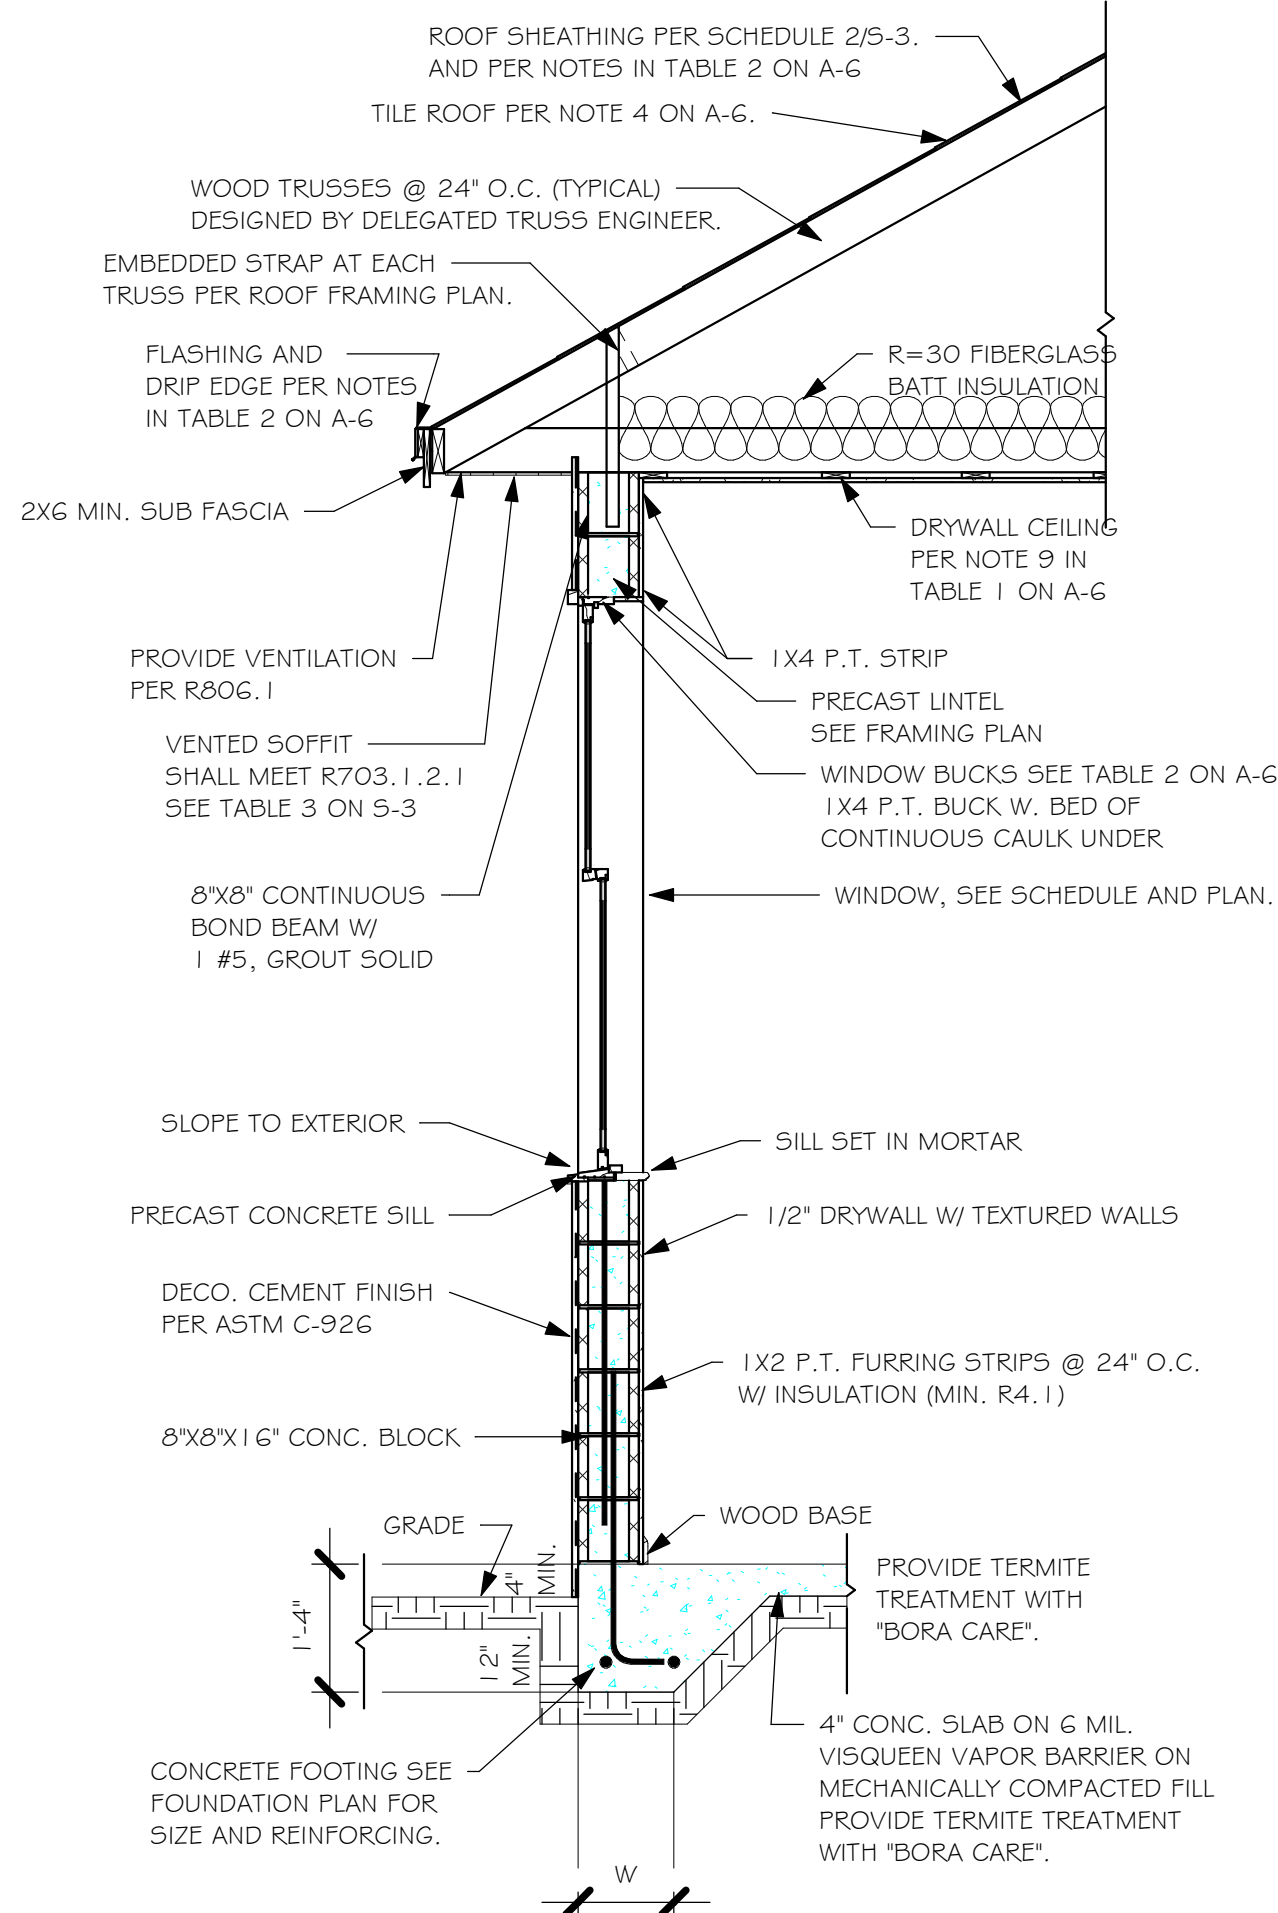

MONO TYPICAL WALL SECTION
1/2" = 1'-0"

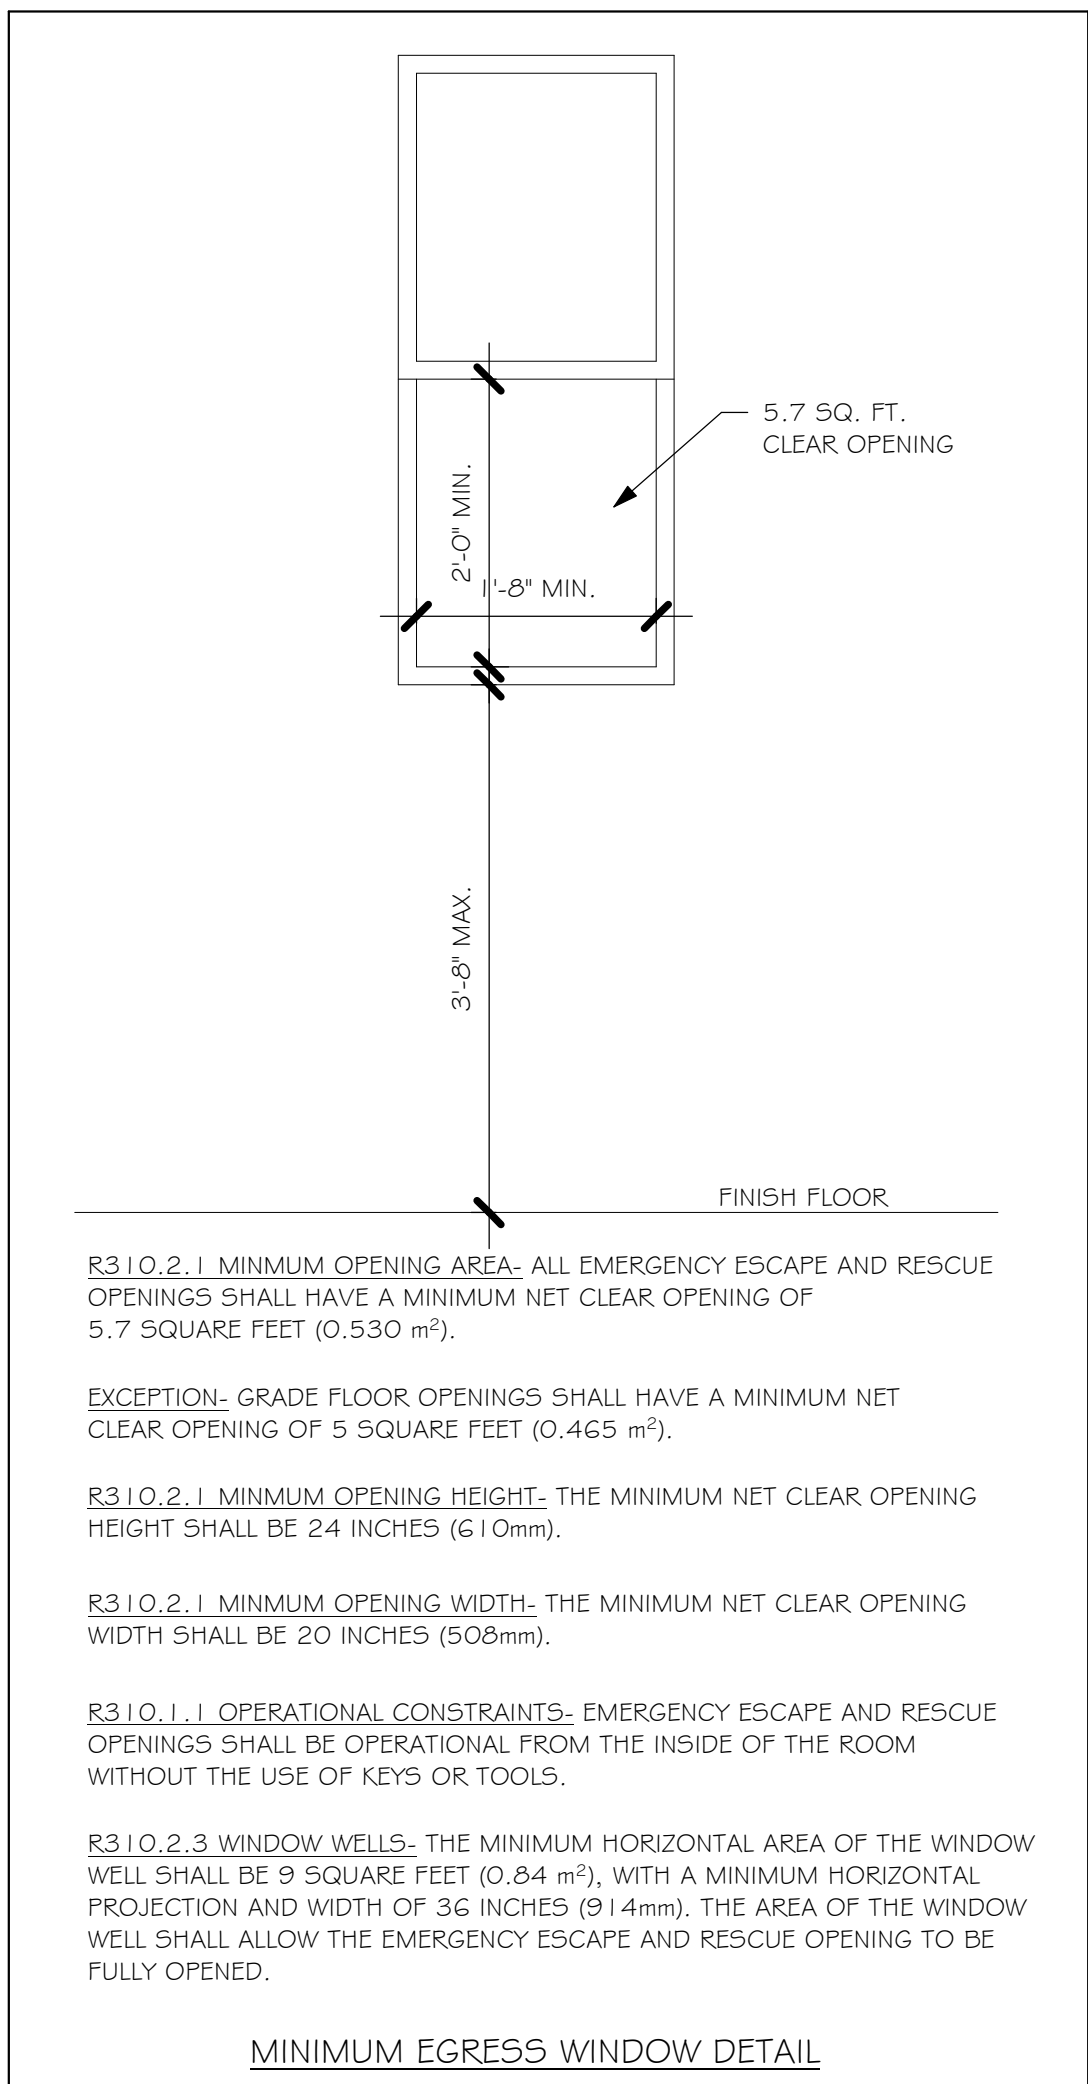

R310.2.1 MINIMUM OPENING AREA: ALL EMERGENCY ESCAPE AND RESCUE OPENINGS SHALL HAVE A MINIMUM NET CLEAR OPENING OF 5.7 SQUARE FEET (0.530 m²).

EXCEPTION- GRADE FLOOR OPENINGS SHALL HAVE A MINIMUM NET CLEAR OPENING OF 5.5 SQUARE FEET (0.465 m²).

R310.2.1 MINIMUM OPENING HEIGHT: THE MINIMUM NET CLEAR OPENING HEIGHT SHALL BE 24 INCHES (610mm).

R310.2.1 MINIMUM OPENING WIDTH: THE MINIMUM NET CLEAR OPENING WIDTH SHALL BE 20 INCHES (508mm).

R310.1.1 OPERATIONAL CONSTRAINTS: EMERGENCY ESCAPE AND RESCUE OPENINGS SHALL BE OPERATIONAL FROM THE INSIDE OF THE ROOM WITHOUT THE USE OF KEYS OR TOOLS.

R310.2.3 WINDOW WELLS: THE MINIMUM HORIZONTAL AREA OF THE WINDOW WELL SHALL BE 9 SQUARE FEET (0.84 m²), WITH A MINIMUM HORIZONTAL PROJECTION AND WIDTH OF 36 INCHES (914mm). THE AREA OF THE WINDOW WELL SHALL ALLOW THE EMERGENCY ESCAPE AND RESCUE OPENING TO BE FULLY OPENED.

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EMAIL: PLANS@GULFCOASTDRAFTING.COM
PHONE: 239-540-1822
1515 SE 47th ST. CAPE CORAL, FL 33904

LOT: 112
SUBDIVISION: TOSCANA ISLES EMERALD 80's
ADDRESS: 292 NARAYANA BLVD
D.R.H. #: 5787800002

Project Name
3692 K

DATE: 8/23/18

DRAWN BY: JSL

CHECKED BY: JWC


REVISED:

PLAN: SECTIONS

SCALE: As indicated

A-6 K


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LOT 112 3692 KRREV\10283 3692 KR.rvt

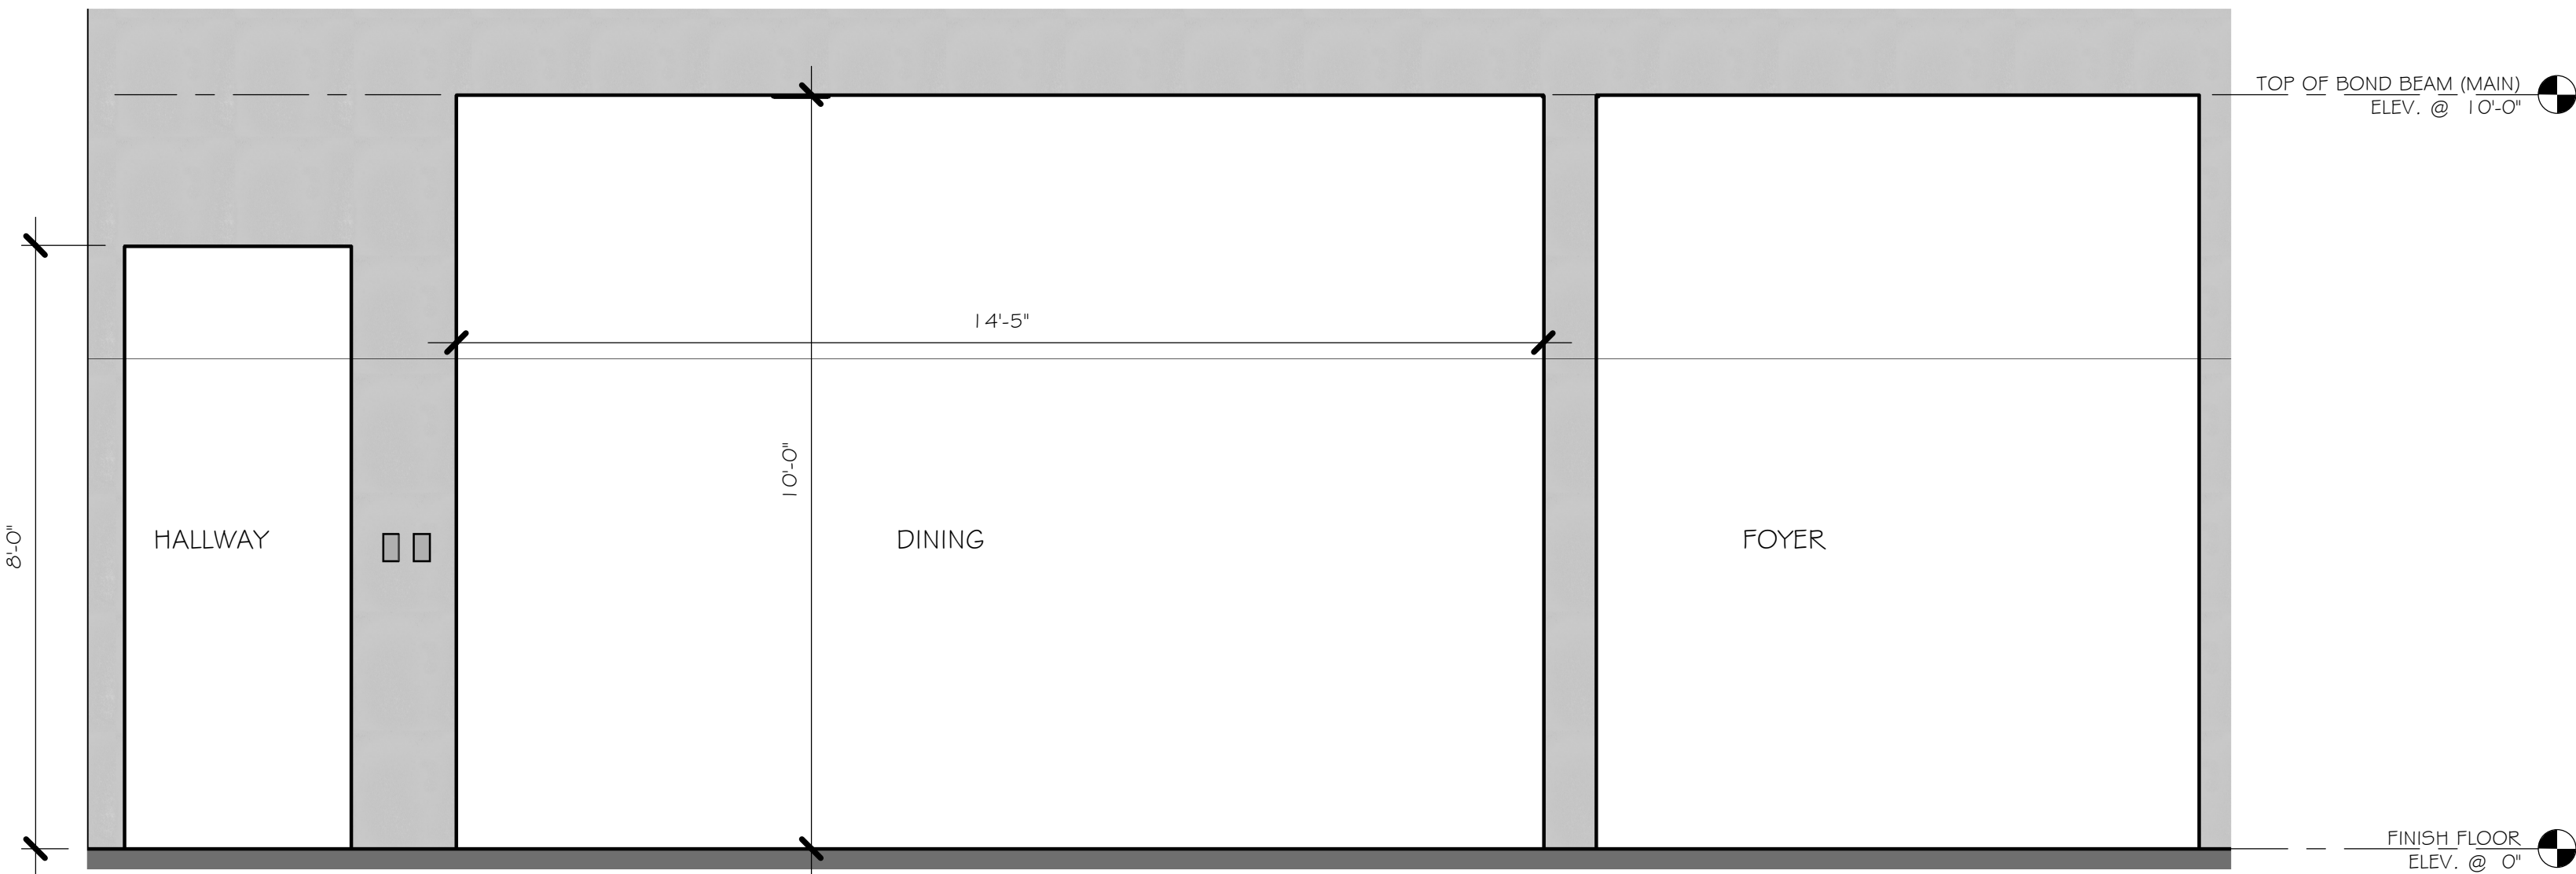


1 DINING/ FOYER/ HALLWAY
1/2" = 1'-0"




2 GREAT ROOM
1/2" = 1'-0"

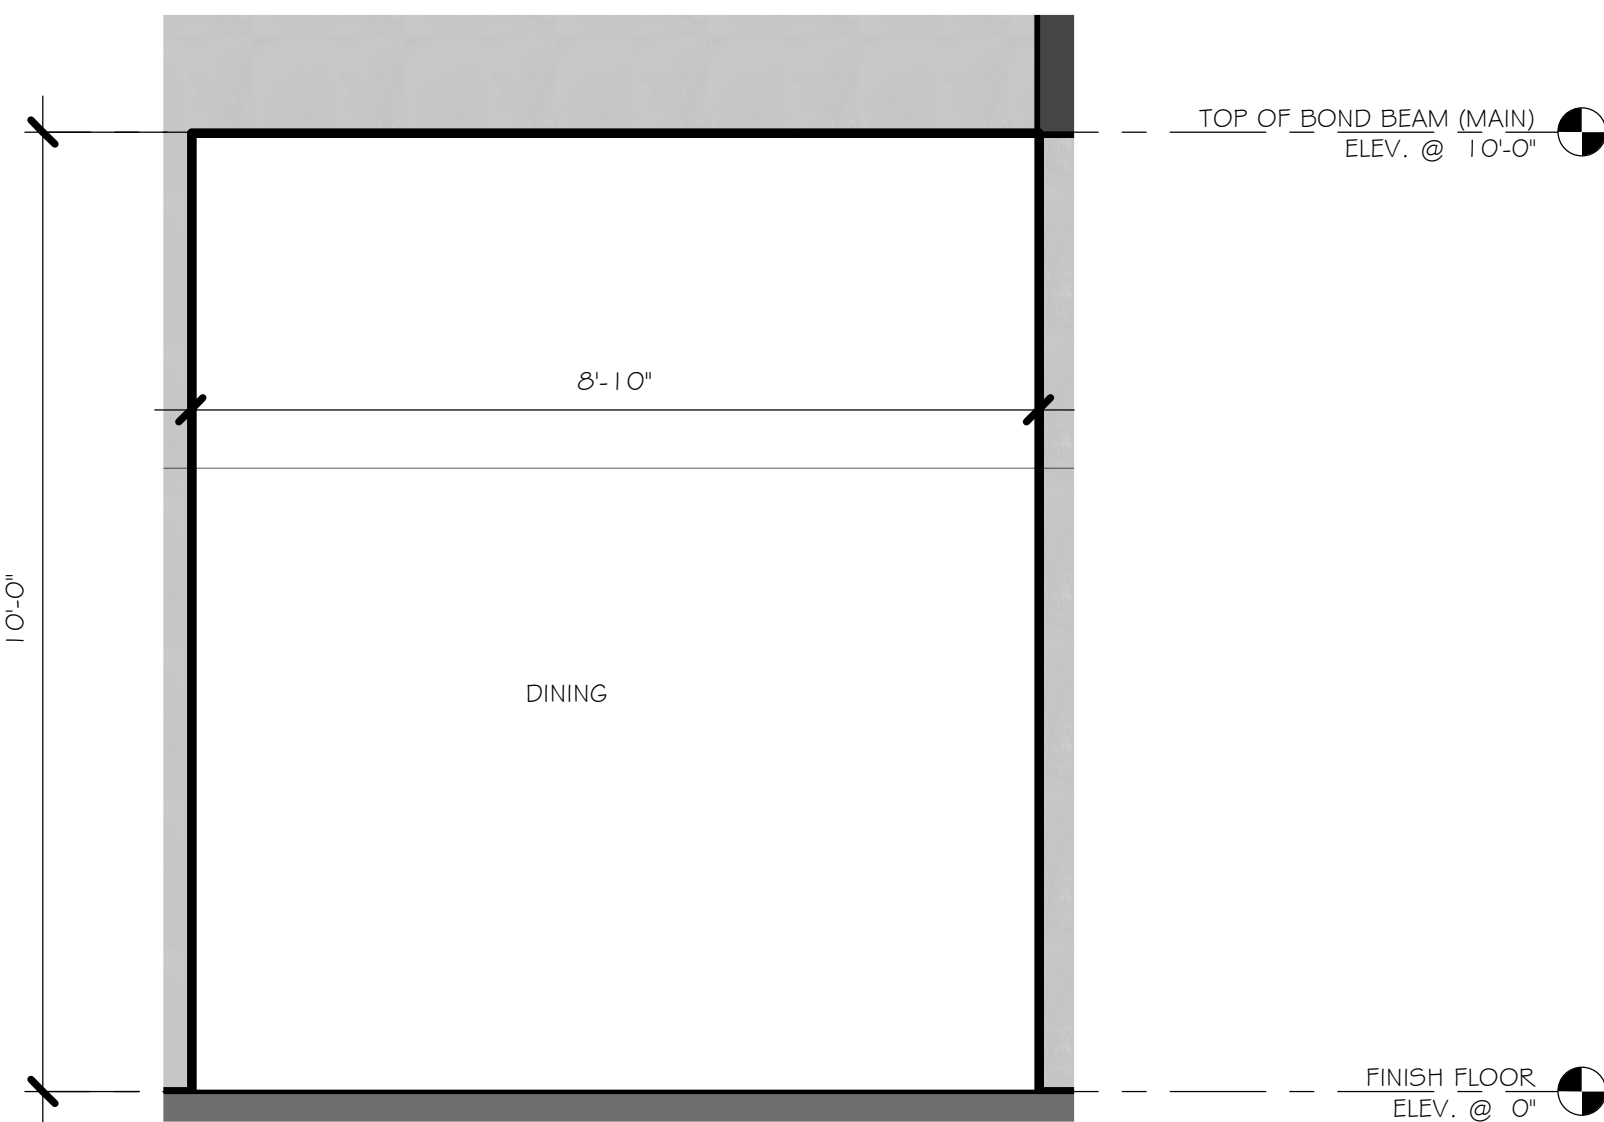


3 DINING/ FOYER
1/2" = 1'-0"

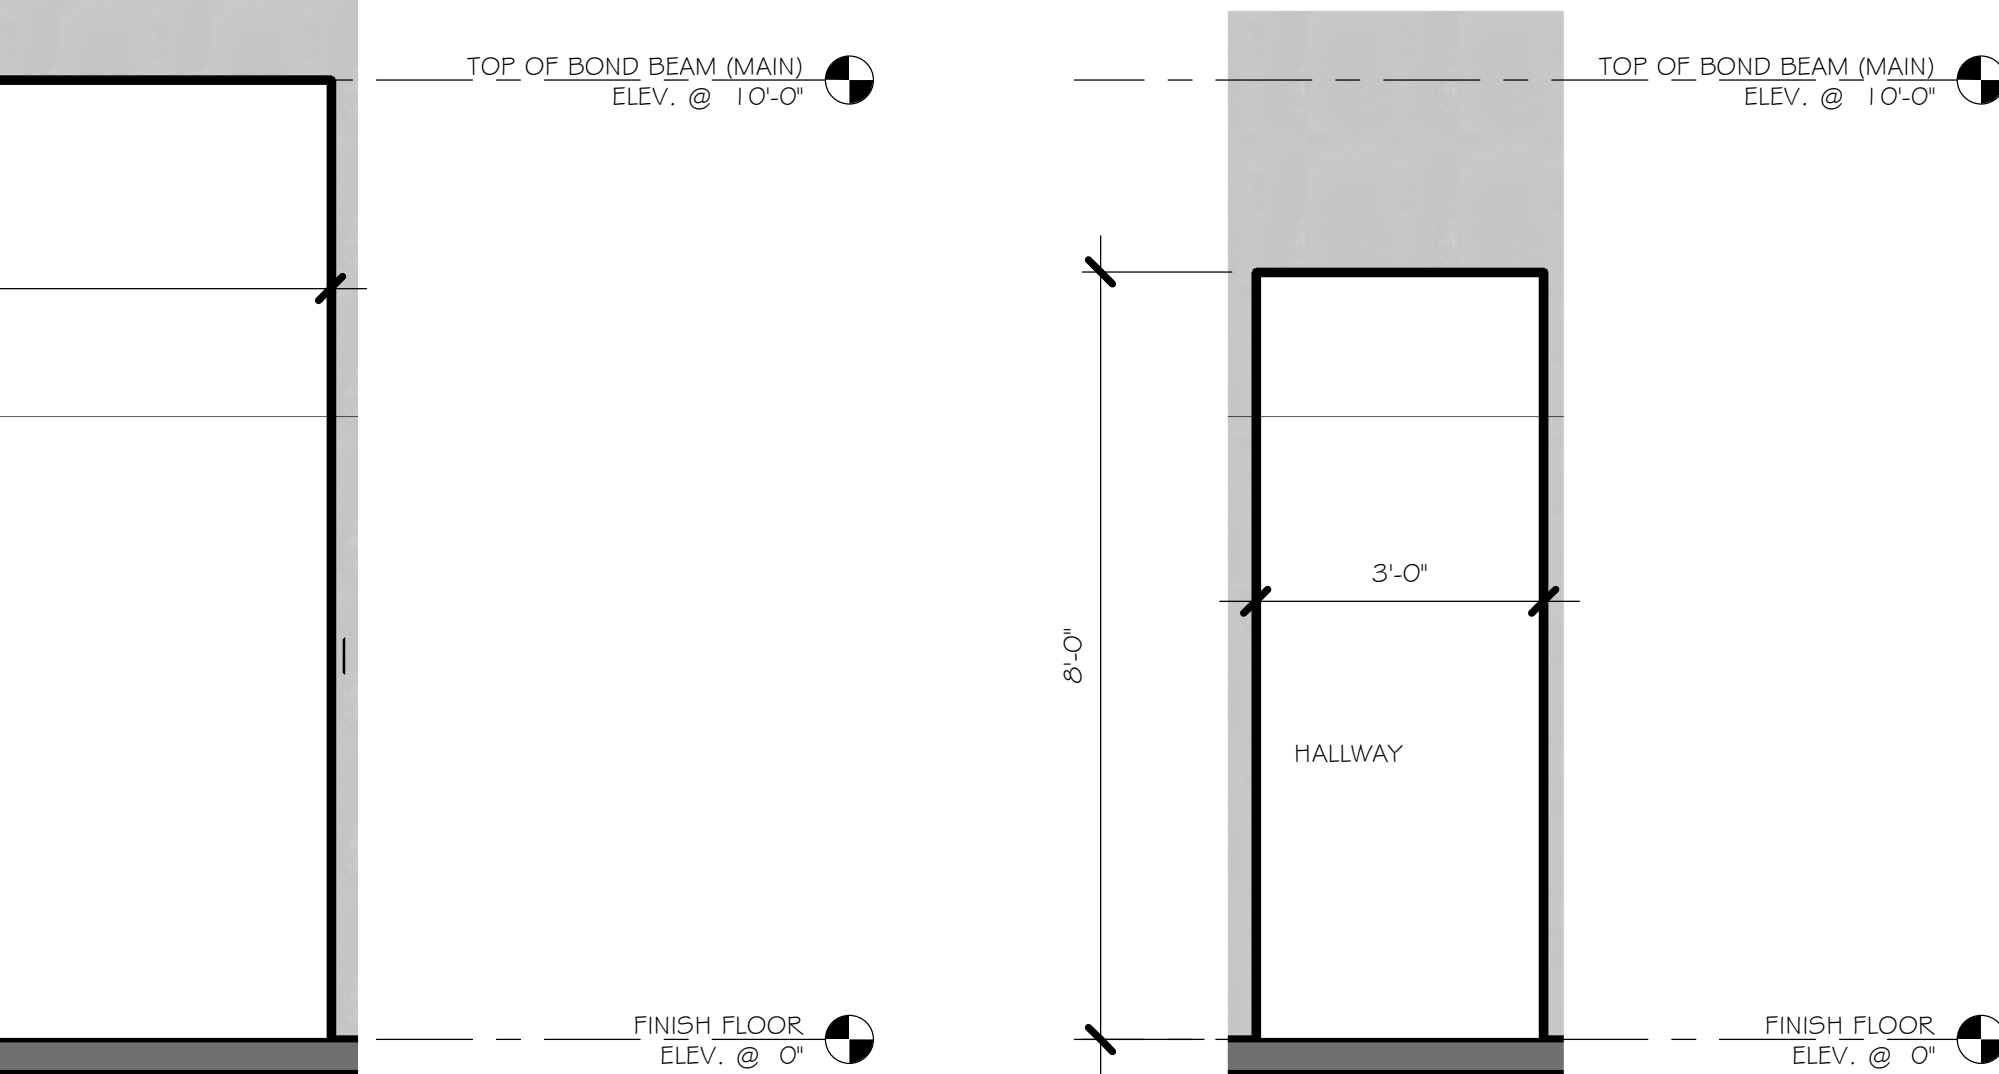


4 DINING HALLWAY
1/2" = 1'-0"

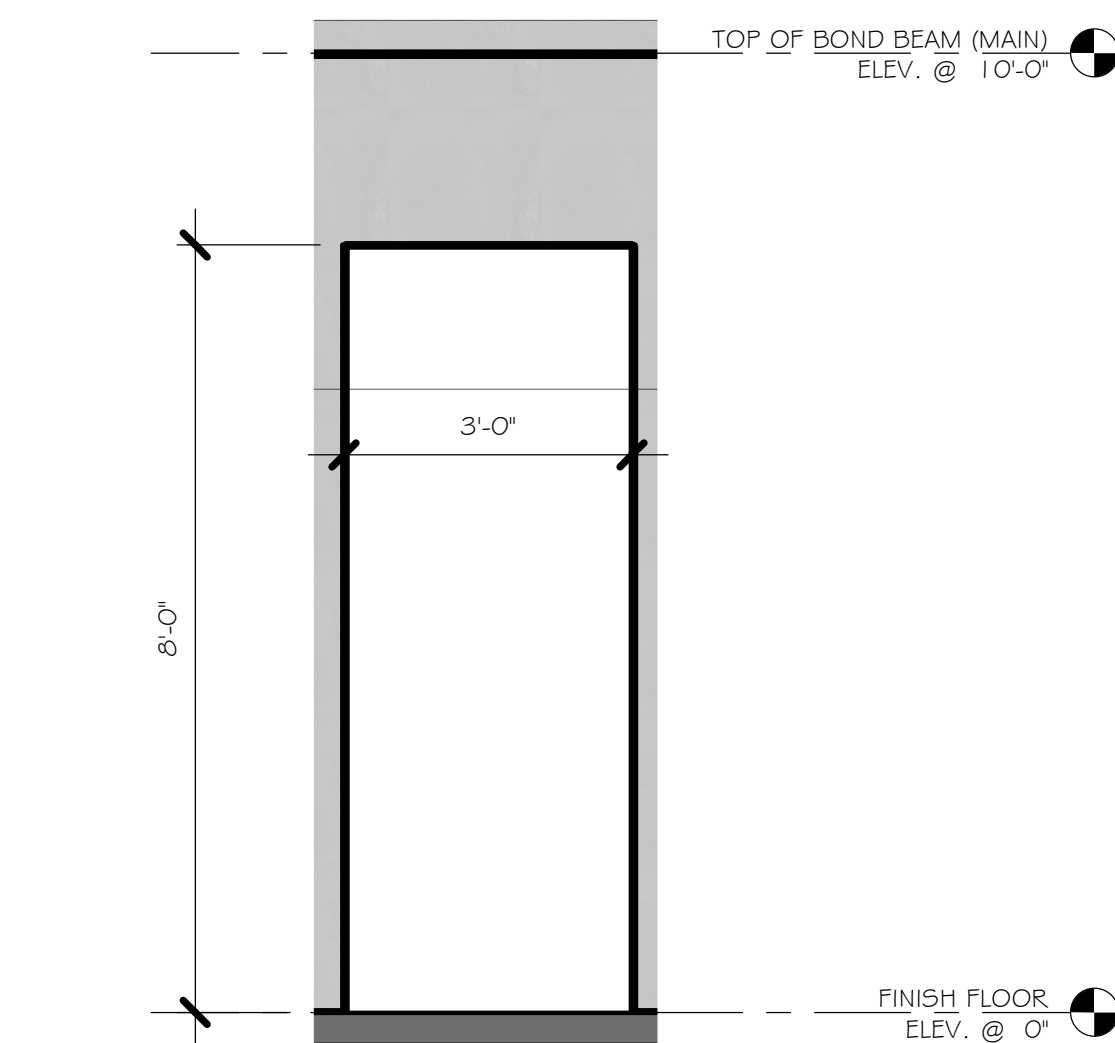


5 NOOK/ HALLWAY
1/2" = 1'-0"

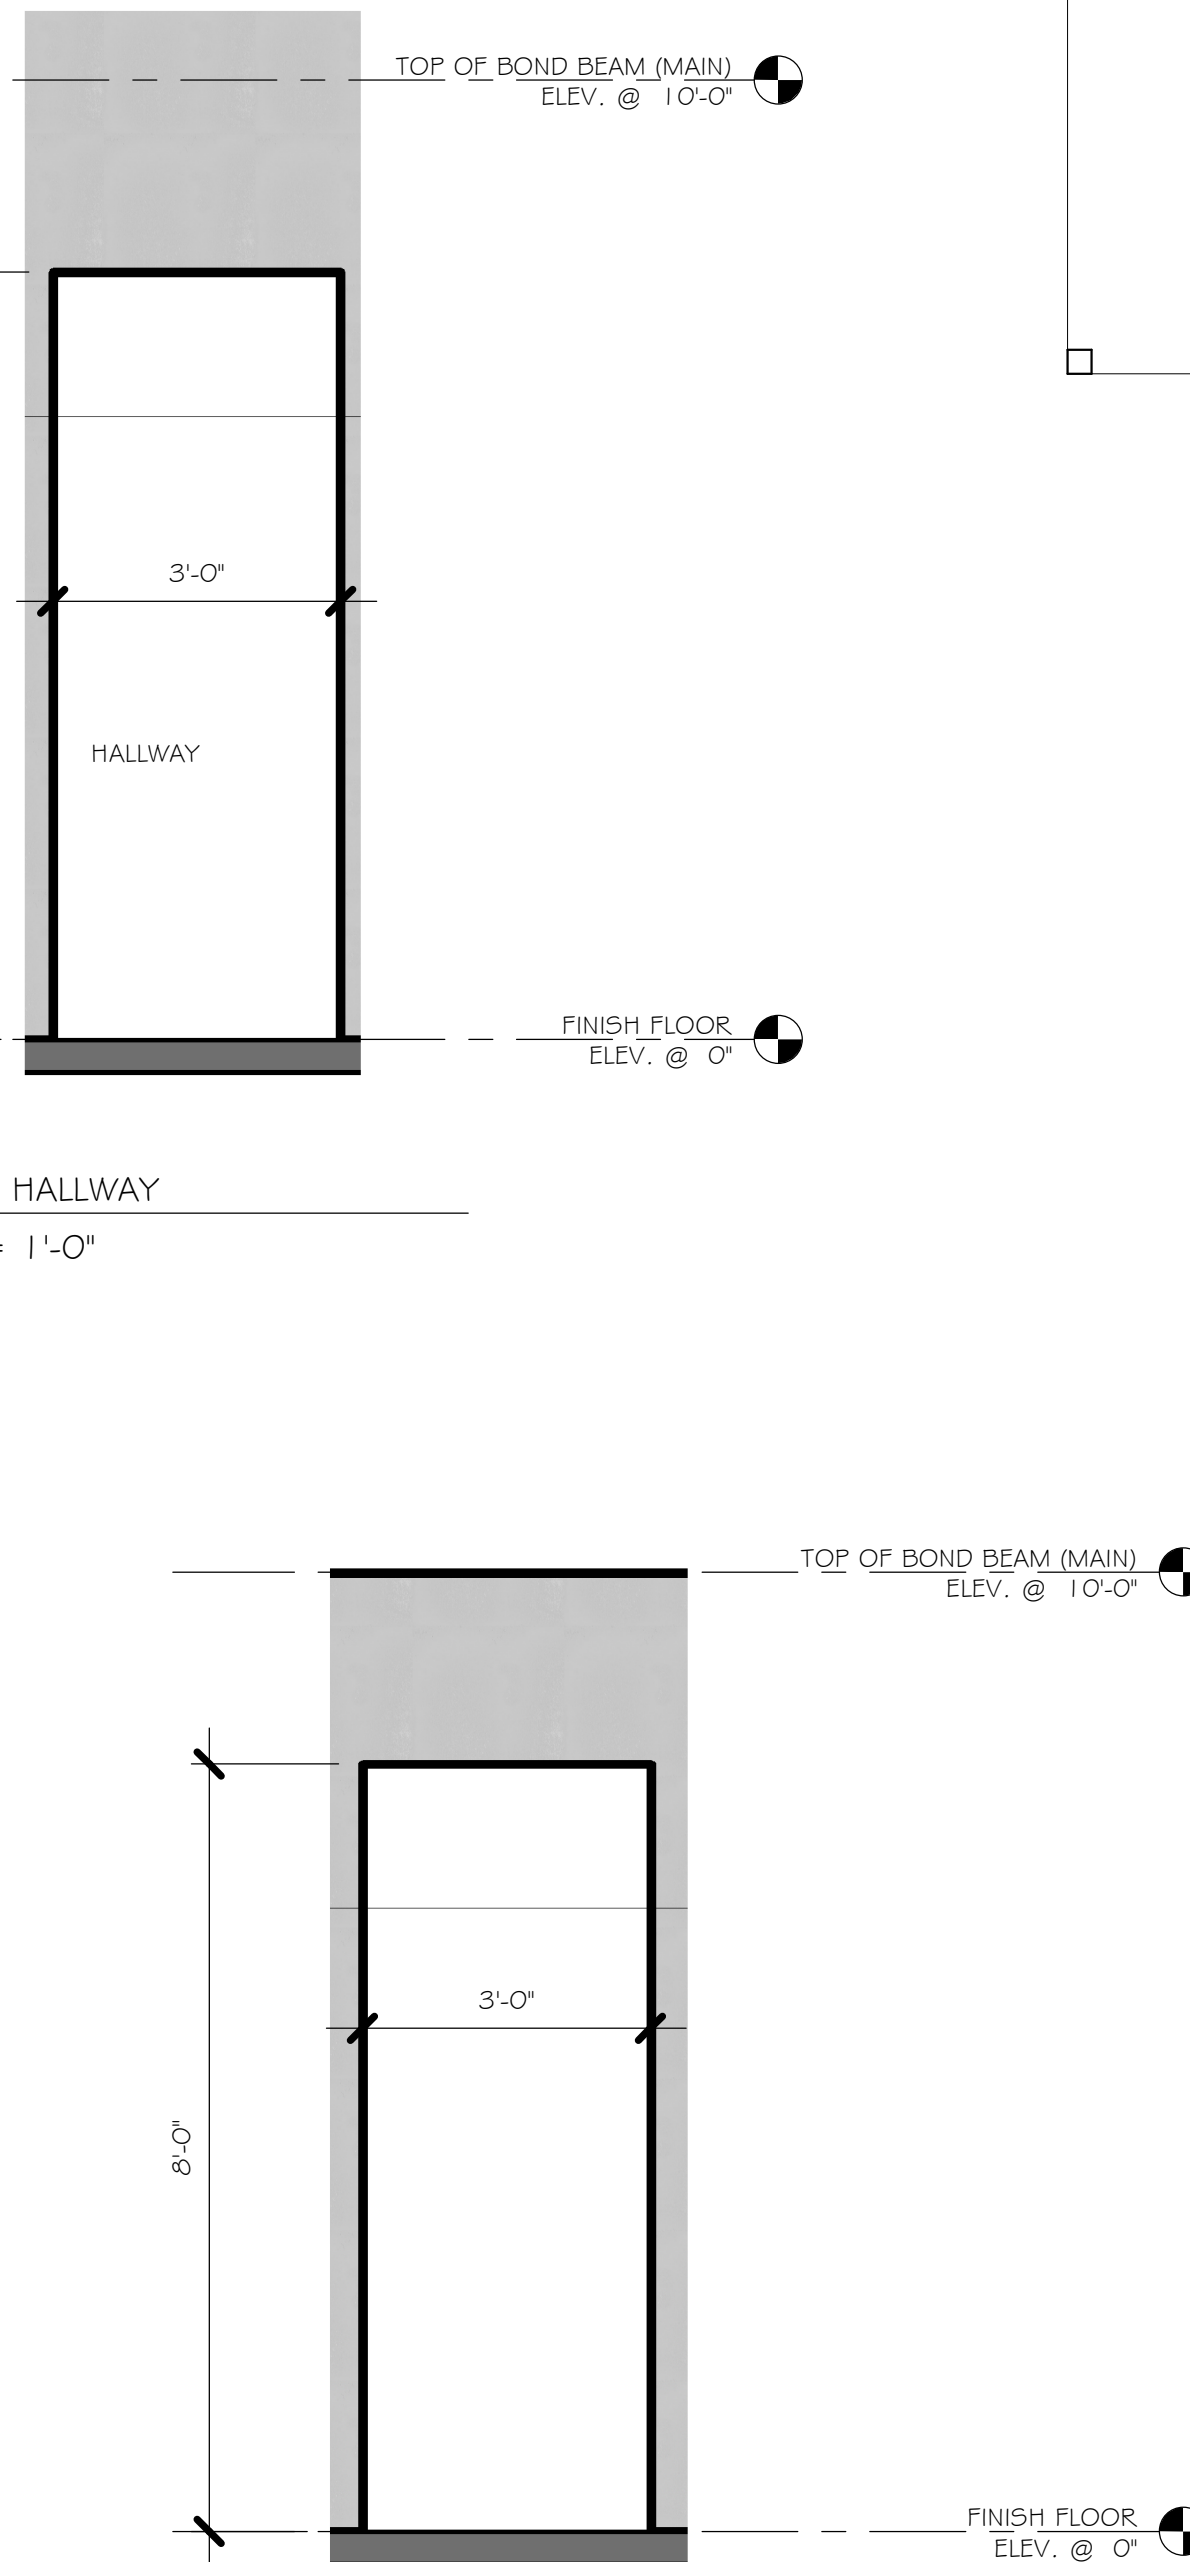

6 MASTER BEDROOM
1/2" = 1'-0"

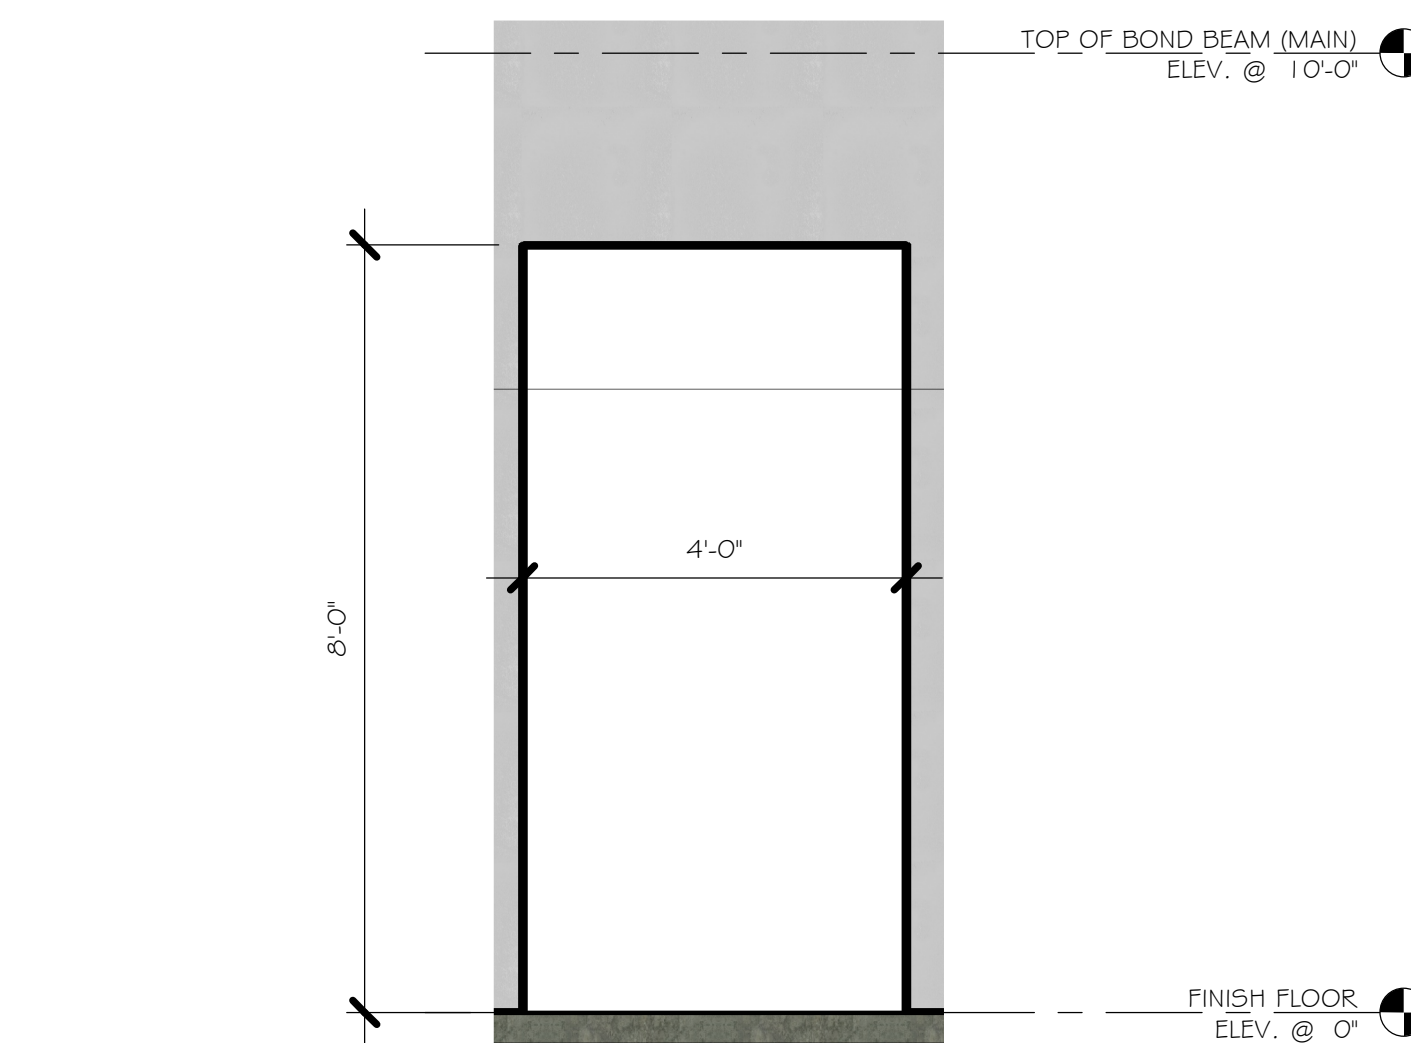

7 MASTER BEDROOM ENTRY
1/2" = 1'-0"

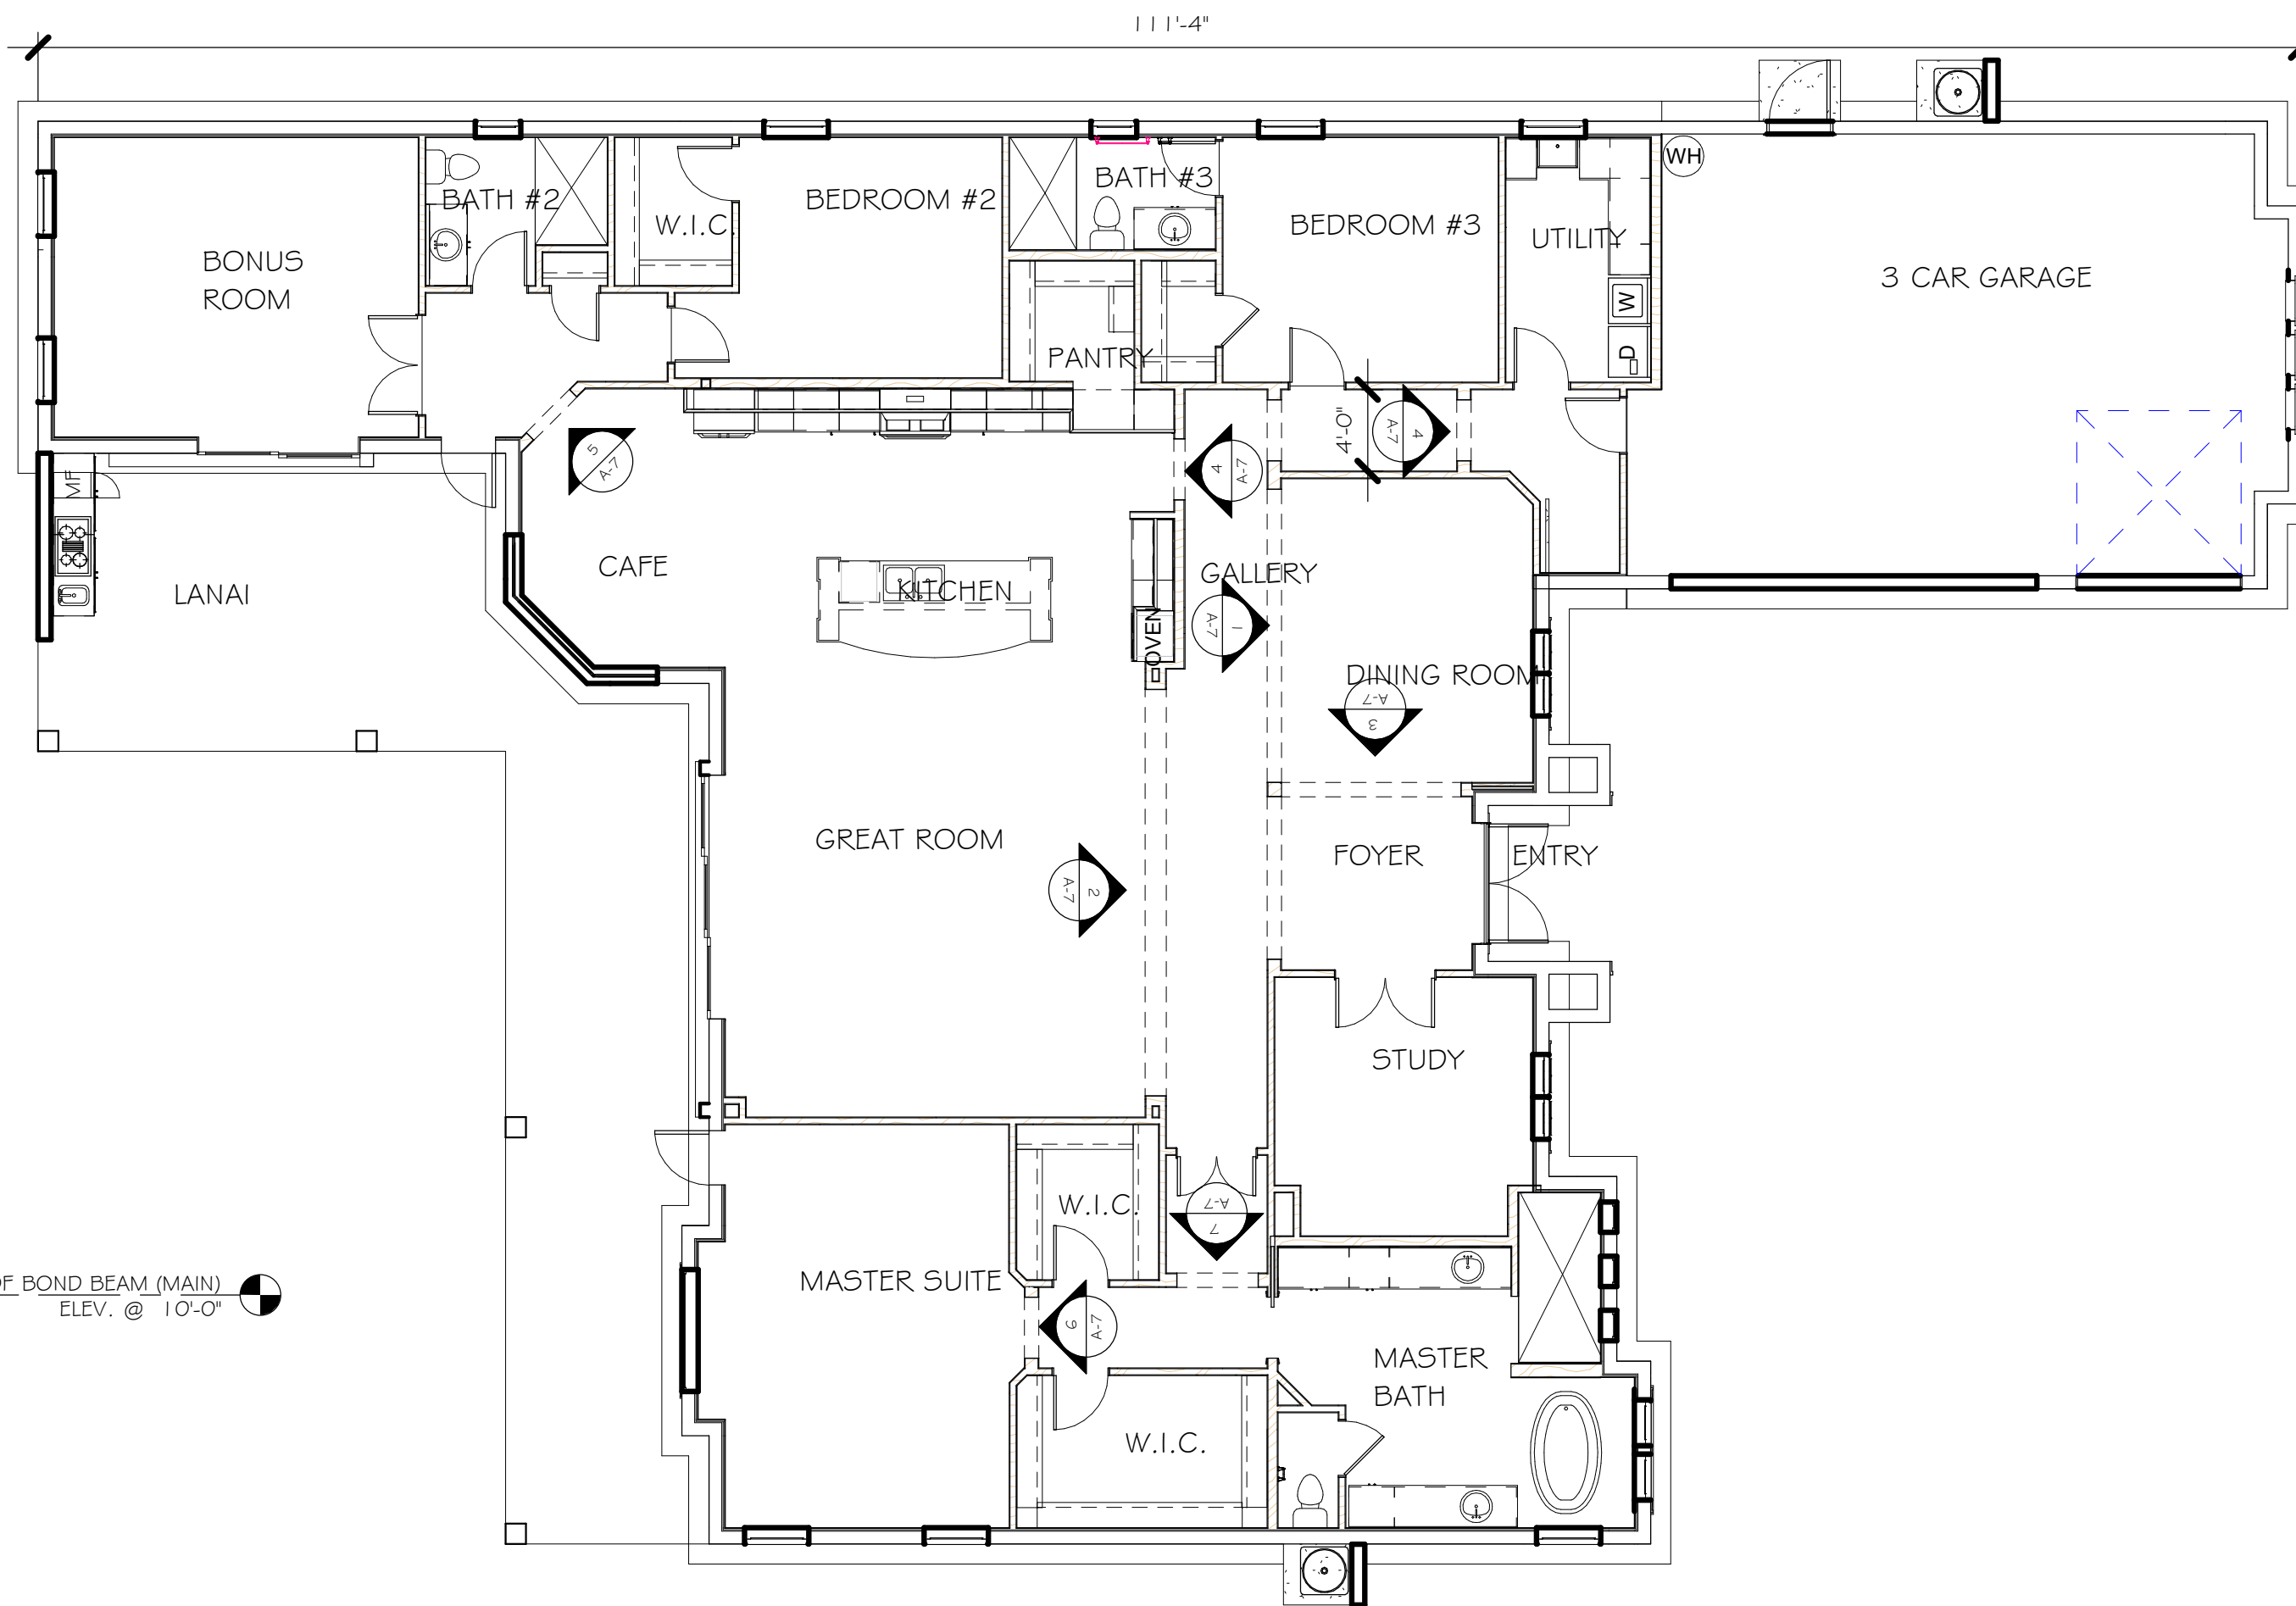

INTERIOR WALL SECTIONS
1/8" = 1'-0"

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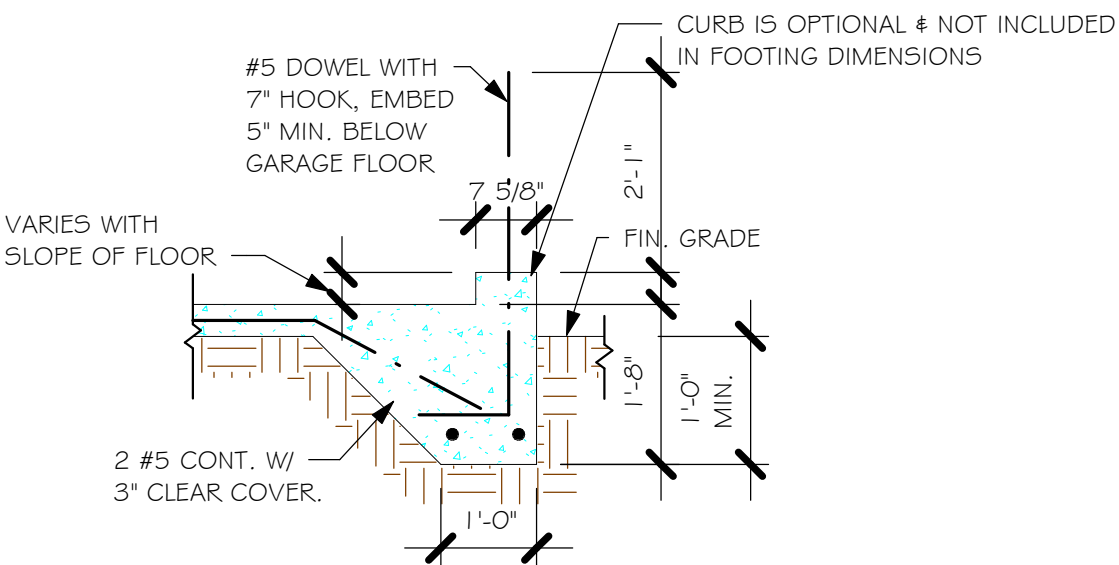
Project Name 3692 K	LOT: 112	SUBDIVISION: TOSCANA ISLES EMERALD 80's
	ADDRS: 292 MARAVIVA BLVD	
	D.R.H. #: 5787800002	
G.C.D. 10283		
DATE:	8/23/18	
DRAWN BY:	JSL	
CHECKED BY:	JWC	
REVISED:		
PLAN:	INTERIOR WALL SECTIONS	
SCALE:	As indicated	
A-7 K		

A-7 K


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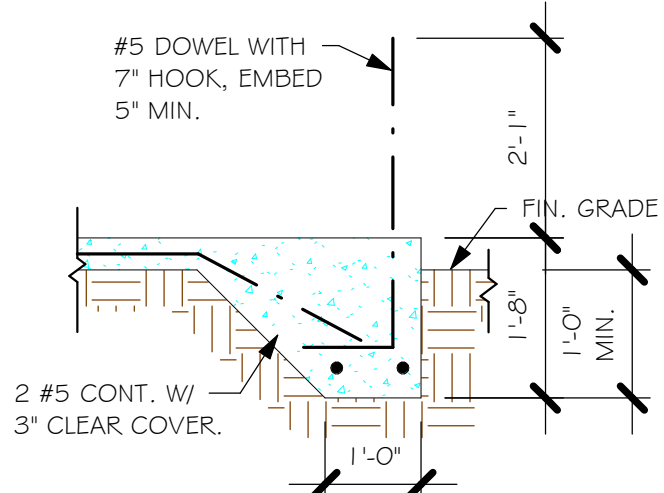
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LOT 112 3692 KRREV\10283 3692 KR.rvt




"F3" WITH CURB AT GARAGE
1/2" = 1'-0"




"F6A"
1/2" = 1'-0"

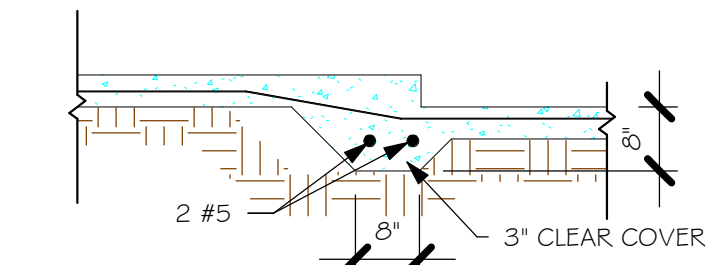


"F3" FOOTING
1/2" = 1'-0"

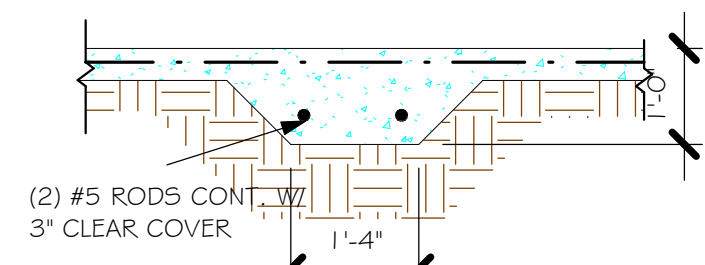

"F5" FOOTING
1/2" = 1'-0"

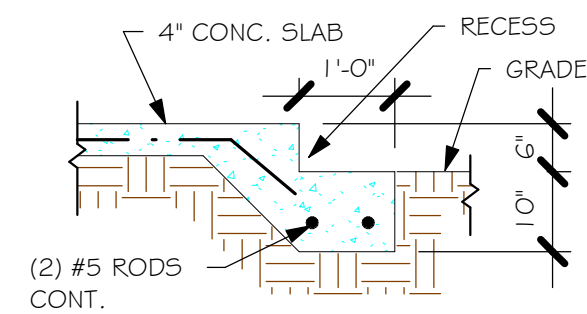

GARAGE DOOR RECESS
1/2" = 1'-0"

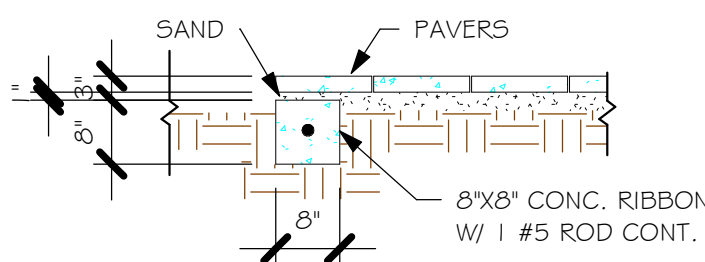

"P" PAVERS DETAIL ENTRY LANAI
1/2" = 1'-0"

FOUNDATION PLAN

- SCALE: 3/16" = 1'-0"
- PLAN NOTES:
- TOP OF GROUND FLOOR SLAB DATUM ELEVATION 0'-0"
 - "F#" DENOTES CONTINUOUS WALL FOOTING TYPE PER SCHEDULE THIS SHEET.
 - "P" DENOTES PAD FOOTING AT CONCENTRATED LOADS PER SCHEDULE THIS SHEET.
 - PROVIDE #5 VERTICAL REINFORCING AT DOT LOCATIONS SHOWN ON PLAN FROM FOOTING TO BOND BEAM.
 - ALL DIMENSIONS ARE TO OUTSIDE FACE OF MASONRY WALLS. SOME SLAB EDGES MAY EXTEND BEYOND FACE OF WALL.
 - FOR DIMENSIONS OF ROUGH OPENINGS IN MASONRY WALLS, COORDINATE WITH WINDOW/DOOR SUPPLIER.
 - PROVIDE PRESSURE TREATED BUCKS AT WINDOWS/DOORS PER DETAIL 7/S-3.

PAD FOOTING SCHEDULE

NO.	TYPE	LENGTH	WIDTH	DEPTH	BOTTOM REINF.		REMARKS
					LONG WAY	SHORT WAY	
A	2'-6"	2'-6"	1'-0"	3'-5"	3-#5	3-#5	-
B	3'-0"	3'-0"	1'-0"	4-#5	4-#5	4-#5	-
C	3'-6"	3'-6"	1'-0"	4-#5	4-#5	4-#5	-
D	4'-0"	4'-0"	1'-2"	5-#5	5-#5	5-#5	-
E	5'-0"	5'-0"	1'-2"	6-#5	6-#5	6-#5	-

WALL FOOTING SCHEDULE

NO.	TYPE	LENGTH	WIDTH	DEPTH	BOTTOM REINFORCING	SHAPE
F1	CONT.	1'-4"	0'-8"	2-#5		
F2	CONT.	1'-8"	0'-10"	2-#5		
F3	CONT.	1'-0"	1'-8"	2-#5		
F4	CONT.	1'-4"	1'-8"	2-#5		
F5	CONT.	1'-4"	1'-0"	2-#5		
F6	CONT.	1'-4"	1'-0"	2-#5		
F6A	CONT.	0'-8"	0'-8"	1-#5		
TE	CONT.	0'-8"	0'-8"	1-#5		

ADD CURB TO GARAGE. SEE DETAIL.

FOUNDATION PLAN K
3/16" = 1'-0"

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(239) 549-4554
CMT 8889

LOT: 112
SUBDIVISION: TOSCANA ISLES EMERALD 80s
ADDRESS: 292 NARAYANA BLVD
D.R.H. #: 5787800002

Project Name
3692 K
G.C.D. 10283

DATE: 8/23/18
DRAWN BY: JSL
CHECKED BY: JWC
REVISED:
PLAN: FOUNDATION
SCALE: As indicated

S-I K

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EMAIL: PLANS@GULFCOASTDRAFTING.COM
PHONE: 239-540-8222
1515 SE 47th ST. CAPE CORAL, FL 33904

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LOT 112 3692 KRREV\10283 3692 KR.rvt

TRUSS STRAPPING TO MASONRY		
MAX TRUSS UPLIFT @ 24" OC (LBS)	CONNECTOR	FASTENER
1615	(1) HTA1G-18	10-1 Odk 1/2", EMBED 4"
1870	(1) HTA20	10-1 Odk 1/2", EMBED 4"
2430 (1 PLY)	(2) HTA1G-18	10-1 Odk 1/2", EMBED 4"
2800 (2 PLY)	(2) HTA1G-18	10-1 Odk 1/2", EMBED 4"
3170 (2 PLY)	(2) HTA20	10-1 Odk 1/2", EMBED 4"
5005	HTT45	5/8" ATR, EPOXY 12"

NOTES:

- PROVIDE A STRAP FROM THE ABOVE LIST AT EACH ROOF TRUSS BEARING POINT, BASED ON THE TRUSS UPLIFT VALUES IN THE SIGNED AND SEALED TRUSS DESIGN PACKAGE AND SUITABLE FOR THE GEOMETRY. EMBED STRAP ON -CL OF WALL.
- CONNECTORS ARE USP STRUCTURAL CONNECTORS. ALL CONNECTORS SHALL BE INSTALLED IN STRICT ACCORDANCE WITH USP PRINTED INSTRUCTIONS. SUBSTITUTIONS MUST BE APPROVED IN WRITING BY THE ENGINEER OF RECORD.
- WHERE EMBEDDED STRAPS ARE MISSING, OR MIS-LOCATED, INSTALL RETROFIT STRAP PER 2/5-4.
- 'ATR' = ALLTHREAD. DRILL AND EPOXY WITH USP EPOXY PER MFR. INSTRUCTIONS.

REV2


TRUSS STRAPPING TO STUDWALL/ WOOD BEAM		
MAX TRUSS UPLIFT @ 24" OC (LBS)	CONNECTOR	FASTENER
1005	(1) MTW1G	12-1 Odk 1-1/2"
2010	(2) MTW1G	12-1 Odk 1-1/2"
3015	(3) MTW1G	12-1 Odk 1-1/2"
1285	(1) HTW20	24-1 Odk 1-1/2"
2570	(2) HTW20	24-1 Odk 1-1/2"
3855	(3) HTW20	24-1 Odk 1-1/2"
5140	(4) HTW20	24-1 Odk 1-1/2"

NOTES:

- PROVIDE A STRAP FROM THE ABOVE LIST AT EACH ROOF TRUSS BEARING POINT, BASED ON THE TRUSS UPLIFT VALUES IN THE SIGNED AND SEALED TRUSS DESIGN PACKAGE.
- CONNECTORS ARE USP STRUCTURAL CONNECTORS. ALL CONNECTORS SHALL BE INSTALLED IN STRICT ACCORDANCE WITH USP PRINTED INSTRUCTIONS.

REV2


TRUSS BEARING CONDITIONS AND STRAPPING IS BASED ON TRUSS LAYOUT PREPARED BY SCOSTA, JOB# 45150K, DATED: 07/12/13
REVISED: 06/18/18

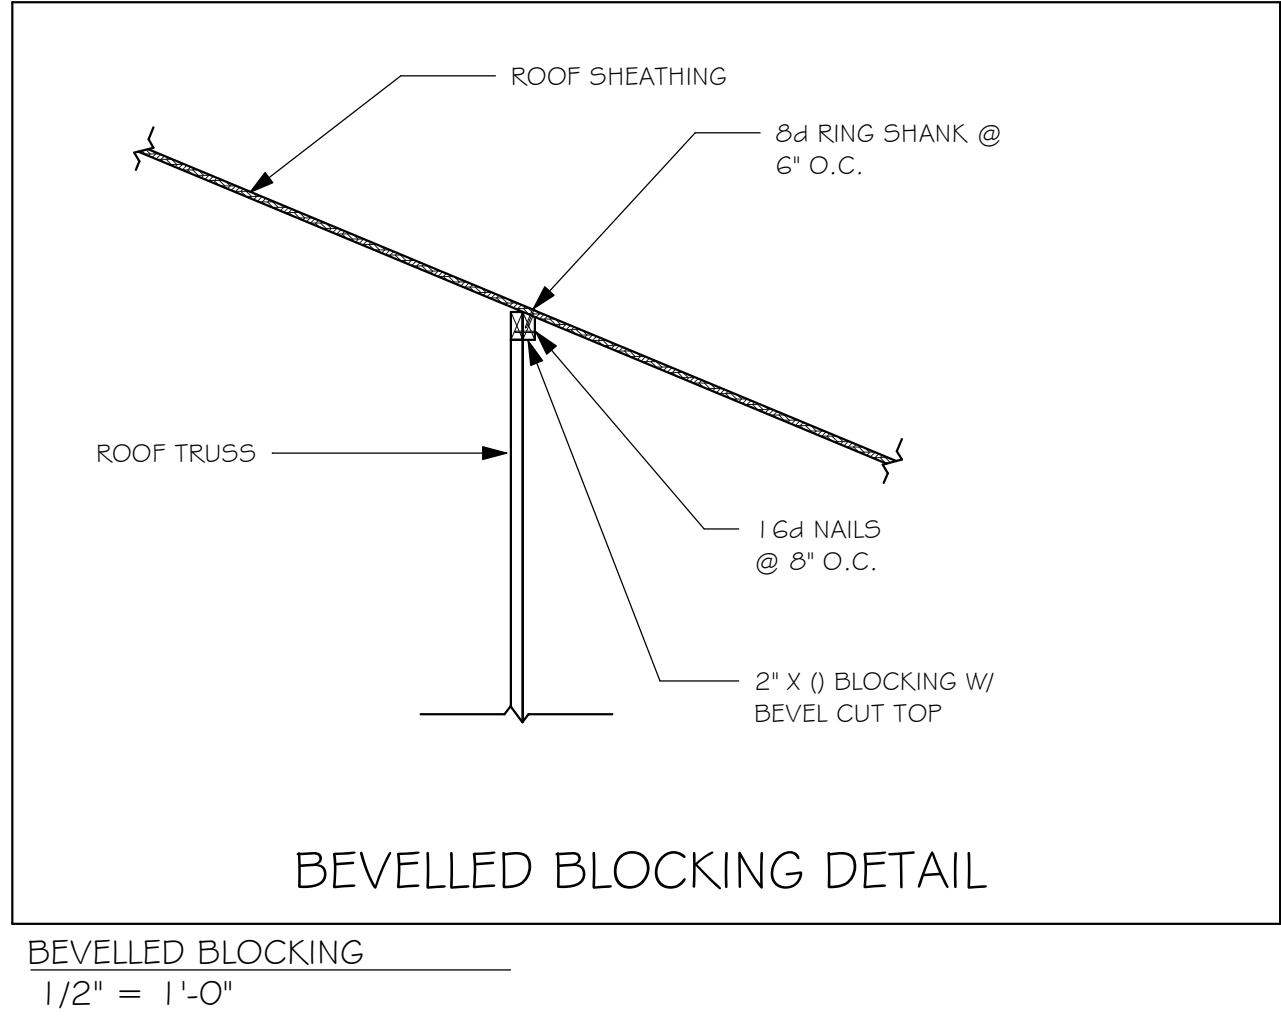

PRECAST LINTEL SCHEDULE	
WALL ABOVE WITH BOND BEAM AT TOP	8" PRECAST LINTEL
#5 VERTICAL, ABOVE LINTEL ONLY WHERE NOTED ON PLAN	8" PRECAST LINTEL
'1B' DENOTES 1#5 BOTTOM WITH 7" HOOK EACH END OR EXTEND 24" BEYOND OPENING.	8" PRECAST LINTEL
'0B' DENOTES 'NO REBAR'	8" PRECAST LINTEL
AT SWING DOORS, USE 2" RECESS STYLE LINTEL IF NEEDED FOR ROUGH OPENING.	8" PRECAST LINTEL

PLAN NOTES:

- ROOF AND FLOOR TRUSS BEARING ELEVATION VARIES, SEE LEGEND.
- ROOF AND FLOOR FRAMING SHALL BE WOOD TRUSSES DESIGNED BY A DELEGATED TRUSS ENGINEER PER DESIGN CRITERIA ON SHEET S-3.
- PROVIDE STRAPPING AT TRUSSES PER NOTES ON THIS SHEET.
- FOR NAILING OF ROOF AND FLOOR DECK, SEE 1 AND 2 ON S-3.
- [8F8-18] etc., DENOTES PRECAST LINTEL ABOVE DOOR/WINDOW OPENING PER SCHEDULE THIS SHEET.
- AT TRUSS BEARING, PROVIDE 8x8 MASONRY BOND BEAM W/ 1#5 CONTINUOUS, SEE DETAIL 11/5-3.

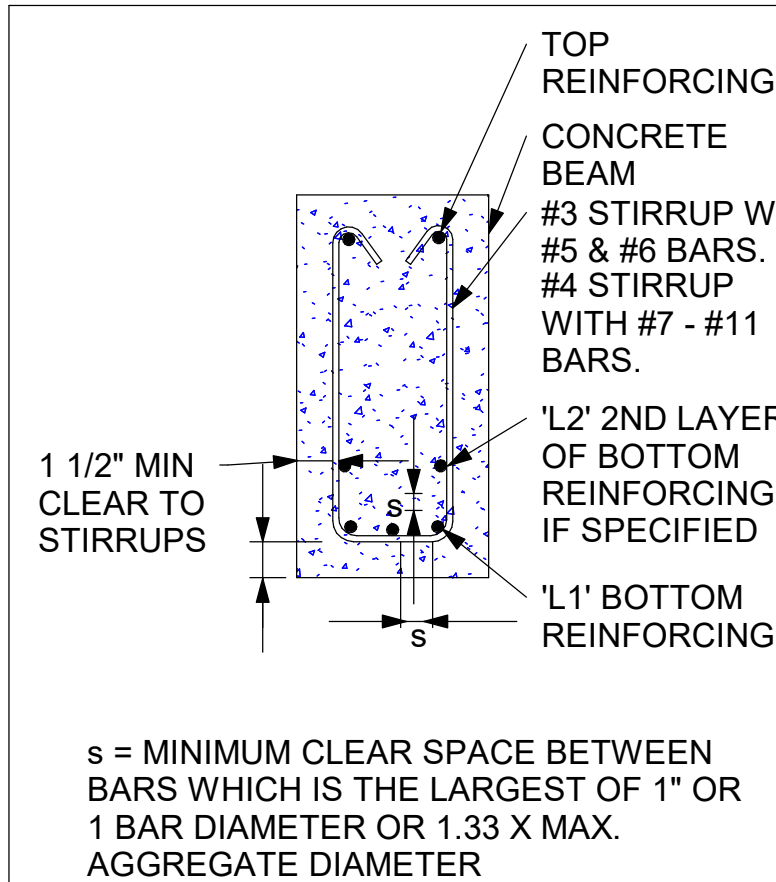

ROOF FRAMING PLAN

3/16" = 1'-0"

CAST-IN-PLACE CONCRETE BEAM SCHEDULE							
I.D	W x D	TOP BARS	BOT 'L1'	BOT 'L2'	TIES	TYPE	NONE
1B1	8" X16"	2- #5	2- #5		NONE		
1B2	8" X16"	2- #5	2- #5		#3 @ 7"	1,2,3	
1B3	8" X16"	2- #5	3- #5		#3 @ 7"	1,2,3	
1B4	8" X16"	2- #5	3- #5	2- #5	#3 @ 6"	1,2,3	

NOTES:


- THE DISTANCE FROM THE FACE OF SUPPORT TO THE FIRST TIE OR STIRRUP SHALL BE 1/2 THE TIE SPACING, OR 6" MAX. (ie. FOR TIE SPACING = 6", LOCATE FIRST TIE 3" FROM FACE OF COLUMN).
- BOTTOM BARS ARE IN 2 LAYERS AND SHALL HAVE 1" CLEAR SPACE BETWEEN LAYERS AS SHOWN IN DETAIL.

TIE & STIRRUP TYPES

1 2 3

BEARING HEIGHT	
[Pattern]	= BEARING @ 10'-0"
[Pattern]	= BEARING @ 12'-0"
[Pattern]	= INTERIOR BEARING @ 12'-0"
[Pattern]	= INTERIOR BEARING @ 12'-1 1/2"
[Pattern]	= INTERIOR BEARING @ 12'-6"
[Pattern]	= BEARING @ 16'-0"

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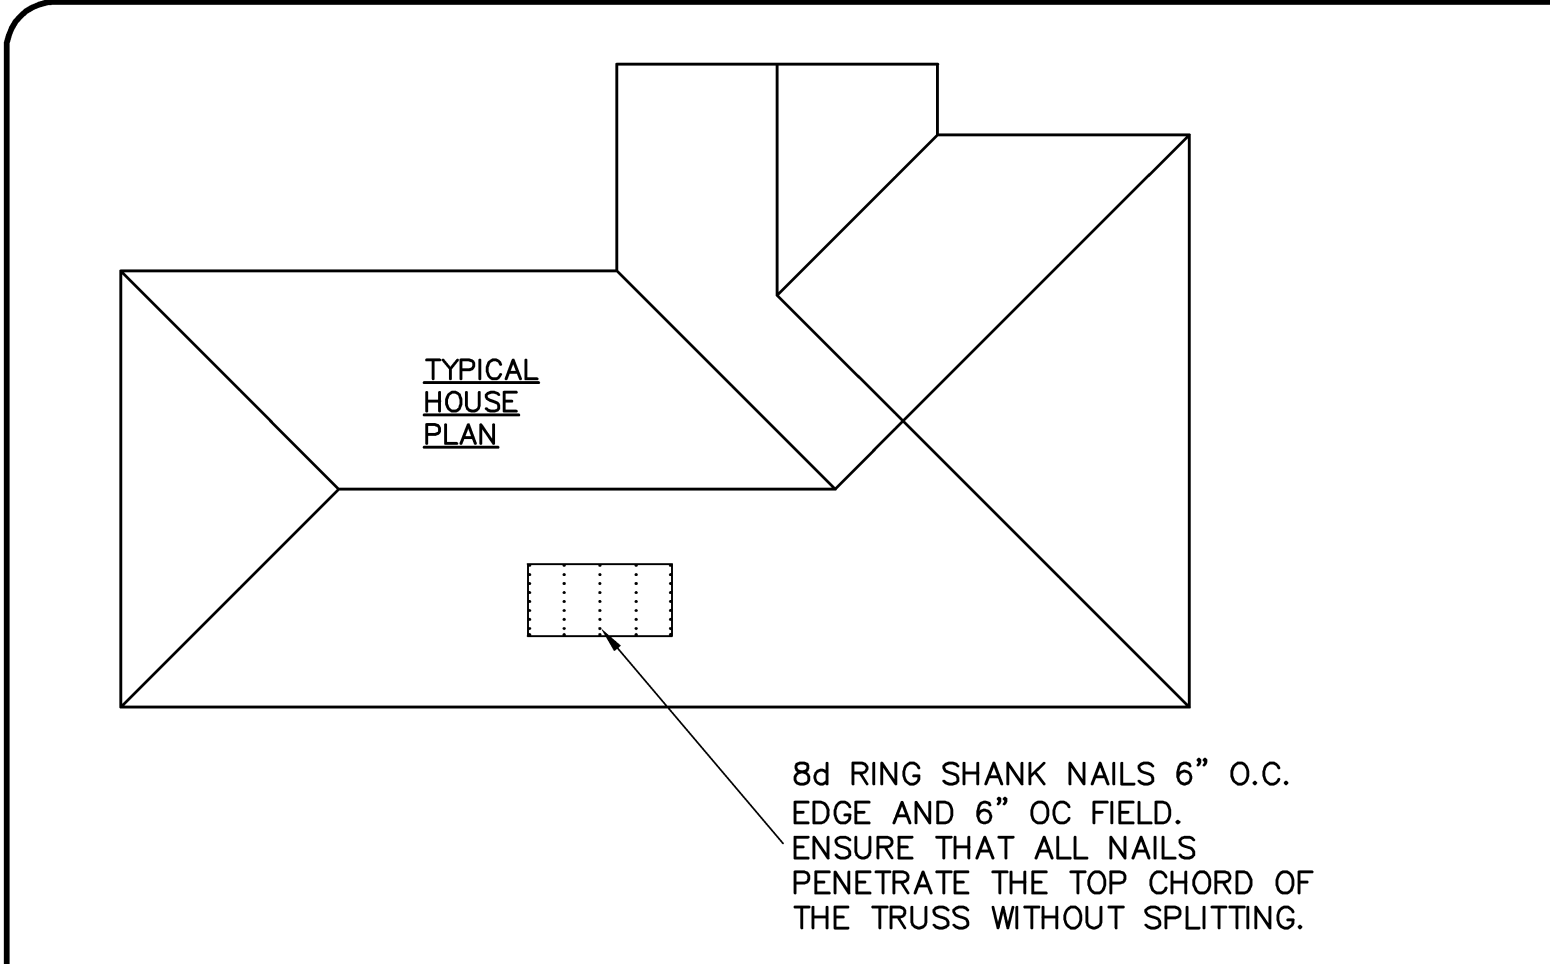

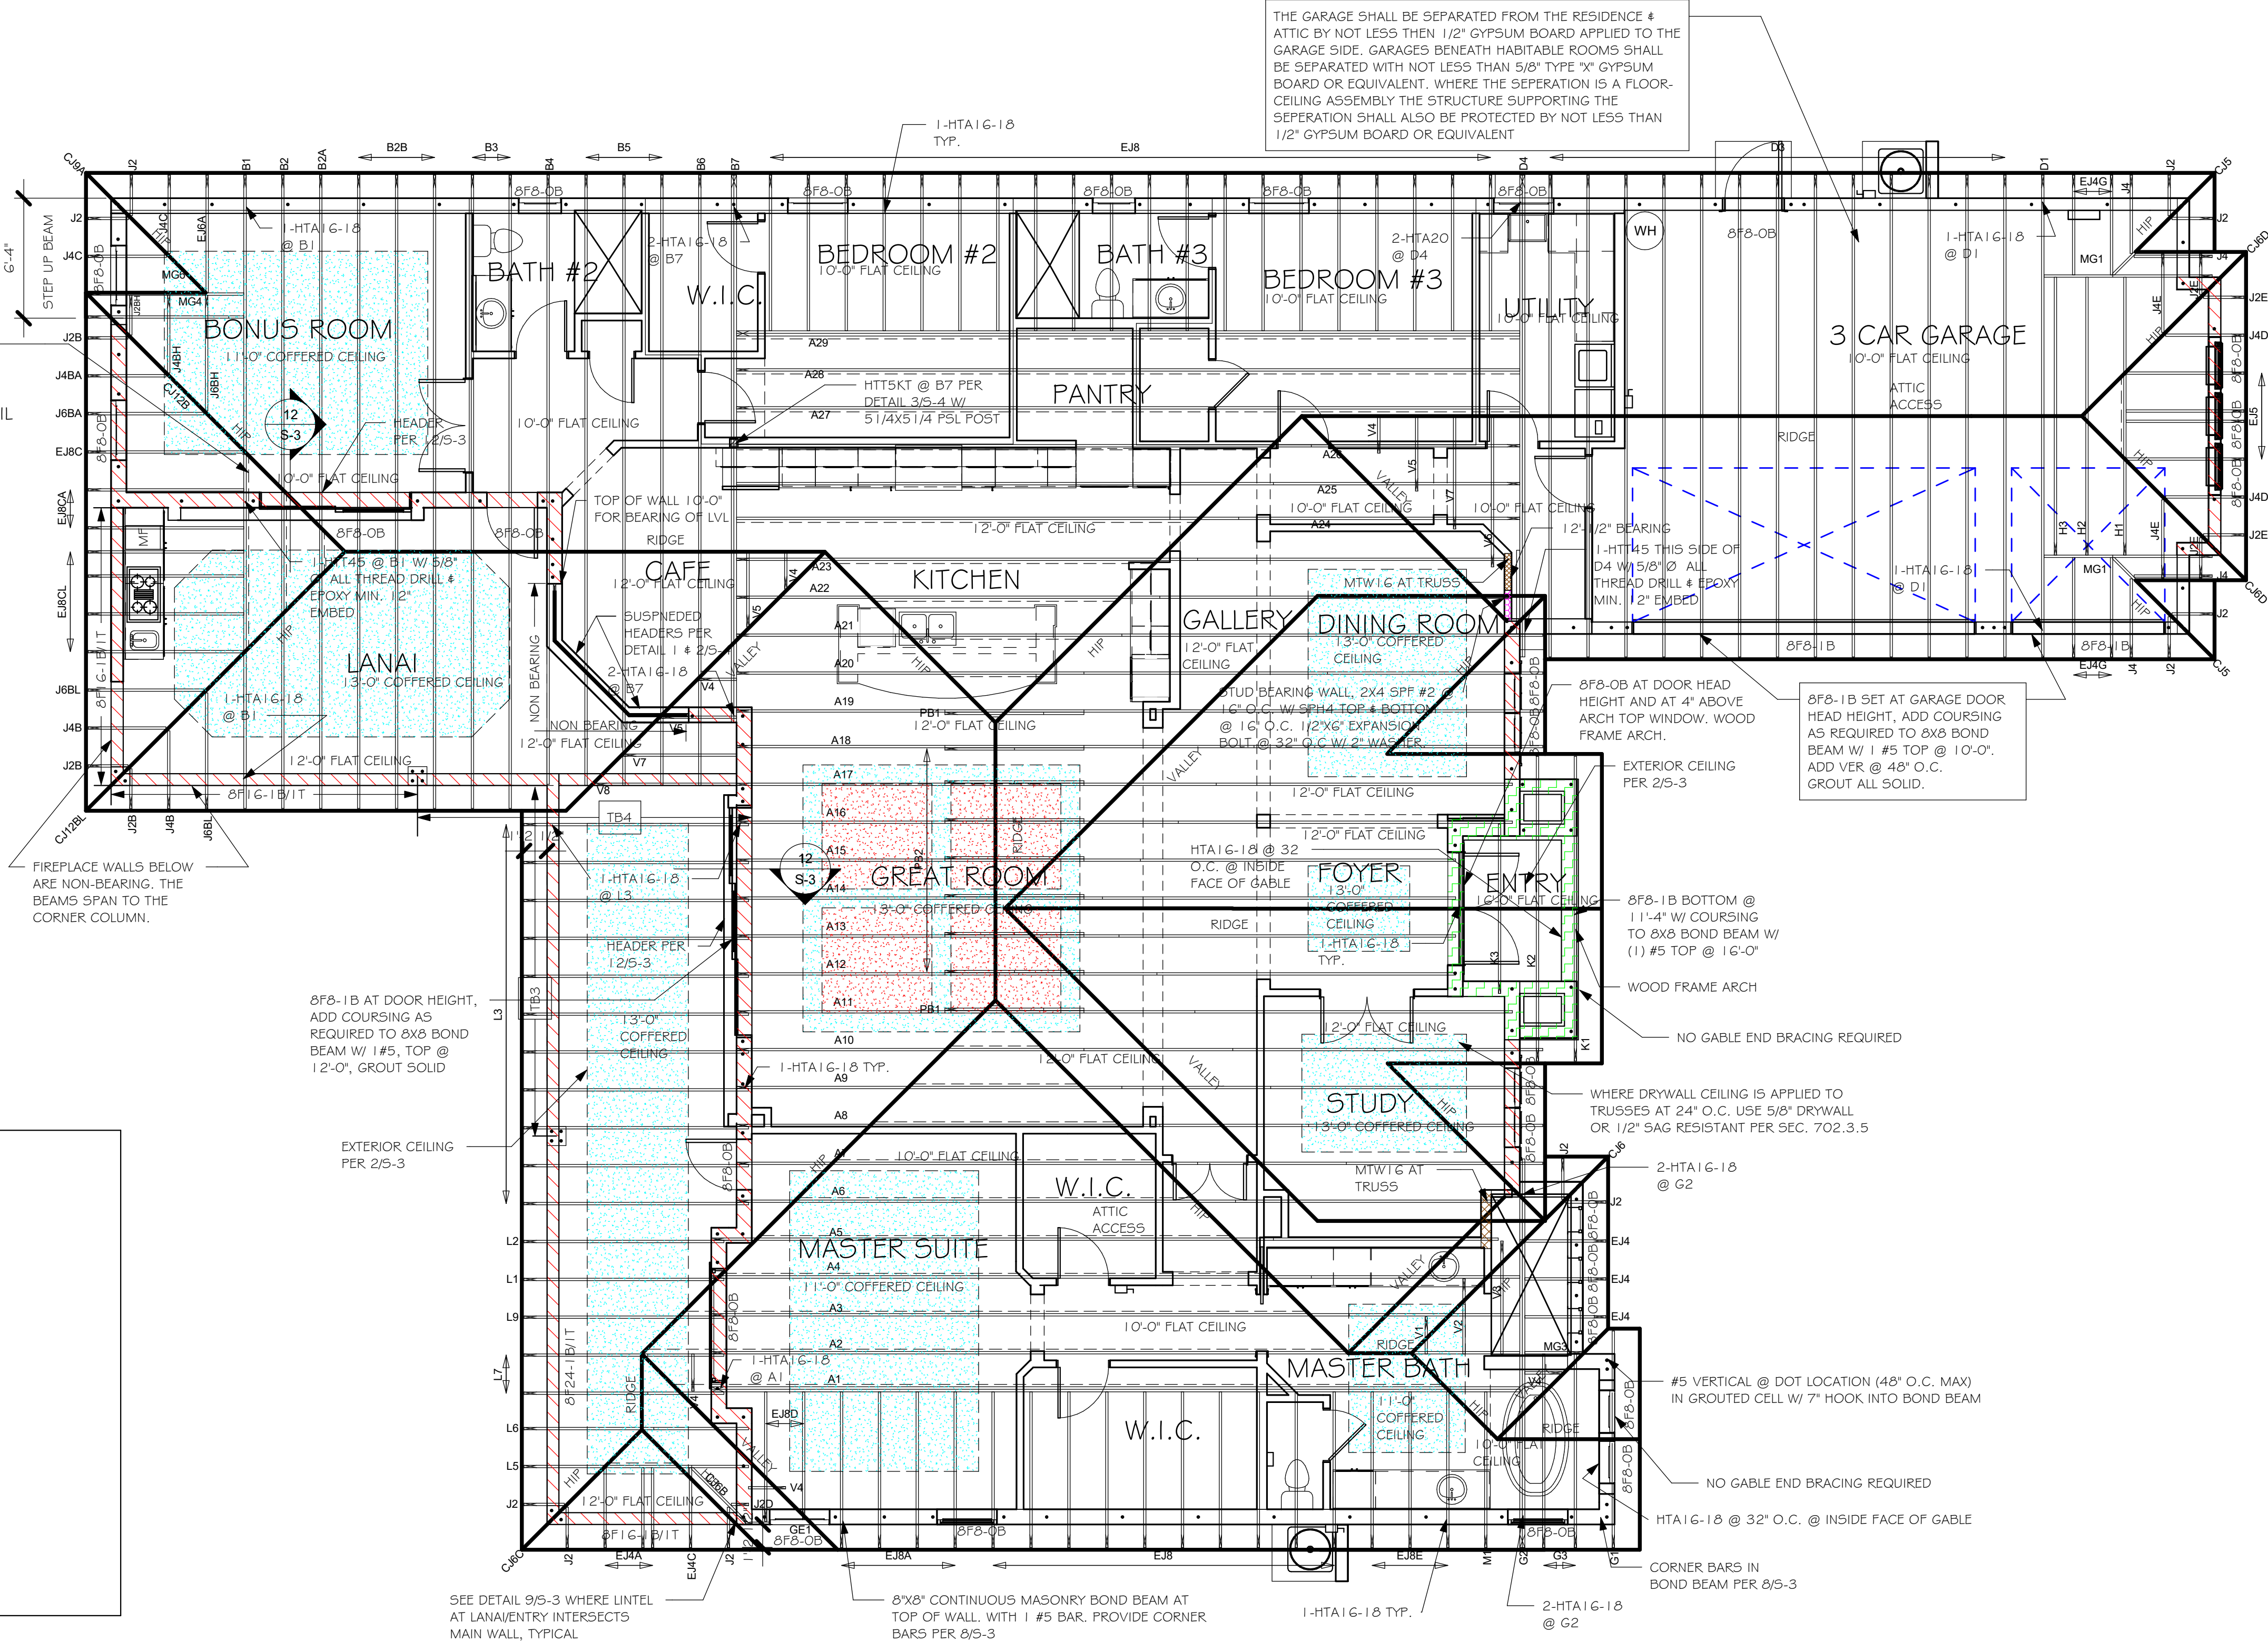
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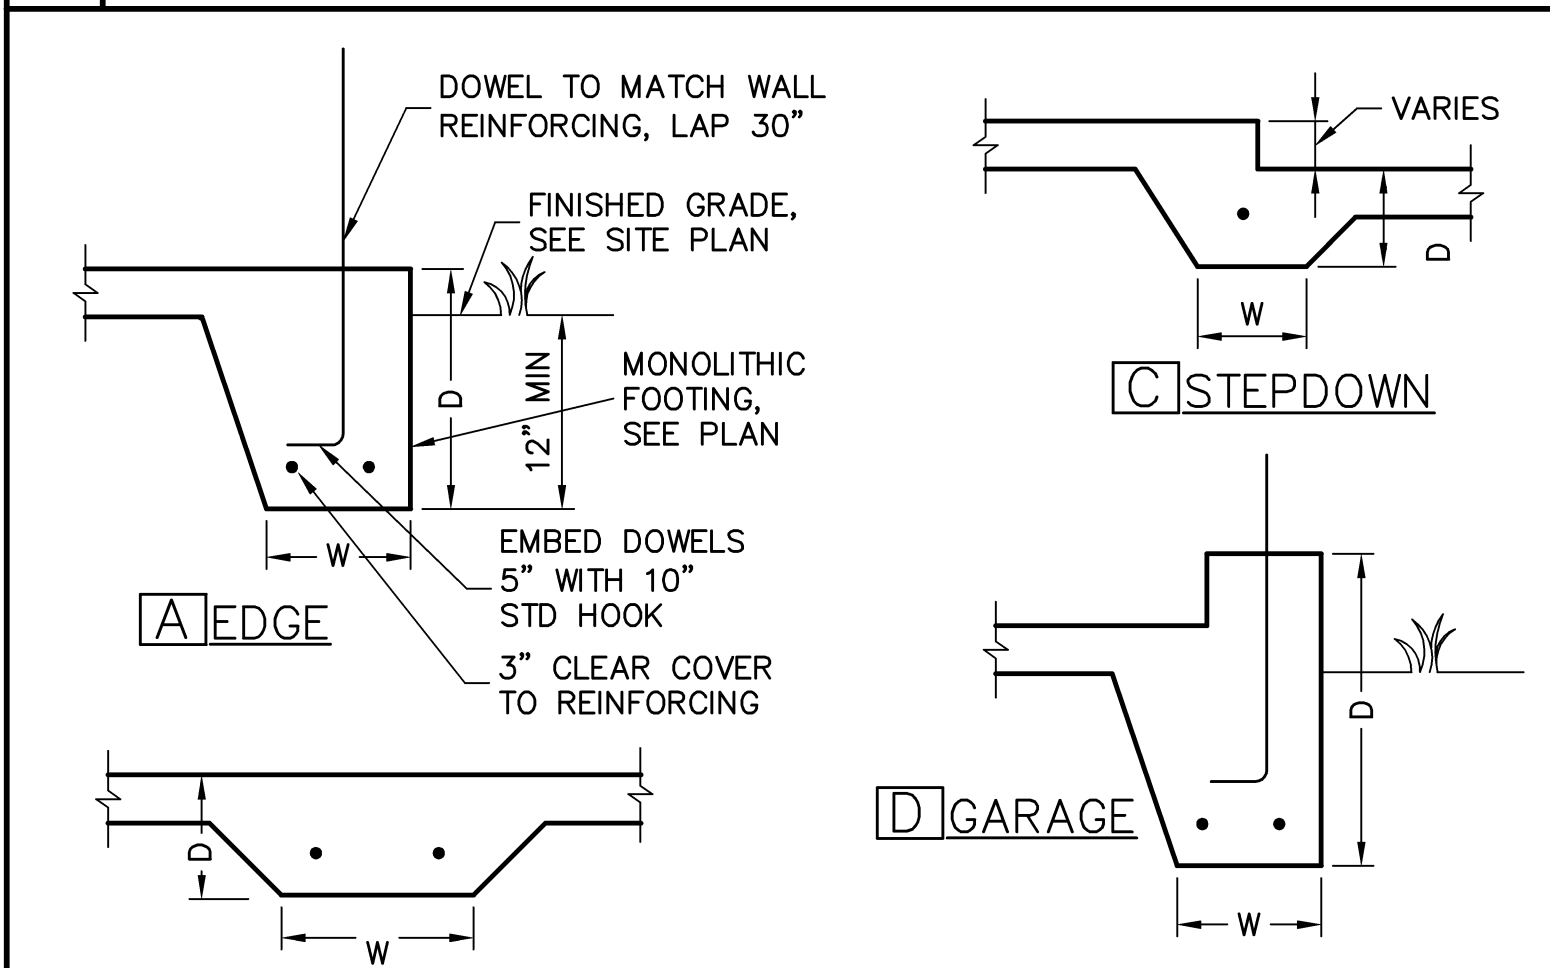
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PHONE: 239-540-8222
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STRUCTURAL DESIGNING
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OF NORTH FLORIDA
2000 S. GULF BLVD., SUITE 100
CAPE CORAL, FL 33904
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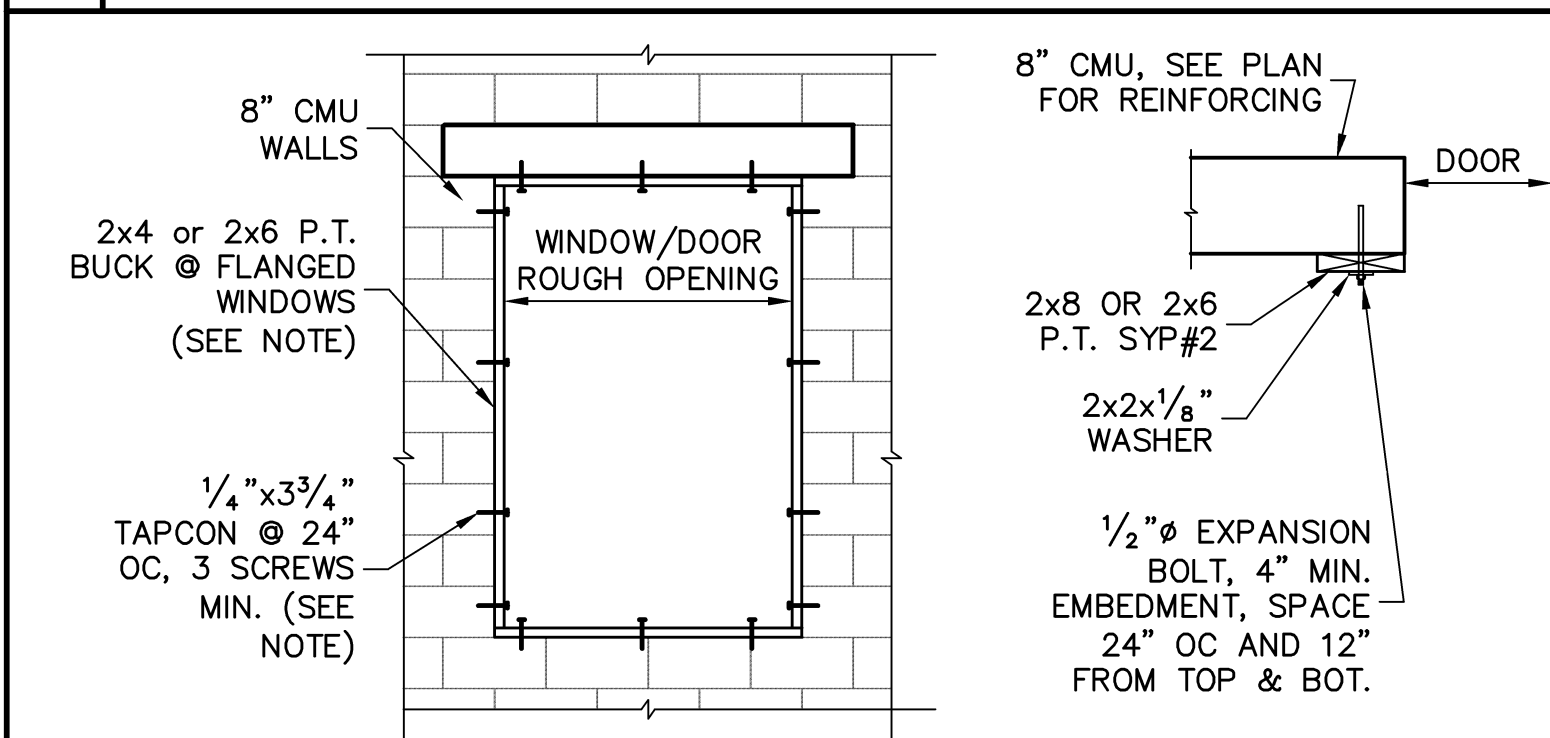
Project Name 3692 K	LOT: 112
	SUBDIVISION: TOSCANA ISLES EMERALD 80's
	ADDRES: 292 NARAYANA BLVD
	D.R.H. #: 5787800002
G.C.D.: 10283	
DATE: 8/23/18	
DRAWN BY: JSL	
CHECKED BY: JWC	
REVISED:	
PLAN: ROOF FRAMING PLAN	
SCALE: As indicated	
S-2	



1 **ROOF DECK NAILING PATTERN**
SCALE: NTS



4 **MONOLITHIC FOOTINGS**
SCALE: 3/4" = 1'-0"



7 **BUCK FASTENING**
GARAGE DOOR
NOTE: THIS BUCK FASTENING DETAIL IS INTENDED FOR FLANGED WINDOW/DOOR PRODUCTS THAT FASTEN THRU THE FLANGE WITH WOOD SCREWS TO THE BUCK. FOR WINDOW/DOOR PRODUCTS THAT DO NOT HAVE A FLANGE AND FASTEN INSTEAD OUTWARD THRU THE FRAME, USE MASONRY SCREWS PER MFR. THAT ARE LONG ENOUGH TO PENETRATE 2-1/4" INTO THE MASONRY. IN THIS CASE, THE BUCK MATERIAL IS SIMPLY A SPACER AND MAY BE 1x4 OR 1x6 OR OMITTED ENTIRELY AND THE SPACER MAY BE TACKED IN PLACE WITH MASONRY NAILS OR PINS.


RETROFIT STRAPS TO CONCRETE/MASONRY		
TRUSS UPLIFT (LBS) @ 24" OC	CONNECTOR	
TO 1145	1-HTWM16 or 20	8-10dx1 1/2" 4-1/4"x2 1/4" CONCRETE SCREW
TO 1145	1-HTWM16 or 20	8-10dx1 1/2" 4-1/4"x2 1/4" CONCRETE SCREW
TO 2290	2-HTWM16 or 20	8-10dx1 1/2" 4-1/4"x2 1/4" CONCRETE SCREW
TO 4520	2-LUGT2	16-16d, 7-1/4"x2 1/4" CONCRETE SCREW
TO 3610	HTT16	18-10d, 3/8" Ø ALLTHREAD, DRILL & EPOXY 10" EMBED w/ USP SET.
TO 9790	HGT-2/3	Two 3/4" Ø ALLTHREAD, DRILL & EPOXY 12" EMBED WITH USP SET.

NOTES:
1) WHERE EMBEDDED STRAP IS MISSING OR MIS-LOCATED, PROVIDE A STRAP FROM THE ABOVE LIST AT EACH ROOF TRUSS BEARING POINT, BASED ON THE TRUSS UPLIFT VALUES IN THE SIGNED AND SEALED TRUSS DESIGN PACKAGE.
2) CONNECTORS ARE USP. ALL CONNECTORS SHALL BE INSTALLED IN STRICT ACCORDANCE WITH USP PRINTED INSTRUCTIONS.
3) CONCRETE SCREW SHALL BE WEDGE-BOLT+, TITEN, TAPCON OR EQUIVALENT.



10 **RETROFIT UPLIFT CONNECTOR SCHEDULE**

SHEATHING SCHEDULE	
EXTERIOR STUD WALL	FLOOR
7/16" ZIP SYSTEM WALL SHEATHING BY HUBER ENGINEERED WOODS LLC, NAILED w/ 8d COMMON WIRE @ 6" O.C. EDGE AND 6" O.C. FIELD. PROVIDE 2x4 BLOCKING AT ALL JOINTS. INSTALL SHEATHING AND SEAM TAPE IN STRICT ACCORDANCE WITH MFR. WRITTEN INSTRUCTIONS.	N/A
ROOF	EXTERIOR CEILING AND SOFFIT
A.P.A. RATED SHEATHING, EXPOSURE 1, SPAN RATING 24/16 OR BETTER. FASTEN WITH 8d RING SHANK NAILS @ 6" O.C. EDGE AND 6" O.C. FIELD. (WHEN 1/2" ZIP BRAND ROOF SHEATHING IS USED, H-CLIPS ARE NOT REQUIRED) (RING SHANK NAILS PER R803.2.3.1: 0.113" NOMINAL SHANK DIAMETER, RING DIA. OF 0.012" OVER SHANK DIAMETER, 16 TO 20 RINGS PER INCH, 0.280" DIAMETER FULL ROUND HEAD, 2" NAIL LENGTH)	OPTIONS: 1) 1x4 STRIPPING @ 16" OC w/ 2-8d NAILS TO EACH TRUSS, 3/8" EXTERIOR GYPBOARD CEILING, FASTEN w/8d NAILS OR 1 5/8" DRYWOOD SCREWS @ 6" OC EDGE & FIELD. 2) 3/8" BC PLYWOOD NAILED w/ 6d COMMON @ 6" OC EDGE & FIELD. 3) VINYL OR ALUMINUM PERFORATED SOFFIT INSTALLED PER MANUFACTURER INSTRUCTIONS TO MEET WIND PRESSURES PER R703.1.2.1.


2 **SHEATHING SCHEDULE**
NOTE: EXTERIOR CEILINGS AND SOFFITS 1) AND 2) SPECIFIED HERE MEET THE DESIGN WIND PRESSURES PER R703.1.2.1.

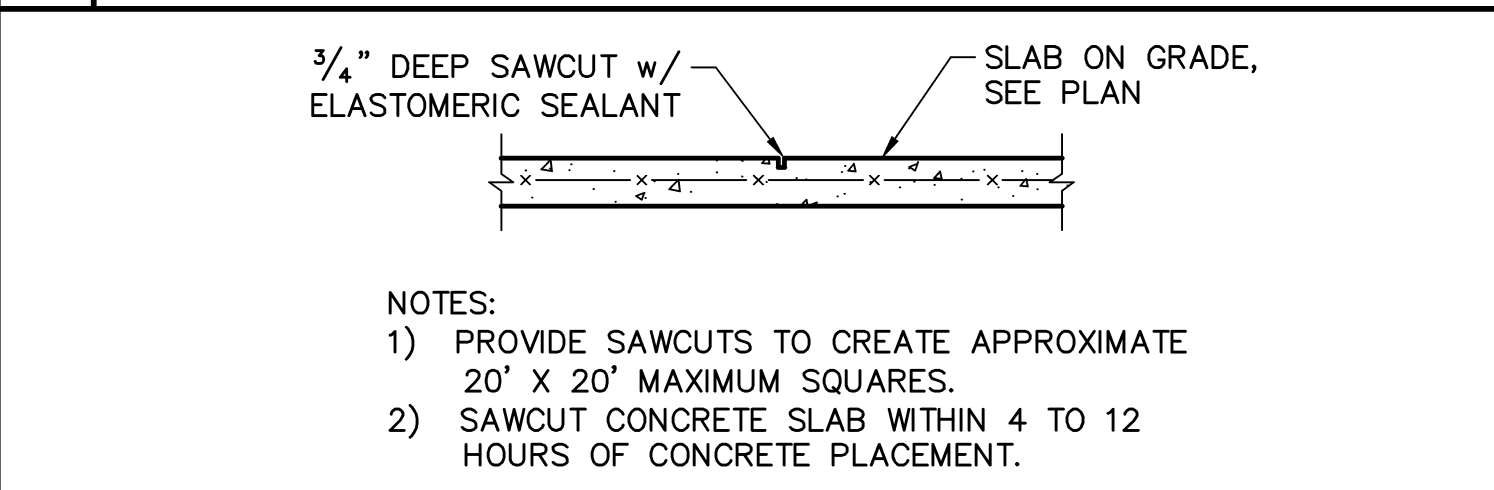




5 **SLAB SAWCUT DETAIL**
SCALE: NTS

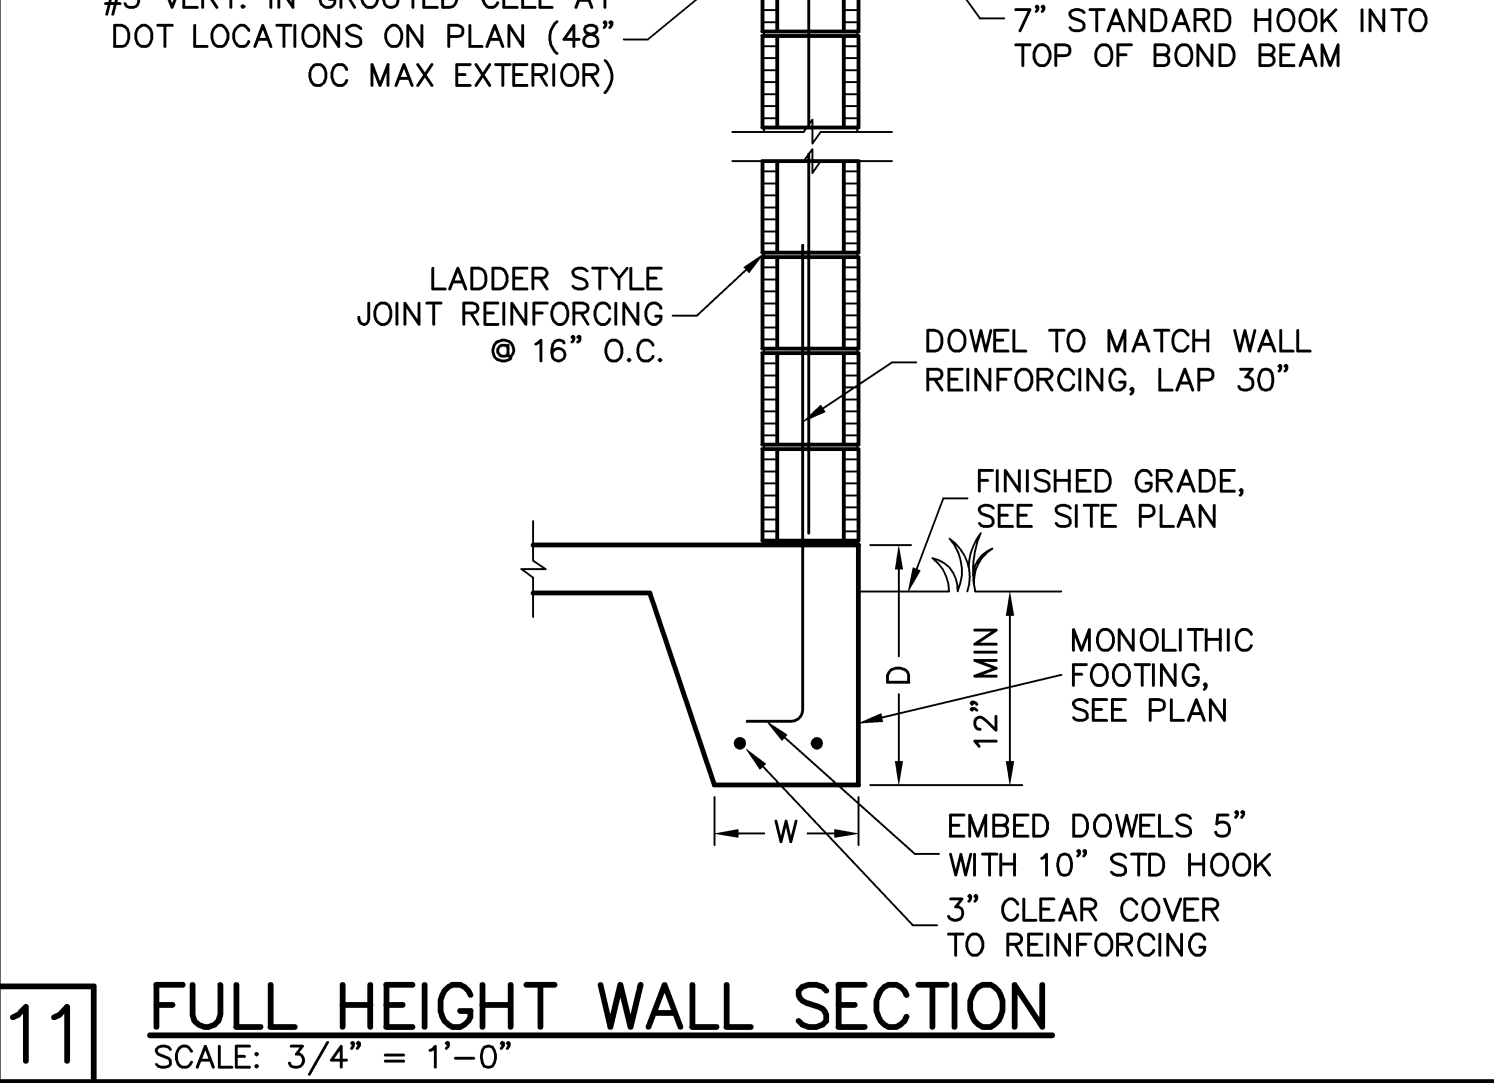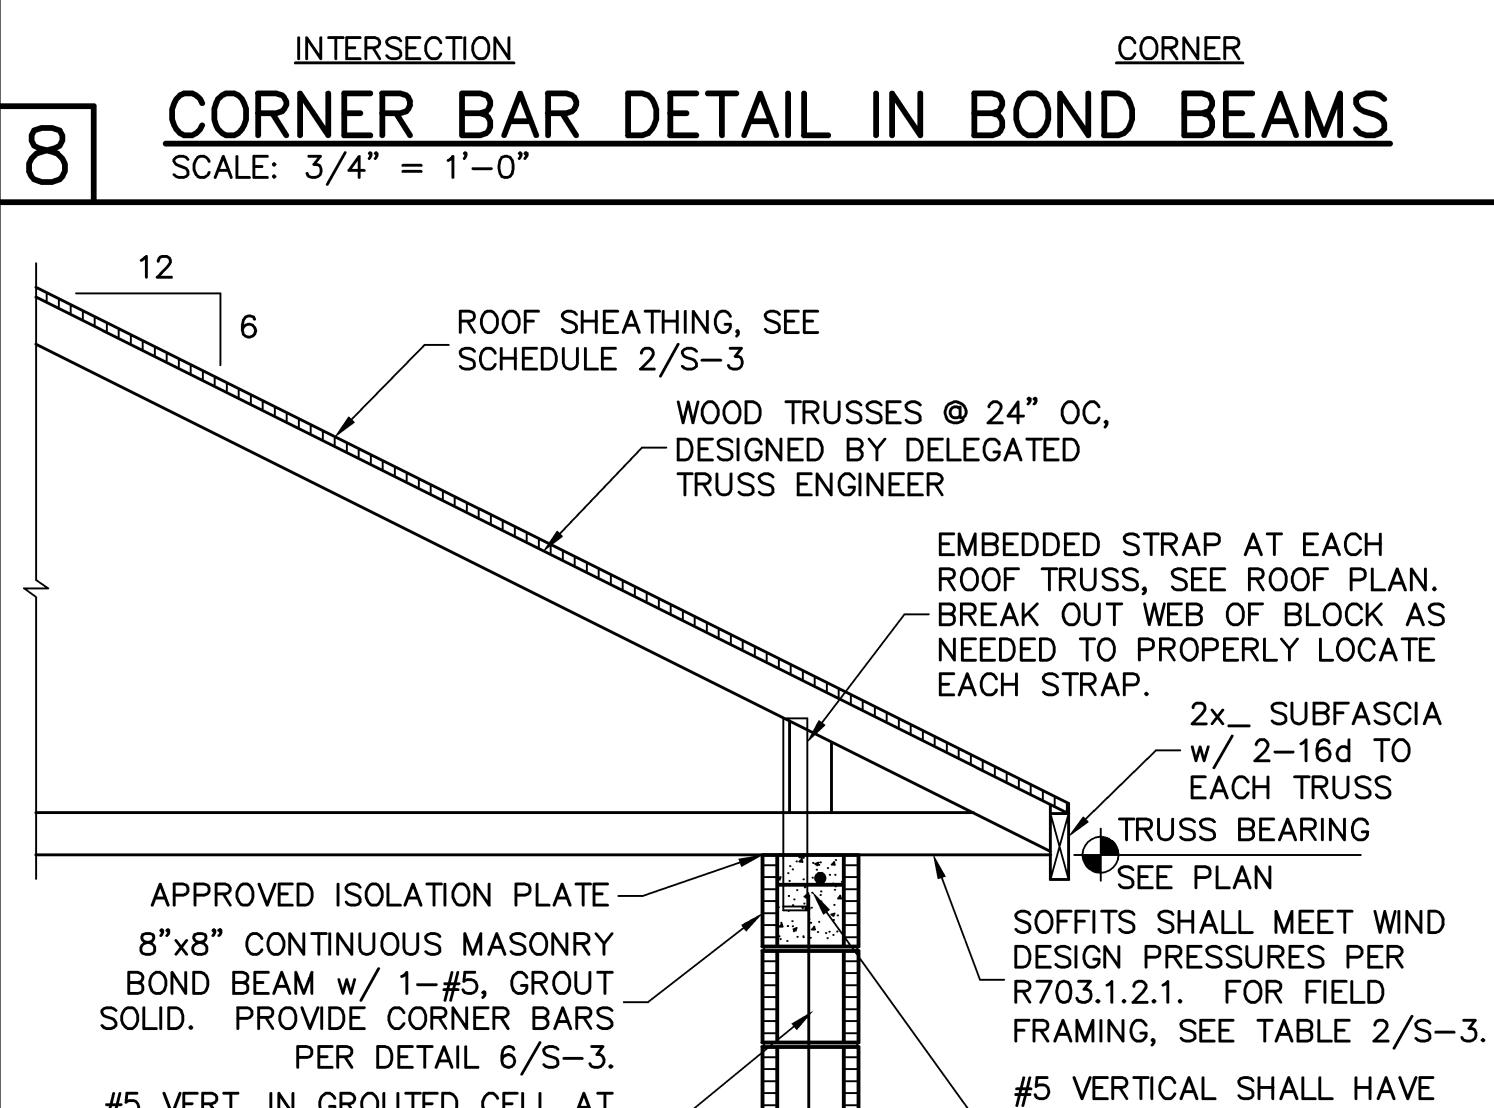

11 **FULL HEIGHT WALL SECTION**
SCALE: 3/4" = 1'-0"

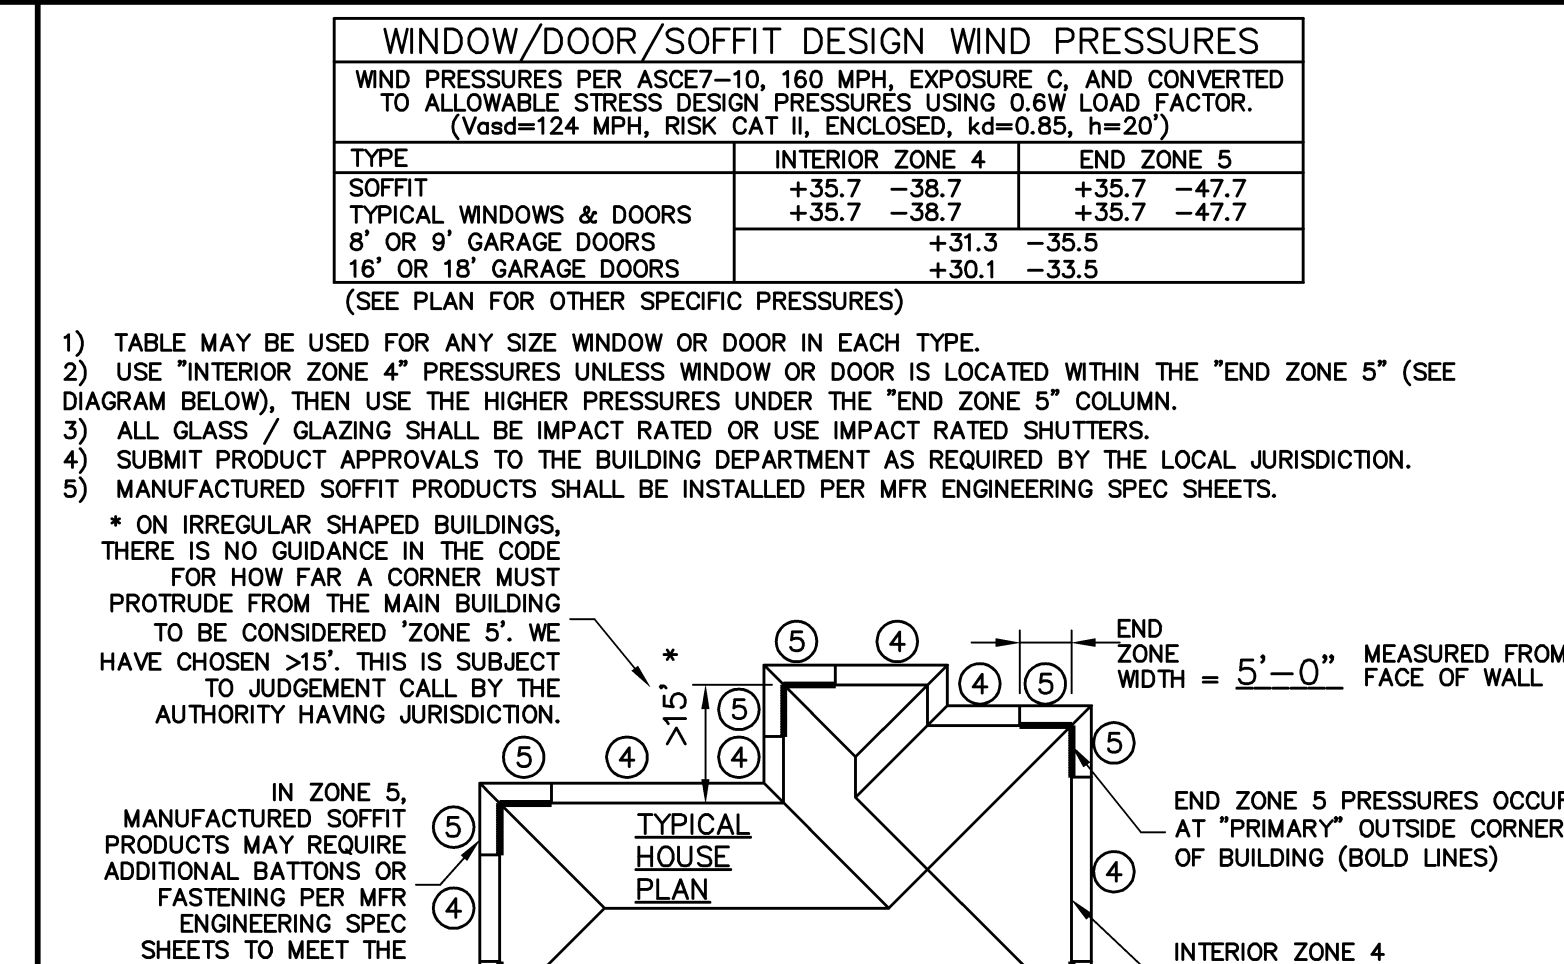

3 **WINDOW/DOOR/SOFFIT DESIGN WIND PRESSURES**

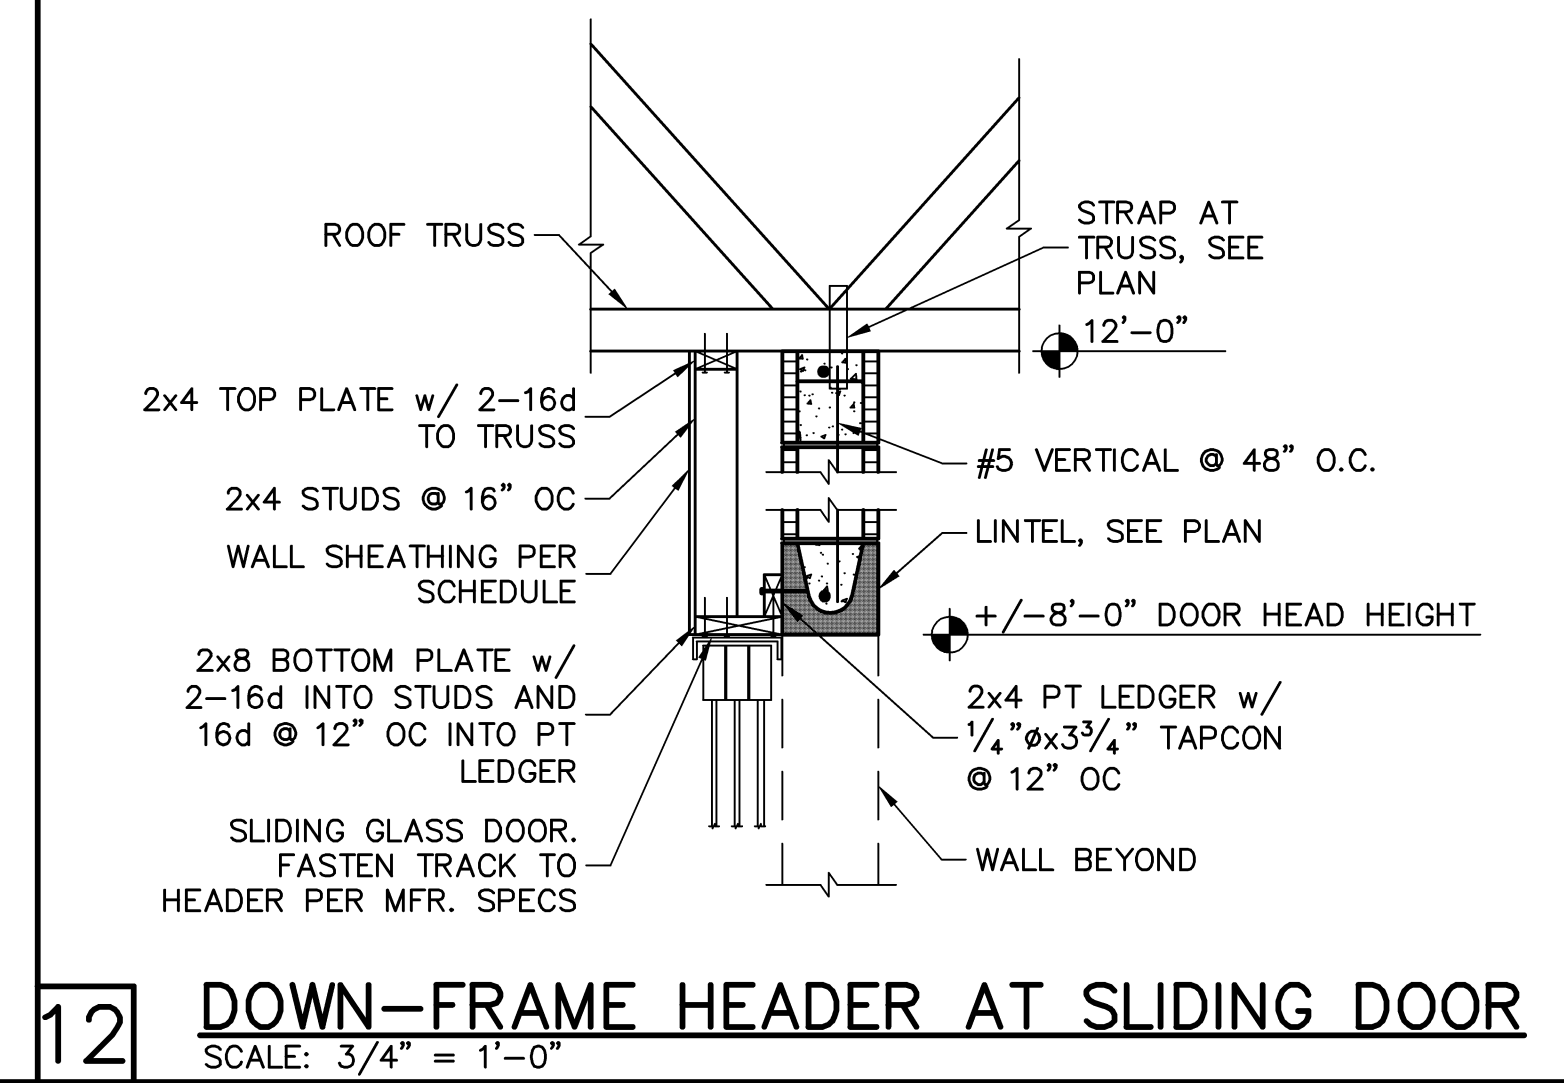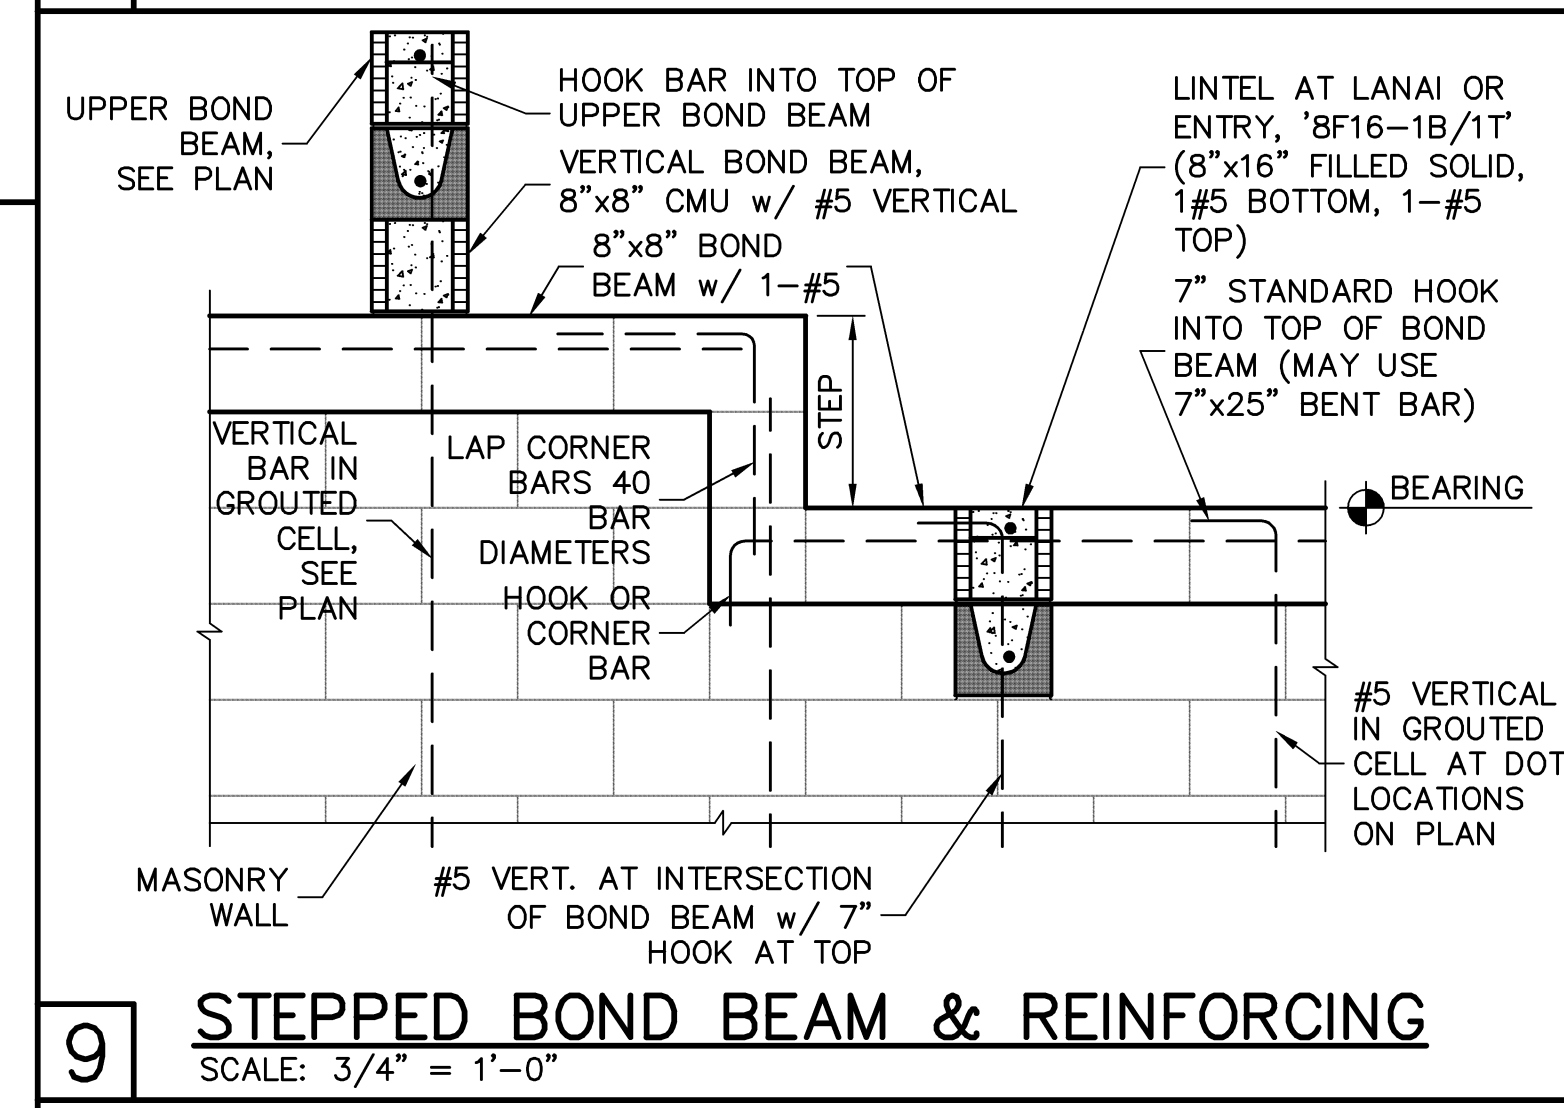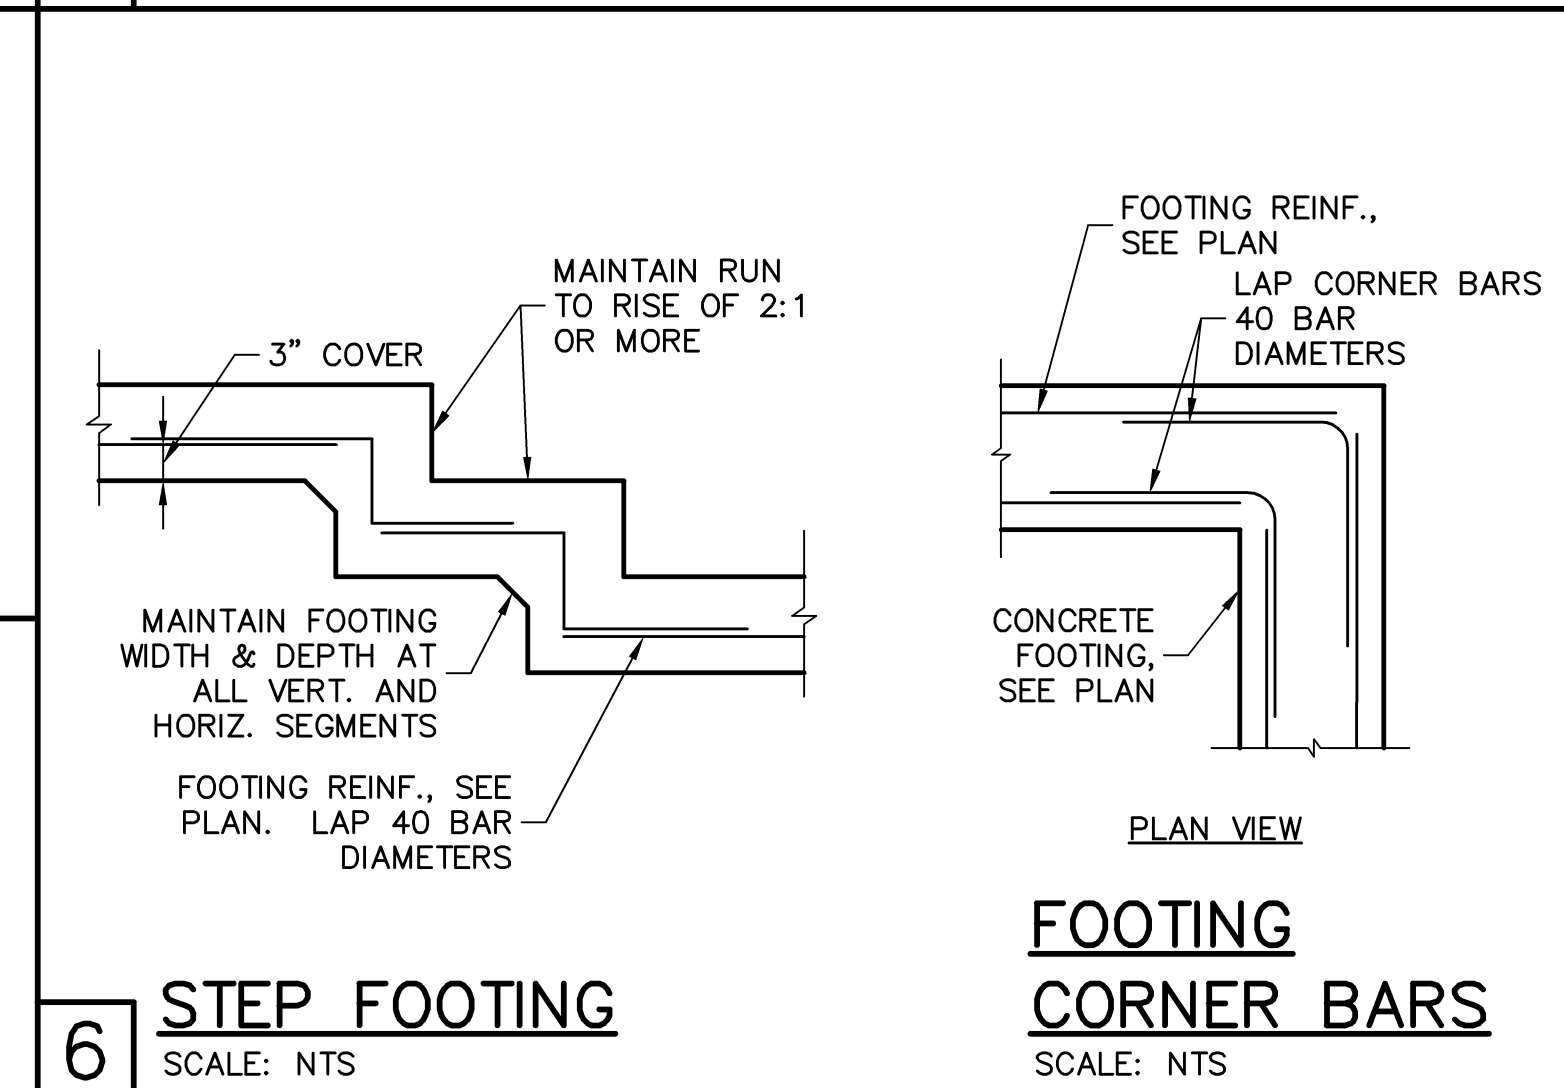

12 **DOWN-FRAME HEADER AT SLIDING DOOR**
SCALE: 3/4" = 1'-0"

DESIGN CRITERIA:
DESIGN IN ACCORDANCE WITH REQUIREMENTS OF THE FLORIDA BUILDING CODE 6th EDITION (2017) RESIDENTIAL

1. FLOOR & ROOF UNIFORM LOADS:
ELEVATED FLOORS: LIVE LOAD 40 PSF, DEAD LOAD 20 PSF
ROOF: LIVE TOP CHORD 20 PSF
LIVE BOTTOM CHORD 10 PSF (NON-CONCURRENT w/ TOLL)
CEMENT ROOF TILE DEAD LOAD 25 PSF TOTAL
SHINGLE/METAL ROOFING DEAD LOAD 15 PSF TOTAL
MINIMUM DEAD LOAD FOR WIND: TC 5 PSF, BC 5 PSF

DEFLECTION CRITERIA:
FLOOR L/480 LIVE, L/360 TOTAL
ROOF L/240 LIVE, L/180 TOTAL

2. WIND LOADS:
WIND DESIGN PER ASCE7-10
BASIC WIND SPEED (ASCE7-10) 160 MPH
NOMINAL WIND SPEED (V_{sd}) TABLE R301.2.1.3) 124 MPH
BUILDING CATEGORY II
IMPORTANCE FACTOR I=1.00
EXPOSURE C
MEAN ROOF HEIGHT = 20 FT
ROOF PITCH 6/12
ENCLOSURE CLASS ENCLOSURED
INTERNAL PRES. COEFF. +/- 0.18
WINDOW/DOOR DESIGN WIND PRESSURE, SEE TABLE IN DETAIL 3.
SOFFITS - PER R703.1.2.1, ALL SOFFITS SHALL BE CAPABLE OF RESISTING THE DESIGN PRESSURES SPECIFIED IN TABLE R301.2(2) FOR WALLS.

3. REINFORCED CONCRETE:
DESIGN AS PER ACI 318-14
REQUIRED COMPRESSIVE STRENGTH AT 28 DAYS:
SLAB ON GRADE f_c = 2500 PSI
3 1/2" MINIMUM THICKNESS REINFORCED WITH 6x6 w/1.4xw1.4 WWF OR FIBERESH.
CONVENTIONAL SHALLOW FOOTINGS f_c = 2500 PSI
BEAMS AND COLUMNS f_c = 3000 PSI
ALL OTHER CONCRETE (U.N.O.) f_c = 3000 PSI
UNLESS OTHERWISE SHOWN ON DRAWINGS, MINIMUM CONCRETE COVER FOR REINFORCING SHALL BE AS FOLLOWS:
FOOTINGS 3"
SLAB ON GRADE CENTERED
BEAMS 1 1/2"
COLUMNS 1 1/2"
ALL REINFORCING STEEL SHALL BE PLACED IN ACCORDANCE WITH THE TYPICAL BENDING DIAGRAMS AND PLACING DETAILS OF ACI STANDARDS AND SPECIFICATIONS. ALL REINFORCING STEEL SHALL BE HELD SECURELY IN POSITION WITH STANDARD ACCESSORIES DURING PLACING OF CONCRETE.
REINFORCING STEEL - ASTM A615 GRADE 40 FOR #3
GRADE 60 FOR #4 TO #11

WELDED WIRE FABRIC - ASTM A185

SPICES IN REINFORCING, SHALL BE 40 BAR DIAMETERS. NON-CONTACT LAP SPICES MAY BE USED PROVIDED REINFORCING IS NOT SPACED MORE THAN 5" APART FOR #5 BARS.

FORMWORK AND SHORING SHALL REMAIN IN PLACE UNTIL CONCRETE HAS REACHED AT LEAST 2/3 OF THE REQUIRED 28 DAY STRENGTH.

4. REINFORCED MASONRY:
DESIGN PER ACI 530-13
REQUIRED COMPRESSIVE STRENGTHS:
MASONRY WALLS f_m = 1500 PSI

REINFORCING STEEL - ASTM A615 GRADE 60.
SPICES IN REINFORCING, SHALL BE 48 BAR DIAMETERS.
ALL CONCRETE MASONRY UNITS SHALL BE COMPOSED OF ASTM C90, GRADE N-1 HOLLOW CONCRETE MASONRY UNITS WITH TYPE "S" MORTAR. GROUT ALL CELLS CONTAINING VERTICAL REINFORCEMENT WITH 3000 PSI PEA ROCK CONCRETE GROUT. ALL CELLS BELOW FINISHED GRADE SHALL BE GROUTED SOLID. ALL EXTERIOR WALLS SHALL BE REINFORCED FULL HEIGHT AT DOT LOCATIONS ON PLANE D H PROVIDE HORIZONTAL JOINT REINFORCEMENT IN WALLS AT 16" OC VERTICALLY, UNLESS NOTED OTHERWISE. IN ADDITION, INSTALL JOINT REINFORCING IN THE FIRST TWO MORTAR JOINTS ABOVE AND BELOW OPENINGS, EXTENDING AT LEAST 24" BEYOND THE OPENING. LAP JOINT REINFORCING 6" MINIMUM.

5. DELEGATED-ENGINEERED WOOD ROOF & FLOOR TRUSSES:
ALL WOOD ROOF AND FLOOR TRUSSES SHALL BE DESIGNED BY A DELEGATED TRUSS ENGINEER PER RULE 61G15-31.003 OF THE FLORIDA ADMINISTRATIVE CODE. ALL TRUSSES SHALL HAVE TEMPORARY BRACING PER "COMMENTARY AND RECOMMENDATIONS FOR HANDLING, INSTALLING AND BRACING METAL PLATE CONNECTED WOOD TRUSSES, HIB-91." FOR OTHER BRACING REQUIREMENTS, NOTIFY ENGINEER. PROVIDE PERMANENT BRACING PER TRUSS MFR. SHOP DRAWINGS. IF PERMANENT BRACING IS NOT SPECIFIED, CONTACT ENGINEER.

6. FOUNDATION:
CONVENTIONAL SHALLOW CONCRETE FOOTINGS 2000 PSF
SOIL BEARING CAPACITY 2000 PSF
THE CONTRACTOR SHALL BE RESPONSIBLE FOR DETERMINING THE SUITABILITY OF THE SOIL CONDITIONS FOR THE INTENDED STRUCTURE AND ASSUMED SOIL BEARING CAPACITY. IT IS RECOMMENDED THAT A GEOTECHNICAL FIRM BE HIRED TO PERFORM A SITE EVALUATION.

7. DIMENSIONS: VERIFY ALL DIMENSIONS WITH HOUSE PLANS. SEE HOUSE PLANS, MECHANICAL, ELECTRICAL AND PLUMBING DRAWINGS FOR EMBEDS, OPENINGS, SLEEVES, ETC. WHICH ARE NOT SHOWN ON STRUCTURAL DRAWINGS.

8. MEANS AND METHODS: THE STRUCTURAL ENGINEER SHALL NOT HAVE CONTROL OR BE RESPONSIBLE FOR CONSTRUCTION MEANS, METHODS, TECHNIQUES, PROCEDURES, OR SEQUENCES TEMPORARY BRACING, SHORING, GUYING OR OTHER MEANS TO SUPPORT STRUCTURAL ELEMENTS IN PLACE DURING CONSTRUCTION. FOR THE ACTS OR OMISSIONS OF THE CONTRACTOR, OR ANY OTHER PERSONS PERFORMING THE WORK OR FOR THE FAILURE OF ANY OF THEM TO CONSTRUCT THE WORK IN ACCORDANCE WITH THE CONTRACT DOCUMENTS.

9. SHOP DRAWINGS: SHOP DRAWINGS SHALL BE PREPARED AND SUBMITTED TO THE ENGINEER FOR REVIEW FOR ALL STRUCTURAL ELEMENTS UTILIZING PREFABRICATED COMPONENTS. ONE SET OF SIGNED & SEALED TRUSS ENGINEERING SHALL BE DELIVERED TO THE ENGINEER OF RECORD FOR THE STRUCTURE PER FLORIDA ADMINISTRATIVE CODE 61G15-30.005 AND 61G15-31.003.

At Exterior Stud Walls and Gable Ends with Wall Sheathing, apply plaster over metal lath over water resistive barrier as follows:
Plaster R703.7.2: 3-coat 7/8" thick portland cement based plaster per ASTM C926.
Metal Lath R703.7.1: Self furring paper backed 2.5lb diamond mesh metal lath per ASTM C847, G60 galvanized, fastened per ASTM C1063 with 1-1/2" long, 11 gage nails with 7/16" head (roofing nails) at 7" oc, or 1-1/2" long, 16 gage staples at 6" oc, into the framing members (ie, the nails or staples must align with and penetrate 3/4" into the framing studs).
Water Resistive Barrier (WRB) R703.7.3: Water-resistive vapor-permeable barrier with a performance at least equivalent to 2 layers of Grade D paper. The individual layers shall be installed independently. An approved house wrap may be used for the 1st layer and metal lath with approved paper backing may be the 2nd layer (Note: ZIP wall sheathing with seam tape qualifies as the first layer).

REVISIONS BY

STRUCTURAL ENGINEERING:
STRUCTURAL SYSTEMS OF NORTH FLORIDA
1834 SE. 47th STREET, SUITE #2
CAPE CORAL, FL 33904
(239) 549-4554
CA# 8829

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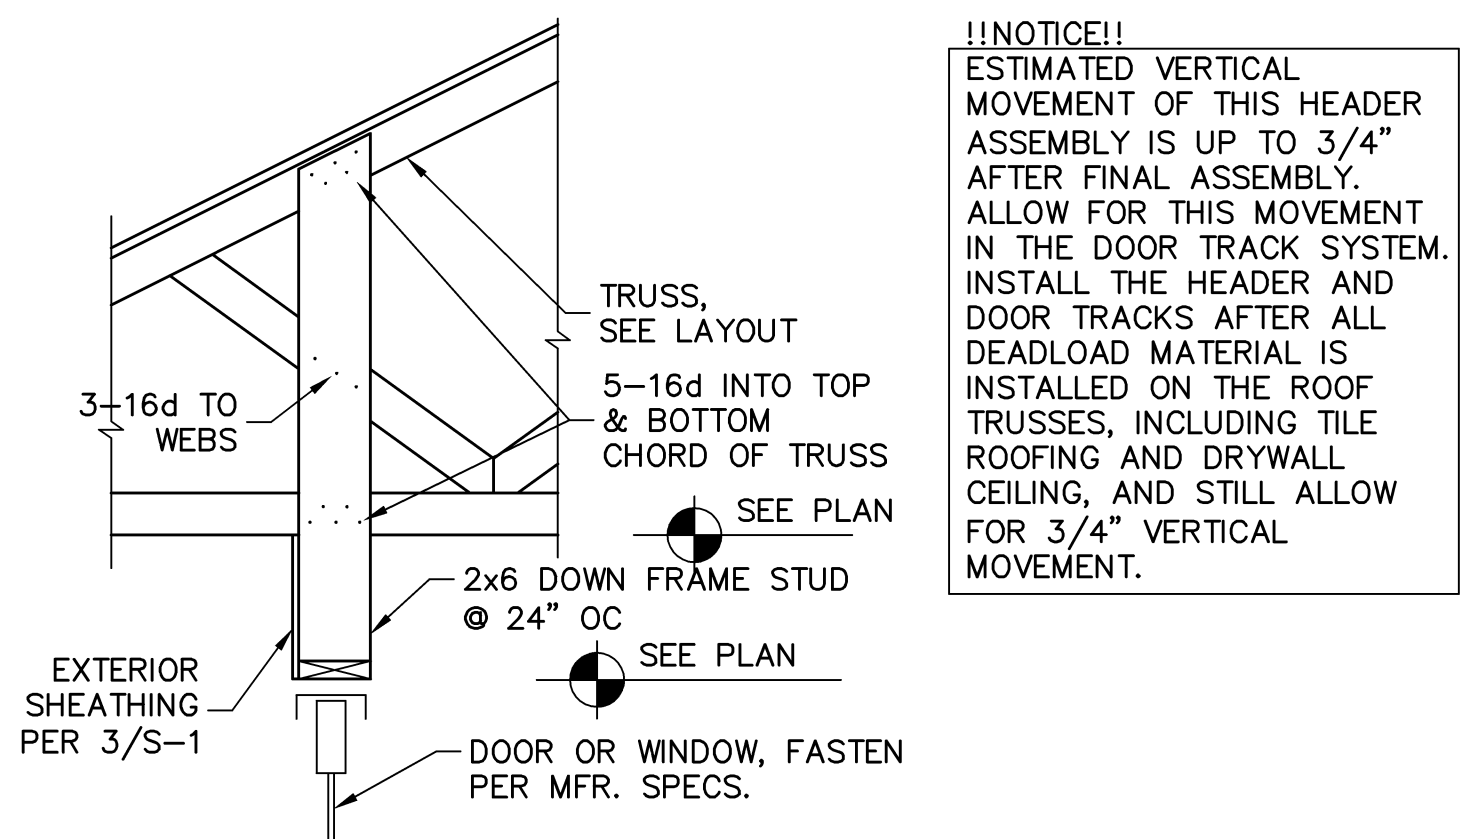
EMERALD HOMES
1380 Treeline Avenue South
Fort Myers, FL 33913
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STRUCTURAL DETAILS FOR MODEL 3692 K
292 MARAYMA BOULEVARD
VENICE, FLORIDA
LOT: 112 SUBDIVISION: TOSCANA ISLES EMERALD


DESIGN/DRAWN DWB/DWB
CHECKED DWB
DATE 08/21/18
SCALE AS NOTED
JOB NO. DR10283
SHEET

S-3
SHEET 3 OF 4


FOR SCOSTA TRUSSES, ELEVATION K, JOB # 4515PK, DATED: 07/12/13, REVISED: 06/18/18




1 TRUSS PERPENDICULAR TO WALL
SUSPENDED HEADER PERPENDICULAR
 SCALE: $\frac{3}{4}" = 1'-0"$

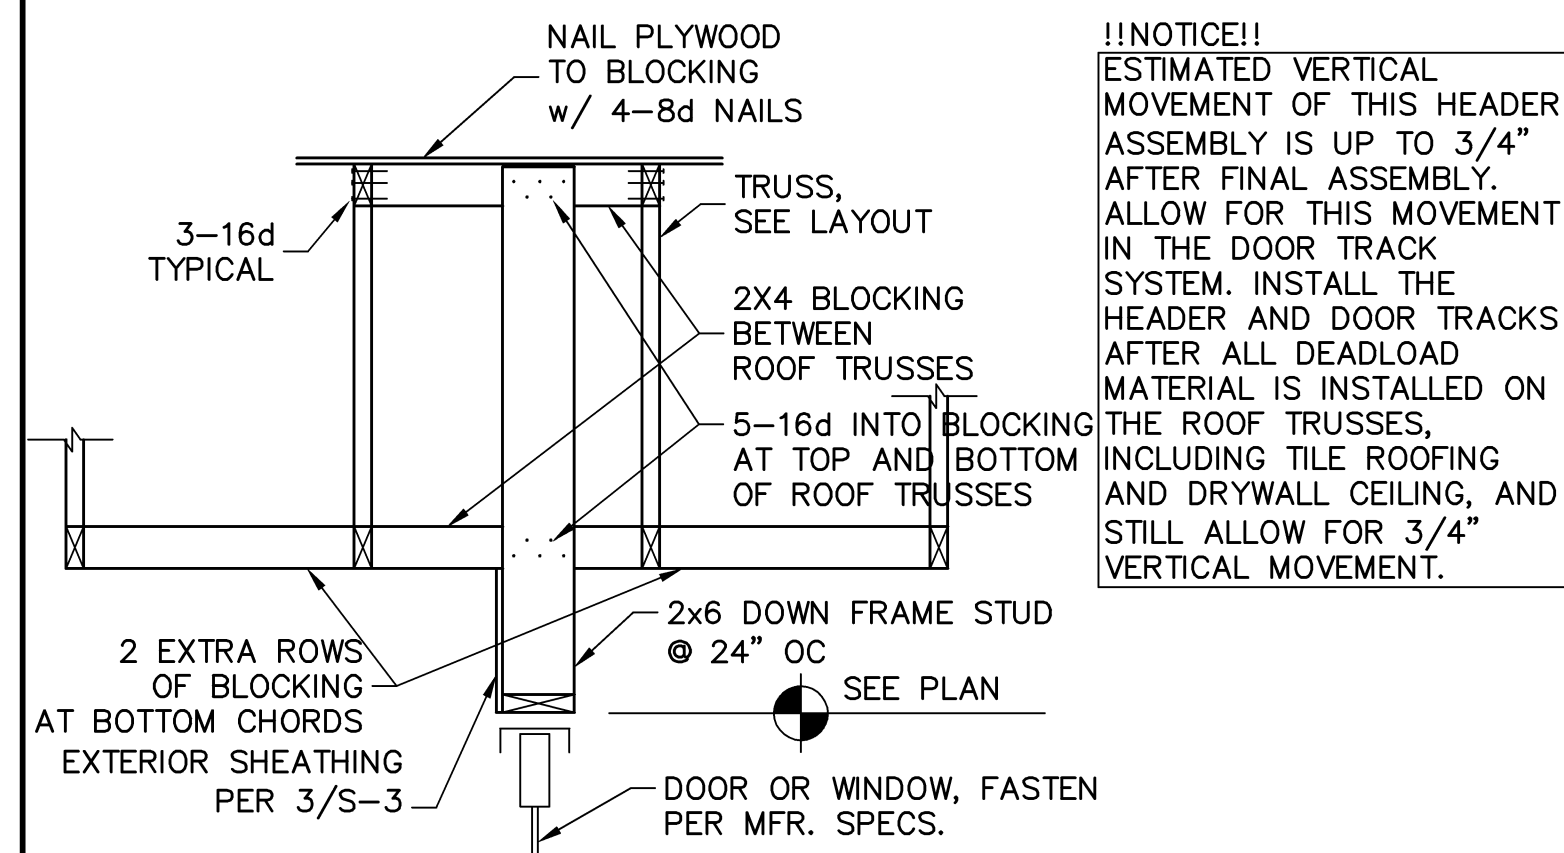

2 TRUSS PARALLEL TO WALL
SUSPENDED HEADER PARALLEL
 SCALE: $\frac{3}{4}" = 1'-0"$

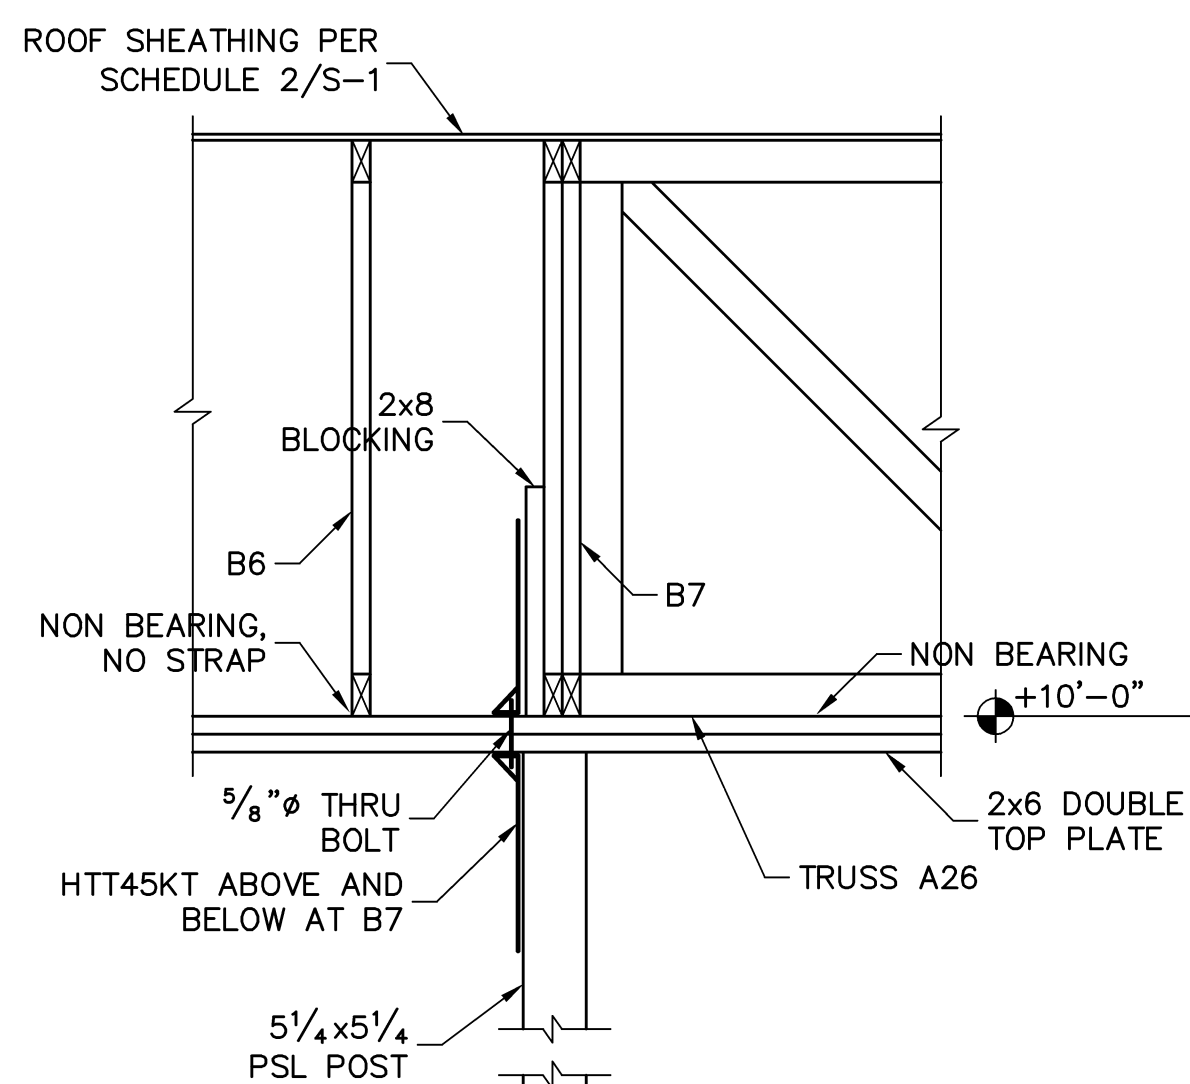

3 SECTION AT B7

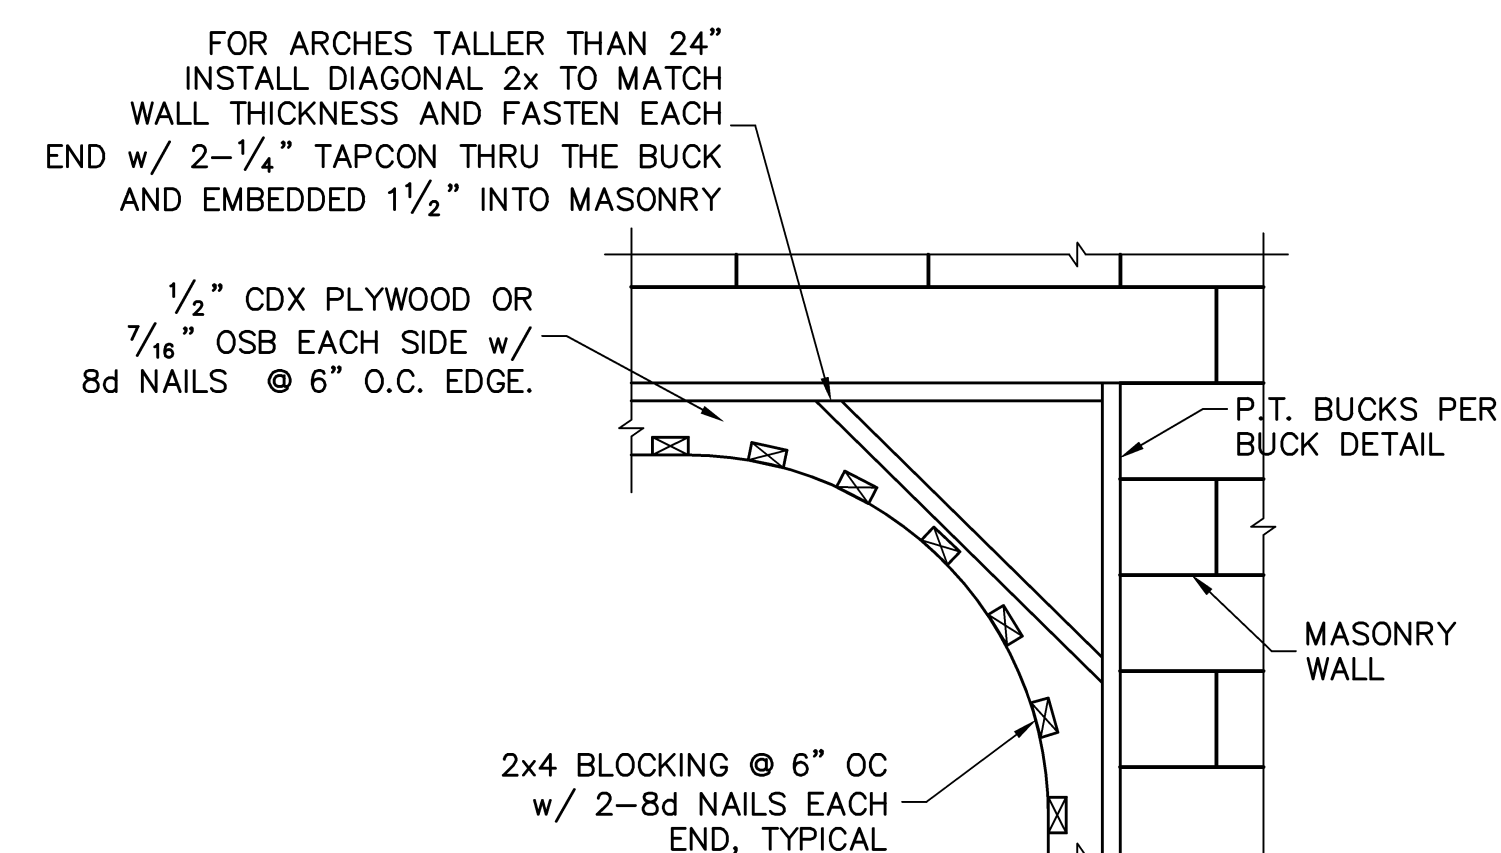

4 ARCHED SPACE FRAMING

FOR SCOSTA TRUSSES, ELEVATION K, JOB # 45150K, DATED: 07/12/13, REVISED: 06/18/18

[illegible]

STRUCTURAL ENGINEERING:

**STRUCTURAL
SYSTEMS
OF NORTH FLORIDA**

1634 S.E. 47th STREET, SUITE #3
CAPE CORAL, FL 33904
(239) 549-4554

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STRUCTURAL DETAILS FOR
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292 MARAVIVA BOULEVARD
VENICE, FLORIDA
LOT: 112 SUBDIVISION: TOSCANA ISLES EMERALD

DESIGN/DRAWN
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AS NOTED
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DR10283
SHEET

S-4

SHEET 4 OF 4