



# TYPICAL JACK CUTS

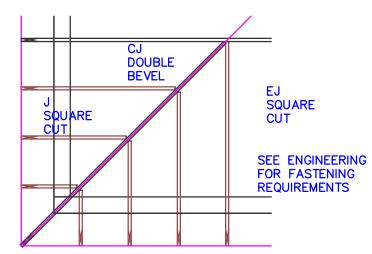

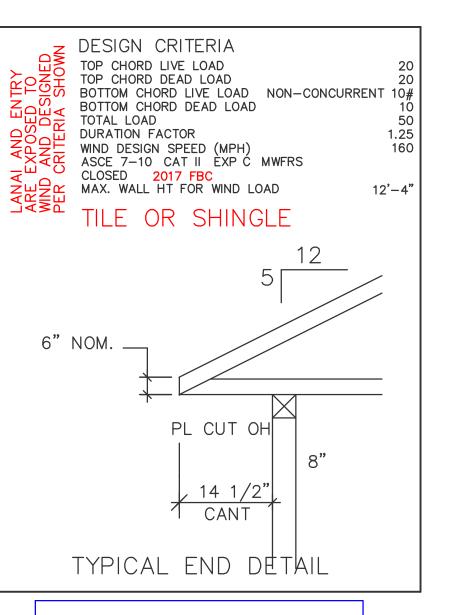

\*\*UNLESS NOTED\*\*

REACTION VALUES ARE UNDER 5000#

UPLIFT VALUES ARE UNDER 1000#

ALL TRUSSES 24"o.c. UNLESS NOTED OTHERWISE \*\*\*\*\*\*\*CAUTION\*\*\*\*\*

DO NOT ATTEMPT TO ERECT TRUSSES WITH-


OUT REFERRING TO THE ENGINEERING DWGS.

IT IS NECESSARY TO REFER TO THE ENGINEERING DRAWINGS FOR NUMBER OF MEMBERS, BEARING LOCATION, ORIENTATION AND WEB BRACING

REFER TO WTCA/TPI BSCI-B1 SUMMARY SHEET FOR HANDLING METHODS & TEMPORARY BRACING, WHICH IS ALWAYS REQUIRED

BEARING HEIGHTS BASED ON PLANS PROVIDED TO SCOSTA CORP. "+/-" BEARING DIFFERENCES SHOWN ARE CRITICAL. IF ANY HEIGHTS DEVIATE - INFORM SCOSTA CORP.

BEARING WALL & BEAM HEIGHTS

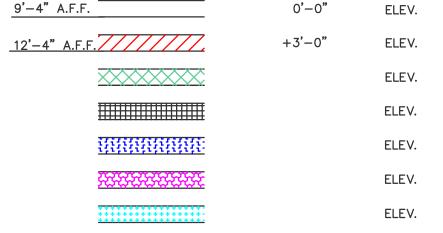

#### HANGER SCHEDULE

C USP HUS 26 (M) USP THDH 28-3 F USP HUS 28 (N) USP THD 48 H USP THDH 28 P USP JUS 24 I USP THDH 28-2 B USP MSH 422 W USP HJC 26 HANGER VALUES HAVE BEEN BASED ON 16D COMMON NAILS EXCEPT THE FOLLOWING LUS24 - 10D COMMON THJA26 - 10D x 1-1/2


### \*\*\*\*\*\*ATTENTION\*\*\*\*\*


APPROVAL OF THIS TRUSS LAYOUT IS NECESSARY BEFORE FABRICATION CAN BEGIN. VERIFY DIMENSIONS, PITCHES, OVERHANGS, ELEVATIONS, CEILING & BEARING CONDITIONS. SCOSTA CORPORATION IS RESPONSIBLE FOR ACCURACY IN ACCORDANCE WITH PLANS AND/OR INFORMATION PROVIDED BY CUSTOMER, WITH ANY DEVIATIONS NOTED HEREIN. CUSTOMER IS RESPONSIBLE TO VERIFY ACCURACY OF INFORMATION AND PLANS PROVIDED TO SCOSTA CORPORATION, AND TO VERIFY CONFORMANCE TO FIELD CONDITIONS, AND/OR OWNER CHANGES. TRUSSES WILL BE BUILT IN ACCORDANCE WITH THE APPROVED LAYOUT.

APPROVED BY: \_\_\_\_\_


DATE: \_\_\_\_\_ REQUESTED DELIVERY DATE: \_\_\_\_\_ JOBSITE CONTACT NAME: \_\_\_\_\_


PHONE #: \_\_\_

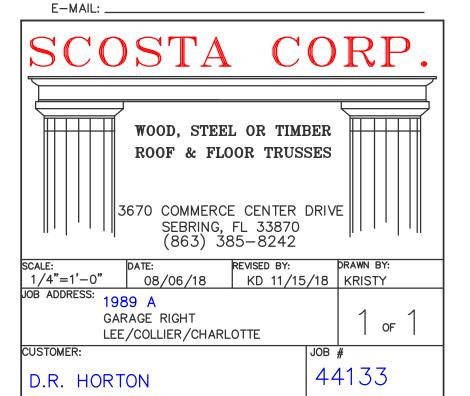


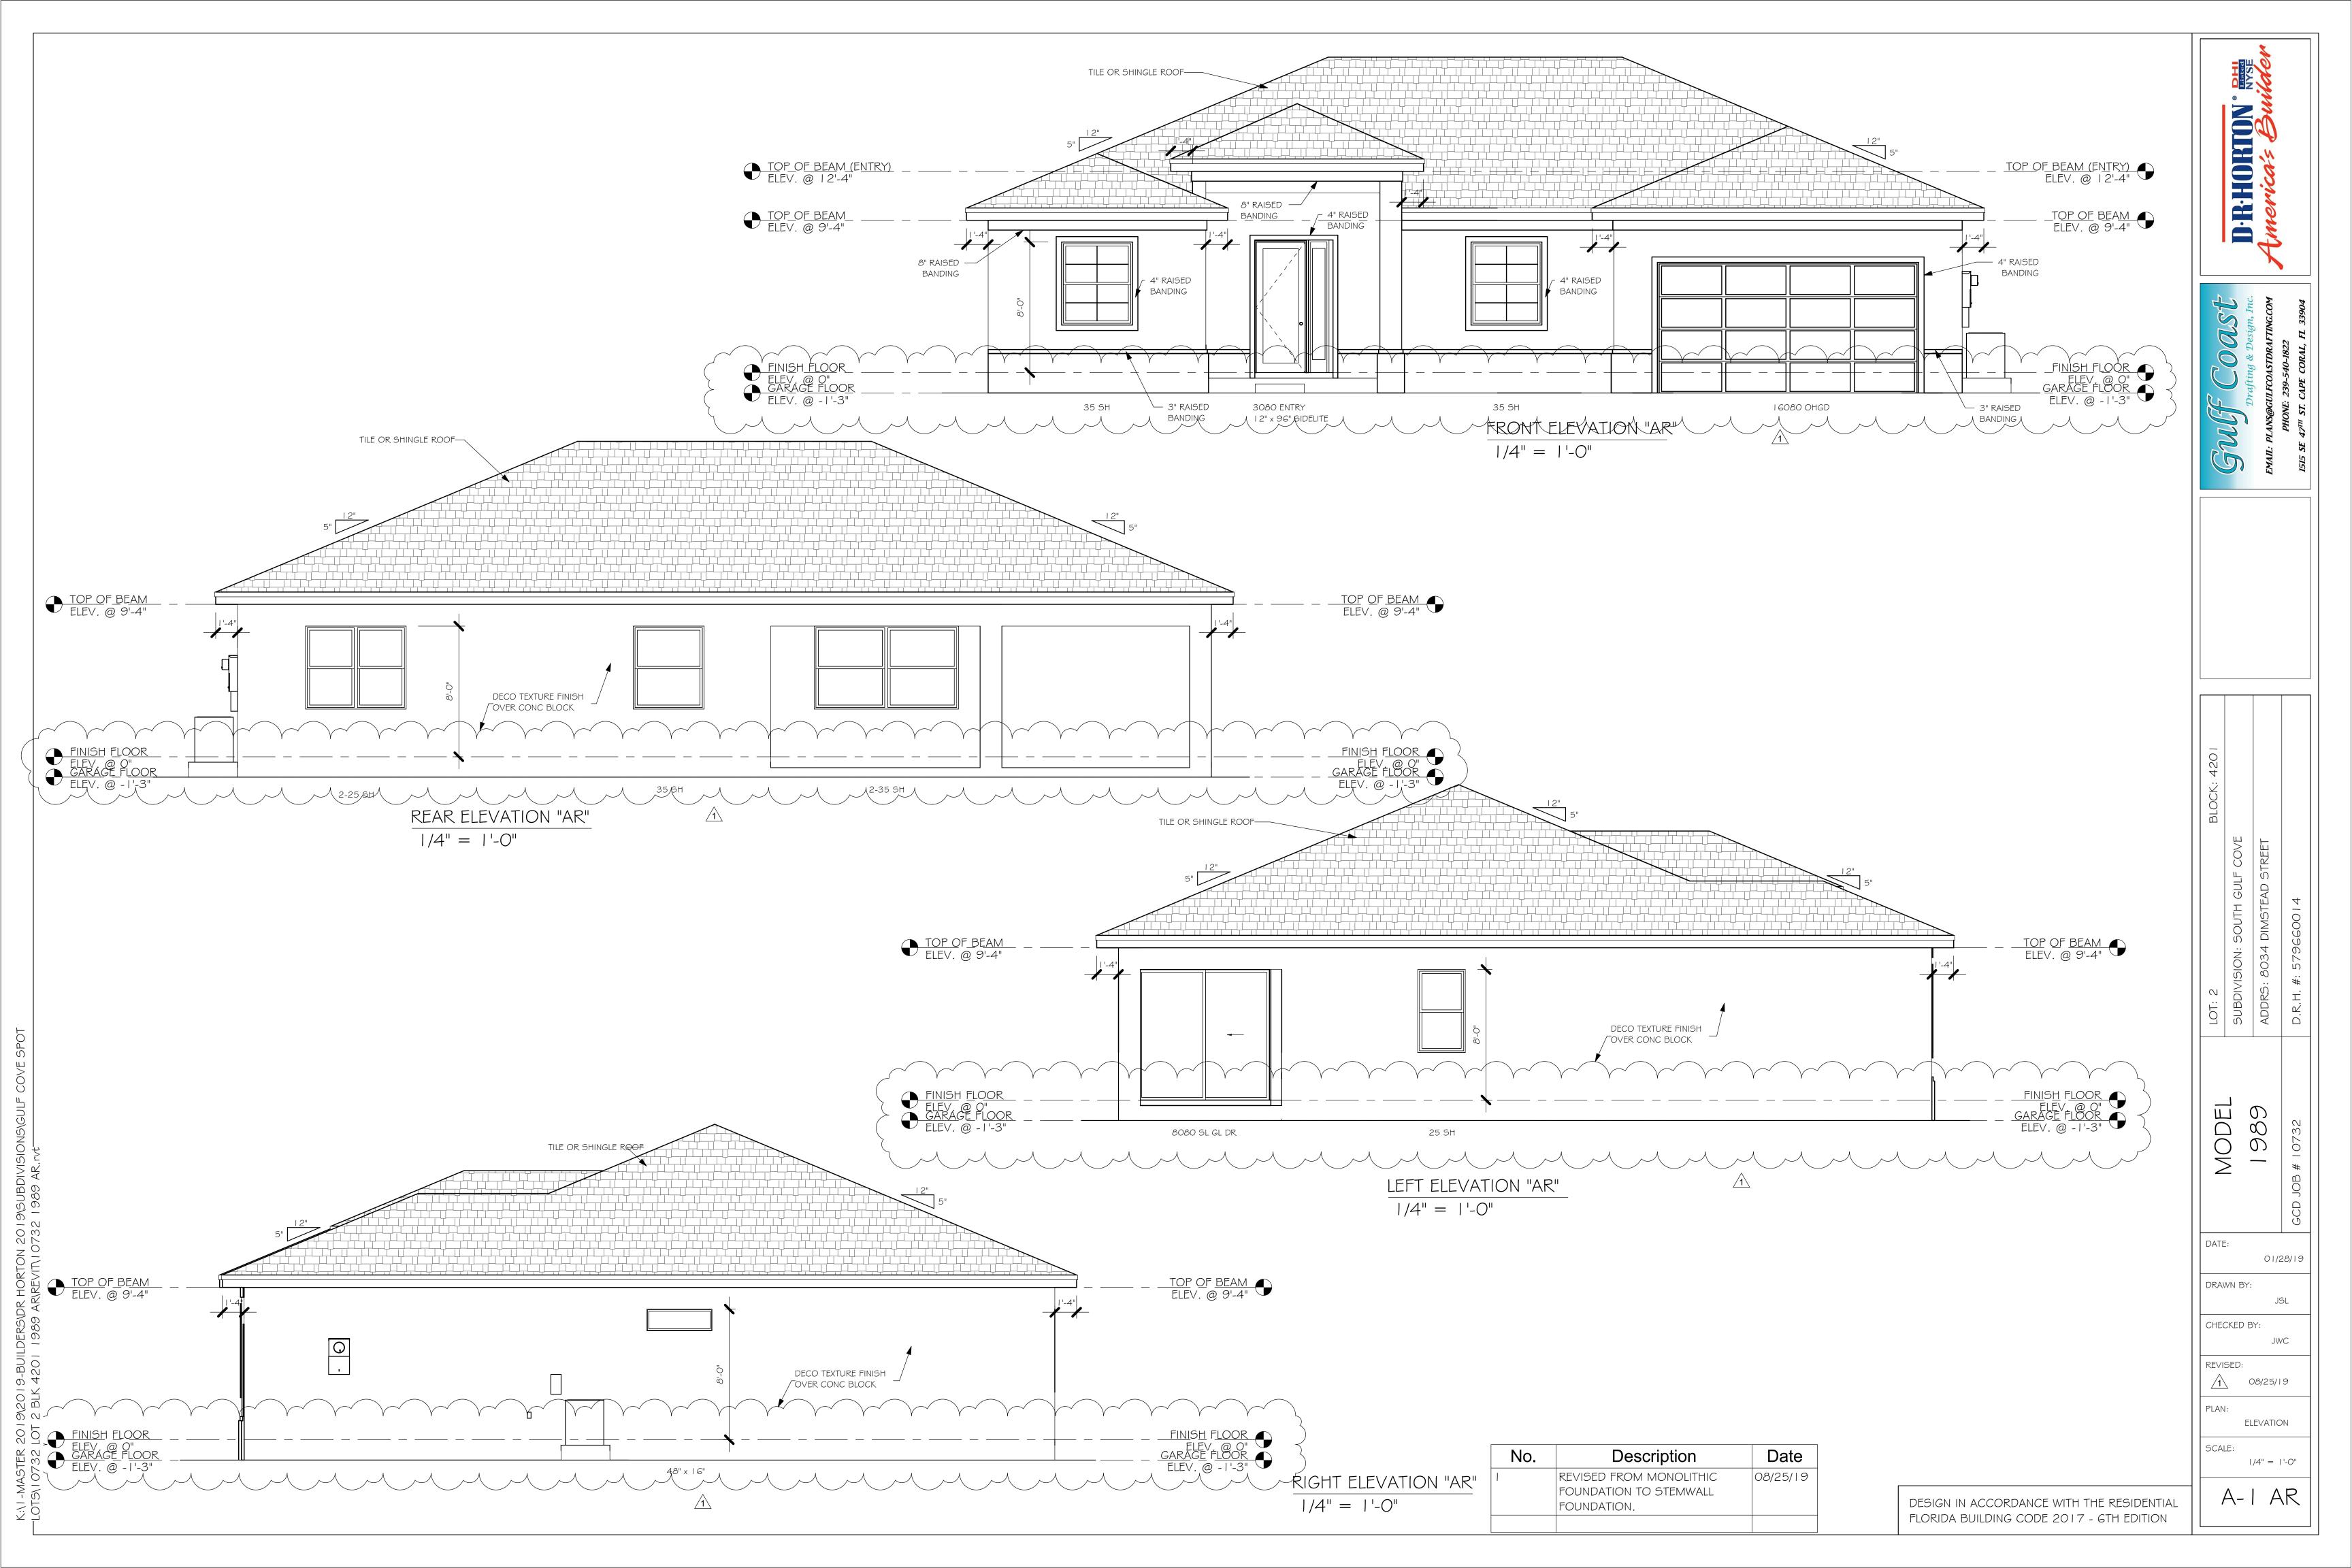



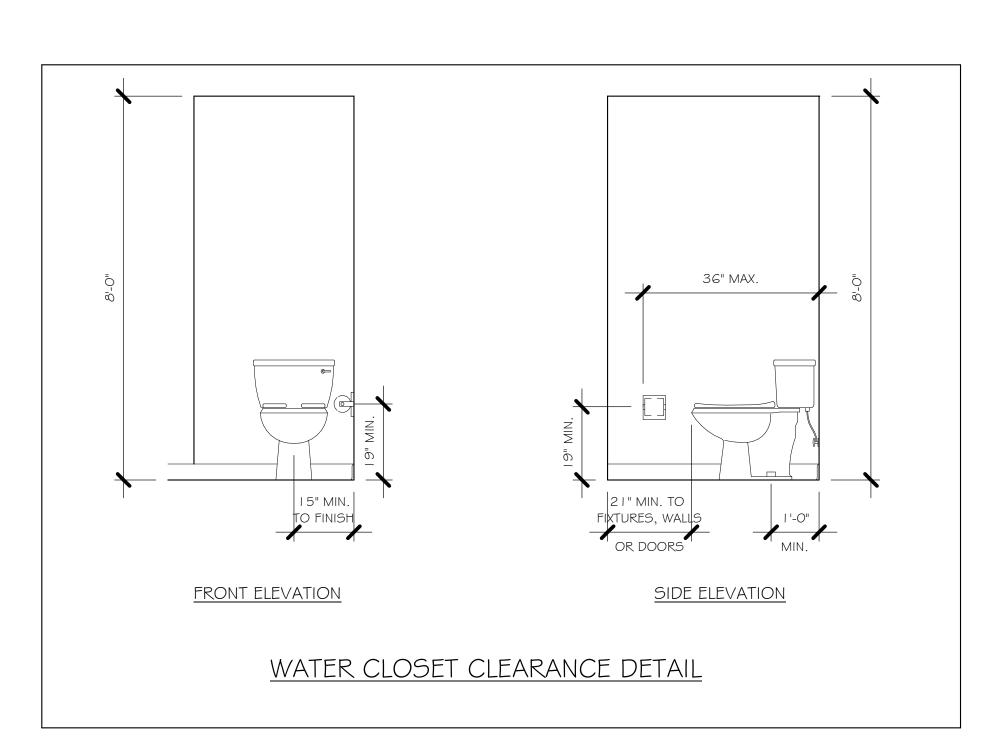

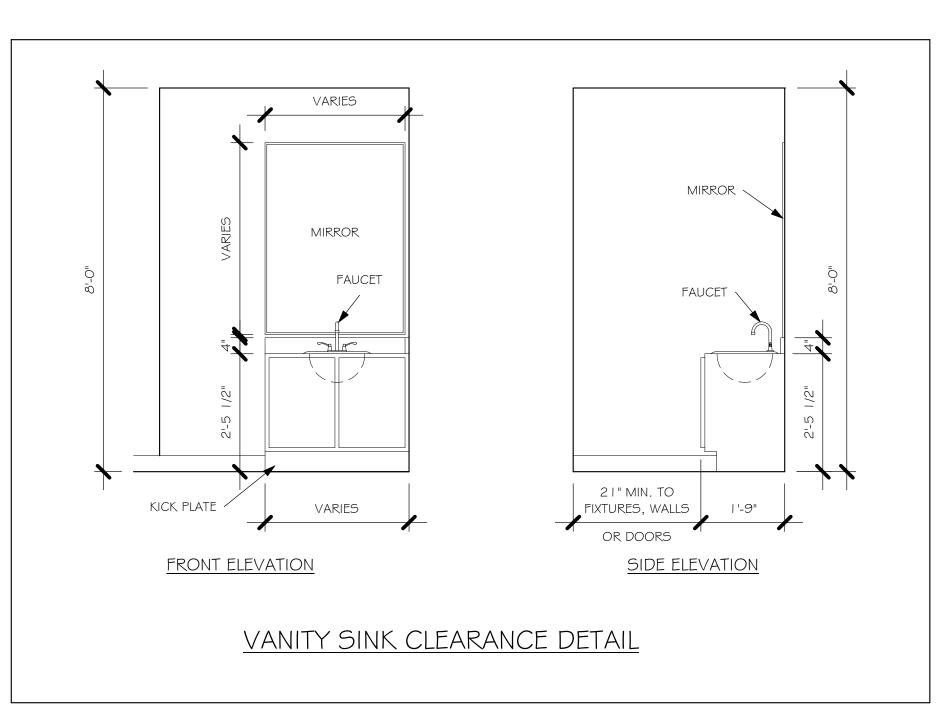

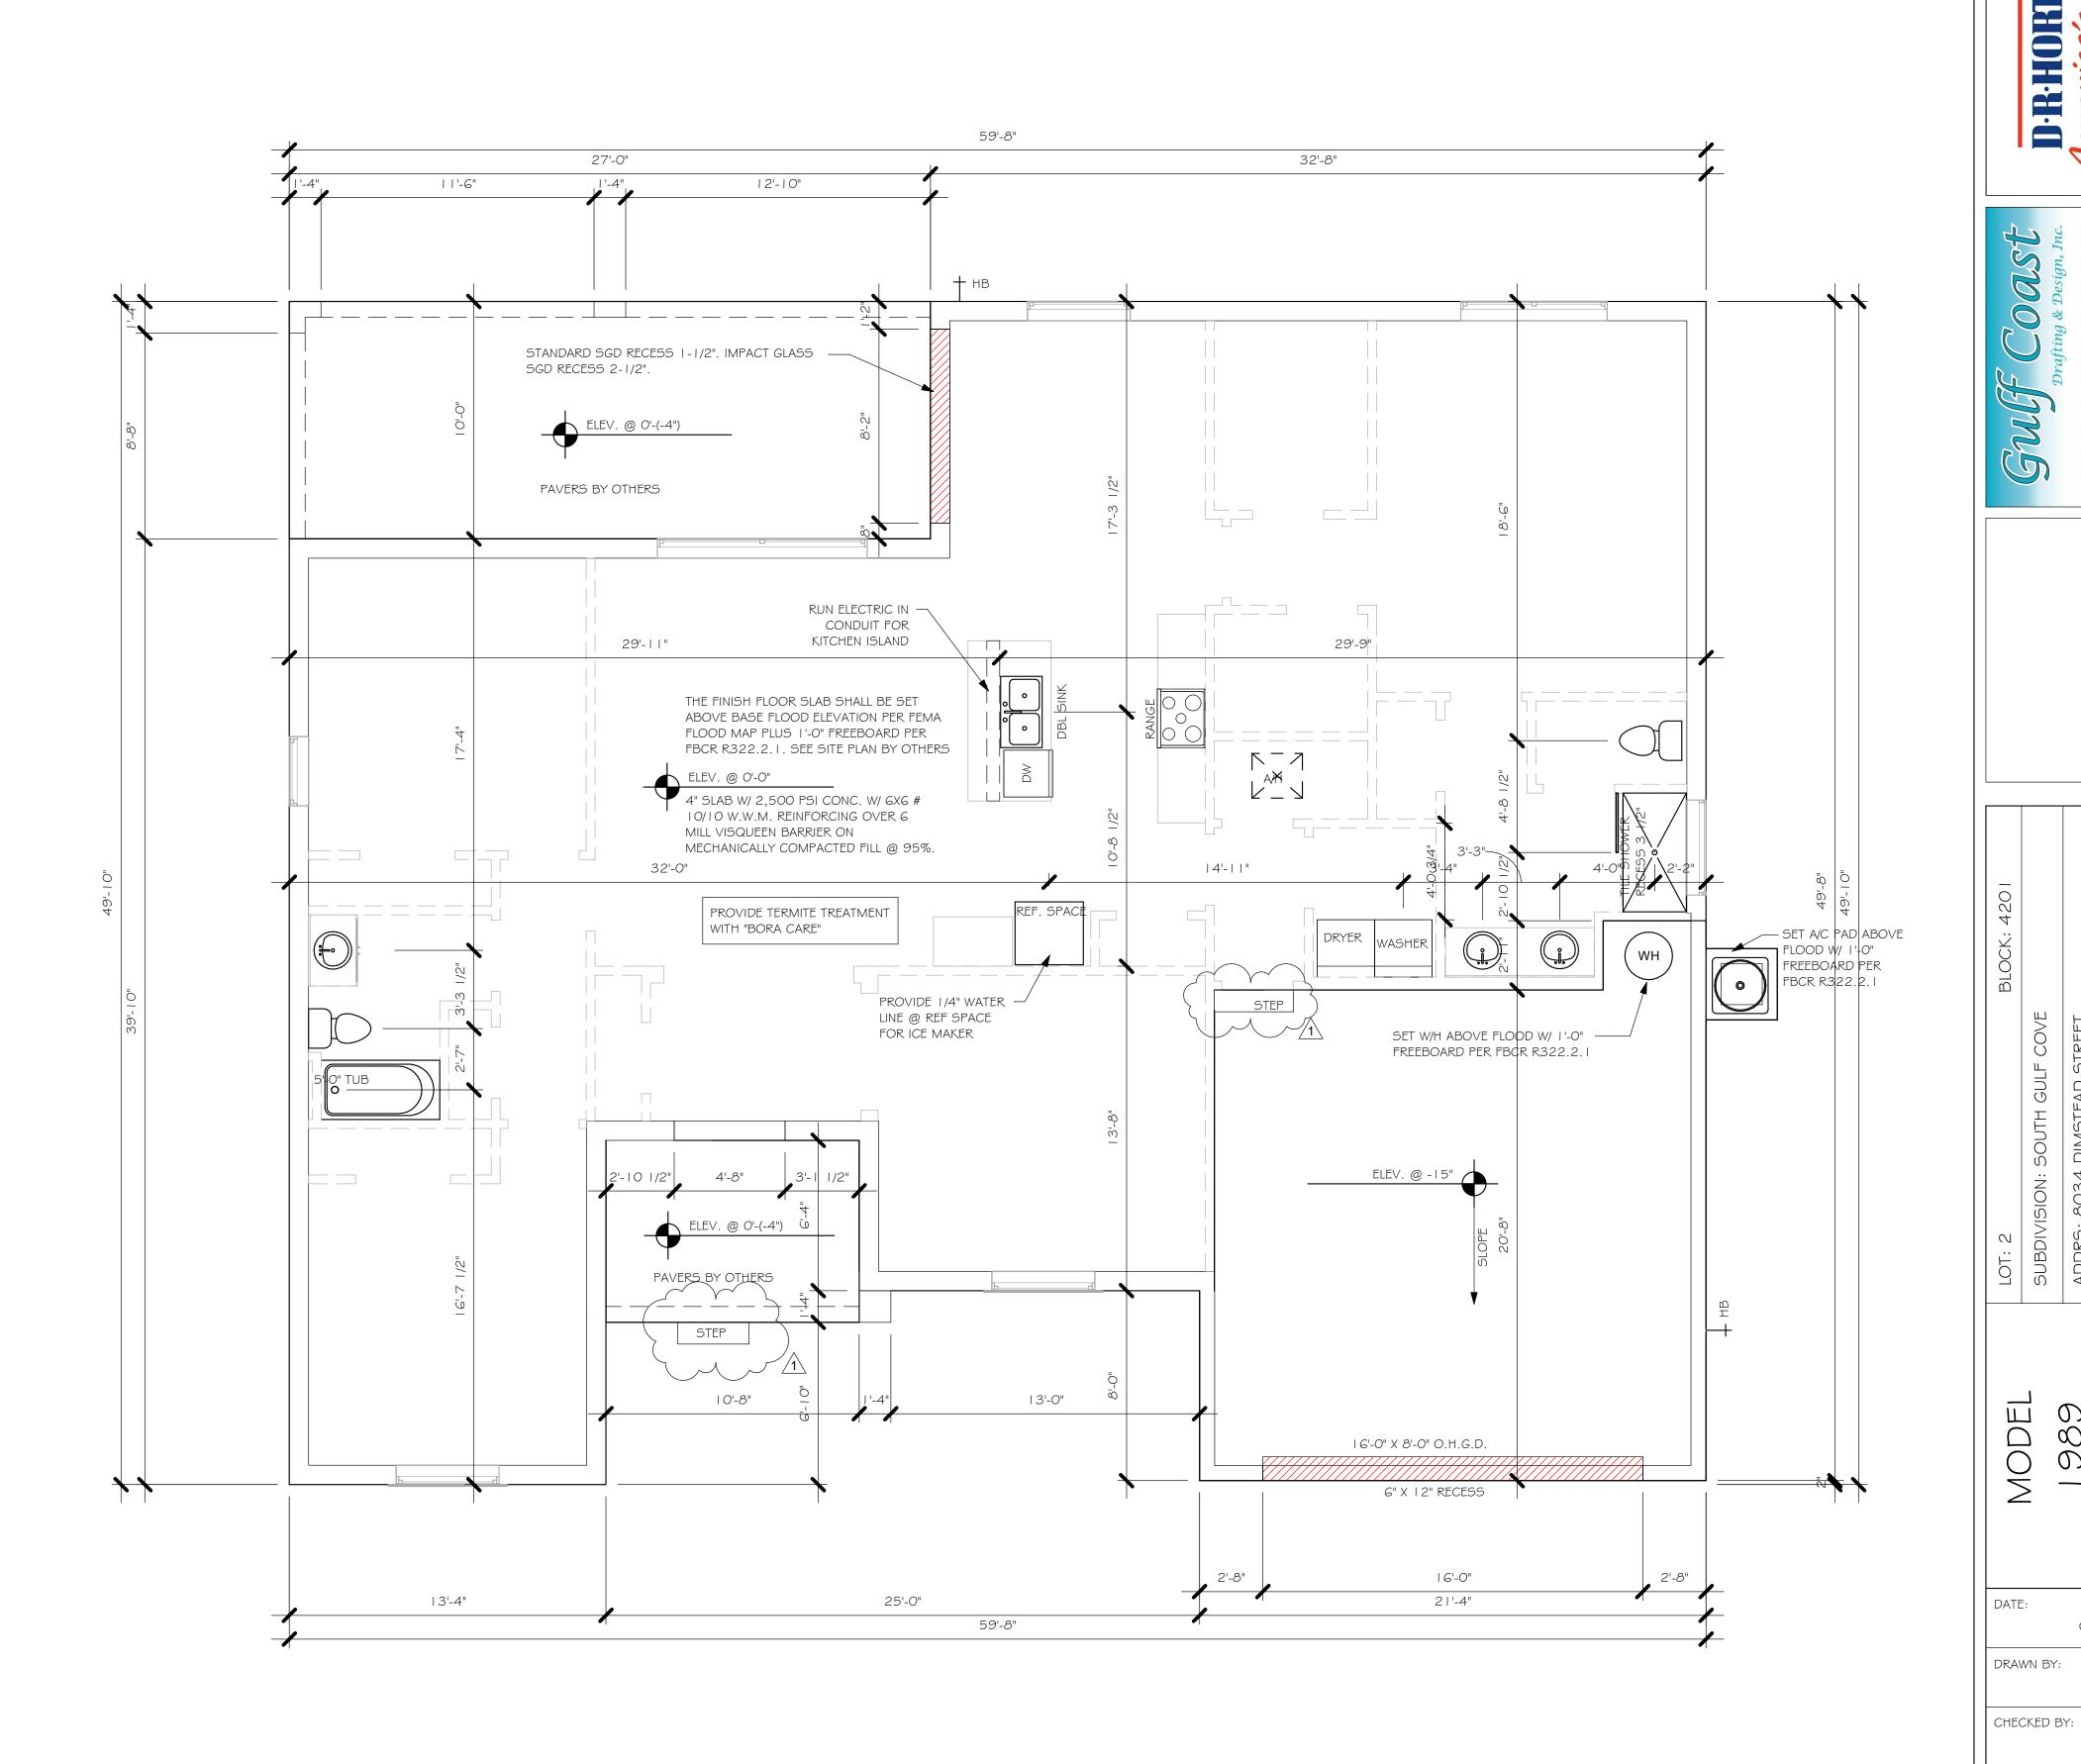

 $\frac{\text{SLAB} \notin \text{PLUMBING PLAN "AR"}}{1/4" = 1'-0"}$ 

No.	Description	Date
1	REVISED FROM MONOLITHIC	08/25/19
	FOUNDATION TO STEMWALL	
	FOUNDATION.	

DESIGN IN ACCORDANCE WITH THE RESIDENTIAL
FLORIDA BUILDING CODE 2017 - 6TH EDITION

01/28/19

08/25/19

As indicated

A-2 AR

SLAB & PLUMBING

REVISED:

1

PLAN:

SCALE:

8'-0"

8'-0"

		WINDO	W SCH	HEDUL	E	
MARK	DESCRIPTION	MANUFACTURER	WIDTH	HEIGHT	COMMENTS	QTY
А	25 SH		3'-1"	5'-3"		1
В	35 SH		4'-6"	5'-3"		3
С	2-35 SH		9'-0"	5'-3"		1
D	2-25 SH		6'-4"	5'-3"		1
E	48" X 16"	FIXED GLASS	4'-2"	1'-6"		1

OPT IMPACT GLASS MAY BE INSTALLED IN LIEU OF SHUTTERS VERIFY W/ CONTRACT


2-4080 SL. GL. DR.

DOOR HEADERS		
6'-8" BI-FOLD	HEADER HEIGHT	82" A.F.F.
6'-8" SWING	HEADER HEIGHT	82 I/2" A.F.F.
8'-0" SWING	HEADER HEIGHT	98 I/2" A.F.F.

CABINET BACKING		
KITCHEN	UPPER TOP @ 84"	BASE TOP @ 35"
MASTER BATH	UPPER	BASE TOP @ 35"
GUEST BATH	UPPER	BASE TOP @ 31"
LAUNDRY ROOM	UPPER TOP @ 84"	BASE

#### PLAN NOTES


- I) VERIFY ALL ROUGH OPENING DIMENSIONS FOR
- 2) PROVIDE SAFETY GLAZING WITHIN 24" FROM EXIT PER FLORIDA BUILDING CODE R 308.4.2.
- 3) PROVIDE SAFETY GLAZING AT BATH/ SHOWER PER FLORIDA BUILDING CODE R 308.4.5.
- 4) NON BEARING INTERIOR FRAME WALLS SHALL BE FRAMED W/ WOOD OR METAL STUDS. SPACING SHALL NOT EXCEED 24" O.C. (NON BEARING WALLS ONLY)
- 5) PROVIDE DEAD WOOD IN ATTIC FOR OVERHEAD GARAGE DOOR HARDWARE
- 6) KITCHEN KNEE WALL TO BE FRAMED W/ TOP @ 34 I/2" A.F.F.
- 7) INSTALL SMOOTH WALLS IN KITCHEN AND ALL BATHROOM AREAS
- 8) WHERE DRYWALL CEILING IS APPLIED TO TRUSSES @ 24" O.C. USE 5/8" DRYWALL OR 1/2" SAG RESISTANT PER SEC. 702.3.5
- 9) THE GARAGE SHALL BE SEPARATED FROM THE RESIDENCE \$ ATTIC BY NOT LESS THEN 1/2" GYPSUM BOARD APPLIED TO THE GARAGE SIDE. GARAGES BENEATH HABITABLE ROOMS SHALL BE SEPARATED WITH NOT LESS THAN 5/8" TYPE "X" GYPSUM BOARD OR EQUIVALENT. WHERE THE SEPARATIION IS A FLOOR - CEILING ASSEMBLY, THE STRUCTURE SUPPORTING THE SEPARTION SHALL ALSO BE PROTECTED BY NOT LESS THAN 1/2" GYPSOM BOARD OR EQUIVALENT
- 10) INSTALL 1 3/8" THICK SOLID WOOD DOOR BETWEEN LIVING AND GARAGE PER FLORIDA BUILDING CODE
- II) ALL WINDOWS INSTALLED 72" ABOVE GRADE MUST COMPLY WITH R6 | 2.2 MIN 24" SILL HEIGHT OR PROVIDED WITH AN APPROVED WINDOW FALL PRVENTION DEVICE
- 12) ALL CLOSET SHELVES TO BE 12". ALL PANTRY \$ LINEN TO BE (4)-16" SHELVES 18" O.F.F. W/ 15"
- 13) ALL MECHANICAL AND ELECTRICAL EQUIPMENT TO BE INSTALLED AT OR ABOVE FLOOD PLUS 1'-0" FREEBOARD.

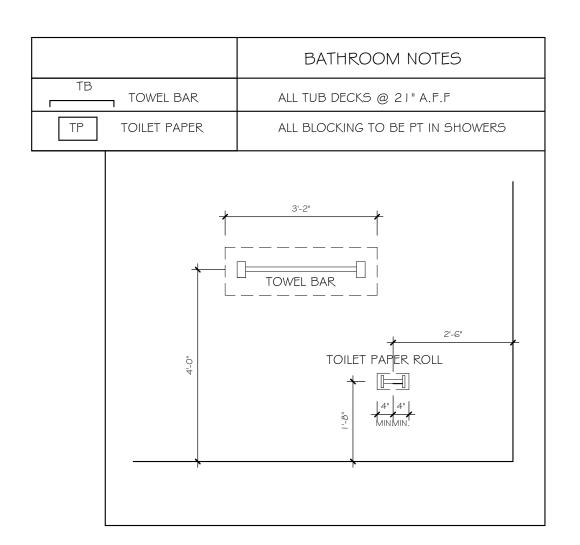


# SQUARE FOOTAGE

ENTRY AREA	82 SF
ANAI AREA	270 SF
GARAGE AREA	443 SF
IVING AREA	1987 SF
TOTAL AREA	2780 SF

INTERIOR DOOR SCHEDULE				
MARK	DOOR WIDTH	NOTES		
	3'-0"	P.K. = POCKET DOOR		
2	2'-10"	B.F. = BI-FOLD DOOR		
3	2'-8"	D.1 DI-1 OLD DOOK		
4	2'-6"	B.P. = BI-PASS DOOR		
5	2'-4"	L.V. = LOUVERED DOOR		
6	2'-0"			
7	1'-8"			
8	1'-6"			

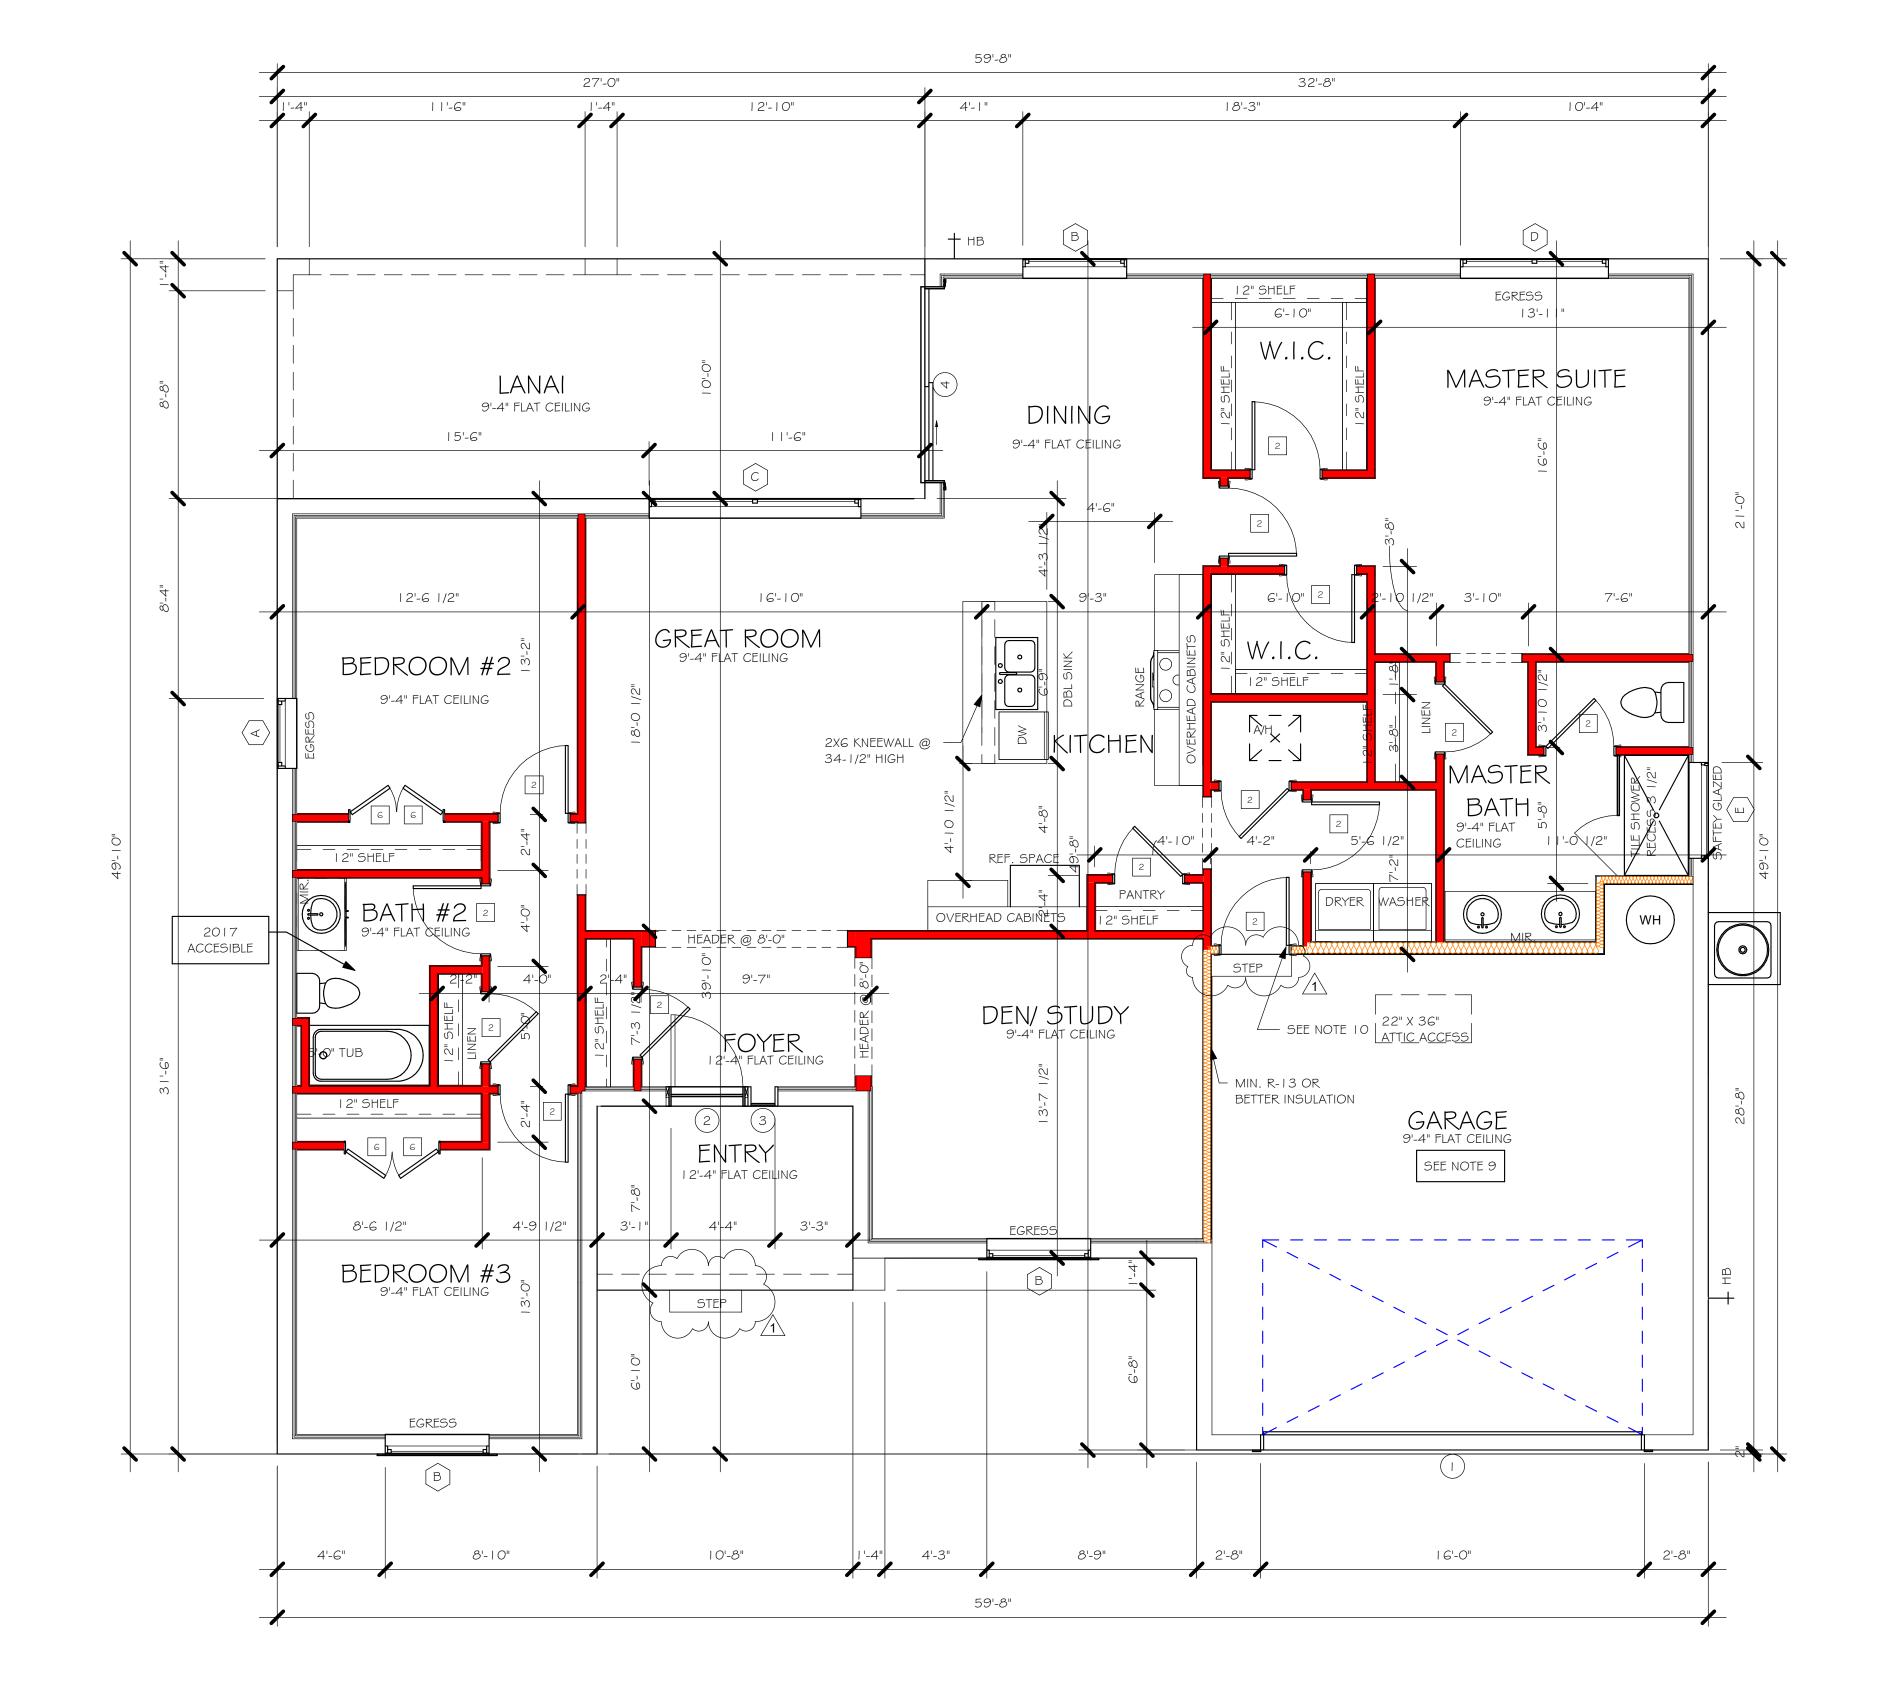

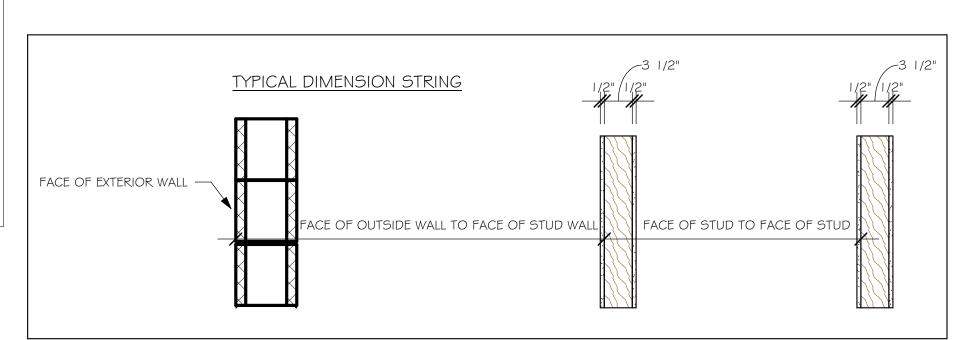

FLOOR PLAN "AR" 1/4" = 1'-0"

Description	Date
REVISED FROM MONOLITHIC FOUNDATION TO STEMWALL FOUNDATION.	08/25/19
	REVISED FROM MONOLITHIC FOUNDATION TO STEMWALL

DESIGN IN ACCORDANCE WITH THE RESIDENTIAL FLORIDA BUILDING CODE 2017 - 6TH EDITION

A-3 AR

MODEL

DATE:

DRAWN BY:

CHECKED BY:

REVISED:

PLAN:

SCALE:

98


01/28/19


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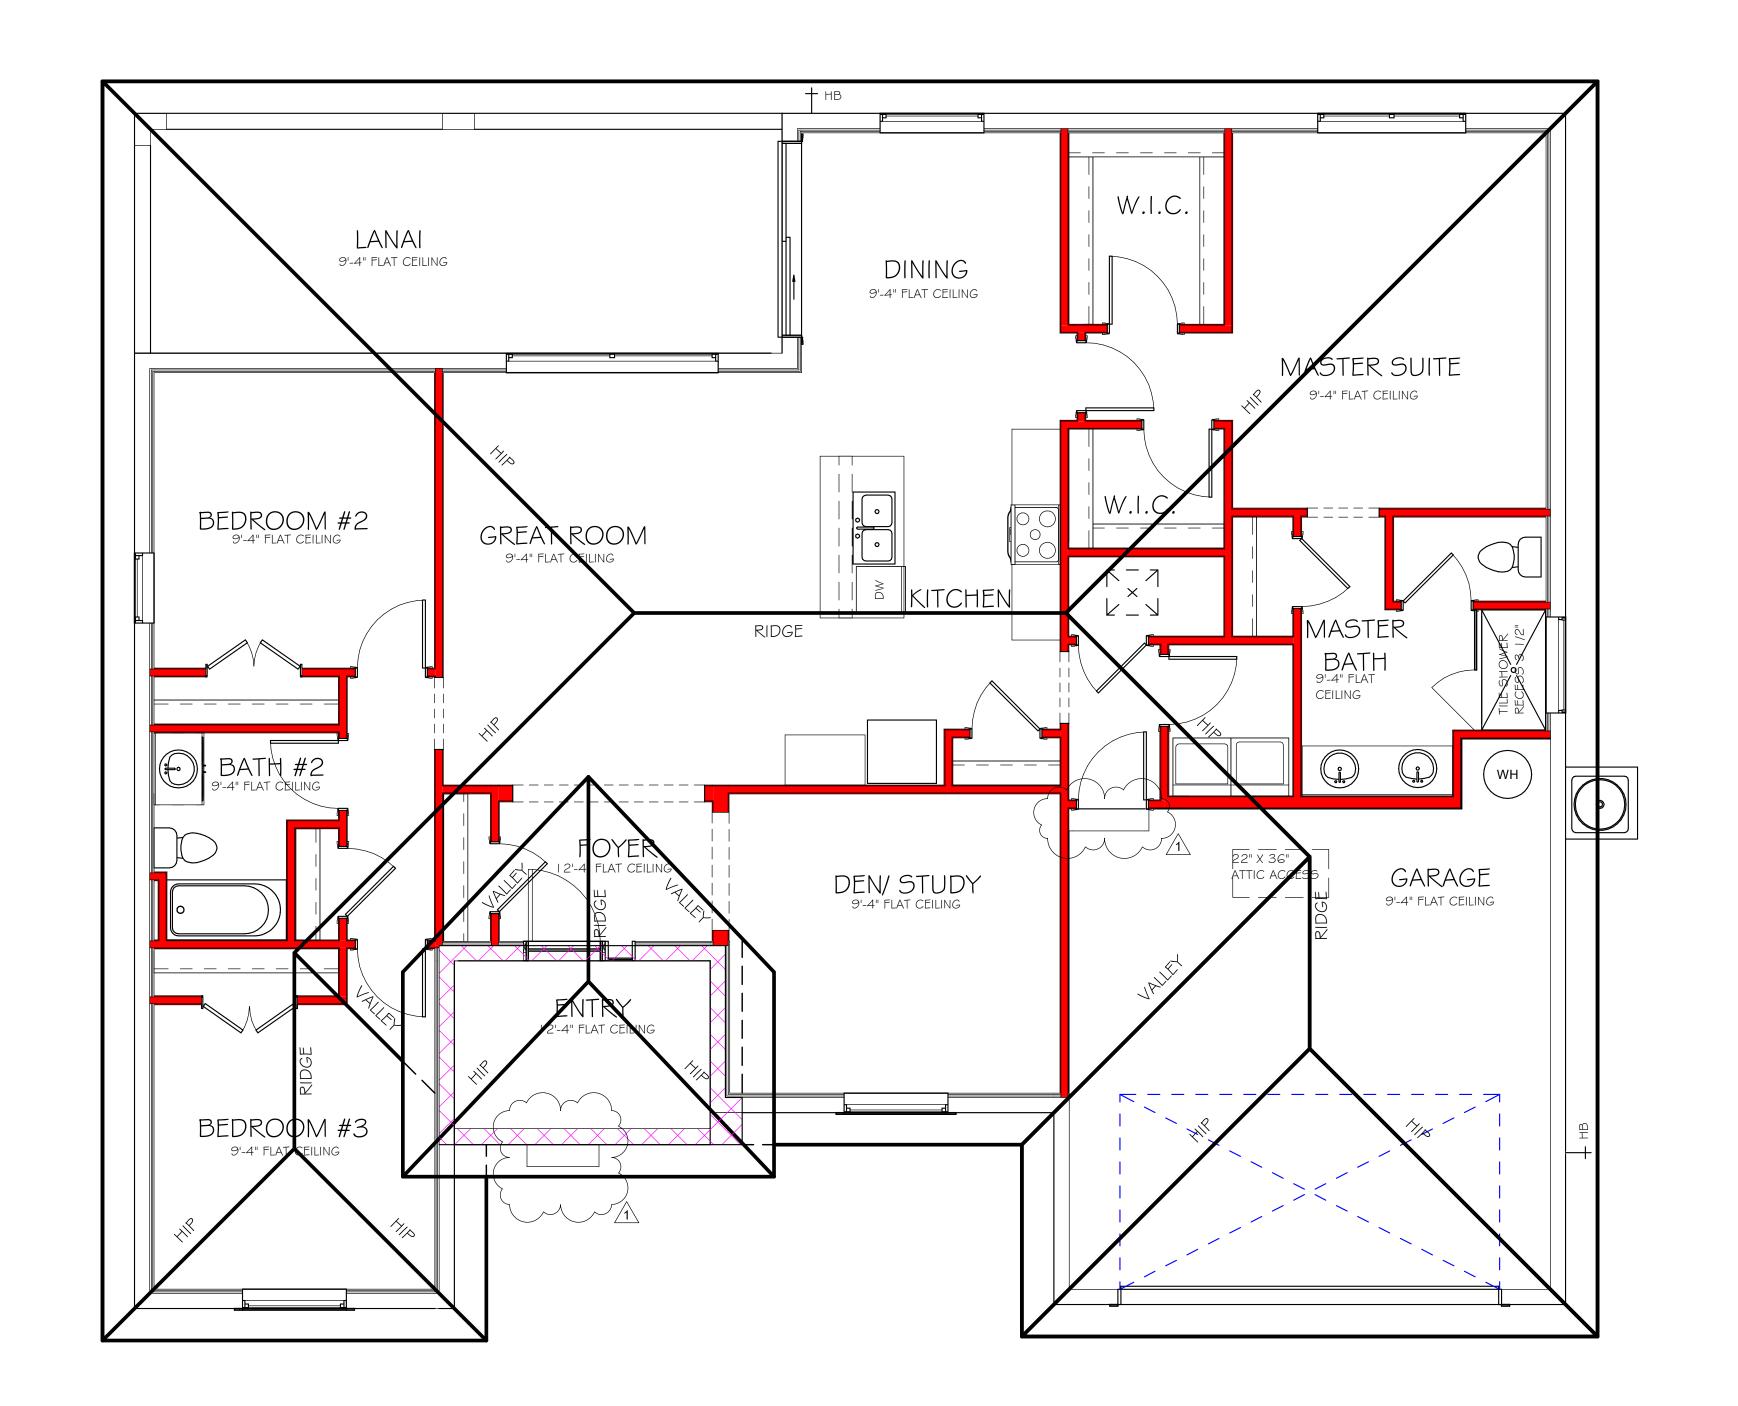
08/25/19

FLOOR

As indicated



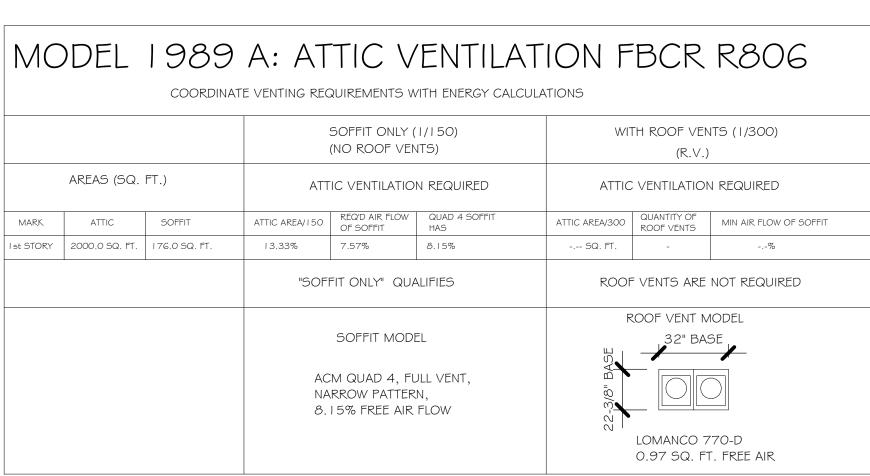

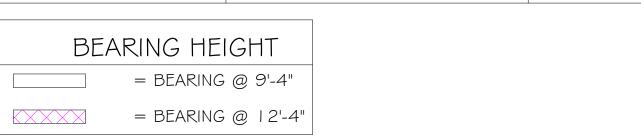

 $\frac{\text{ROOF PLAN "AR"}}{1/4" = 1'-0"}$ 

No.	Description	Date
1	REVISED FROM MONOLITHIC	08/25/19
	FOUNDATION TO STEMWALL	
	FOUNDATION.	

	As indicated
DESIGN IN ACCORDANCE WITH THE RESIDENTIAL FLORIDA BUILDING CODE 2017 - 6TH EDITION	-4 AR

MODEL

DRAWN BY:

CHECKED BY:

REVISED:

PLAN:

SCALE:

01/28/19

08/25/19

ROOF

<del>()</del> □	DIMMER SWITCH
₩ <sup>S</sup>	MOTION SENSOR SWITCH
S <sub>SD</sub>	AC/DC SMOKE DETECTOR TO BE INTERCONNECTED ANY RESIDENT HAVING A FOSSIL-BURNING HEATER OR APPLIANCE, A FIREPLACE, OR AN ATTACHED GARAGE SHALL HAVE AN OPERATIONAL CARBON MONOXIDE ALARM INSTALLED WITHIN 10 FEET OF EACH ROOM USED FOR SLEEPING PERPOSES. PER RULE 9B-3.04.72 SD (SMOKE DETECTOR) SCD (CARBON MONOXIDE/ SMOKE DETECTOR)
<b>-</b> T	TELEPHONE OUTLET
-TV	TELEVISION RECEPTION OUTLET
	SURFACE MOUNTED CEILING LIGHT
	RECESSED LIGHT
Ю	WALL MTD. BRACKET LIGHT
46	DUPLEX FLOOD LIGHT
\$	EXHAUST FAN
$\nabla \nabla$	TRACK MTD. LIGHTS
□-	A/C DISCONNECT
Ю	PUSH BUTTON (PB) / DOOR BELL (DB)
(10)	INTERCOM
	KEYPAD
<u> </u>	4' FLUORESCENT LIGHT
<u> </u>	2' UNDER COUNTER LIGHT
NOTE: NO	DT ALL SYMBOLS ARE USED FOR THIS

PROJECT.

K:\I-MASTER 2019\2019-BUILDERS\DR HO LOTS\10732 LOT 2 BLK 4201 1989 AR\RE

ELECTRICAL NOTES:

ARC-FAULT CIRCUIT-INTERRUPTERS AND TAMPER RESISTANT RECEPTACLES SHALL BE INSTALLED IN DWELLING UNITS PER N.E.C 210.12 AND 406.11


ALL OUTLETS IN WET AREAS AND ALL


INSTALL PHONE AND T.V PER CONTRACT. INSTALL ALL ELECTRICAL PER NEC 2014

EXTERIOR OUTLETS TO BE GFI'S.

ALL ELECTRIC, ELETRICAL EQUIPMENT AND APPLIANCES TO BE SET AT

OR ABOVE BASE FLOOD ELEVATION PLUS 1'-0" FREEBOARD.

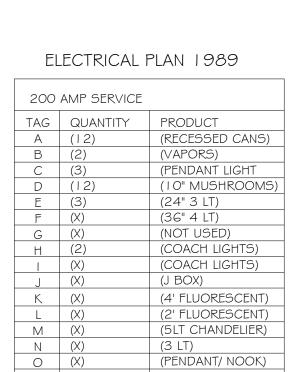

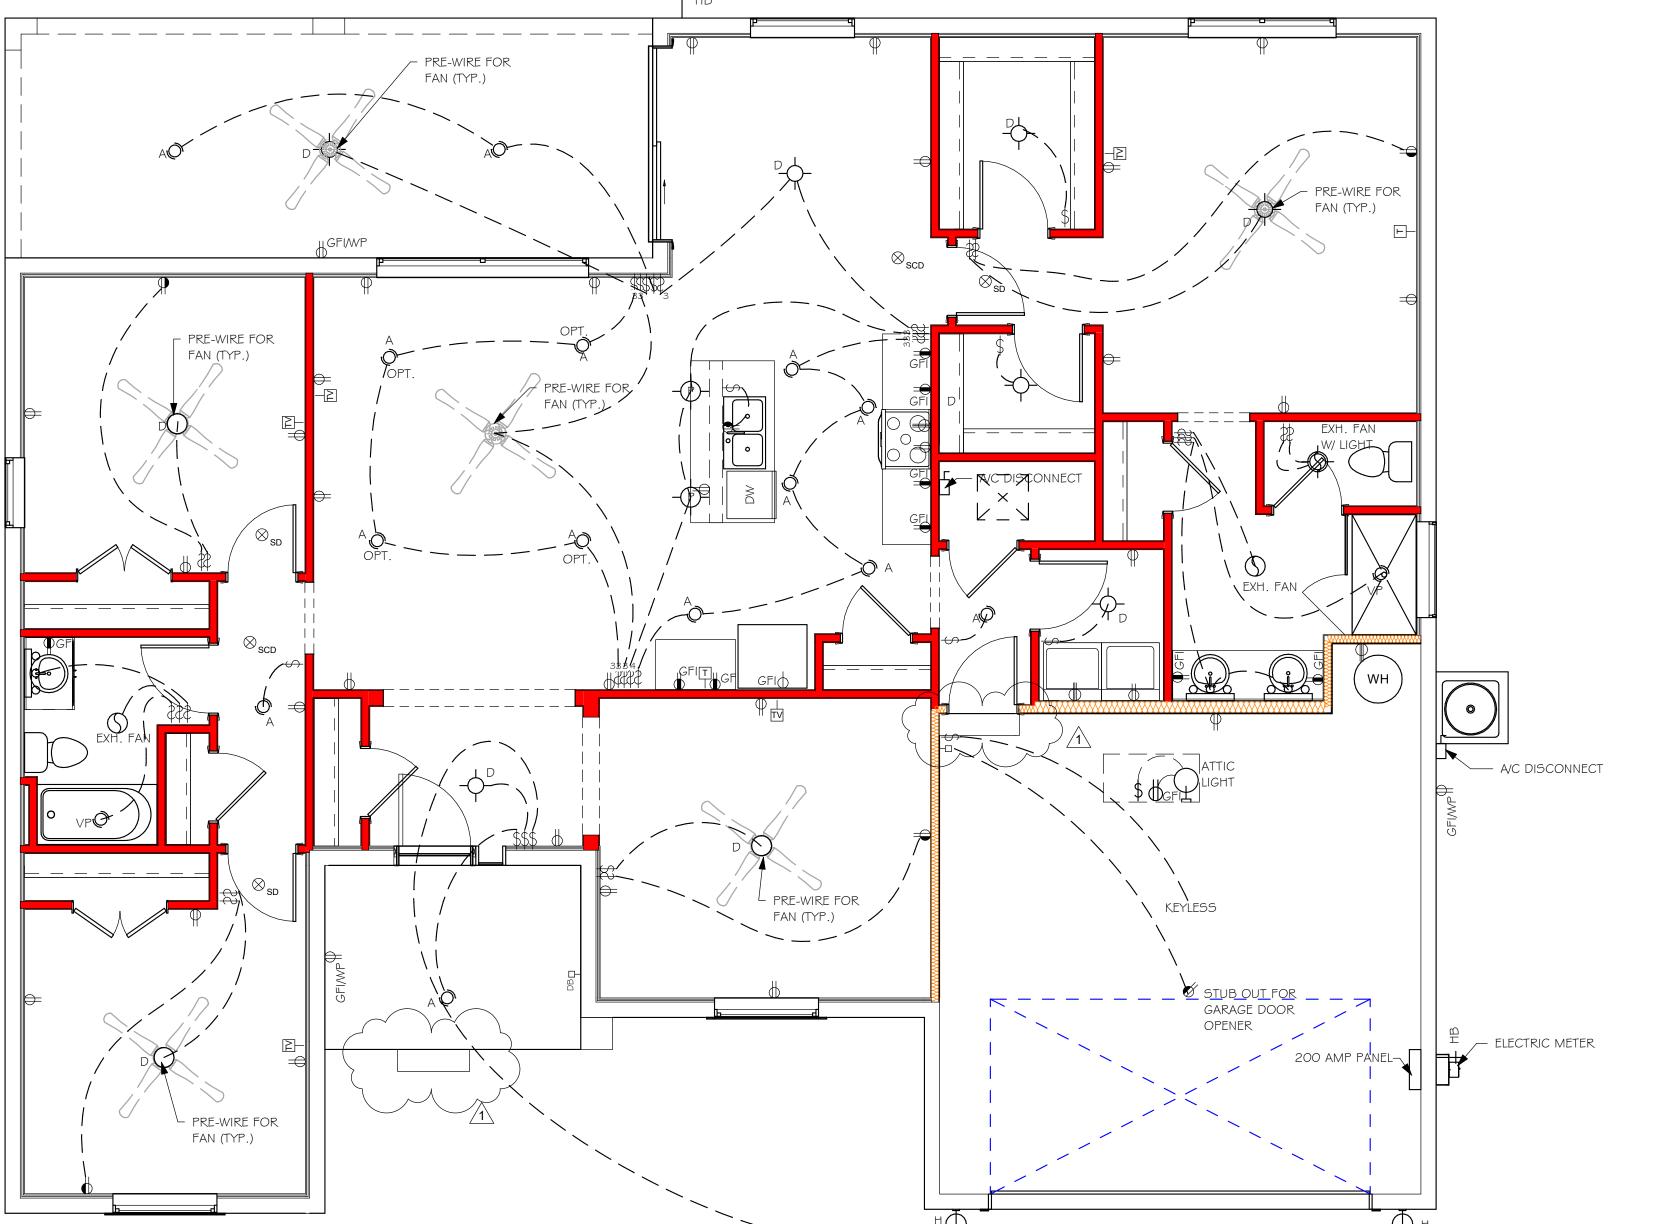

ELECTRICAL PLAN "AR" 1/4" = 1'-0"

No.	Description	Date
1	REVISED FROM MONOLITHIC	08/25/19
	FOUNDATION TO STEMWALL	
	FOUNDATION.	

	As indicated
CE WITH THE RESIDENTIAL DE 2017 - GTH EDITION	A-5 AR

MODEL

DATE:

DRAWN BY:

CHECKED BY:

REVISED:

PLAN:


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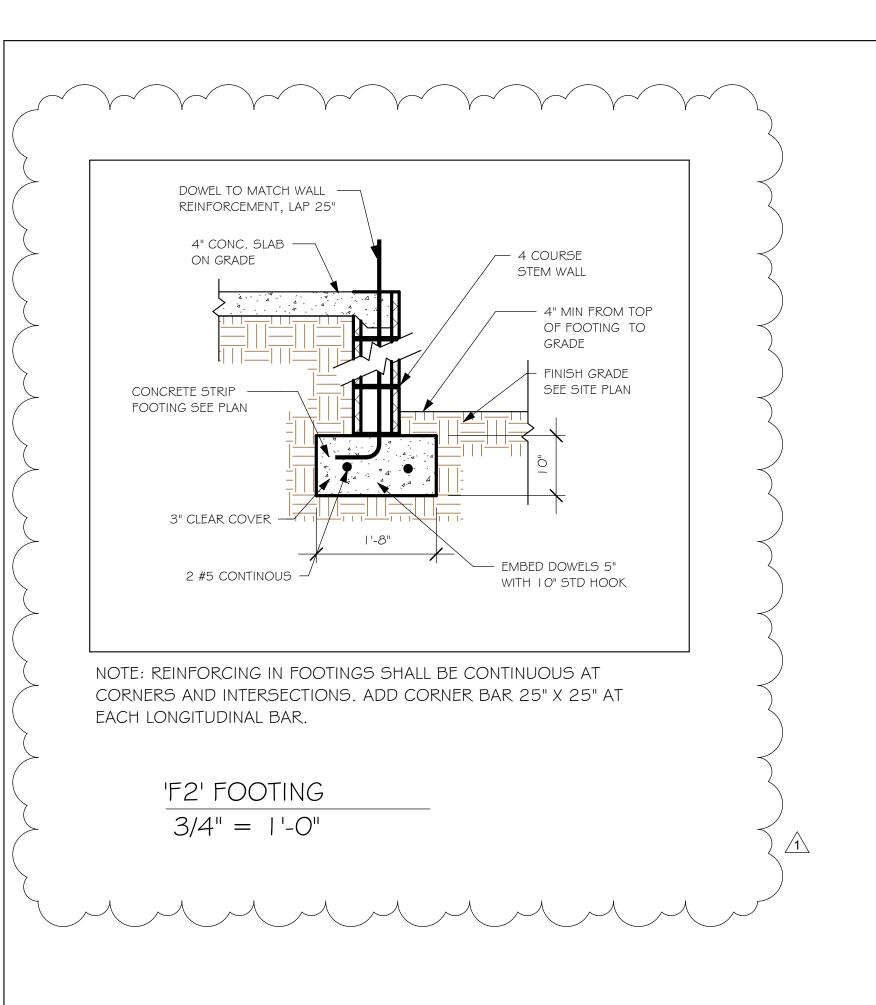
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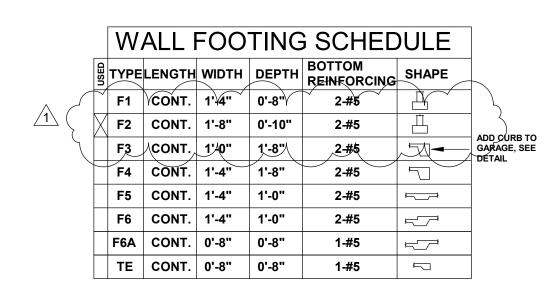
JWC

08/25/19

ELECTRICAL





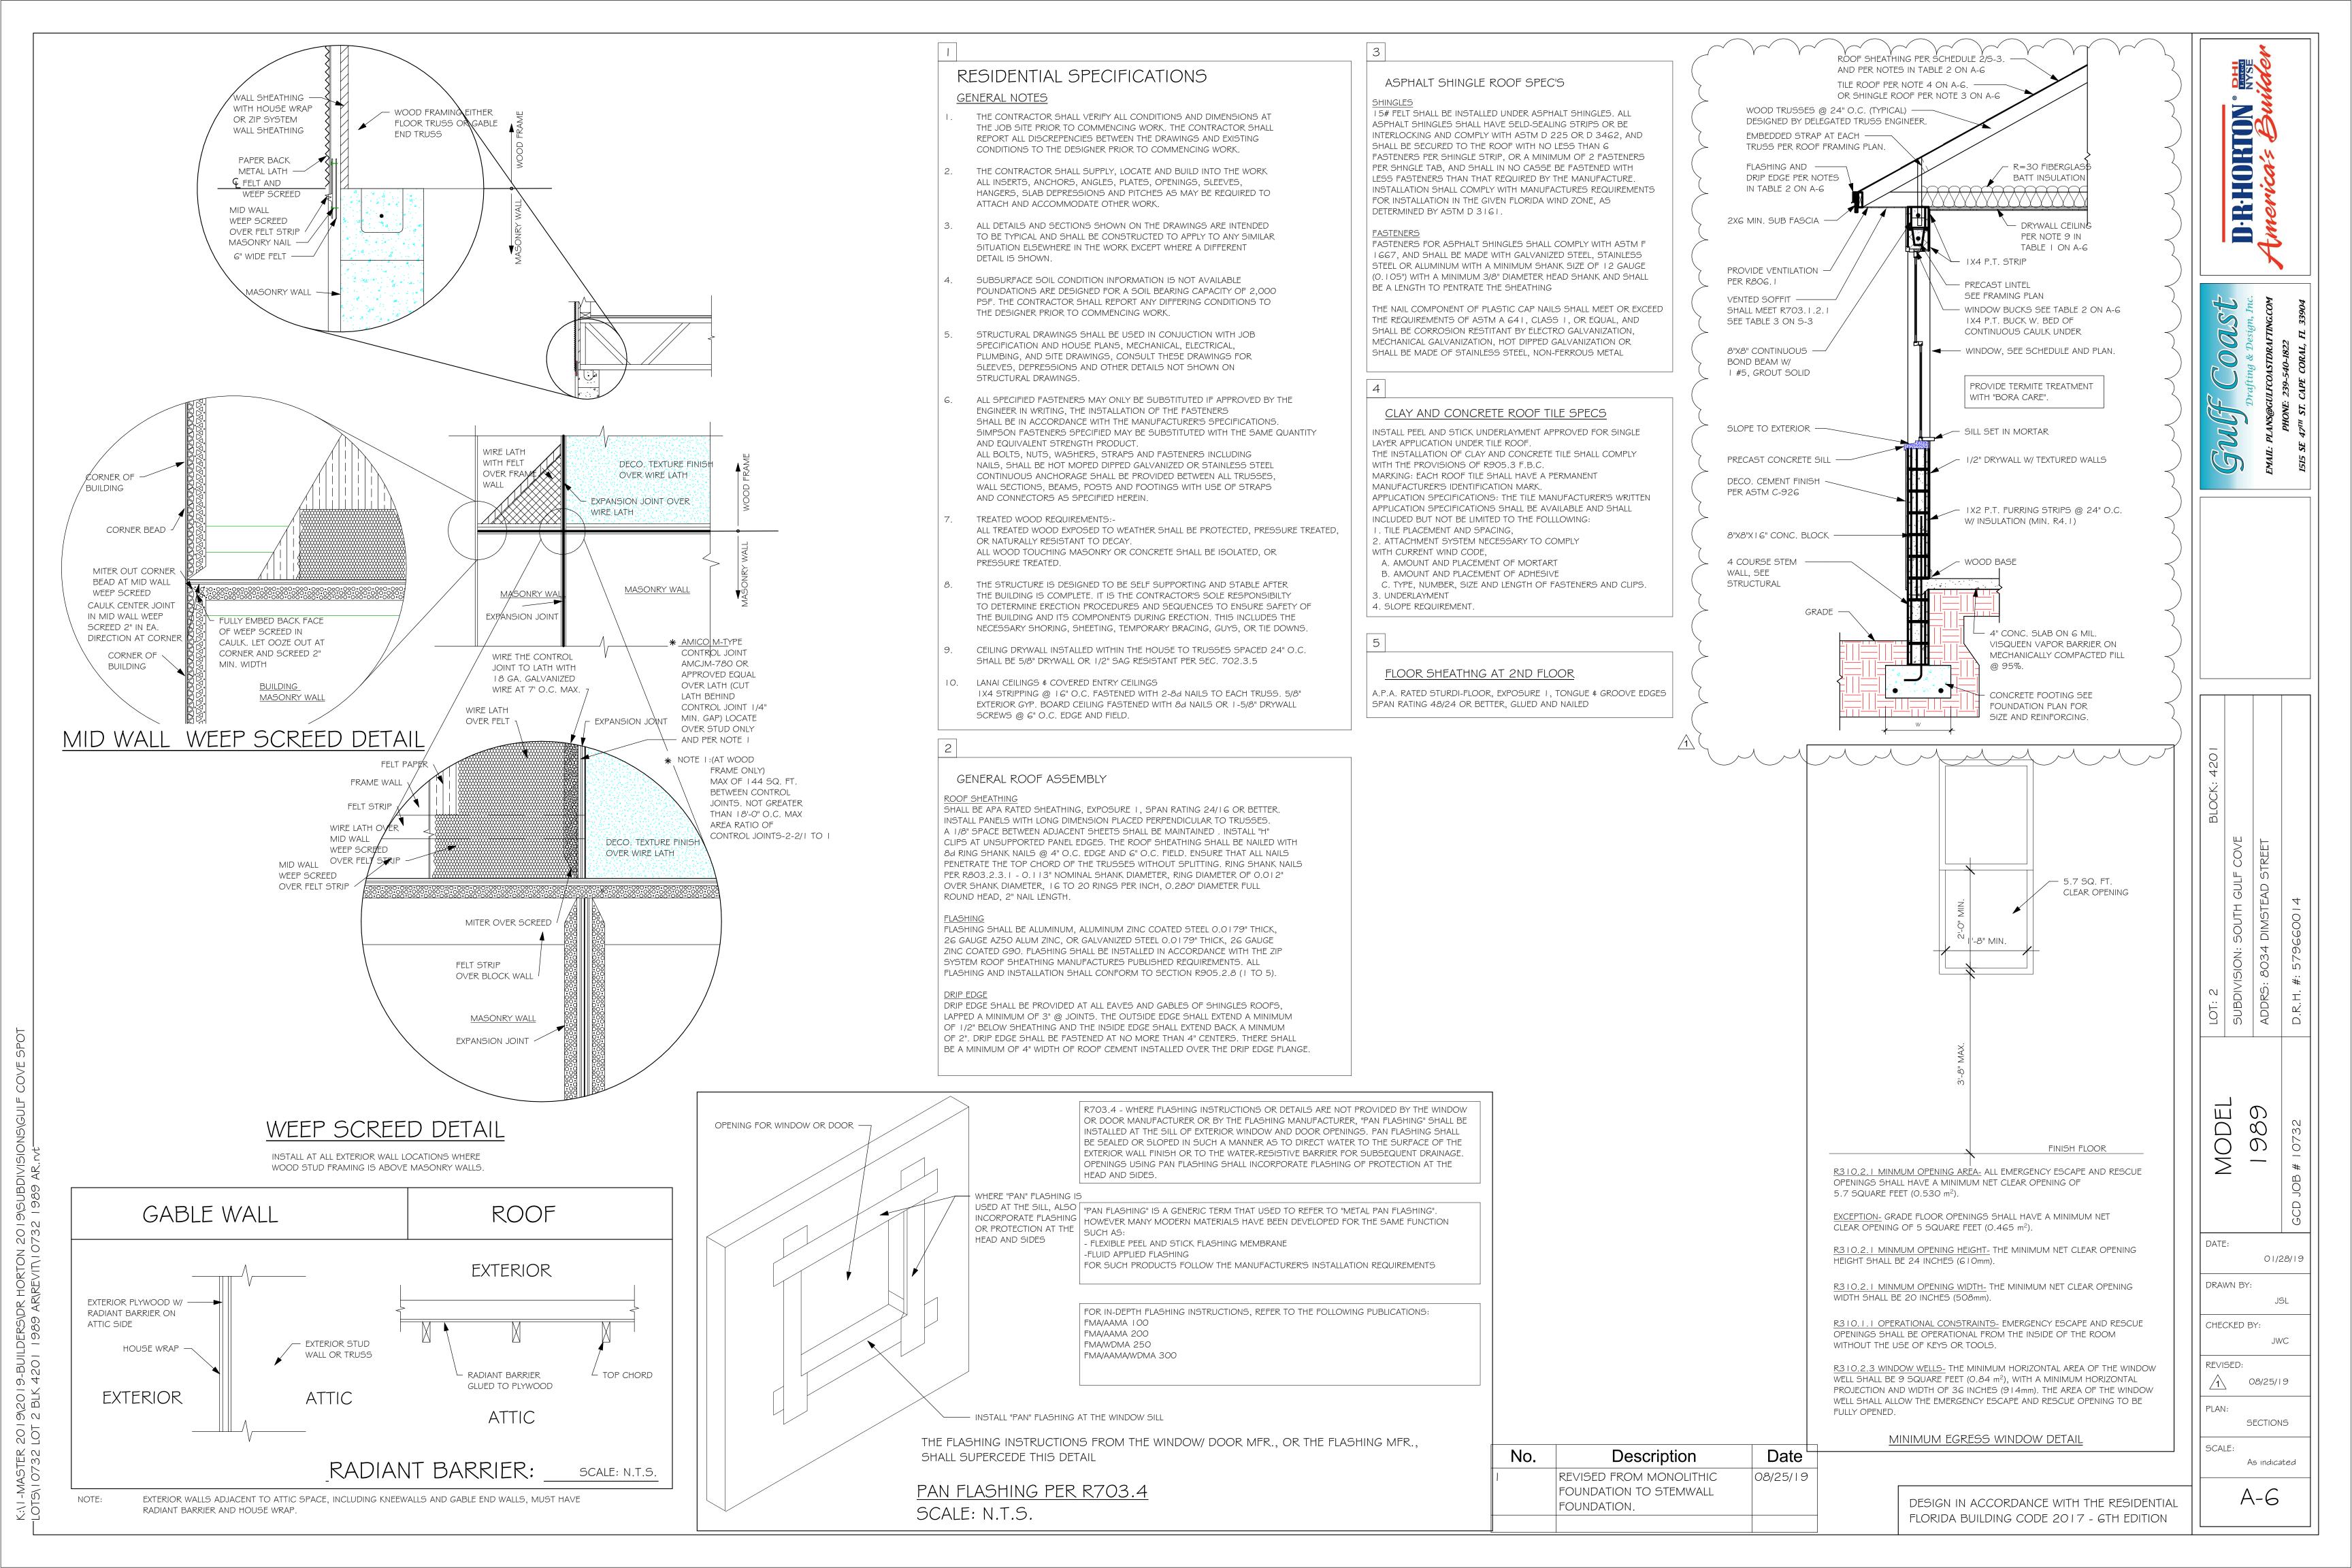

PROVIDE CORNER BARS
IN FOOTING PER 6/S-3


	PAD FOOTING SCHEDULE						
B	TVDE	LENGTH	MIDTH	DEDTII	вотт	OM REINF.	DEMARKS
USED	ITPE	LENGTH	WIDIH	DEPTH	LONG WAY	SHORT WAY	REMARKS
X	<b>(A</b> )	2'-6"	2'-6"	1'-0"	3-#5	3-#5	-
	$\langle \mathbf{B} \rangle$	3'-0"	3'-0"	1'-0"	4-#5	4-#5	-
	<b>(C</b> )	3'-6"	3'-6"	1'-0"	4-#5	4-#5	-
	(D)	4'-0"	4'-0"	1'-2"	5-#5	5-#5	-
	⟨ <b>E</b> ⟩	5'-0"	5'-0"	1'-2"	6-#5	6-#5	-

# **FOUNDATION PLAN**


#### SCALE: 1/4" = 1'-0"

PLAN NOTES:
1. TOP OF GROUND FLOOR SLAB DATUM ELEVATION 0'-0"

- "F#" DENOTES CONTINUOUS WALL FOOTING TYPE PER SCHEDULE THIS SHEET.
- PROVIDE #5 VERTICAL REINFORCING AT DOT LOCATIONS SHOWN ON PLAN FROM FOOTING TO BOND BEAM.
- ALL DIMENSIONS ARE TO OUTSIDE FACE OF MASONRY WALLS. SOME SLAB EDGES MAY EXTEND BEYOND FACE OF WALL.
- FOR DIMENSIONS OF ROUGH OPENINGS IN MASONRY WALLS, COORDINATE WITH WINDOW/DOOR SUPPLIER.
- 6. PROVIDE PRESSURE TREATED BUCKS AT WINDOWS/ DOORS PER DETAIL 7/S-3.

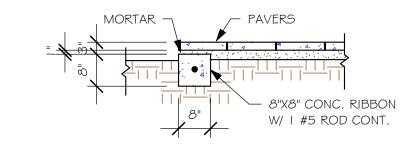

 $\frac{\text{"P" PAVERS DETAIL}}{1/2\text{"} = 1\text{'-0"}}$ 

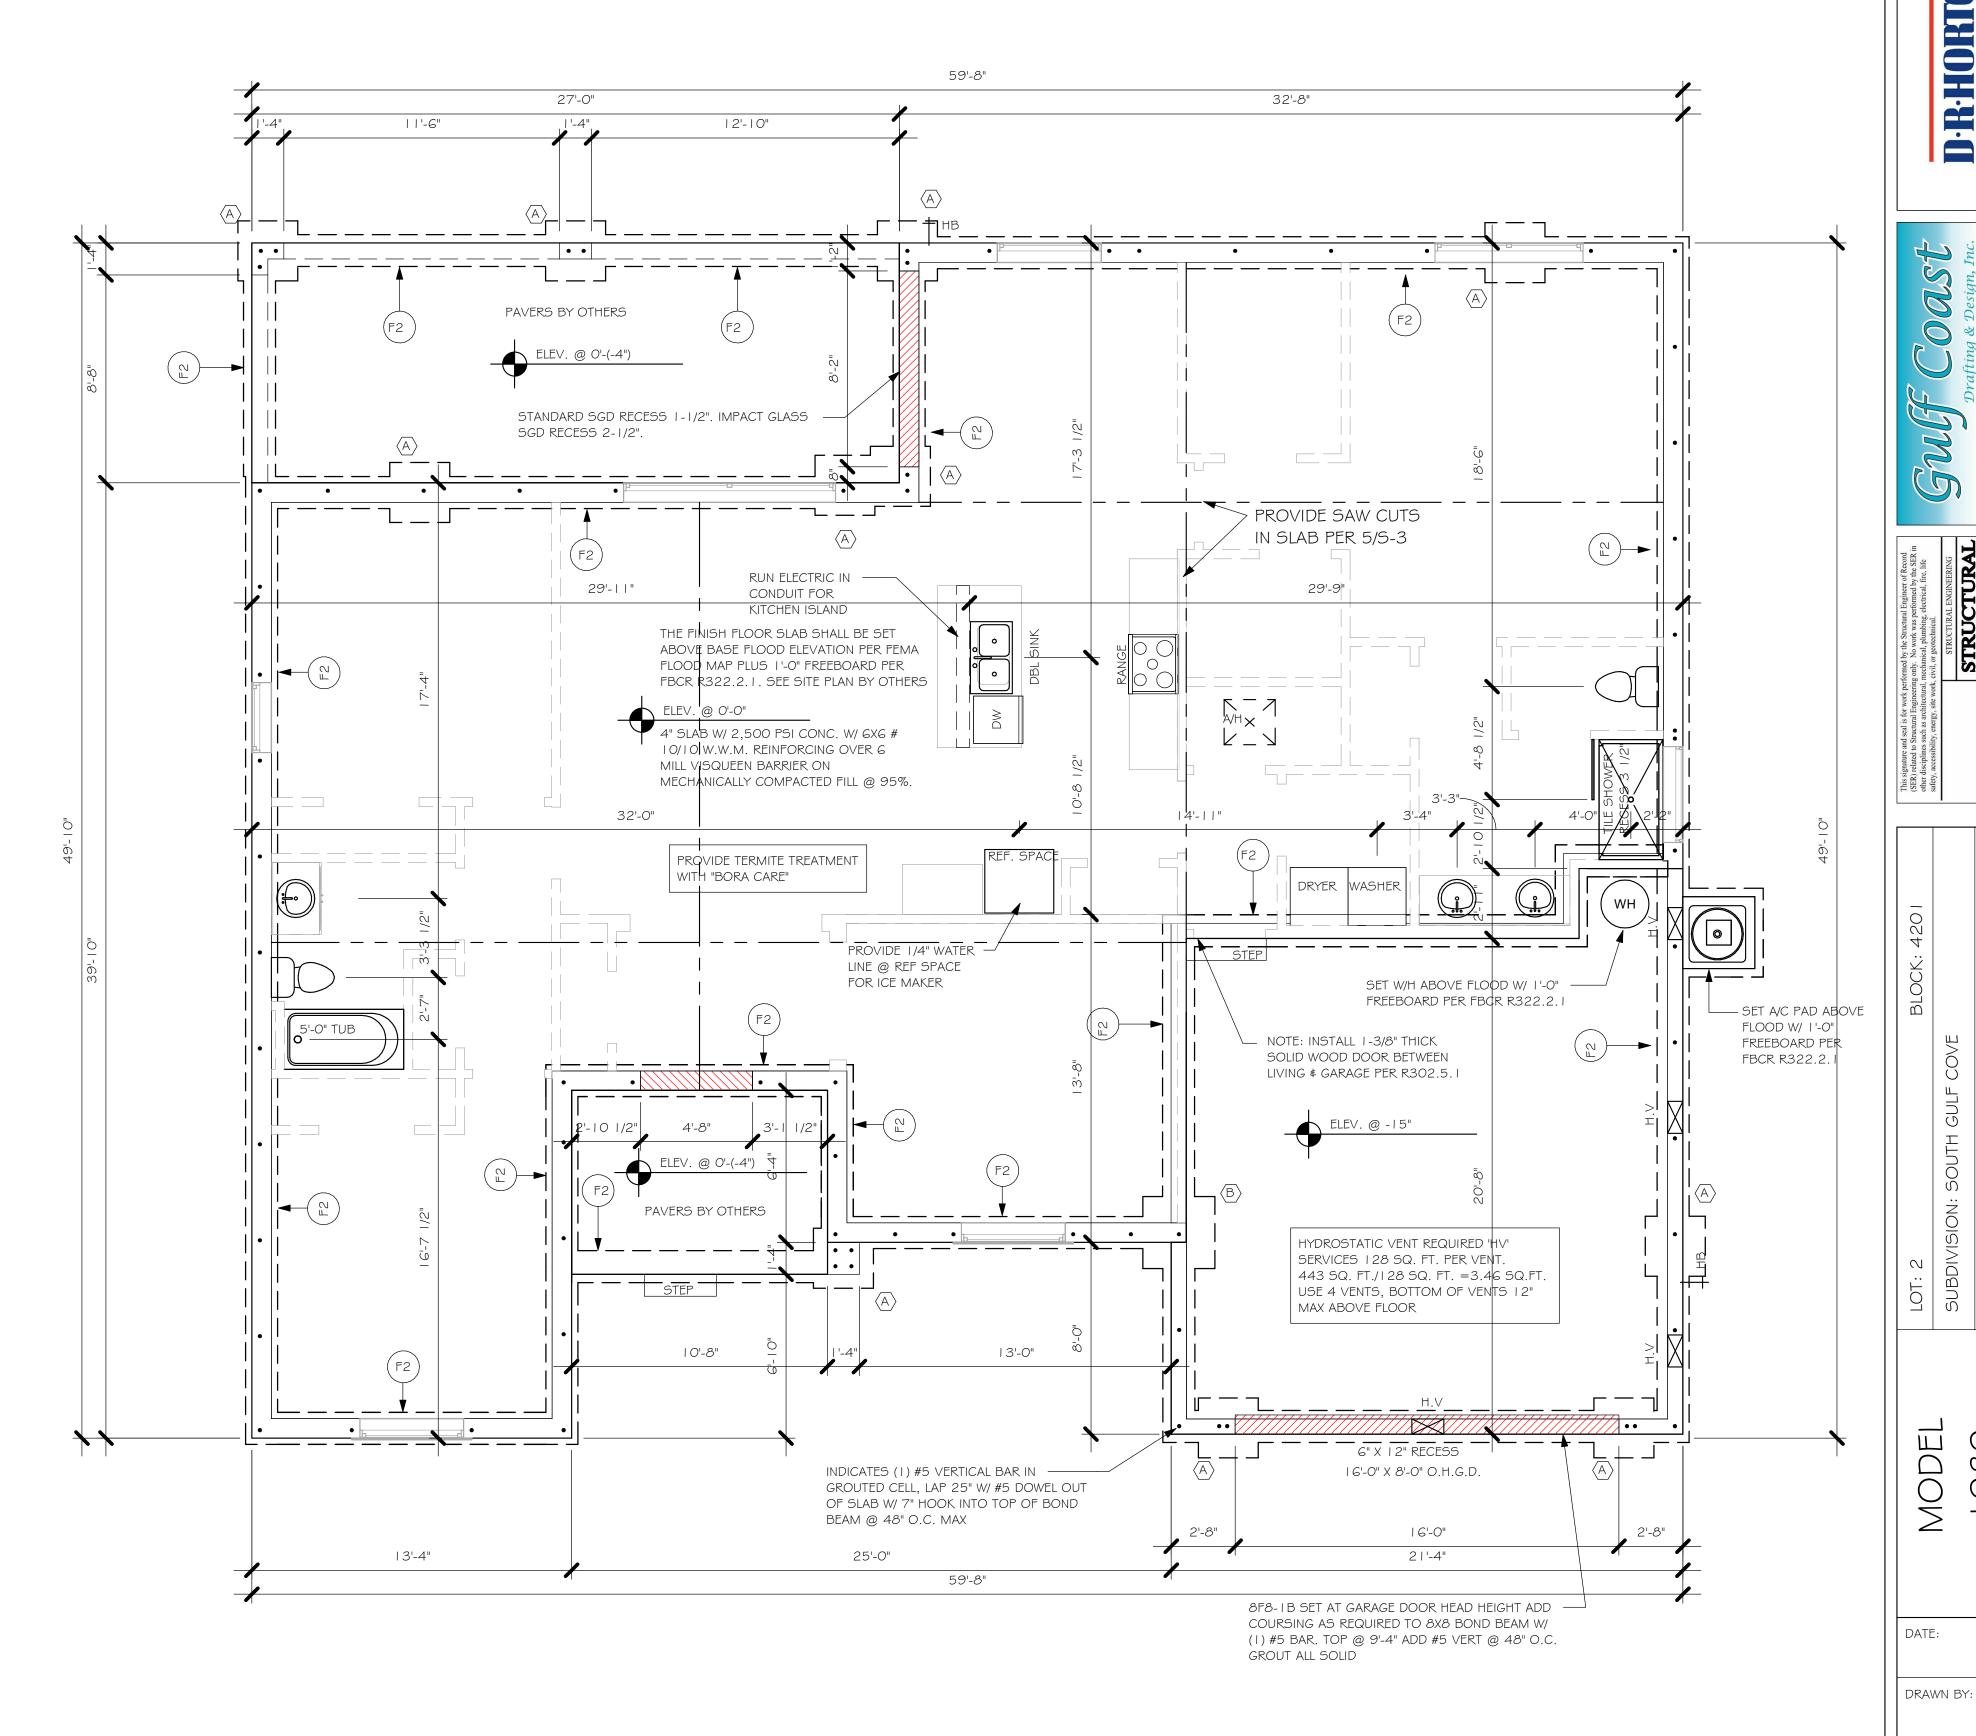

 $\frac{\text{FOUNDATION PLAN "AR"}}{1/4" = 1'-0"}$ 

No.	Description	Date
	REVISED FROM MONOLITHIC FOUNDATION TO STEMWALL FOUNDATION.	08/25/19

DESIGN IN ACCORDANCE WITH THE RESIDENTIAL FLORIDA BUILDING CODE 2017 - 6TH EDITION

98

01/28/19

JWC

08/25/19

FOUNDATION PLAN

CHECKED BY:

REVISED:

PLAN:


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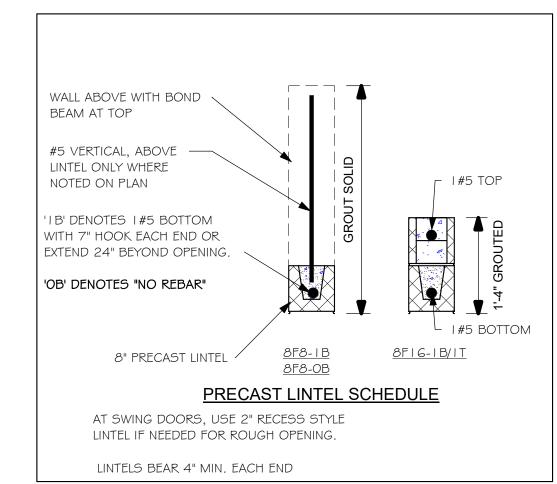
TRUSS STRAPPING TO	D MASONRY	
MAX TRUSS UPLIFT @ 24" OC (LBS)	CONNECTOR	FASTENER
1615 1870 2430 (1 PLY) 2800 (2 PLY) 3170 (2 PLY) 5005	(1) HTA16-18 (1) HTA20 (2)HTA16- 18 (2)HTA16 -18 (2) HTA20 HTT45	10-10dx   /2", EMBED 4   5/8"ø ATR, EPOXY   2"

- PROVIDE A STRAP FROM THE ABOVE LIST AT EACH ROOF TRUSS BEARING POINT, BASED ON THE TRUSS UPLIFT VALUES IN THE SIGNED AND SEALED TRUSS DESIGN PACKAGE AND SUITABLE FOR THE GEOMETRY. EMBED STRAP ON -C/L OF WALL. CONNECTORS ARE USP STRUCTURAL CONNECTORS. ALL CONNECTORS
- SHALL BE INSTALLED IN STRICT ACCORDANCE WITH USP PRINTED INSTUCTIONS. SUBSTITUTIONS MUST BE APPROVED IN WRITING BY THE
- ENGINEER OF RECORD. WHERE EMBEDDED STRAPS ARE MISSING, OR MIS-LOCATED, INSTALL RETROFIT STRAP PER 2/S-4.
- 'ATR' = ALLTHREAD. DRILL AND EPOXY WITH USP EPOXY PER MFR. INSTRUCTIONS.

INSTALL AT ALL	TRUSS STRAPPING TO	O STUDWALL/ WOOD BE	AM
TRUSSES TO 1 005 Ib UPLIFT.	MAX TRUSS UPLIFT @ 24" OC (LBS)	CONNECTOR	FASTENER
FOR HIGHER UPLIFTS, SEE NOTES ON PLAN.	1005 2010 3015 1285 2570 3855 5140	(1)MTW16 (2) MTW16 (3) MTW16 (1) HTW20 (2) HTW20 (3) HTW20 (4) HTW20	2-  OdX   ~   /2"   12-  OdX   ~   /2"   12-  OdX   ~   /2"   24-  OdX   ~   /2"   24-  OdX   ~   /2"   24-  OdX   ~   /2"   24-  OdX   ~   /2"

- I. PROVIDE A STRAP FROM THE ABOVE LIST AT EACH ROOF TRUSS BEARING POINT, BASED ON THE TRUSS UPLIFT VALUES IN THE SIGNED AND SEALED TRUSS DESIGN PACKAGE.
- CONNECTORS ARE USP STRUCTURAL CONNECTORS. ALL CONNECTORS SHALL BE INSTALLED IN STRICT ACCORDANCE WITH USP PRINTED




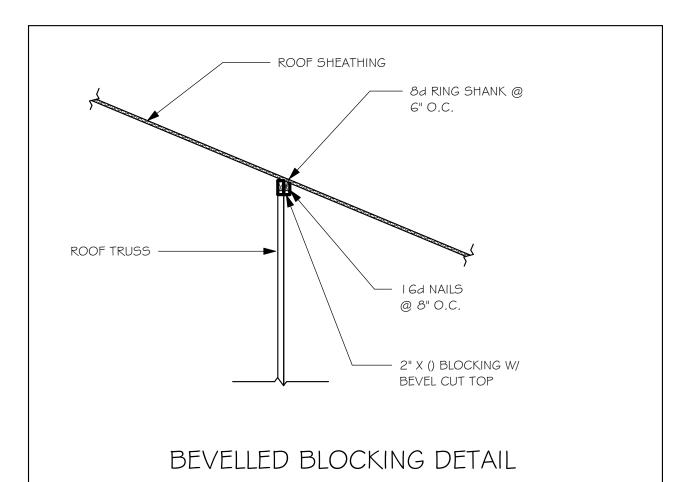

### PLAN NOTES:

- ROOF TRUSS BEARING ELEVATION VARIES, SEE
- ROOF FRAMING SHALL BE WOOD TRUSSES DESIGNED BYA DELEGATED TRUSS ENGINEER PER DESIGN
- CRITERIA ON SHEET S-3. PROVIDE STRAPPING AT TRUSSES PER NOTES ON THIS
- FOR NAILING OF ROOF, SEE I AND 2 ON S-3. 8F8-1B etc., DENOTES PRECAST LINTEL ABOVE
- DOOR/WINDOW OPENING PER SCHEDULE THIS SHEET. AT TRUSS BEARING, PROVIDE 8x8 MASONRY BOND
- BEAM W/ | #5 CONTINUOUS, SEE DETAIL | 1/S-3.

PREPARED BY SCOSTA JOB# 44113 DATED: 08/06/18 REVISED: 11/15/18

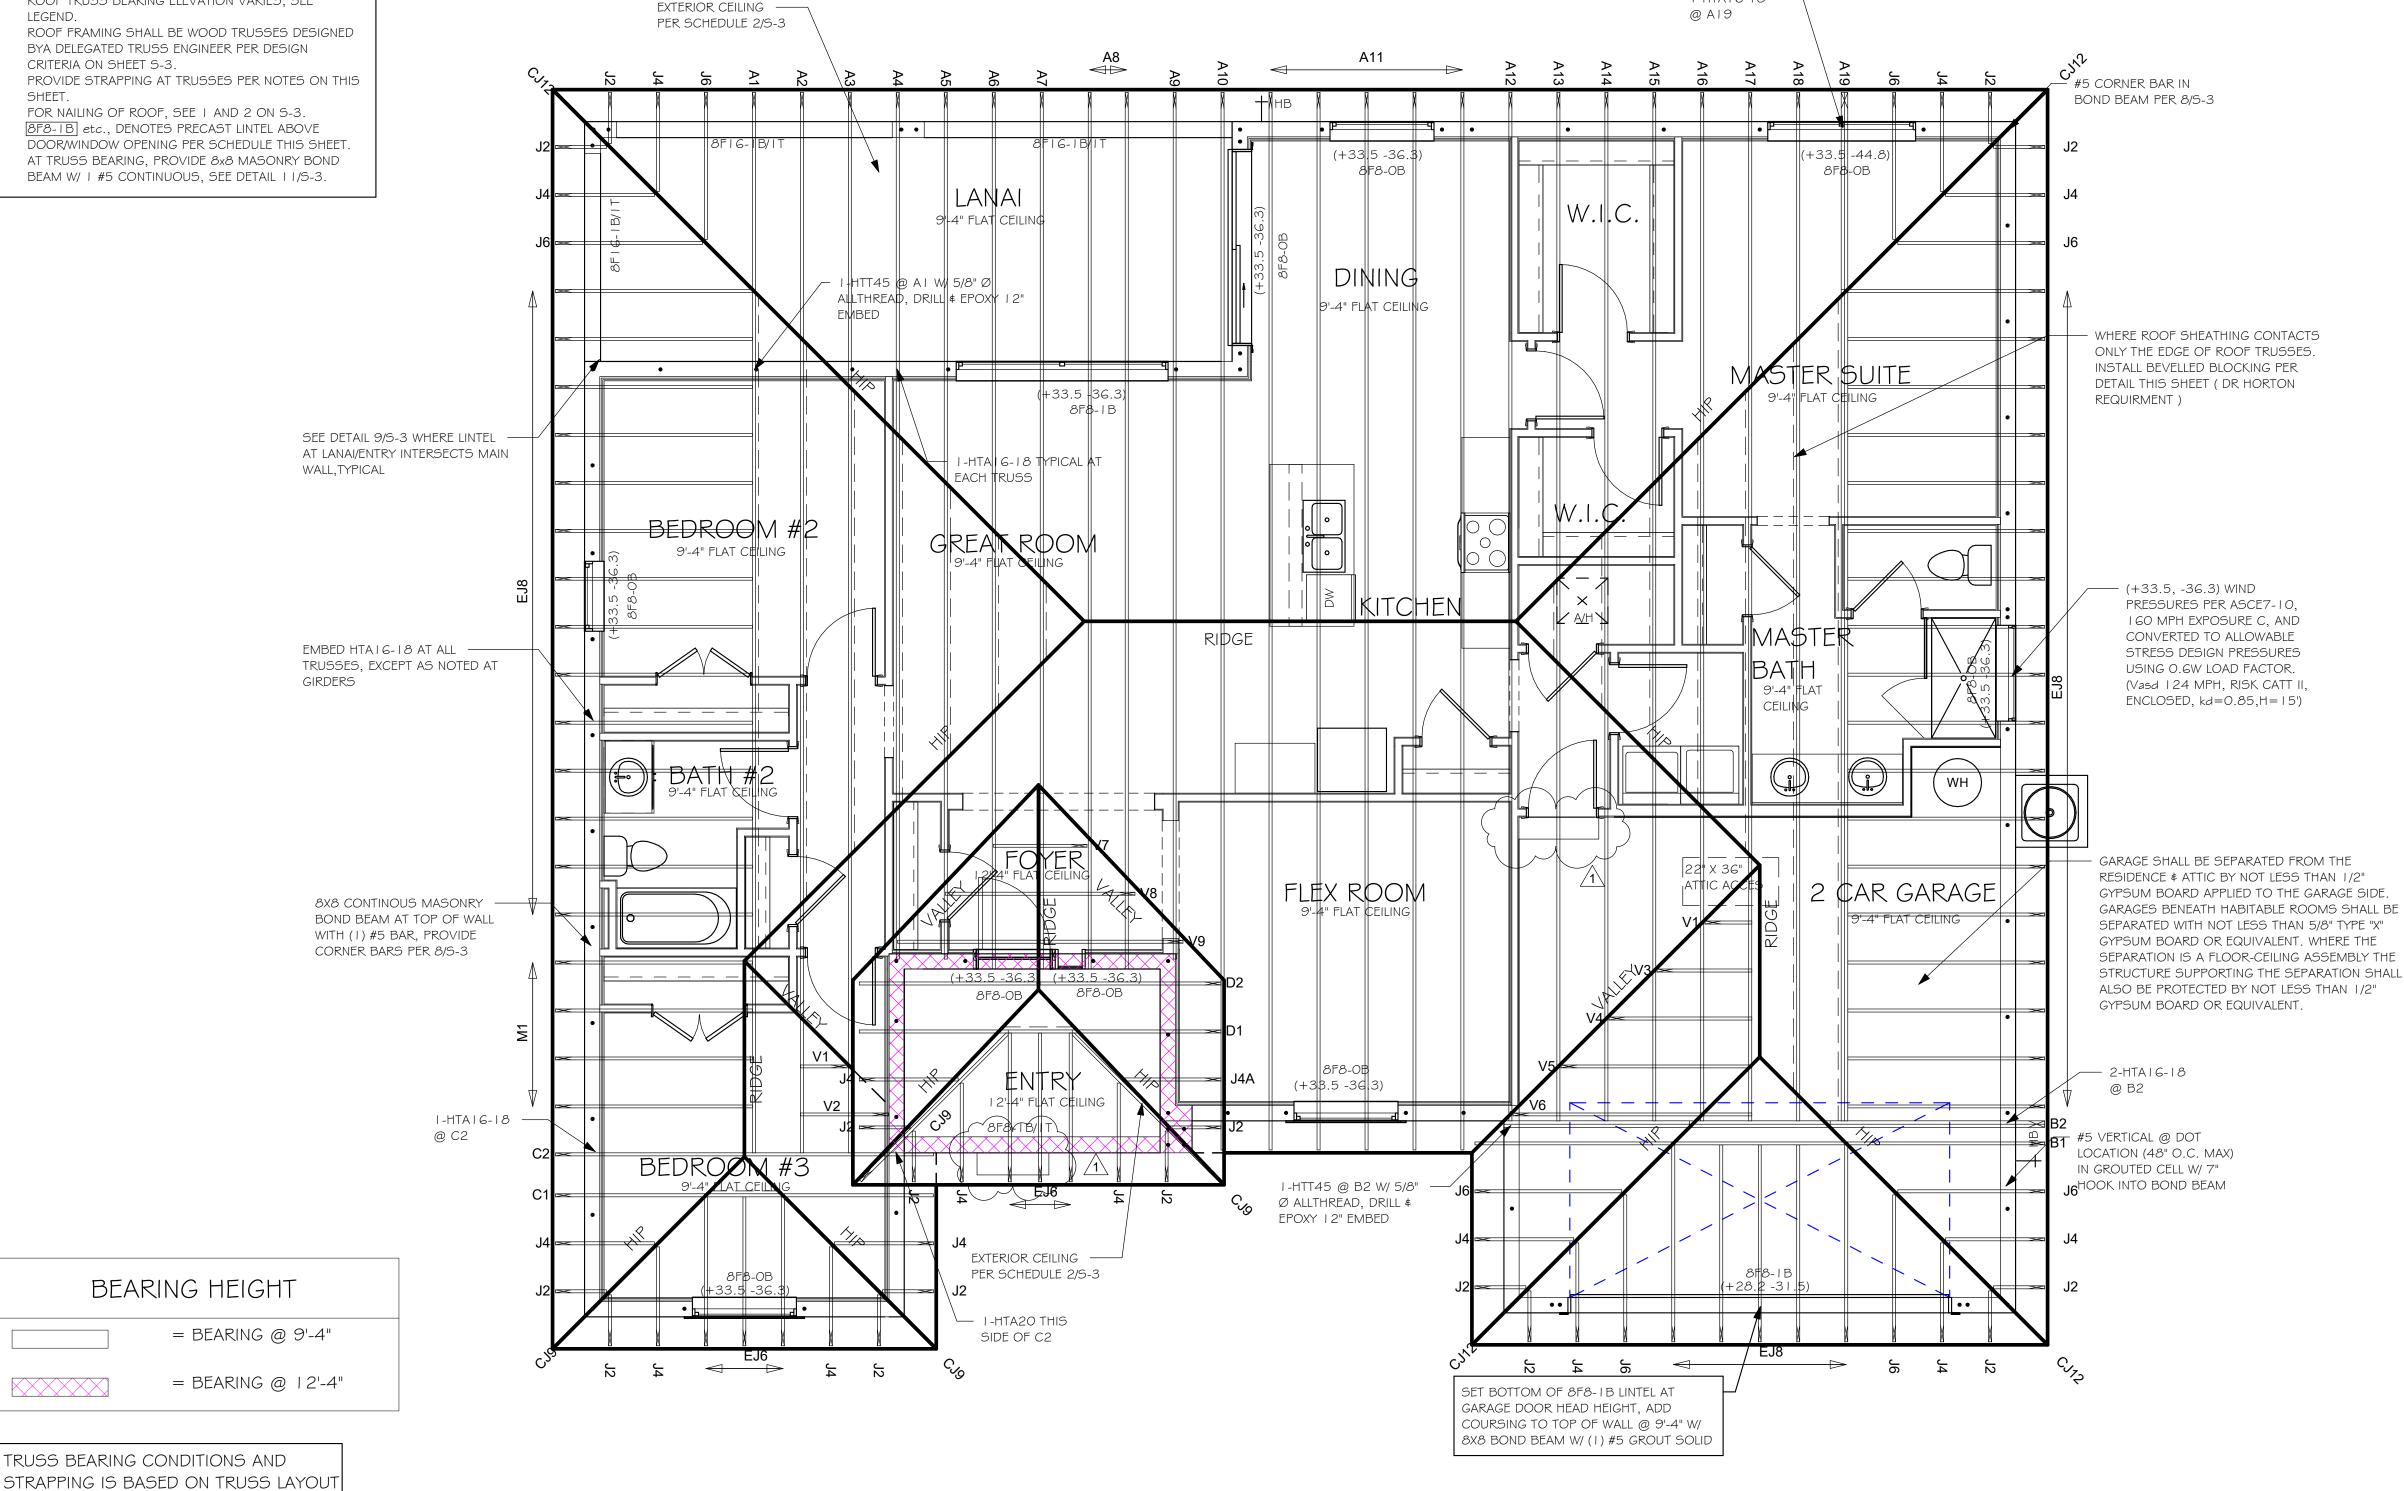

ROOF FRAMING PLAN "AR" 1/4" = 1'-0"

No.	Description	Date
	REVISED FROM MONOLITHIC	08/25/19
	FOUNDATION TO STEMWALL	
	FOUNDATION.	

I-HTA16-18 ---

DESIGN IN ACCORDANCE WITH THE RESIDENTIAL FLORIDA BUILDING CODE 2017 - 6TH EDITION

STRUCTURAL SYSTEMS OF NORTH FLORIDA 1634 SE, 47th ST SUITE #3 CAPE CIRAL, FL 33904 (239) 549-4554

VISION: SOUTH GULF COVE

MODEL 989


DATE: 01/28/19 DRAWN BY:

CHECKED BY: JWC

REVISED: 08/25/19 PLAN:

ROOF FRAMING PLAN SCALE: As indicated

S-2 AR

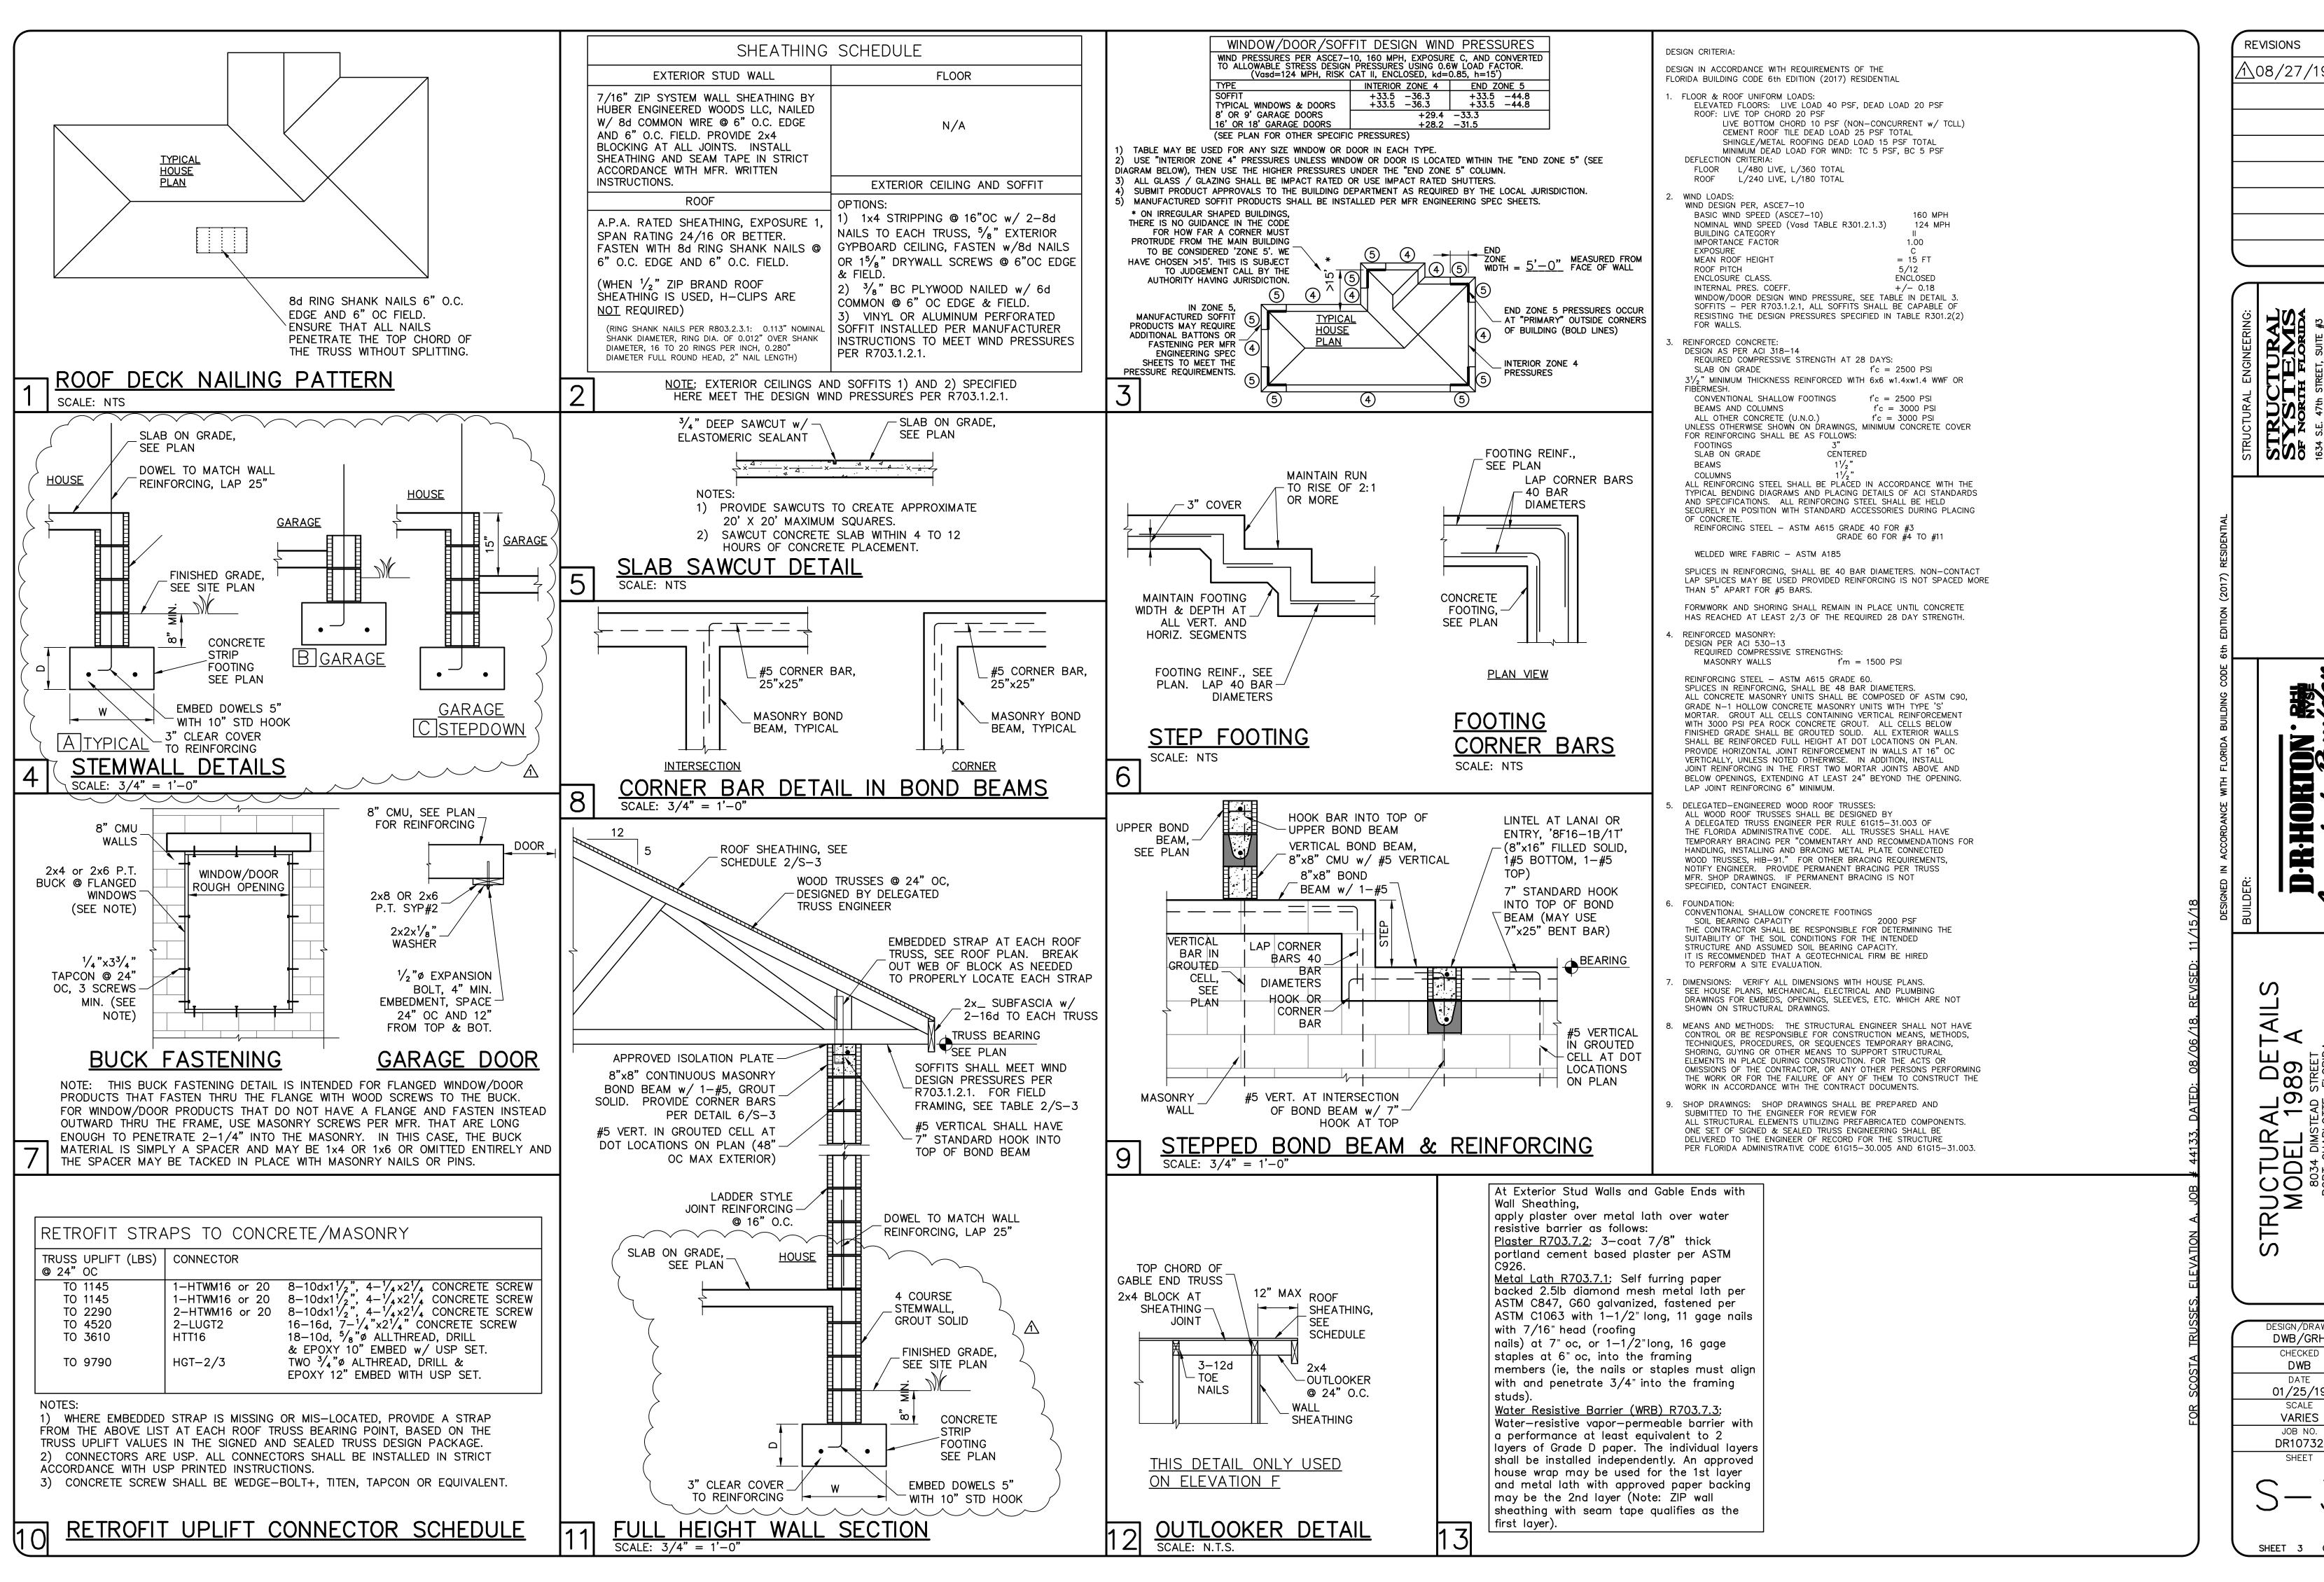

REVISIONS <u>1</u>08/27/19 DWB

STRUS SYSSI OF NOR1 1634 S.E. 47th CAPE COR. (239) E

ORTON -R-H

DE 39  $\infty$ 198 10 E 

DWB/GRH CHECKED DWB 01/25/19 SCALE **VARIES**