

1	16080 OHGD	16'-0"	8'-0"	
2	3080 ENTRY	3'-0"	8'-0"	
3	2-4080 SL. GL. DR.	8'-0"	8'-0"	I

WINDOW SCHEDULE							
MARK	DESCRIPTION	MANUFACTURER	HEIGHT	WIDTH	COMMENTS	QTY	
	0 05 011			C1			

А	2-25 SH		5'-1"	6'-2"	1
В	2-26 SH		6'-2"	6'-2"	1
С	48" X 16"	FIXED GLASS	1'-4"	4'-0"	1
D	25 SH		5'-1"	2'-11"	3
E	2-35 SH		5'-1"	8'-10"	3

OPT IMPACT GLASS MAY BE INSTALLED IN LIEU OF SHUTTERS VERIFY W/ CONTRACT

INTERIOR DOOR SCHEDULE					
MARK	DOOR WIDTH	NOTES			
	3'-0"	P.K. = POCKET DOOR			
2	2'-10"	B.F. = BI-FOLD DOOR			
3	2'-8"	D.I .			
4	2'-6"	B.P. = BI-PASS DOOR			
5	2'-4"	L.V. = LOUVERED DOOR			
6	2'-0"				
7	1'-8"				
8	1'-6"				

FACE OF STUD TO FACE OF STUD

ACE OF OUTSIDE WALL TO FACE OF STUD WALL $[\ \]$

D	OOR HEADE	RS
6'-8" BI-FOLD	HEADER HEIGHT	82" A.F.F.
6'-8" SWING	HEADER HEIGHT	82 I/2" A.F.F.
8'-0" SWING	HEADER HEIGHT	98 I/2" A.F.F.

PLAN NOTES

- VERIFY ALL ROUGH OPENING DIMENSIONS FOR ALL WINDOWS AND DOORS
- 2) PROVIDE SAFETY GLAZING WITHIN 24" FROM EXIT PER FLORIDA BUILDING CODE R 308.4.2.
- 3) PROVIDE SAFETY GLAZING AT BATH/ SHOWER PER FLORIDA BUILDING CODE R 308.4.5.
- 4) NON BEARING INTERIOR FRAME WALLS SHALL BE FRAMED W/ WOOD OR METAL STUDS. SPACING SHALL NOT EXCEED 24" O.C. (NON BEARING WALLS ONLY)
- 5) PROVIDE DEAD WOOD IN ATTIC FOR OVERHEAD GARAGE DOOR HARDWARE
- 6) KITCHEN KNEE WALL TO BE FRAMED W/ TOP @ 34 1/2" A.F.F.
- 7) INSTALL SMOOTH WALLS IN KITCHEN AND ALL BATHROOM AREAS


 8) WHERE DRYWALL CEILING IS APPLIED TO TRUSSES
- PRESISTANT PER SEC. 702.3.5

 THE GARAGE SHALL BE SEPARATED FROM THE RESIDENCE & ATTIC BY NOT LESS THEN 1/2" GYPSUM BOARD APPLIED TO THE GARAGE SIDE. GARAGES BENEATH HABITABLE ROOMS SHALL BE SEPARATED WITH NOT LESS THAN 5/8" TYPE "X" GYPSUM BOARD OR EQUIVALENT. WHERE THE SEPARATION IS A

@ 24" O.C. USE 5/8" DRYWALL OR 1/2" SAG

- BENEATH HABITABLE ROOMS SHALL BE SEPARATED WITH NOT LESS THAN 5/8" TYPE "X" GYPSUM BOARD OR EQUIVALENT. WHERE THE SEPARATIION IS A FLOOR CEILING ASSEMBLY, THE STRUCTURE SUPPORTING THE SEPARTION SHALL ALSO BE PROTECTED BY NOT LESS THAN 1/2" GYPSOM BOARD OR EQUIVALENT
- 10) INSTALL 1 3/8" THICK SOLID WOOD DOOR BETWEEN LIVING AND GARAGE PER FLORIDA BUILDING CODE R302.1.5.
- II) ALL WINDOWS INSTALLED 72" ABOVE GRADE MUST COMPLY WITH R612.2 MIN 24" SILL HEIGHT OR PROVIDED WITH AN APPROVED WINDOW FALL PRVENTION DEVICE
- 12) ALL CLOSET SHELVES TO BE 12". ALL PANTRY \$
 LINEN TO BE (4)-16" SHELVES 18" O.F.F. W/ 15"
 INCREMENT.

CABINET BACKING					
KITCHEN	UPPER TOP @ 84"	BASE TOP @ 35"			
MASTER BATH	UPPER	BASE TOP @ 35"			
GUEST BATH	UPPER	BASE TOP @ 31"			
LAUNDRY ROOM	UPPER TOP @ 84"	BASE			

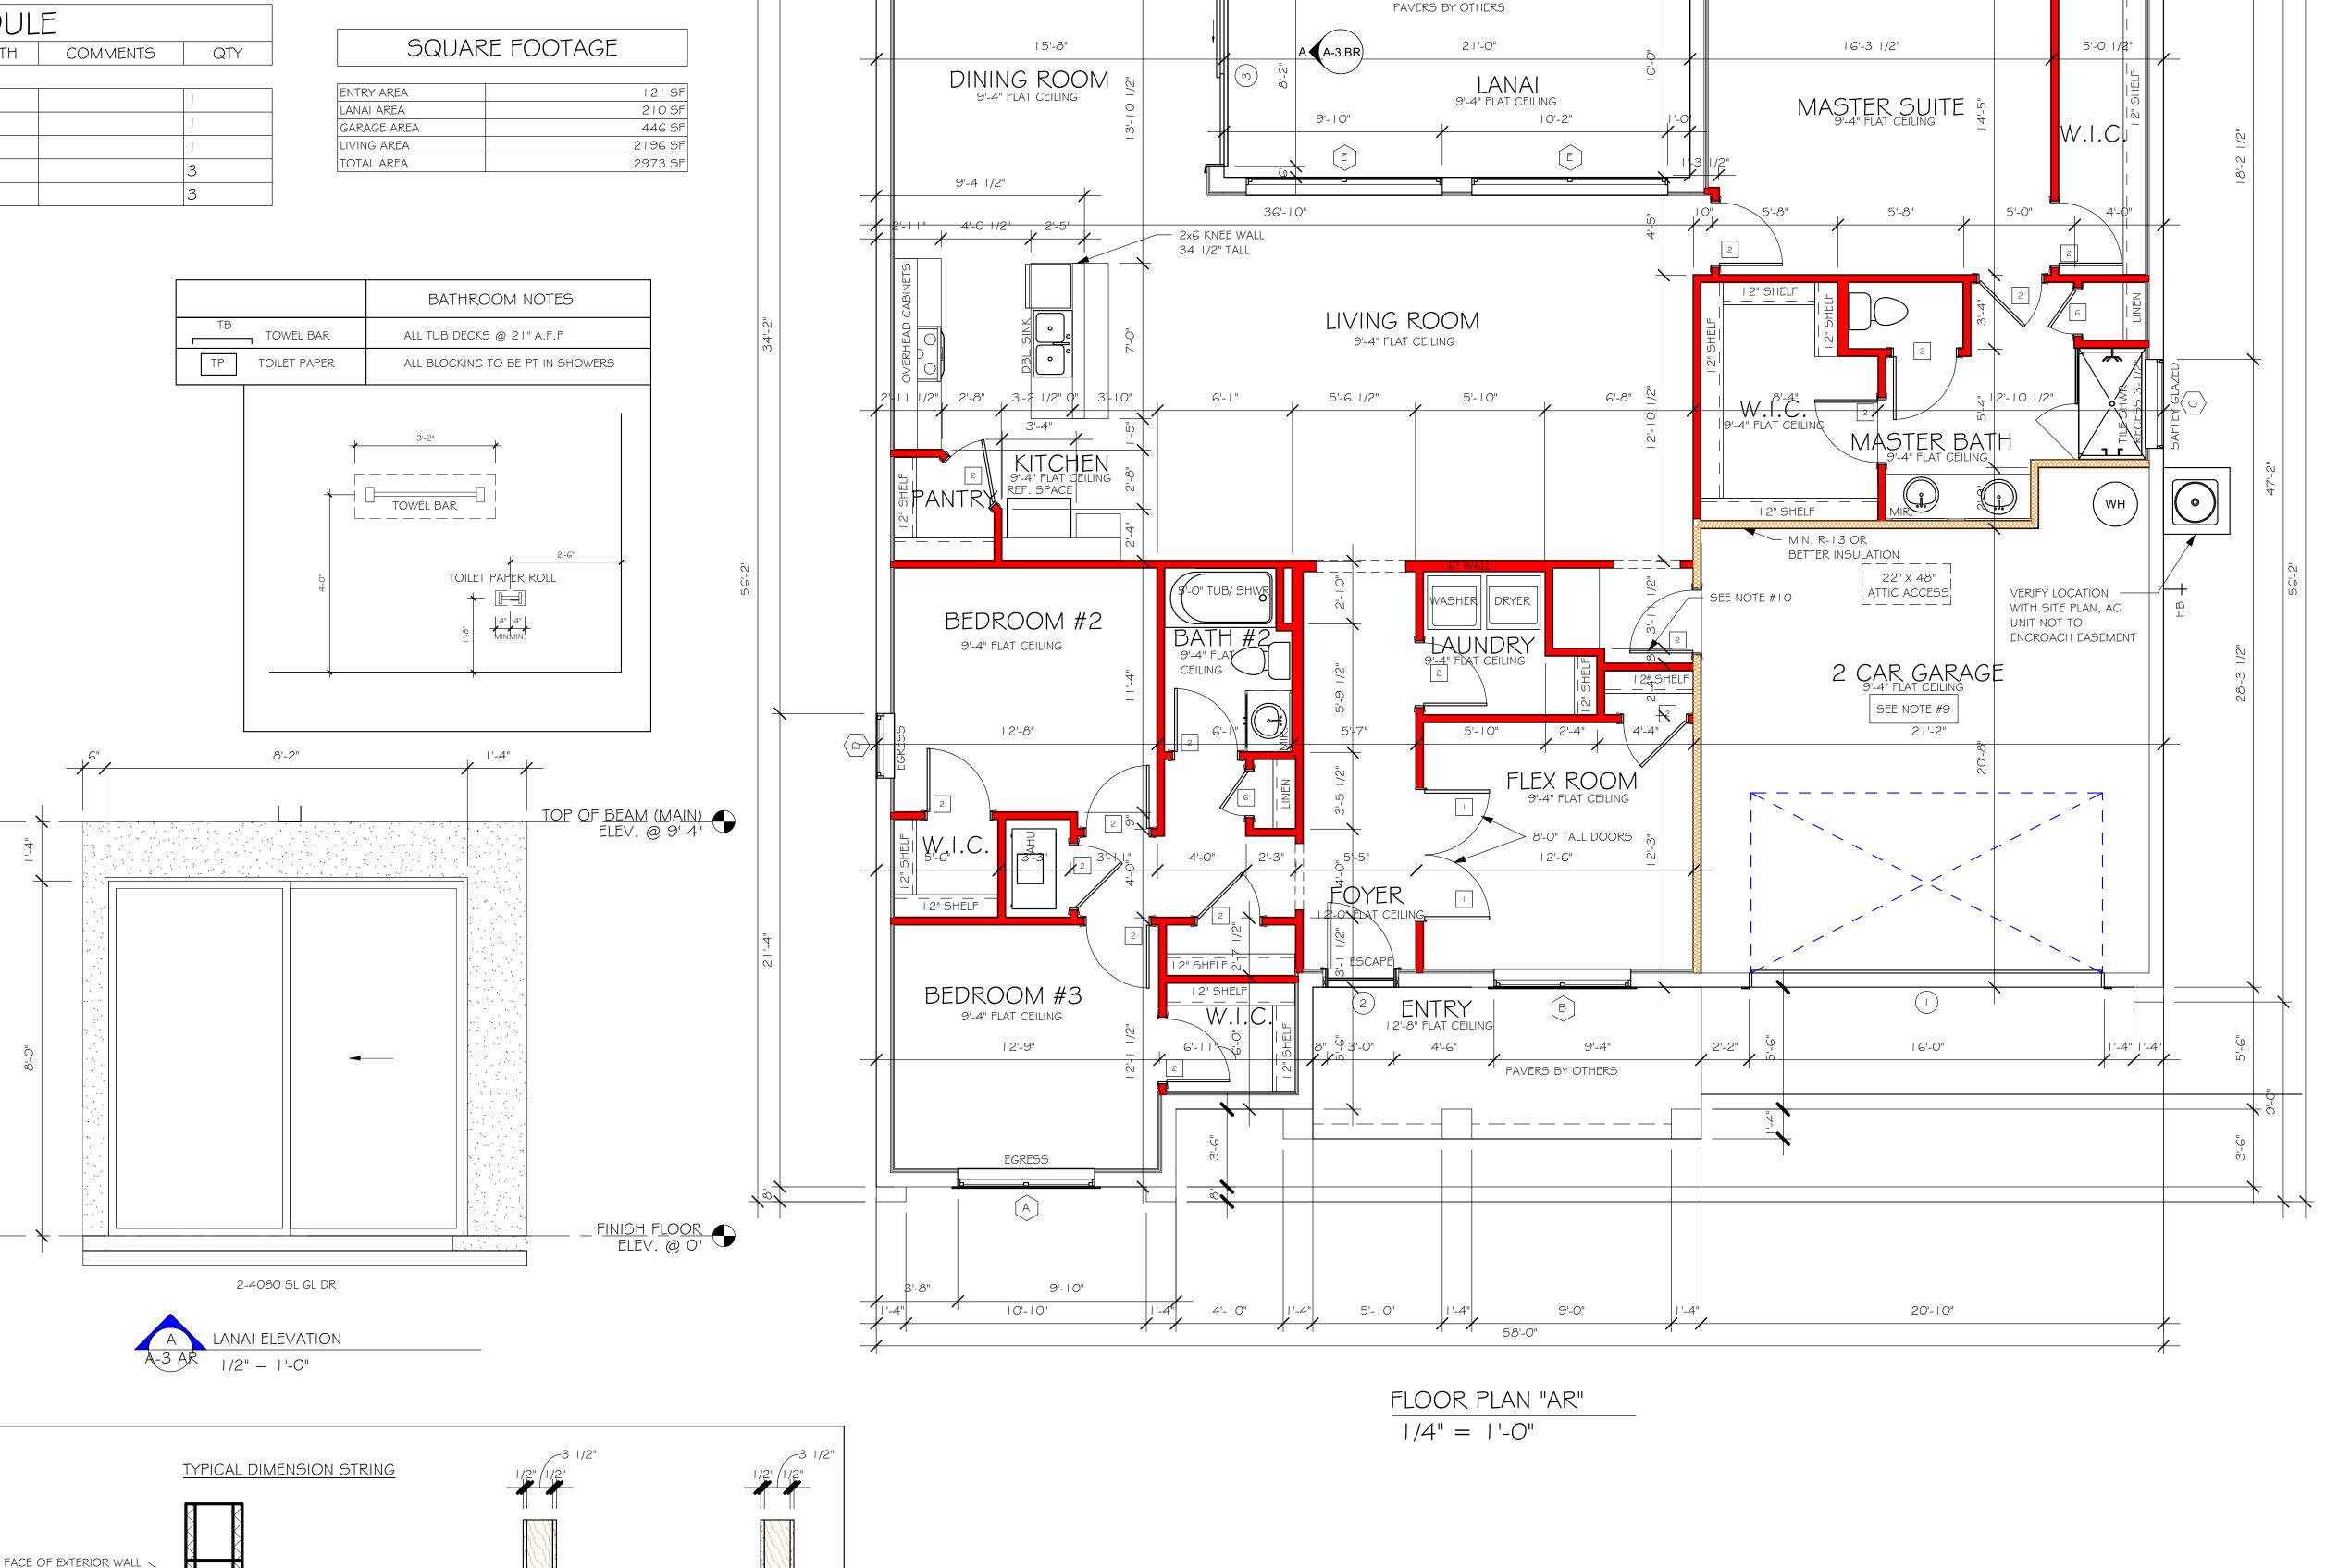

15'-8"

3'-3"

12'-5"

58'-0"

21'-4"

5'-0"

6'-4"

MODEL

DATE:

DRAWN BY:

CHECKED BY:

REVISED:

PLAN:

SCALE:

DESIGN IN ACCORDANCE WITH THE RESIDENTIAL FLORIDA BUILDING CODE 2017 - 6TH EDITION

03/05/19

JSL

JWC

FLOOR

As indicated

A-3 AR

21'-0"

Z:\MASTER\2018 BUILDERS\2018 DR HORTON\SUBDIVISIONS\BURNT STORE\10782 LOT PBLK 364 2197 AR\REVIT\10782 2197 AR.rvt

DATE:

03/05/19

DRAWN BY:

JSL

CHECKED BY:

JWC

CHECKED BY:

J

REVISED:

PLAN:


PLAN:


ROOF

SCALE:

As indicated

A-4 AR

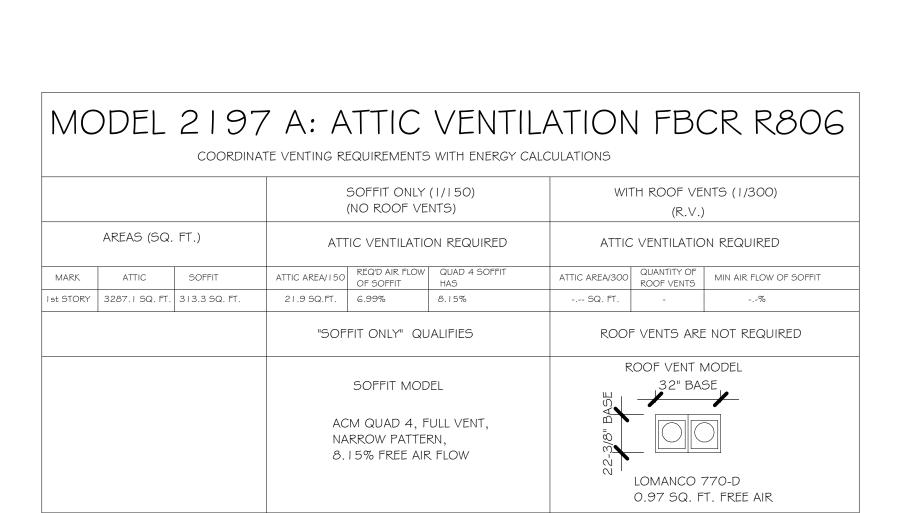

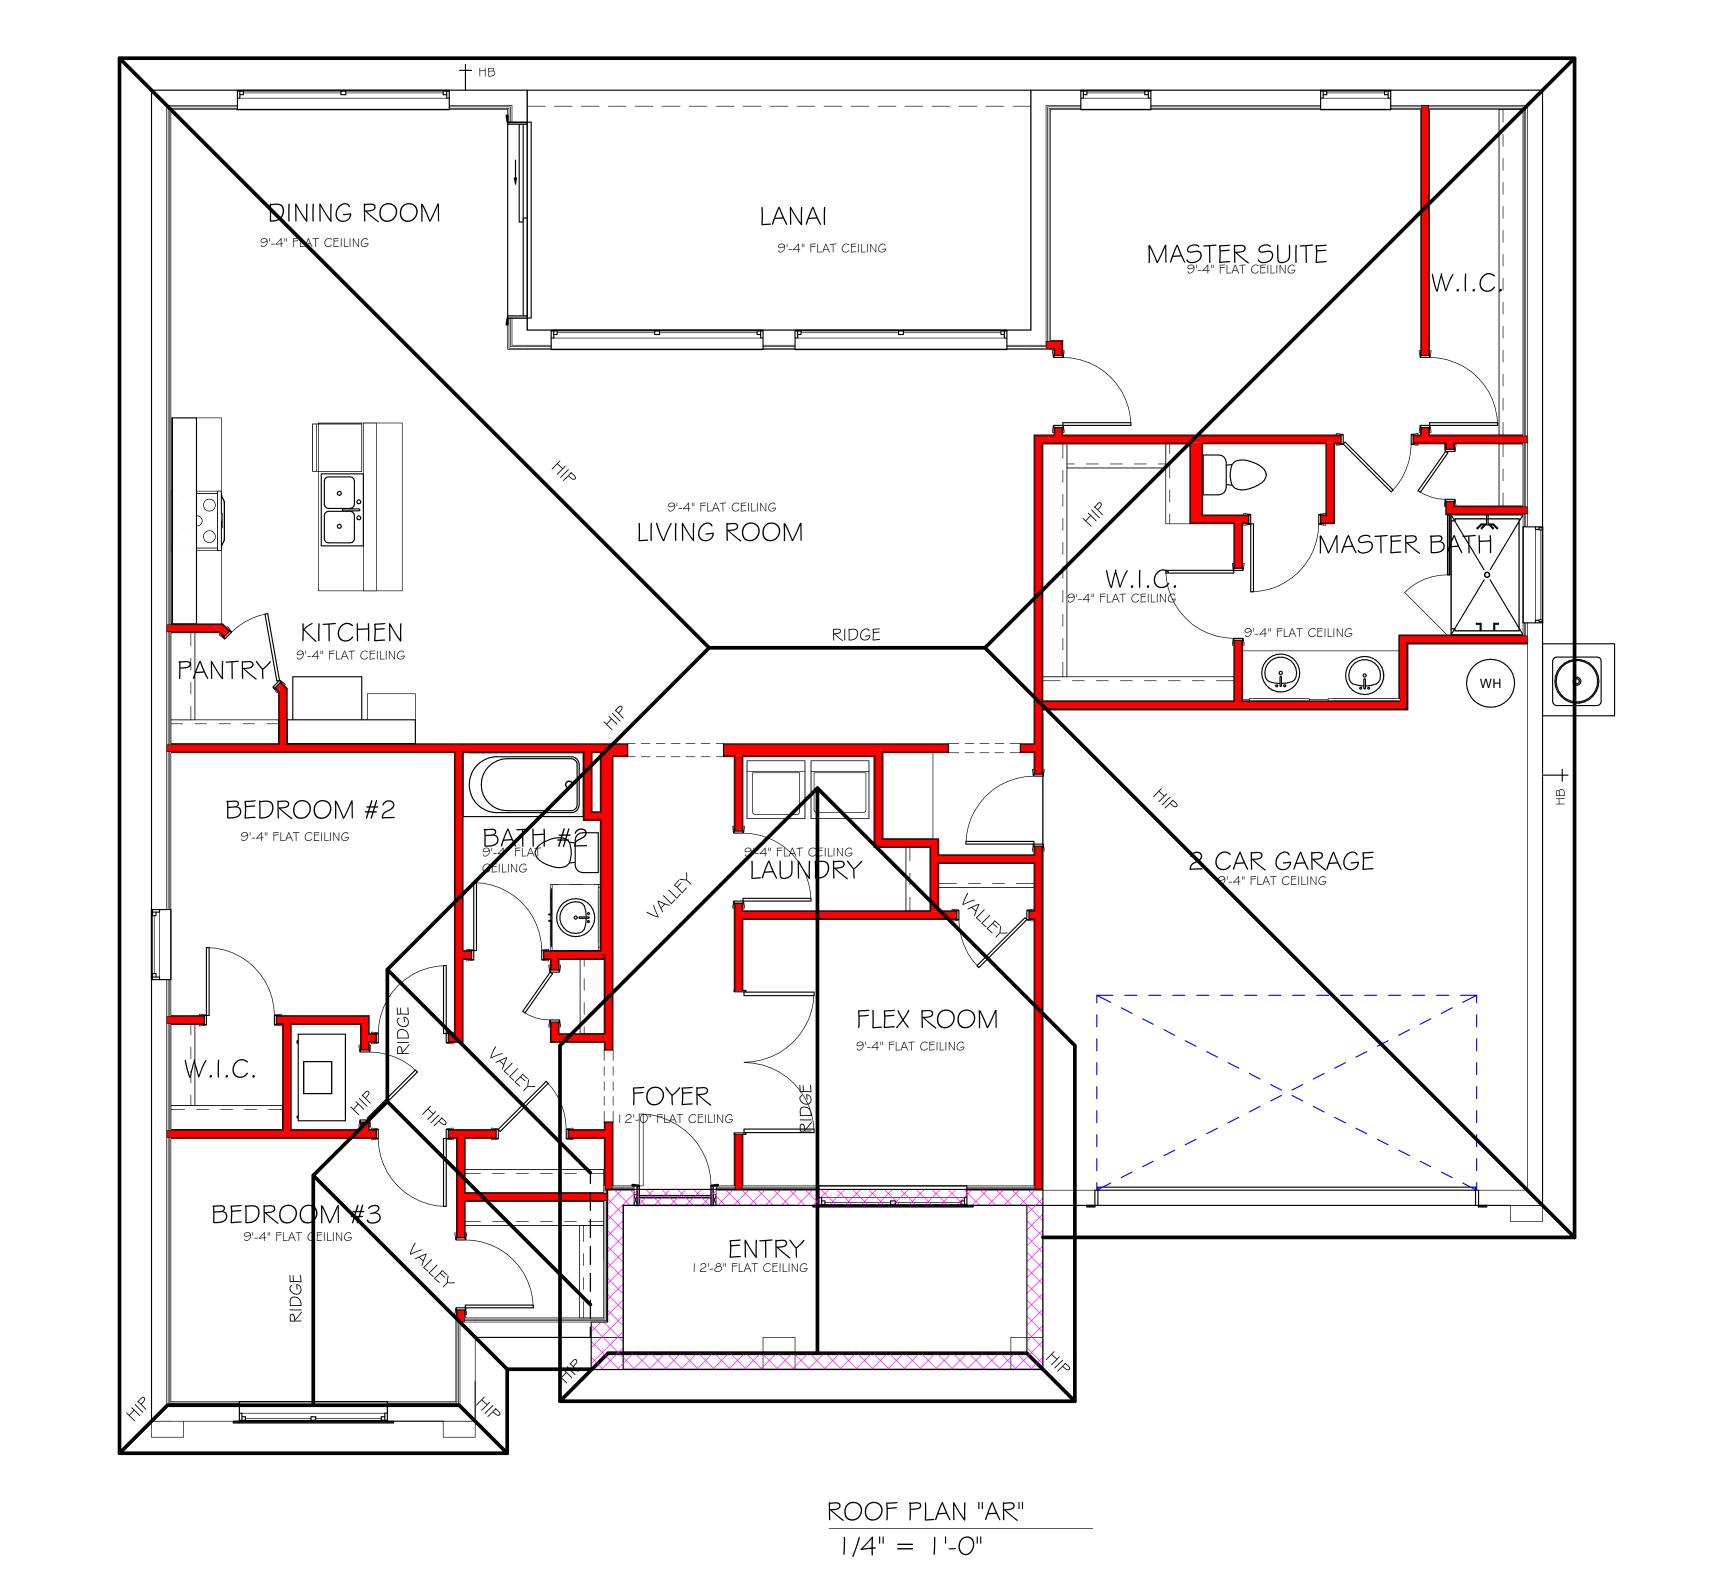

BEARING HEIGHT

= BEARING @ 9'-4"

= BEARING @ 12'-8"

DESIGN IN ACCORDANCE WITH THE RESIDENTIAL FLORIDA BUILDING CODE 2017 - 6TH EDITION

IM	
\Rightarrow	DUPLEX RECEPTACLE OUTLET
\Rightarrow	1/2 SWITCHED DUPLEX OUTLET
AFF	DUPLEX RECEPTACLE AT ELEV. A.F.F.
$\overline{}$	DUPLEX RECEPTACLE - ABOVE COUNTER
Θ	SINGLE POLE SWITCH
(√) 3	3 WAY SWITCH
() □	DIMMER SWITCH
₩ ^S	MOTION SENSOR SWITCH
S _{SD}	AC/DC SMOKE DETECTOR TO BE INTERCONNECTED ANY RESIDENT HAVING A FOSSIL-BURNING HEATER OR APPLIANCE, A FIREPLACE, OR AN ATTACHED GARAGE SHALL HAVE AN OPERATIONAL CARBON MONOXIDE ALARM INSTALLED WITHIN 10 FEET OF EACH ROOM USED FOR SLEEPING PERPOSES. PER RULE 9B-3.04.72 SD (SMOKE DETECTOR) SCD (CARBON MONOXIDE/ SMOKE DETECTOR)
-[T]	TELEPHONE OUTLET
-TV	TELEVISION RECEPTION OUTLET
	SURFACE MOUNTED CEILING LIGHT
0	RECESSED LIGHT
Ю	WALL MTD. BRACKET LIGHT
46	DUPLEX FLOOD LIGHT
\$	EXHAUST FAN
	TRACK MTD. LIGHTS
	A/C DISCONNECT
Ю	PUSH BUTTON (PB) / DOOR BELL (DB)
(10)	INTERCOM
	KEYPAD
	4' FLUORESCENT LIGHT
<u> </u>	2' UNDER COUNTER LIGHT
NOTE: NO	OT ALL SYMBOLS ARE USED FOR THIS
·	AL NOTES:
RESISTAN	LT CIRCUIT-INTERRUPTERS AND TAMPER NT RECEPTACLES SHALL BE INSTALLED ING UNITS PER N.E.C 210.12 AND 406.11
I	TRICAL EQUIPMENT TO BE SET AT
	/E BASE FLOOD ELEVATION.
OR ABOV	ETS IN WET AREAS AND ALL
OR ABOV	

ELECTRICAL LEGEND

ELECTRICAL METER


I 20 V JUNCTION BOX

SINGLE RECEPTACLE OUTLET

220 V RECEPTACLE OUTLET


4-PLEX RECEPTACLE OUTLET

ELECTRICAL PANEL

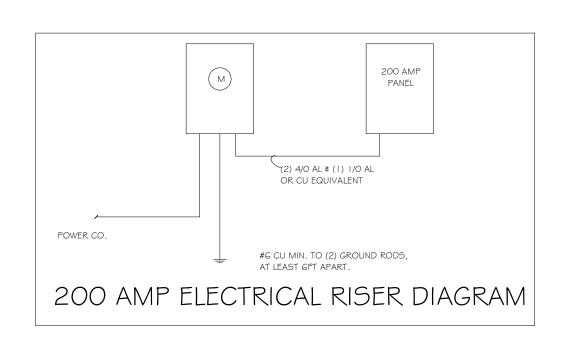


LIGHTING SCHEDULE

	2101111110	001120022
200	AMP SERVICE	
TAG	QUANTITY	PRODUCT
Α	(17)	(RECESSED CANS)
В	(1)	(VAPORS)
С	(3)	(PENDANT LIGHT
D	(14)	(10" MUSHROOMS)
E	(3)	(24" 3 LT)
F	(X)	(36" 4 LT)
G	(X)	(NOT USED)
Н	(2)	(COACH LIGHTS)
1	(X)	(COACH LIGHTS)
J	(1)	(J BOX)
Κ	(X)	(4' FLUORESCENT)
L	(X)	(2' FLUORESCENT)
М	(X)	(5LT CHANDELIER)
N	(X)	(3 LT)
0	(X)	(PENDANT/ NOOK)
Р	(X)	(X)
Q	(X)	(X)

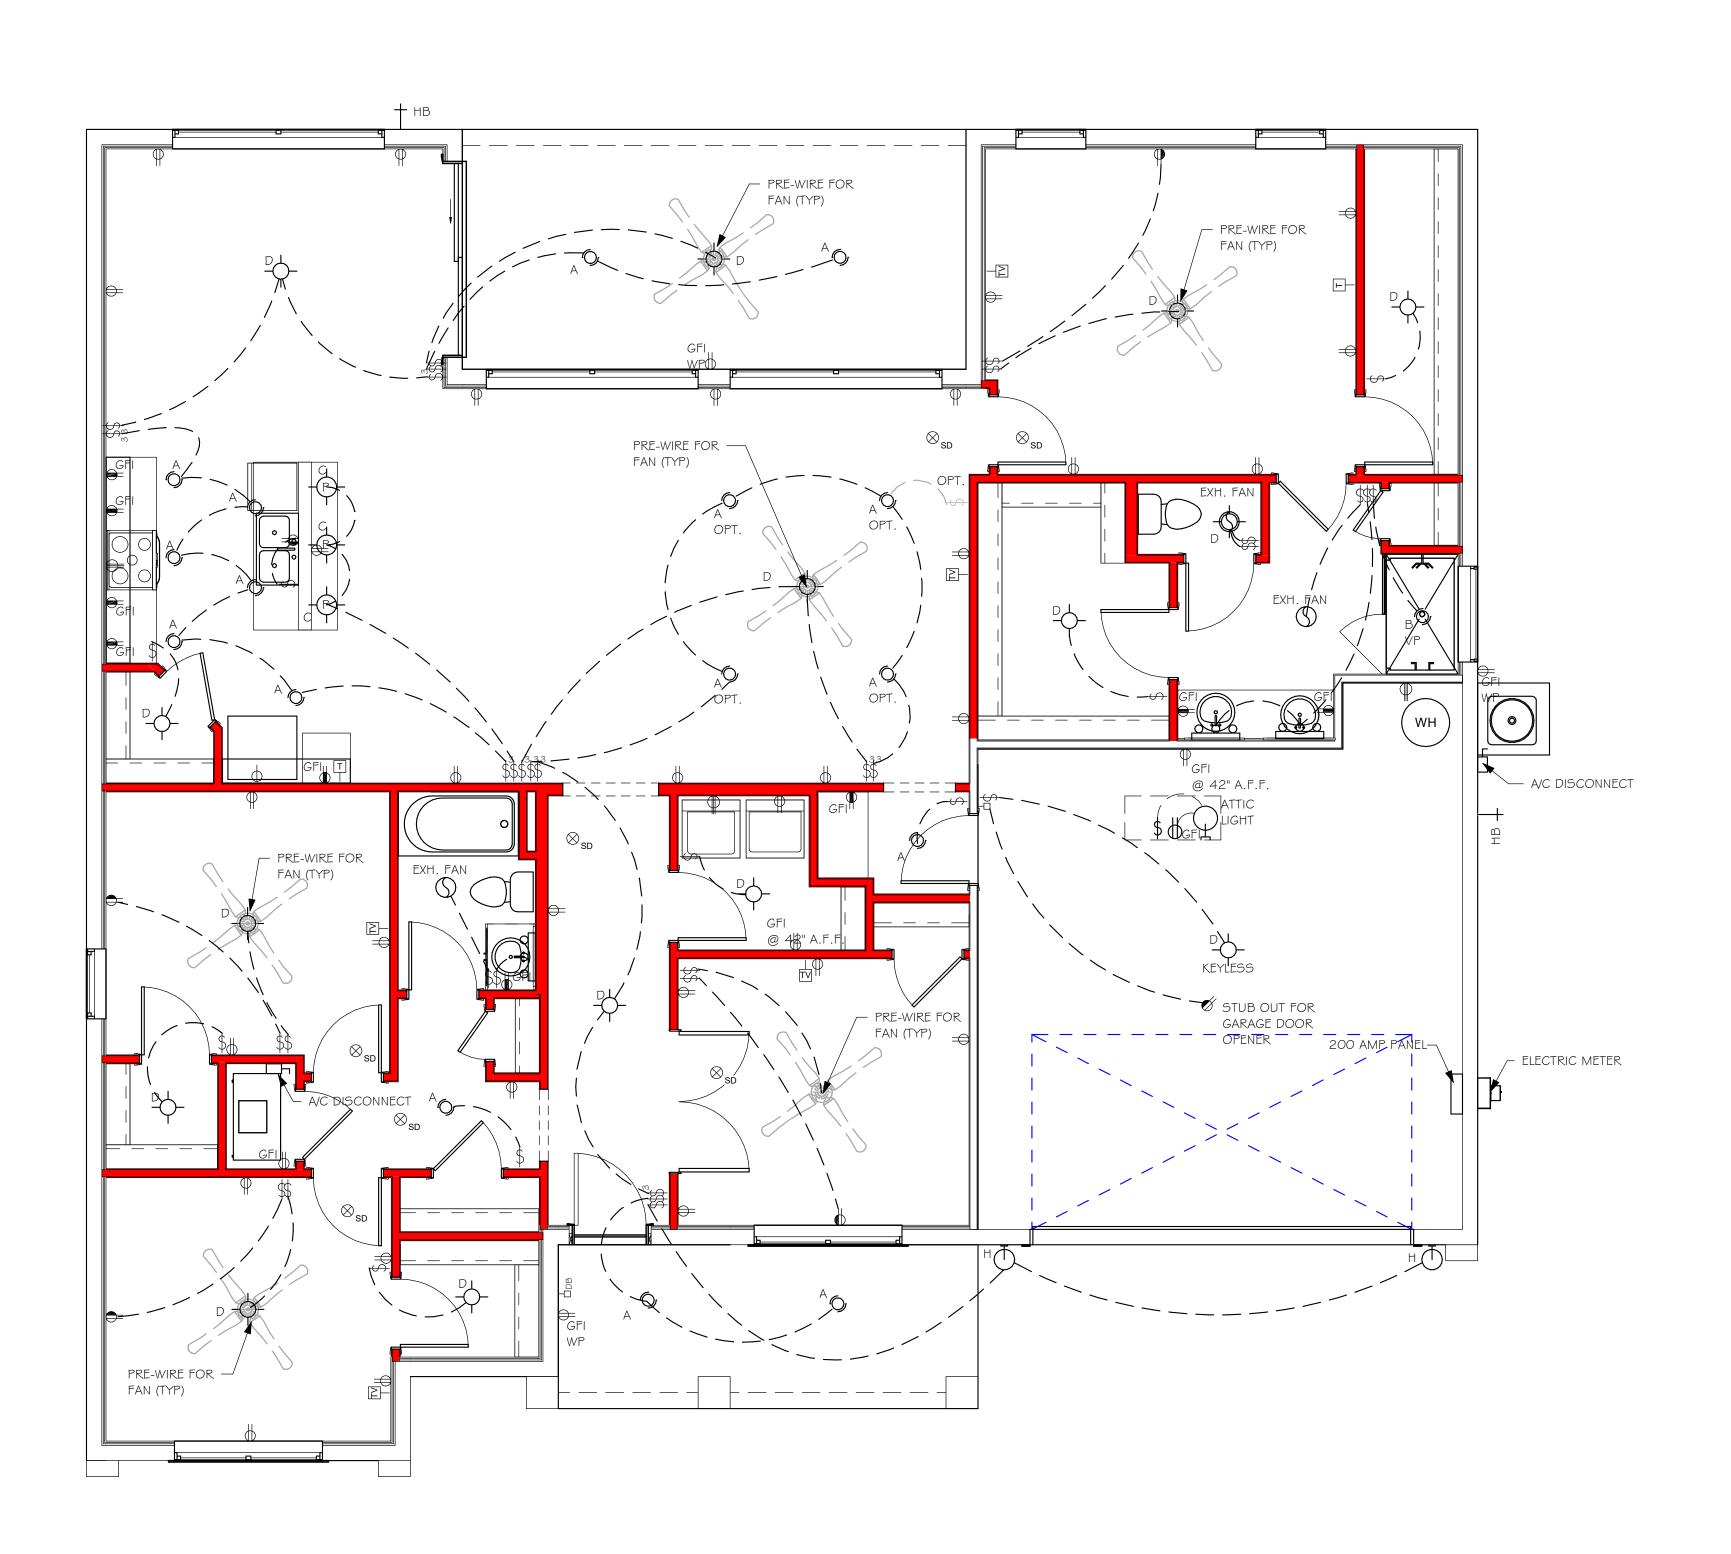


 $\frac{\text{ELECTRICAL PLAN "AR"}}{1/4" = 1'-0"}$

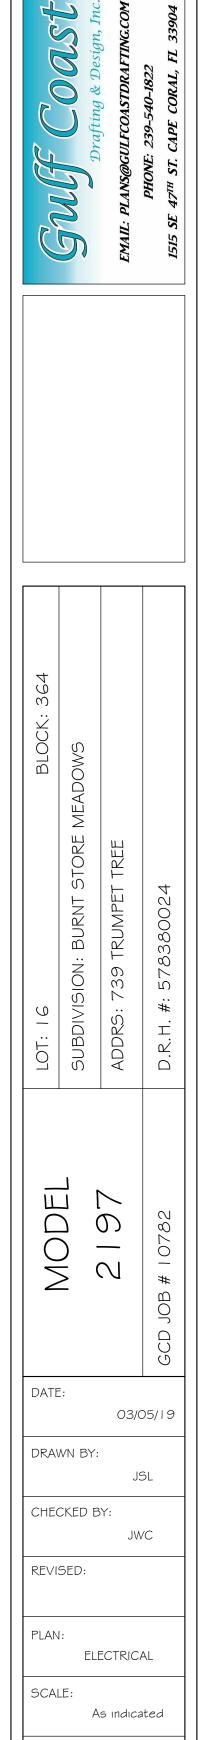

A-5 AR

DESIGN IN ACCORDANCE WITH THE RESIDENTIAL FLORIDA BUILDING CODE 2017 - 6TH EDITION

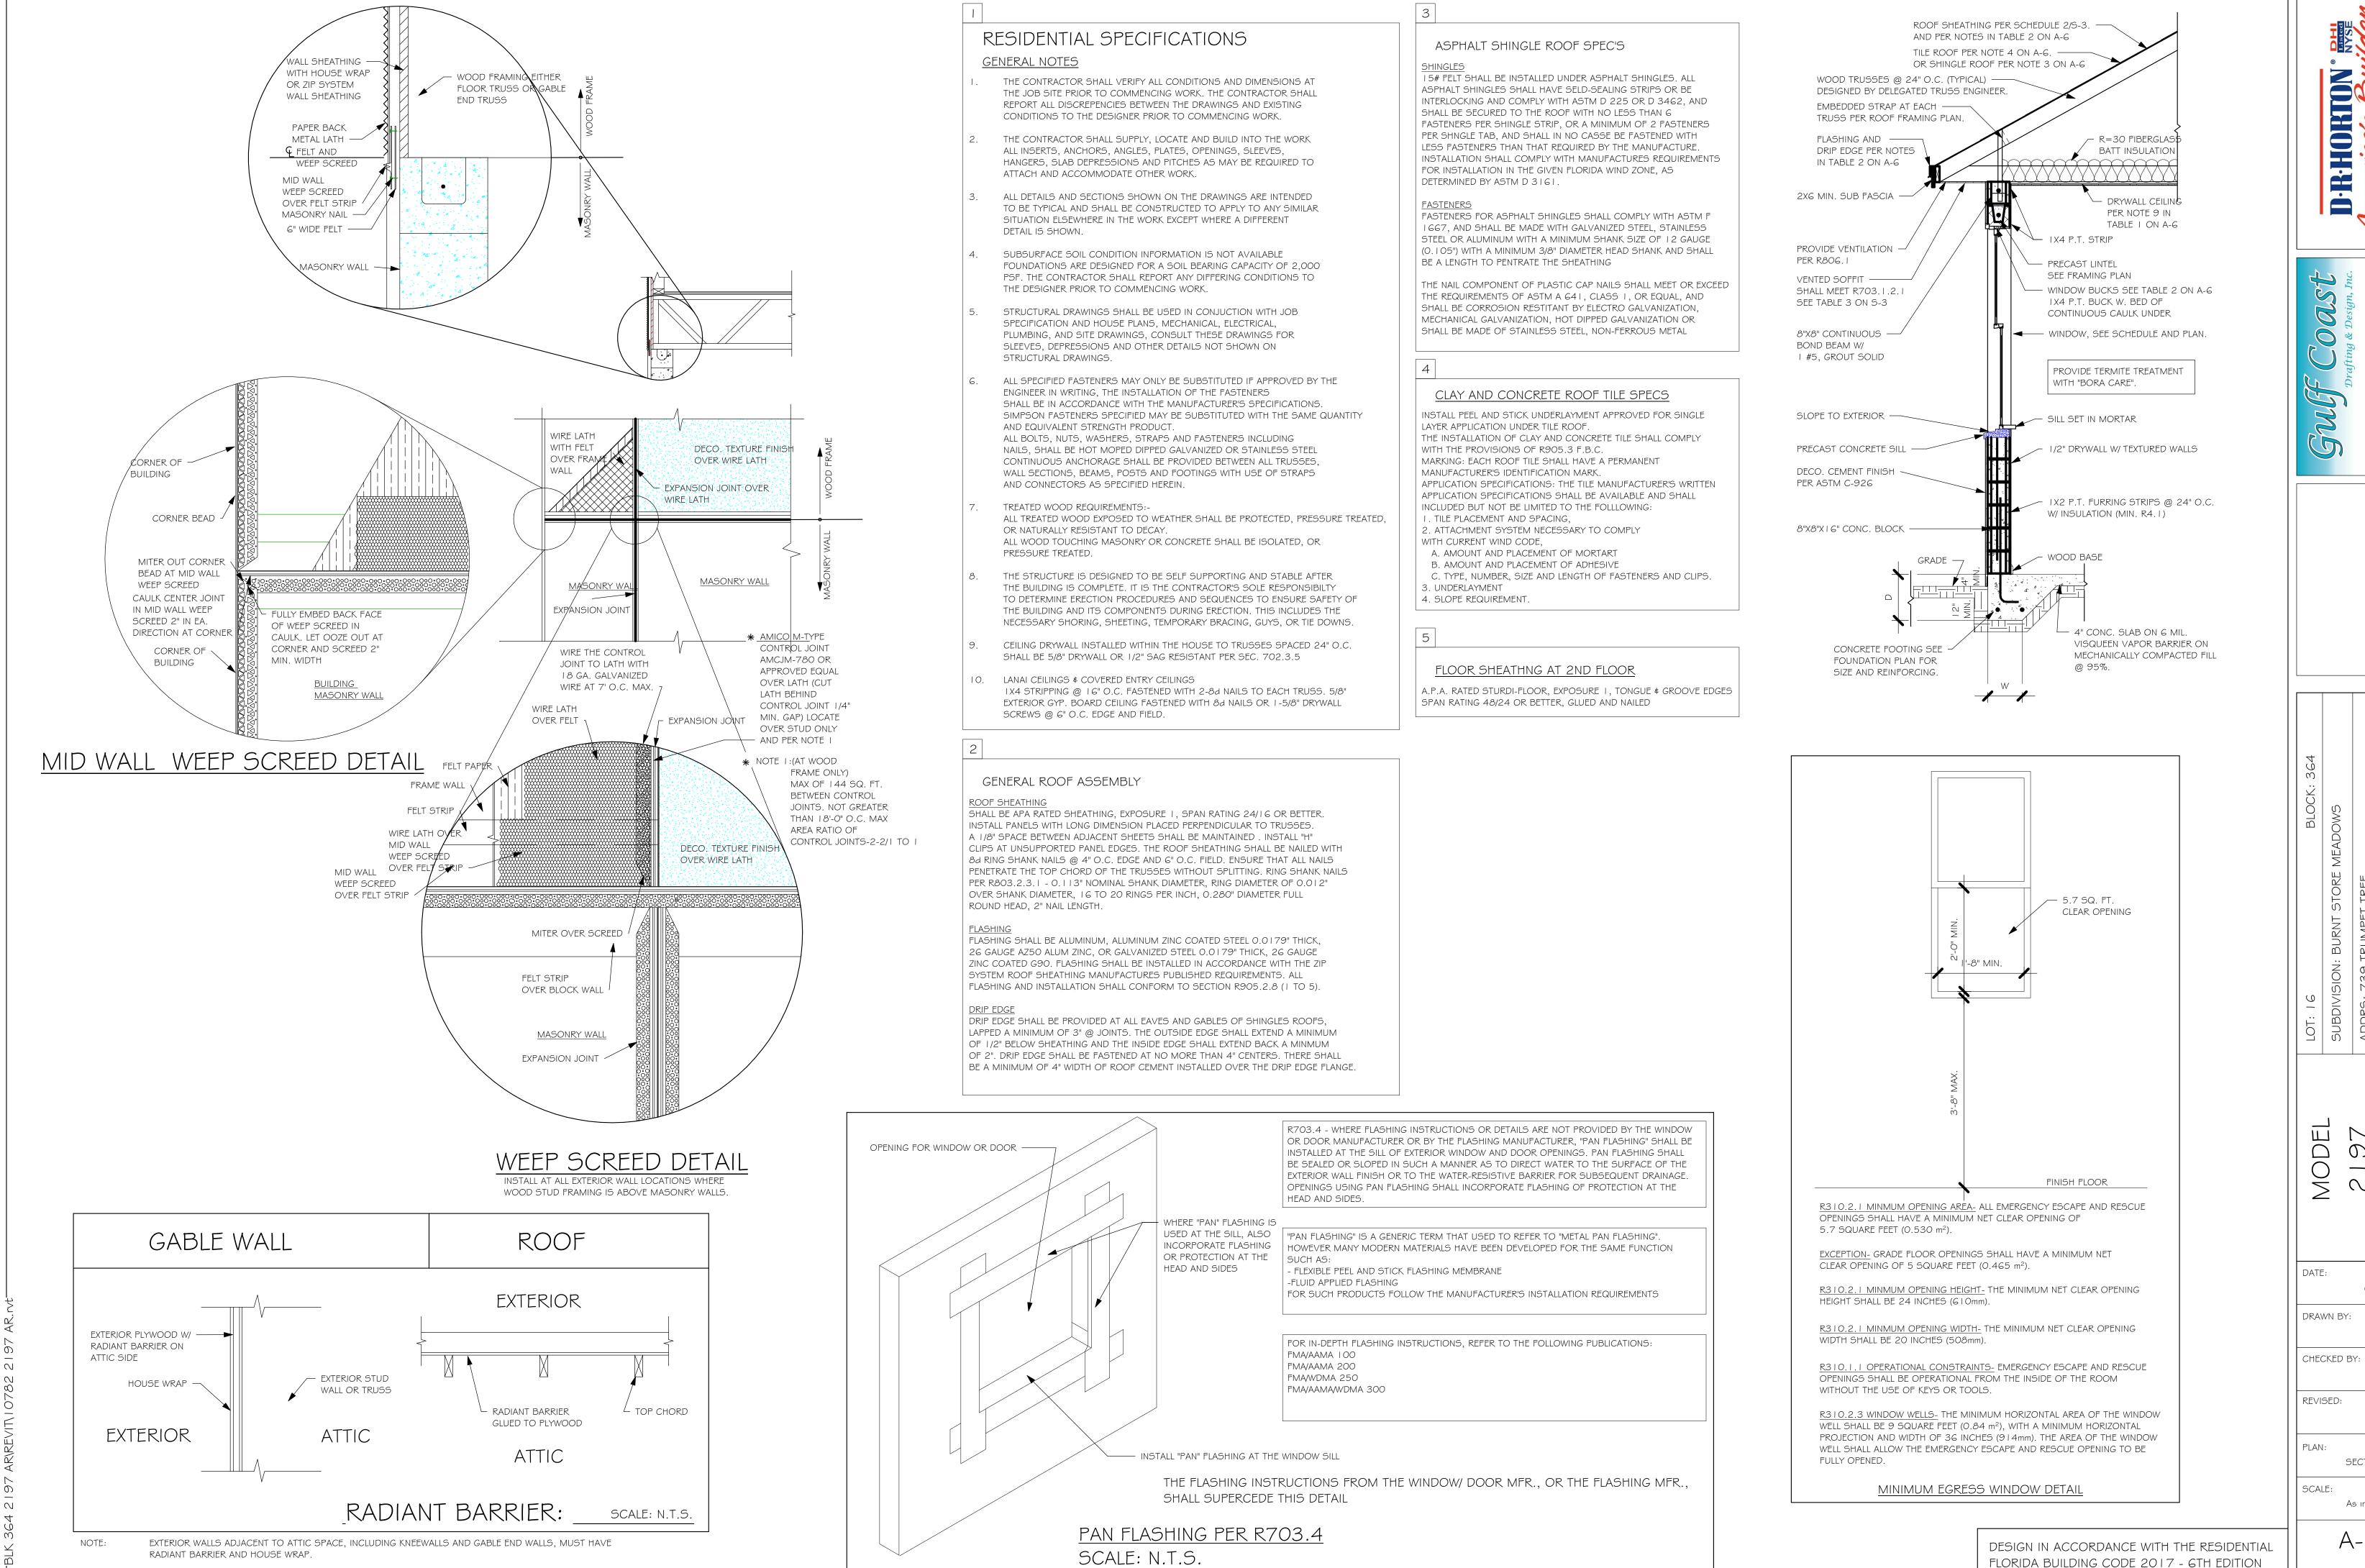

03/05/19

JWC

SECTIONS As indicated


A-6

FOUNDATION PLAN


SCALE: 1/4" = 1'-0"

- PLAN NOTES:
- TOP OF GROUND FLOOR SLAB DATUM ELEVATION 0'-0"
 "F#" DENOTES CONTINUOUS WALL FOOTING TYPE PER SCHEDULE THIS SHEET.
- PROVIDE #5 VERTICAL REINFORCING AT DOT LOCATIONS SHOWN ON PLAN FROM FOOTING
- TO BOND BEAM.
- ALL DIMENSIONS ARE TO OUTSIDE FACE OF MASONRY WALLS. SOME SLAB EDGES MAY EXTEND BEYOND FACE OF WALL.
 FOR DIMENSIONS OF ROUGH OPENINGS IN MASONRY WALLS, COORDINATE WITH WINDOW/
- 6. PROVIDE PRESSURE TREATED BUCKS AT WINDOWS/ DOORS PER DETAIL 7/S-3.


$\frac{\text{"F3" FOOTING}}{1/2" = 1'-0"}$

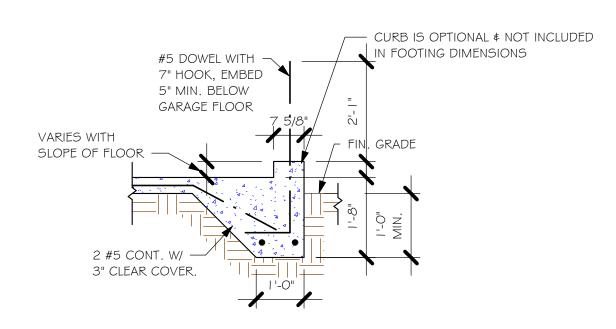


 $\frac{\text{"F3" WITH CURB}}{1/2\text{"} = 1\text{'-0"}}$

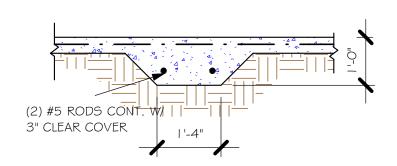


 $\frac{"F5" FOOTING}{1/2" = 1'-0"}$

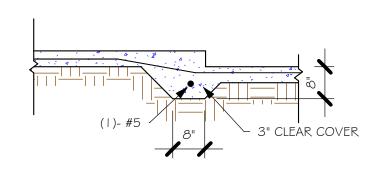

 $\frac{\text{"F6A" STEP DOWN}}{1/2\text{"} = 1\text{'-0"}}$

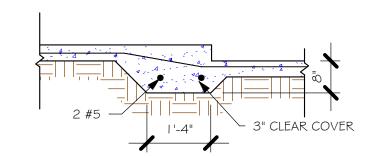


 $\frac{\text{"F6" STEP DOWN}}{1/2\text{"} = 1\text{'-0"}}$

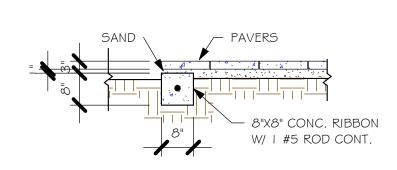

 $\frac{\text{"P" PAVERS DETAIL}}{1/2\text{"} = 1\text{'-0"}}$

		PAD FOOTING SCHEDULE							
2	TVDE	LENGTH	WIDTH	DEPTH	вотт	OM REINF.	REMARKS		
-	3 1 1 7 5	LENGIA	WIDIA	DEPIR	LONG WAY	SHORT WAY	KEWAKNO		
	$\langle A \rangle$	2'-6"	2'-6"	1'-0"	3-#5	3-#5	-		
	(B)	3'-0"	3'-0"	1'-0"	4-#5	4-#5	-		
	(C)	3'-6"	3'-6"	1'-0"	4-#5	4-#5	-		
	$\langle \mathbf{D} \rangle$	4'-0"	4'-0"	1'-2"	5-#5	5-#5	-		
	(E)	5'-0"	5'-0"	1'-2"	6-#5	6-#5	-		

	١٨/	ΛΙΙ Γ	-00	TINIC	COLIED	\	
	۷۷	ALL F	-00	IIIIG	SCHED	JULE	
USED	TYPE	LENGTH	WIDTH	DEPTH	BOTTOM REINFORCING	SHAPE	
	F1	CONT.	1'-4"	0'-8"	2-#5		
	F2	CONT.	1'-8"	0'-10"	2-#5		ADD CURB TO
X	F3	CONT.	1'-0"	1'-8"	2-#5	₩	GARAGE, SEE
	F4	CONT.	1'-4"	1'-8"	2-#5		
	F5	CONT.	1'-4"	1'-0"	2-#5	—	
	F6	CONT.	1'-4"	1'-0"	2-#5		
X	F6A	CONT.	0'-8"	0'-8"	1-#5		
	TE	CONT.	0'-8"	0'-8"	1-#5		

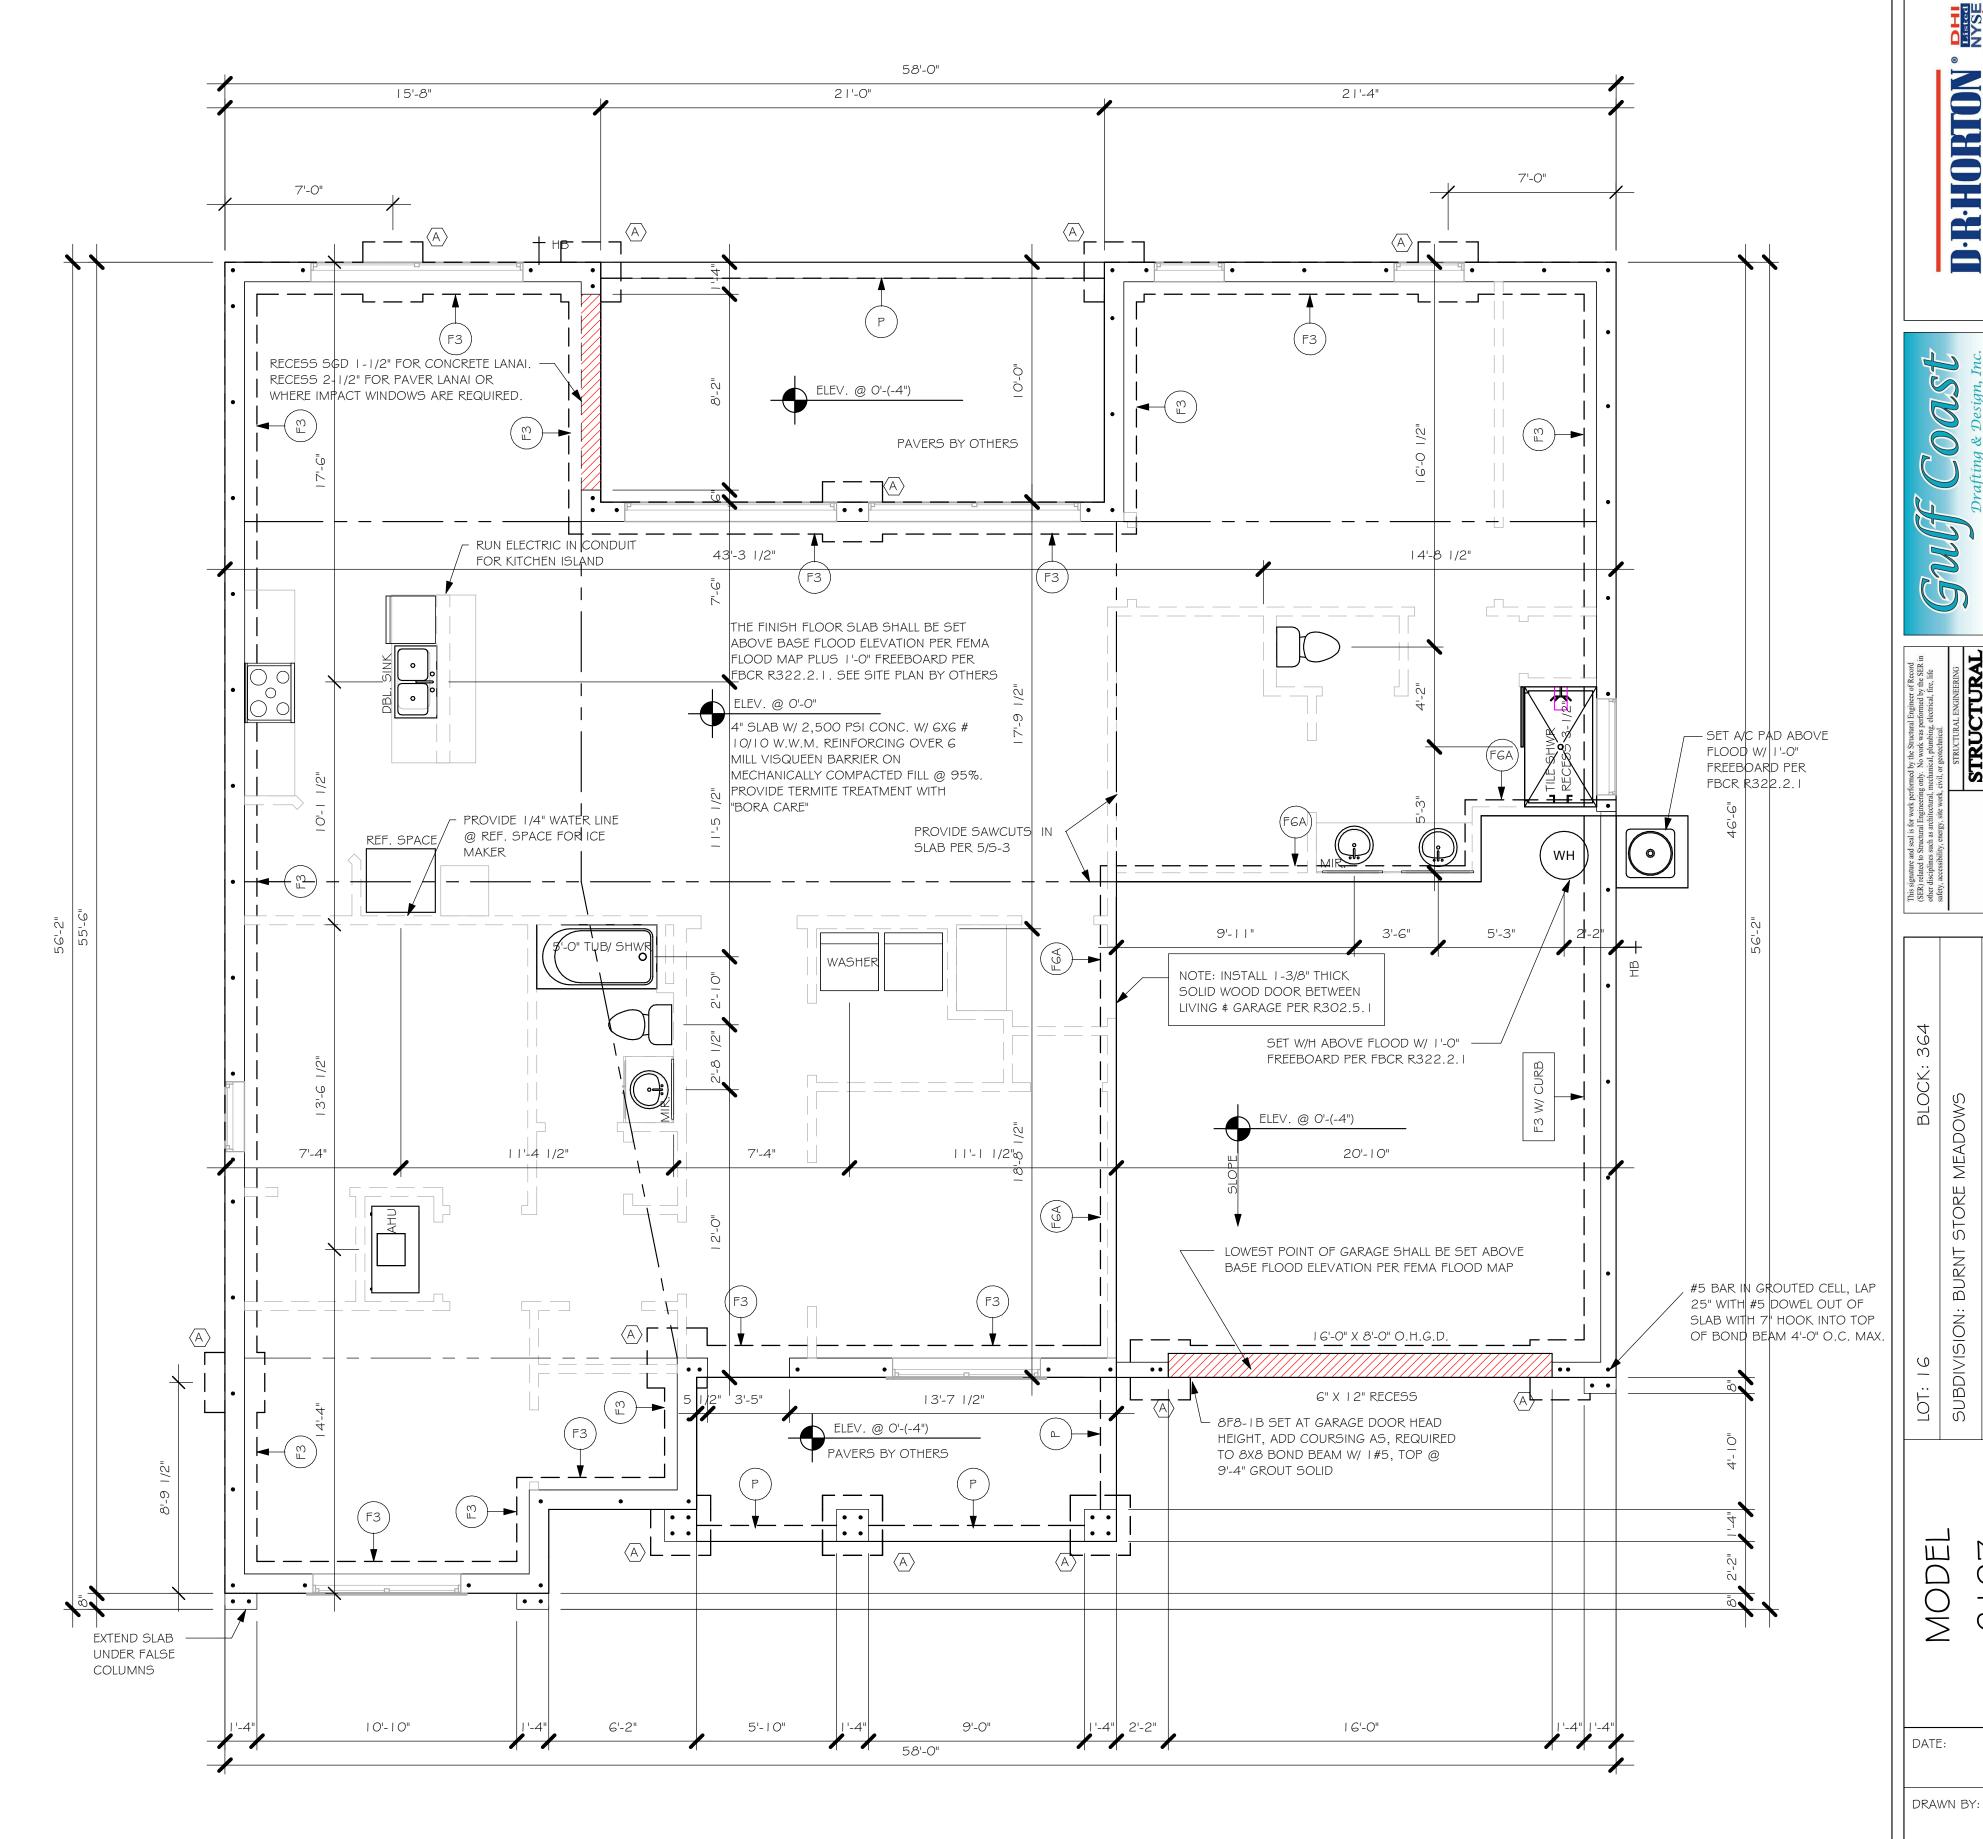

 $\frac{\text{FOUNDATION PLAN "AR"}}{1/4" = 1'-0"}$

DESIGN IN ACCORDANCE WITH THE RESIDENTIAL FLORIDA BUILDING CODE 2017 - 6TH EDITION

03/05/19

JWC

CHECKED BY:

FOUNDATION PLAN

As indicated

S-I AR

REVISED:

SCALE:

Z:\MASTER\2018 BUILDERS\2018 DR HORTON\SUBDIVISIONS\BURNT STORE\1078 ---BLK 364 2197 AR\REVIT\10782 2197 AR.rvt I. PROVIDE A STRAP FROM THE ABOVE LIST AT EACH ROOF TRUSS BEARING POINT, BASED ON THE TRUSS UPLIFT VALUES IN THE SIGNED AND SEALED TRUSS DESIGN PACKAGE AND SUITABLE FOR THE GEOMETRY. EMBED STRAP

FASTENER

10-10dx1/2", EMBED 4"

10-10dx1/2", EMBED 4"

10-10dx1/2", EMBED 4"

10-10dx1/2", EMBED 4"

10-10dx 1/2", EMBED 4"

5/8"ø ATR, EPOXY 12"

CONNECTORS ARE USP STRUCTURAL CONNECTORS. ALL CONNECTORS SHALL BE INSTALLED IN STRICT ACCORDANCE WITH USP PRINTED INSTUCTIONS. SUBSTITUTIONS MUST BE APPROVED IN WRITING BY THE


WHERE EMBEDDED STRAPS ARE MISSING, OR MIS-LOCATED, INSTALL RETROFIT STRAP PER 2/S-4.

'ATR' = ALLTHREAD. DRILL AND EPOXY WITH USP EPOXY PER MFR. INSTRUCTIONS.

INSTALL AT ALL	TRUSS STRAPPING TO) STUDWALL/ WOOD BE	AM
TRUSSES TO 1 005 Ib UPLIFT.	MAX TRUSS UPLIFT @ 24" OC (LBS)	CONNECTOR	FASTENER
FOR HIGHER UPLIFTS, SEE NOTES ON PLAN.	1005 2010 3015 1285 2570 3855 5140	(1)MTW16 (2) MTW16 (3) MTW16 (1) HTW20 (2) HTW20 (3) HTW20 (4) HTW20	2- OdX ~ /2" 2- OdX ~ /2" 2- OdX ~ /2" 24- OdX ~ /2" 24- OdX ~ /2" 24- OdX ~ /2" 24- OdX ~ /2"


I. PROVIDE A STRAP FROM THE ABOVE LIST AT EACH ROOF TRUSS BEARING POINT, BASED ON THE TRUSS UPLIFT VALUES IN THE SIGNED AND SEALED

TRUSS DESIGN PACKAGE. CONNECTORS ARE USP STRUCTURAL CONNECTORS. ALL CONNECTORS SHALL BE INSTALLED IN STRICT ACCORDANCE WITH USP PRINTED INSTUCTIONS.

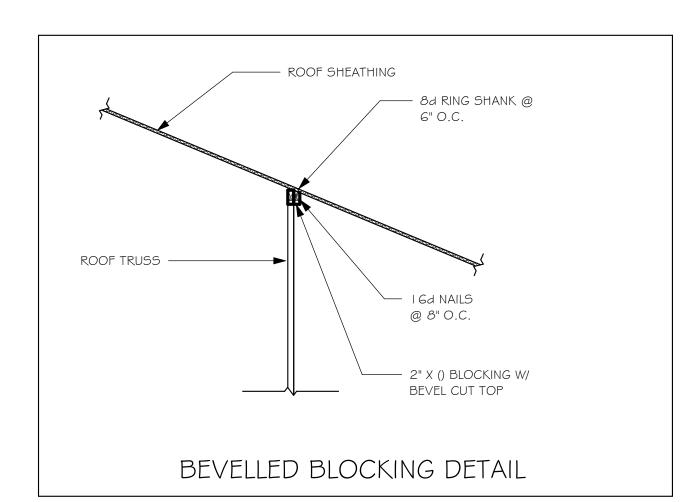

TRUSS BEARING CONDITIONS AND STRAPPING IS BASED ON TRUSS LAYOUT PERPARED BY SCOSTA JOB# 44134 DATED: 08/13/18 REVISED: 10/28/18


BEARING HEIGHT = BEARING @ 9'-4" = BEARING @ 12'-8"

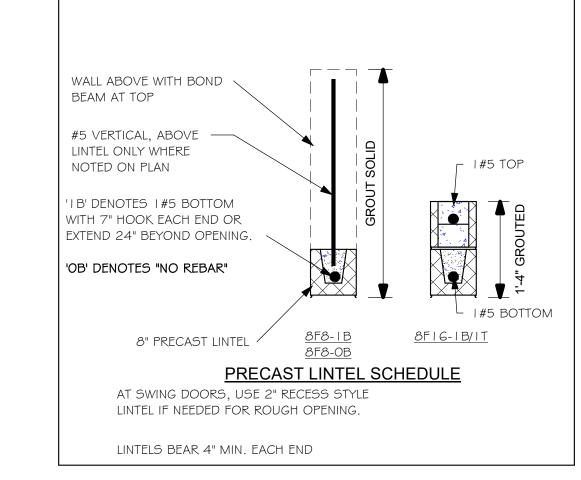

PLAN NOTES:

- ROOF TRUSS BEARING ELEVATION VARIES, SEE
- ROOF FRAMING SHALL BE WOOD TRUSSES DESIGNED BYA DELEGATED TRUSS ENGINEER PER DESIGN CRITERIA ON SHEET S-3.
- PROVIDE STRAPPING AT TRUSSES PER NOTES ON THIS
- FOR NAILING OF ROOF DECK, SEE | AND 2 ON S-3. 8F8-1B etc., DENOTES PRECAST LINTEL ABOVE DOORWINDOW OPENING PER SCHEDULE THIS SHEET. AT TRUSS BEARING, PROVIDE 8x8 MASONRY BOND

BEAM W/ | #5 CONTINUOUS, SEE DETAIL | 1/5-3.

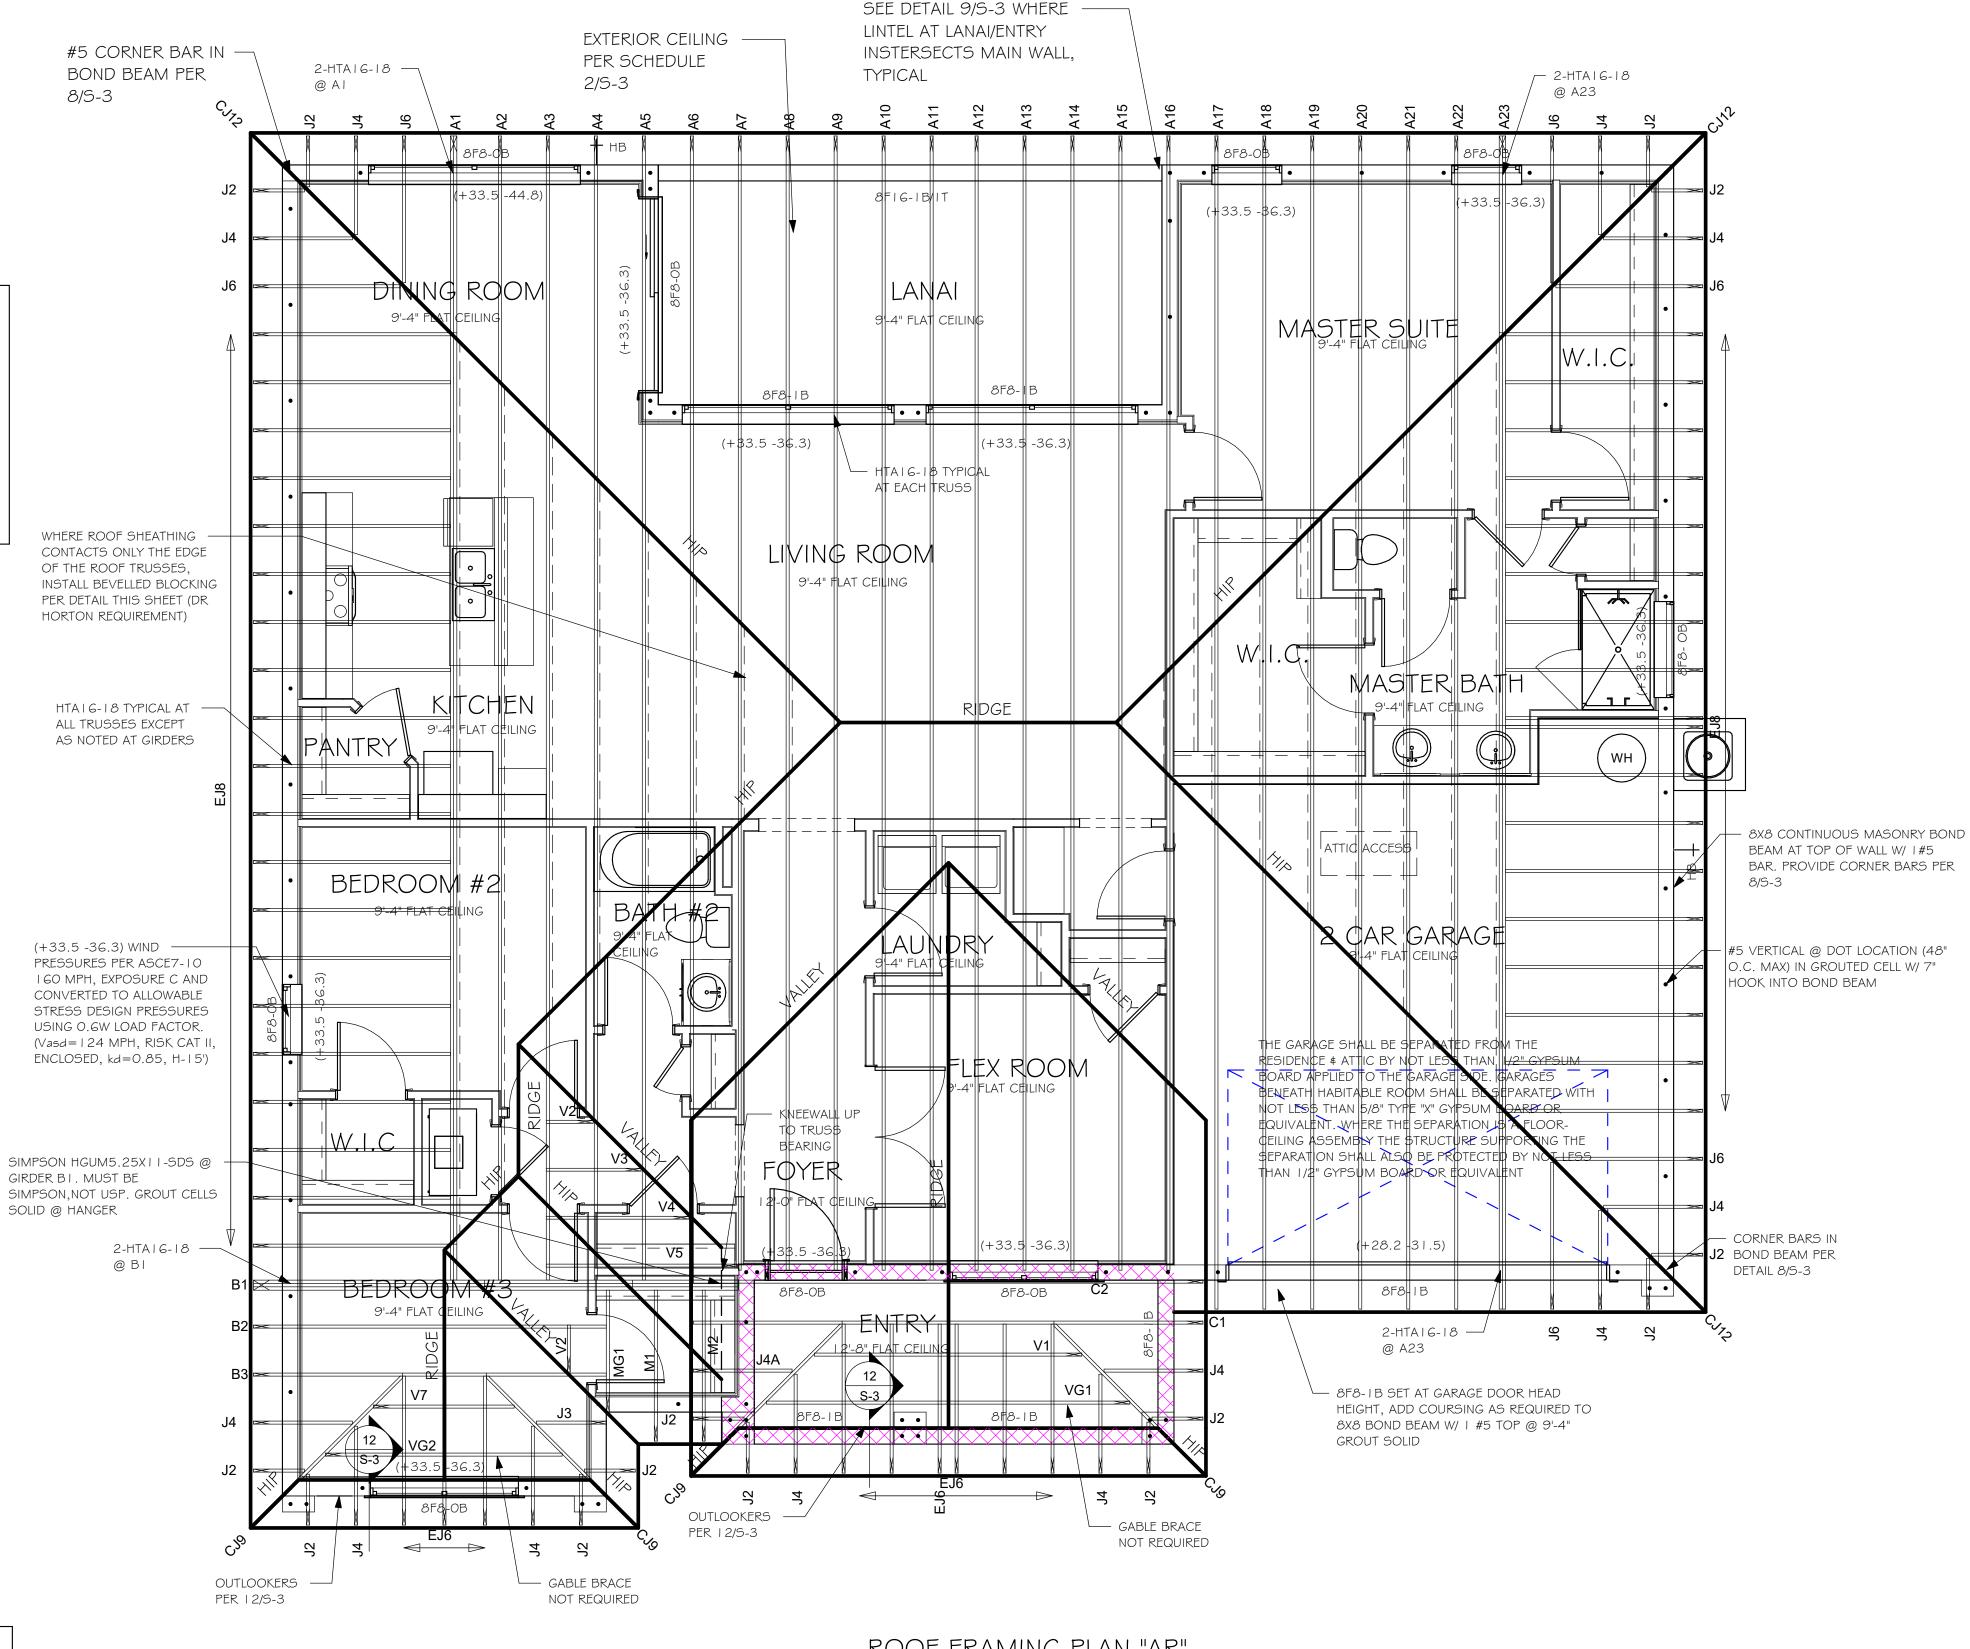

ROOF FRAMING PLAN "AR" 1/4" = 1'-0"

> DESIGN IN ACCORDANCE WITH THE RESIDENTIAL FLORIDA BUILDING CODE 2017 - 6TH EDITION

DATE: 03/05/19 DRAWN BY: CHECKED BY:


MODEL

JWC REVISED:

STRUCTURAL SYSTEMS OF NORTH FLORIDA 1634 S.E. 47th ST SUITE #3 CAPE CIRAL, FL 33904 (239) 549-4554

ROOF FRAMING PLAN SCALE: As indicated

5-2 AR

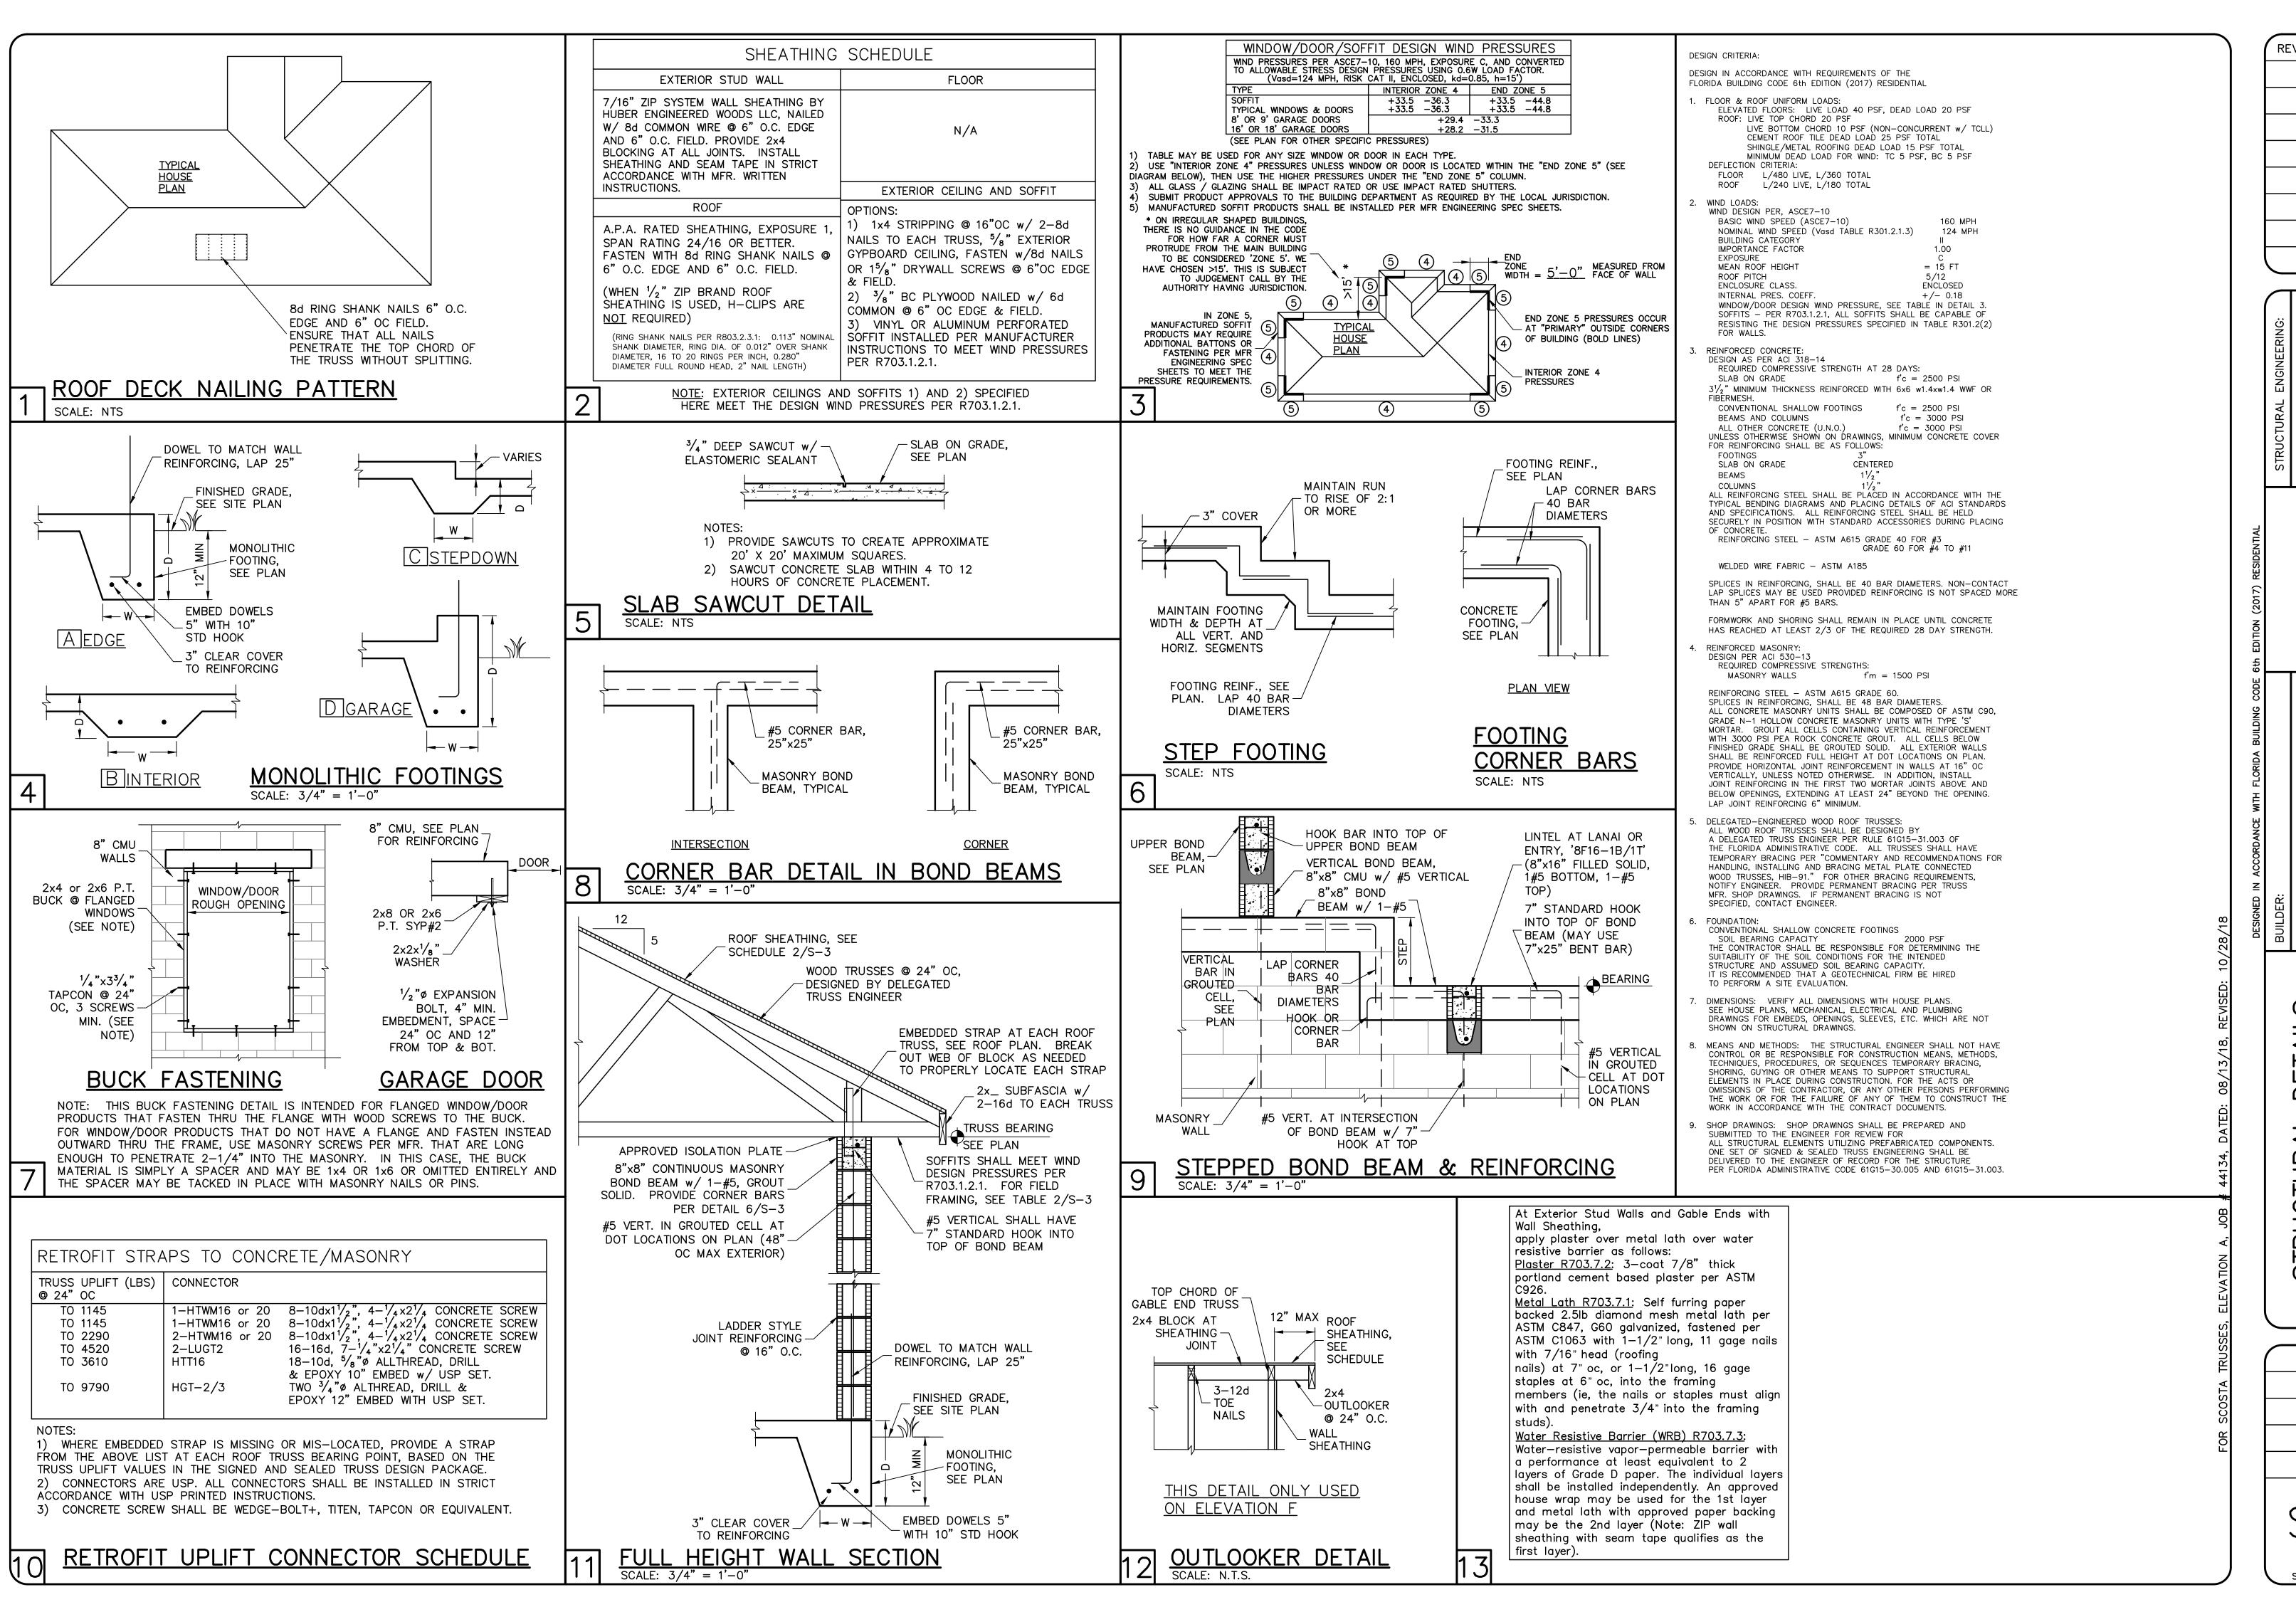

REVISIONS

OKTON FH

< 97 STEEF MODEL 739 PUNTA PUNTA

DWB/GRH CHECKED DWB 03/13/19 **VARIES**

DR10782

JOB NO.