

 $\frac{\text{SLAB \sharp PLUMBING "AL"}}{1/4" = 1'-0"}$

DESIGN IN ACCORDANCE WITH THE RESIDENTIAL FLORIDA BUILDING CODE 2017 - 6TH EDITION

A-2 AL

As indicated

SLAB & PLUMBING PLAN

MODEL

DATE:

DRAWN BY:

CHECKED BY:

REVISED:

SCALE:

03/27/19

JWC

1	3080 ENTRY	DISTINCTION			1
2	2880 ENTRY	DISTINCTION			
3	(3)-4080 SL. GL. DR.		12'-2"	8'-1"	1
4	8080 OHGD		8'-2"	8'-1"	1
5	16080 OHGD		16'-3"	8'-1 1/2"	1

WINDOW SCHEDULE

NAARK DECCRIPTION NAANUEACTURED WIRTH LIEUCUT CONAMENTO O	***************************************							
MARK DESCRIPTION MANUFACTURER WIDTH HEIGHT COMMENTS QT	ìTY ¯	QTY	COMMENTS	HEIGHT	WIDTH	MANUFACTURER	DESCRIPTION	MARK

A	2-35 SH		9'-0"	5'-3"	2
В	48" X 16"	FIXED GLASS	4'-2"	3'-4"	1
С	1/2 33 SH		2'-2"	3'-2"	2
D	25 SH		3'-1"	5'-3"	3
E	2-25 SH		6'-4"	5'-3"	1
F	2-26 SH		6'-4"	6'-4"	1


OPT IMPACT GLASS MAY BE INSTALLED IN LIEU OF SHUTTERS VERIFY W/ CONTRACT

DOOR HEADERS		
6'-8" BI-FOLD	HEADER HEIGHT	82" A.F.F.
6'-8" SWING	HEADER HEIGHT	82 1/2" A.F.F.
8'-0" SWING	HEADER HEIGHT	98 I/2" A.F.F.

PLAN NOTES

- VERIFY ALL ROUGH OPENING DIMENSIONS FOR
 ALL WINDOWS AND DOORS
- 2) PROVIDE SAFETY GLAZING WITHIN 24" FROM EXIT PER FLORIDA BUILDING CODE R 308.4.2.
- 3) PROVIDE SAFETY GLAZING AT BATH/ SHOWER PER FLORIDA BUILDING CODE R 308.4.5.
- 4) NON BEARING INTERIOR FRAME WALLS SHALL BE FRAMED W/ WOOD OR METAL STUDS. SPACING SHALL NOT EXCEED 24" O.C. (NON BEARING WALLS ONLY)
- 5) PROVIDE DEAD WOOD IN ATTIC FOR OVERHEAD GARAGE DOOR HARDWARE
- 6) KITCHEN KNEE WALL TO BE FRAMED W/ TOP @ 34 1/2" A.F.F.
- 7) INSTALL SMOOTH WALLS IN KITCHEN AND ALL BATHROOM AREAS
- 8) WHERE DRYWALL CEILING IS APPLIED TO TRUSSES @ 24" O.C. USE 5/8" DRYWALL OR 1/2" SAG RESISTANT PER SEC. 702.3.5
- 9) THE GARAGE SHALL BE SEPARATED FROM THE
 RESIDENCE & ATTIC BY NOT LESS THEN 1/2" GYPSUM
 BOARD APPLIED TO THE GARAGE SIDE. GARAGES
 BENEATH HABITABLE ROOMS SHALL BE SEPARATED
 WITH NOT LESS THAN 5/8" TYPE "X" GYPSUM BOARD
 OR EQUIVALENT. WHERE THE SEPARATIION IS A
 FLOOR CEILING ASSEMBLY, THE STRUCTURE
 SUPPORTING THE SEPARTION SHALL ALSO BE
 PROTECTED BY NOT LESS THAN 1/2" GYPSOM BOARD
 OR EQUIVALENT
- 10) INSTALL I 3/8" THICK SOLID WOOD DOOR BETWEEN LIVING AND GARAGE PER FLORIDA BUILDING CODE R302.1.5.
- 11) ALL WINDOWS INSTALLED 72" ABOVE GRADE MUST COMPLY WITH RG12.2 MIN 24" SILL HEIGHT OR PROVIDED WITH AN APPROVED WINDOW FALL PRVENTION DEVICE
- 12) ALL CLOSET SHELVES TO BE 12". ALL PANTRY \$
 LINEN TO BE (4)-16" SHELVES 18" O.F.F. W/ 15"
 INCREMENT.


CABINET BACKING		
KITCHEN	UPPER TOP @ 84"	BASE TOP @ 35"
MASTER BATH	UPPER	BASE TOP @ 35"
GUEST BATH	UPPER	BASE TOP @ 31"
LAUNDRY ROOM	UPPER TOP @ 84"	BASE

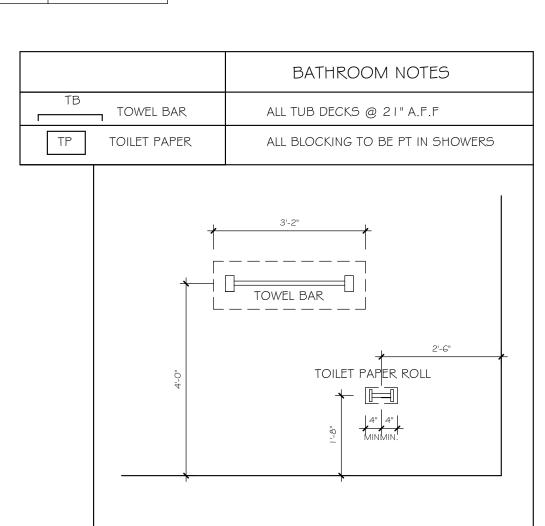


SQUARE FOOTAGE

LIVIN	IG AREA	2416 SF
LANA	AI AREA	211 SF
GAR	AGE AREA	604 Sf
ENTR	RY AREA	98 Sf
TOTA	AL AREA	3330 Sf

INTERIOR DOOR SCHEDULE						
MARK	DOOR WIDTH	NOTES				
	3'-0"	P.K. = POCKET DOOR				
2	2'-10"	B.F. = BI-FOLD DOOR				
3	2'-8"	D.1 DI-1 OLD DOOK				
4	2'-6"	B.P. = BI-PASS DOOR				
5	2'-4"	L.V. = LOUVERED DOOR				
6	2'-0"					
7	1'-8"					
8	1'-6"					

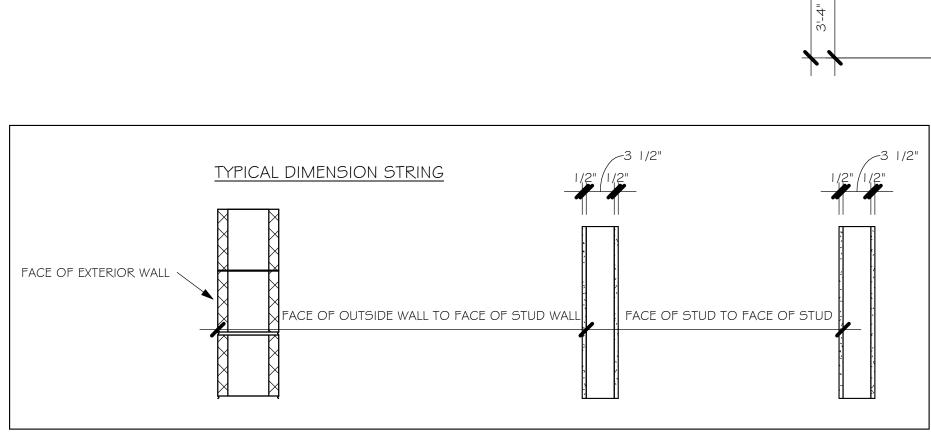

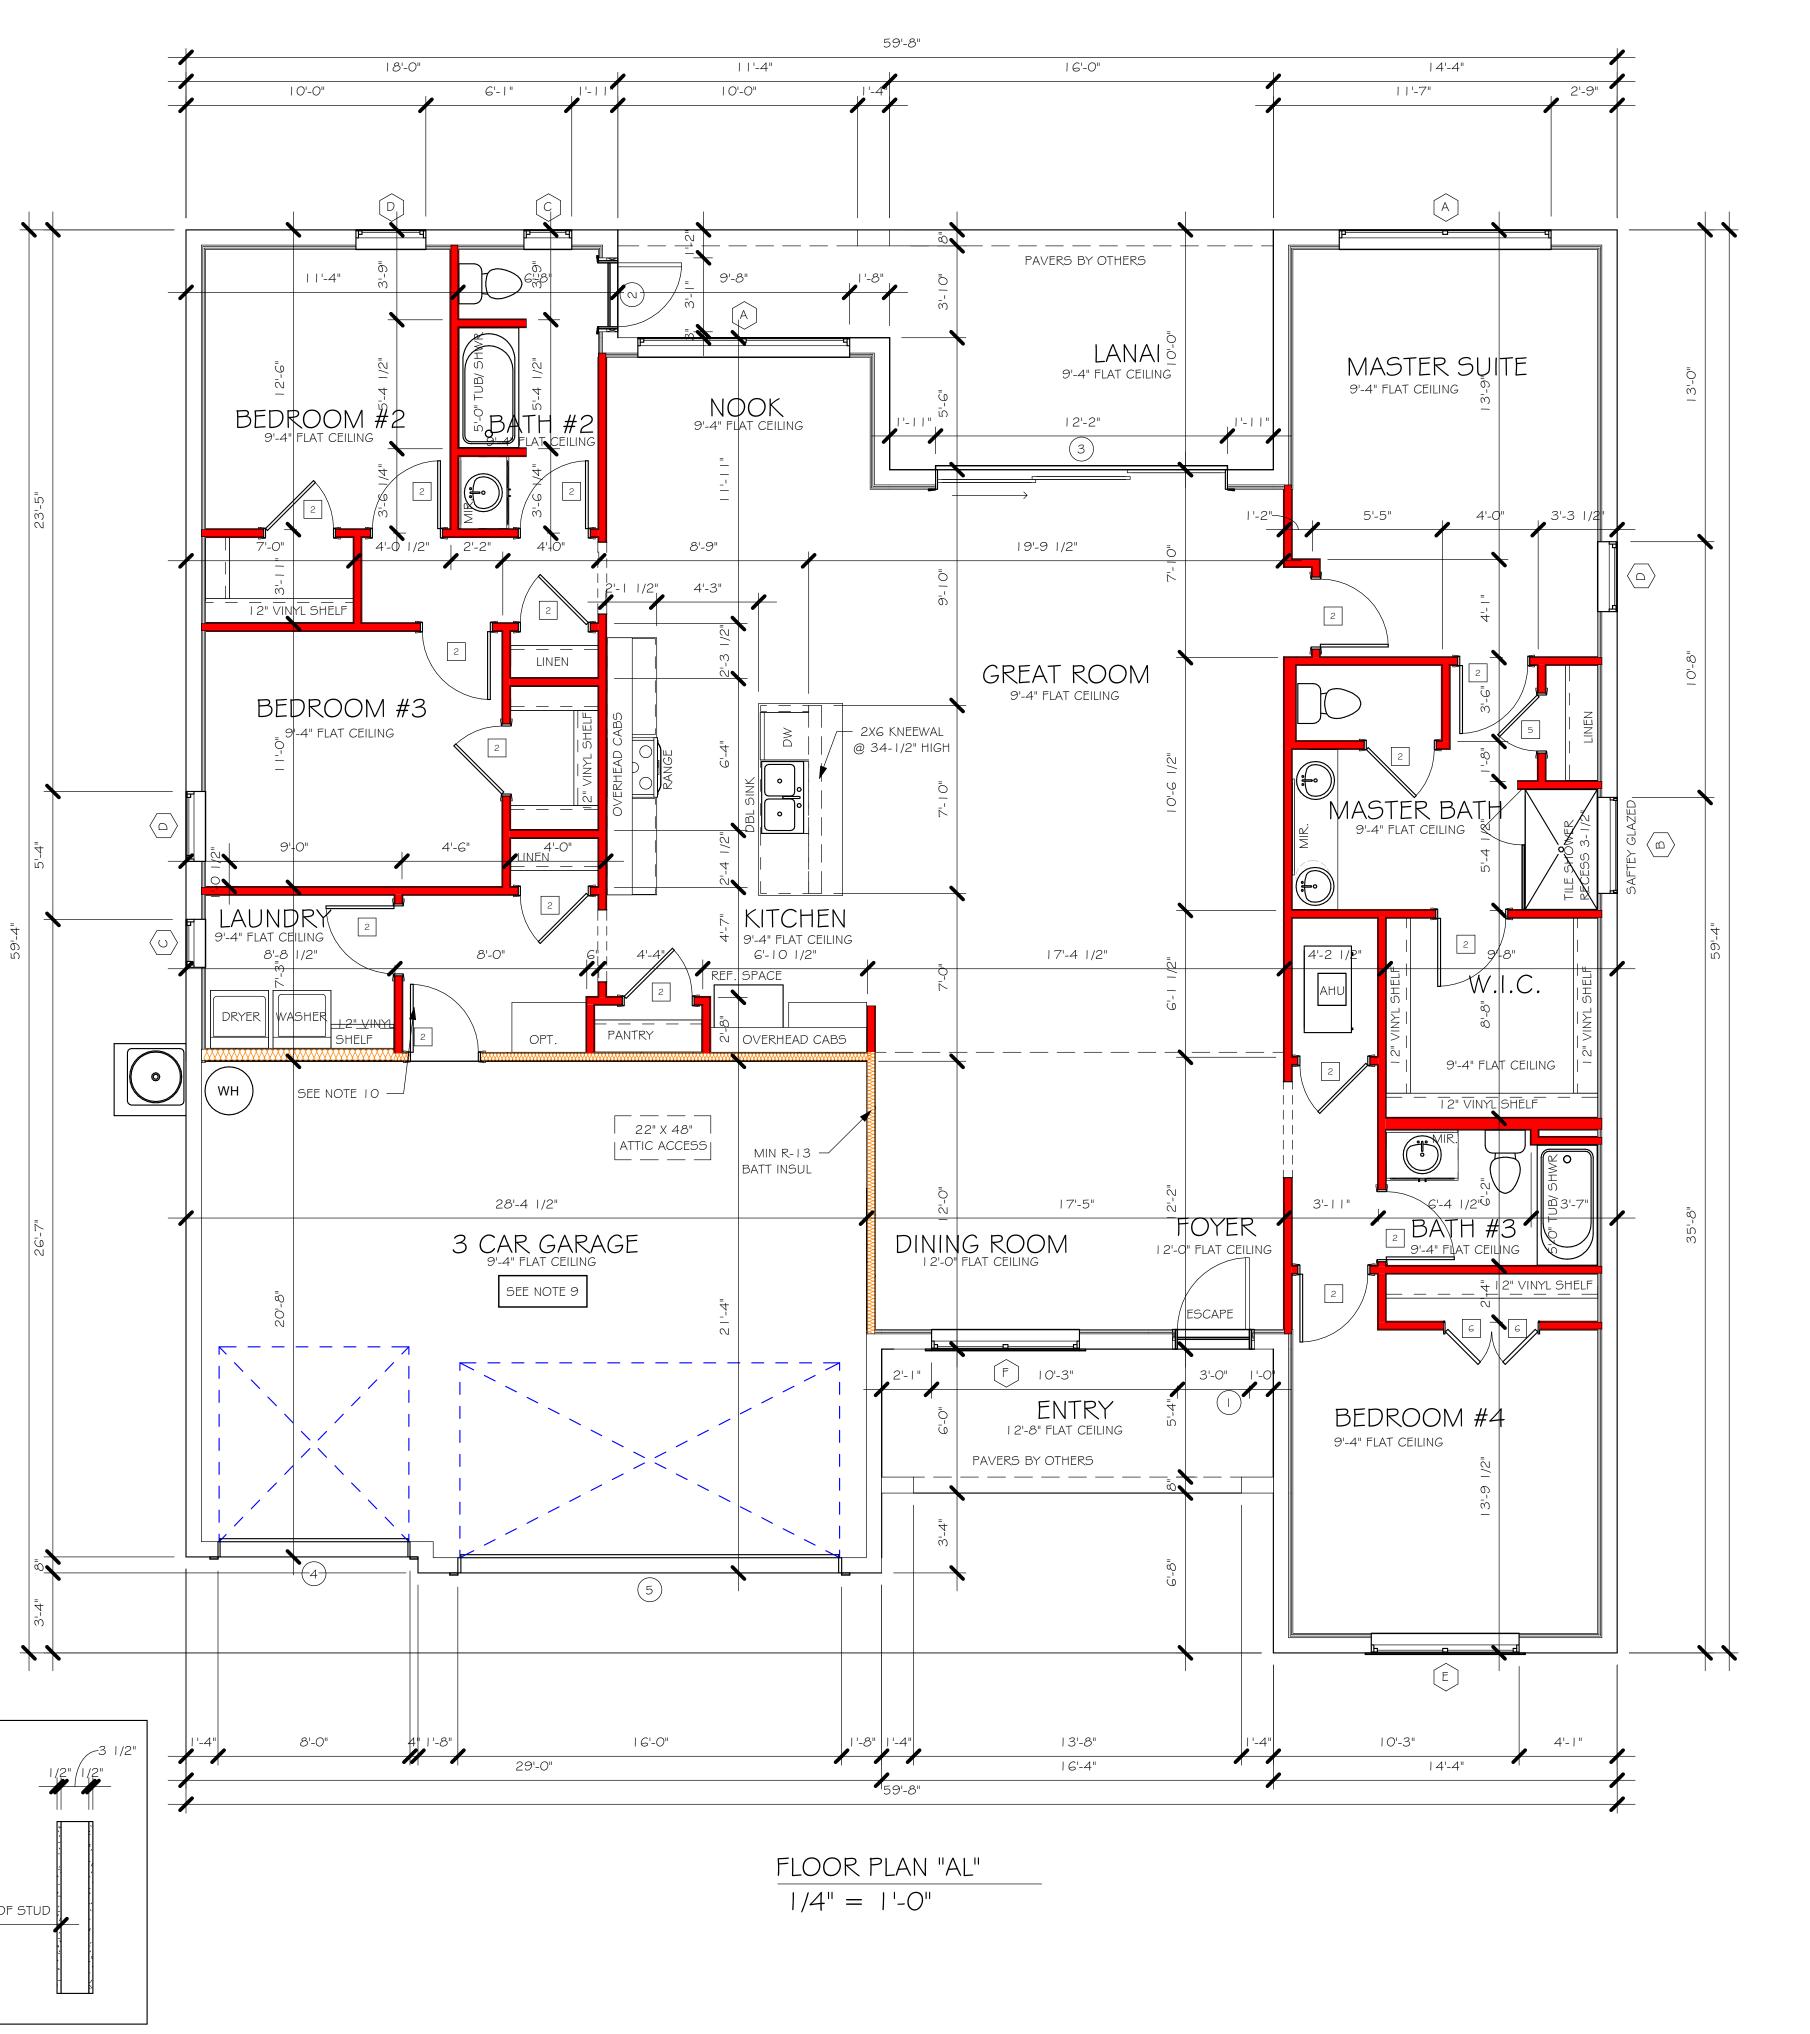

Ш

 $\sum_{i=1}^{n}$

DATE:

DRAWN BY:

CHECKED BY:

REVISED:

SCALE:

DESIGN IN ACCORDANCE WITH THE RESIDENTIAL FLORIDA BUILDING CODE 2017 - 6TH EDITION


03/27/19


JWC

FLOOR

As indicated

A-3 AL

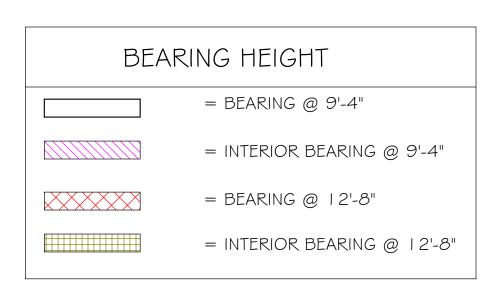

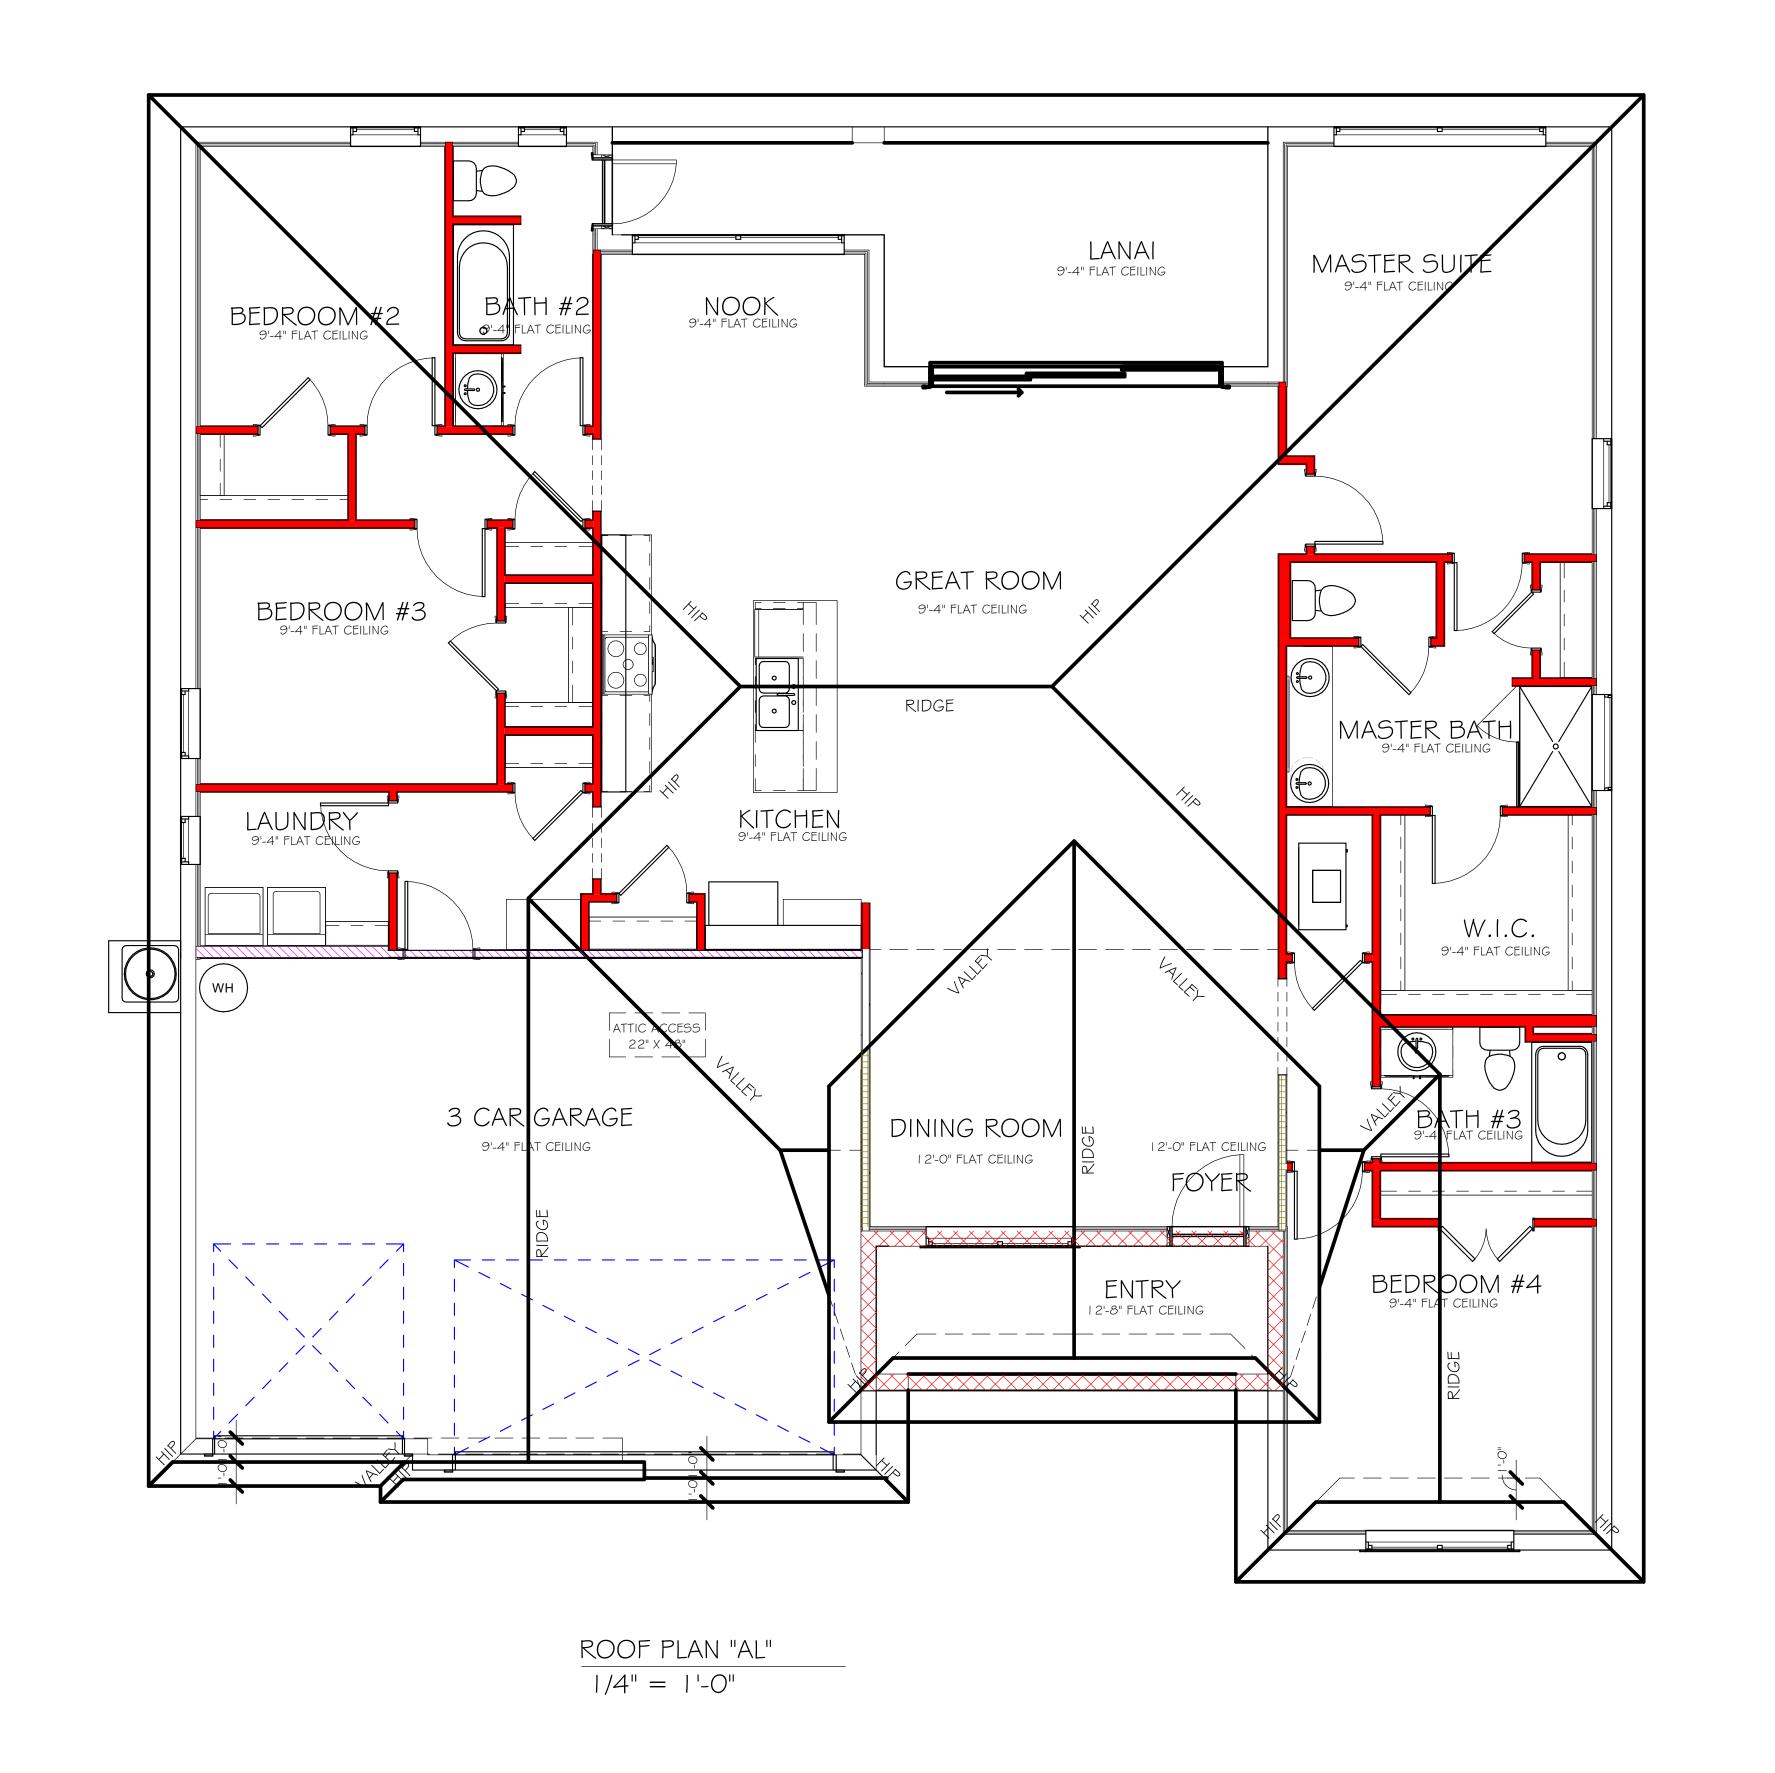

DESIGN IN ACCORDANCE WITH THE RESIDENTIAL FLORIDA BUILDING CODE 2017 - 6TH EDITION

MODEL

DATE:

DRAWN BY:

CHECKED BY:

REVISED:

PLAN:

SCALE:


03/27/19


JWC

ROOF

As indicated

A-4 AL

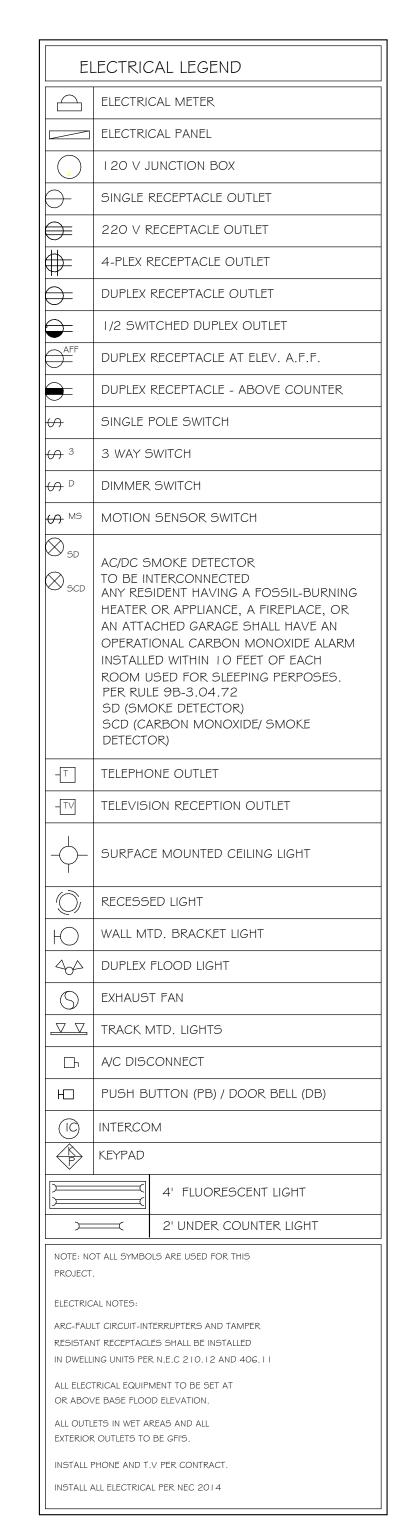

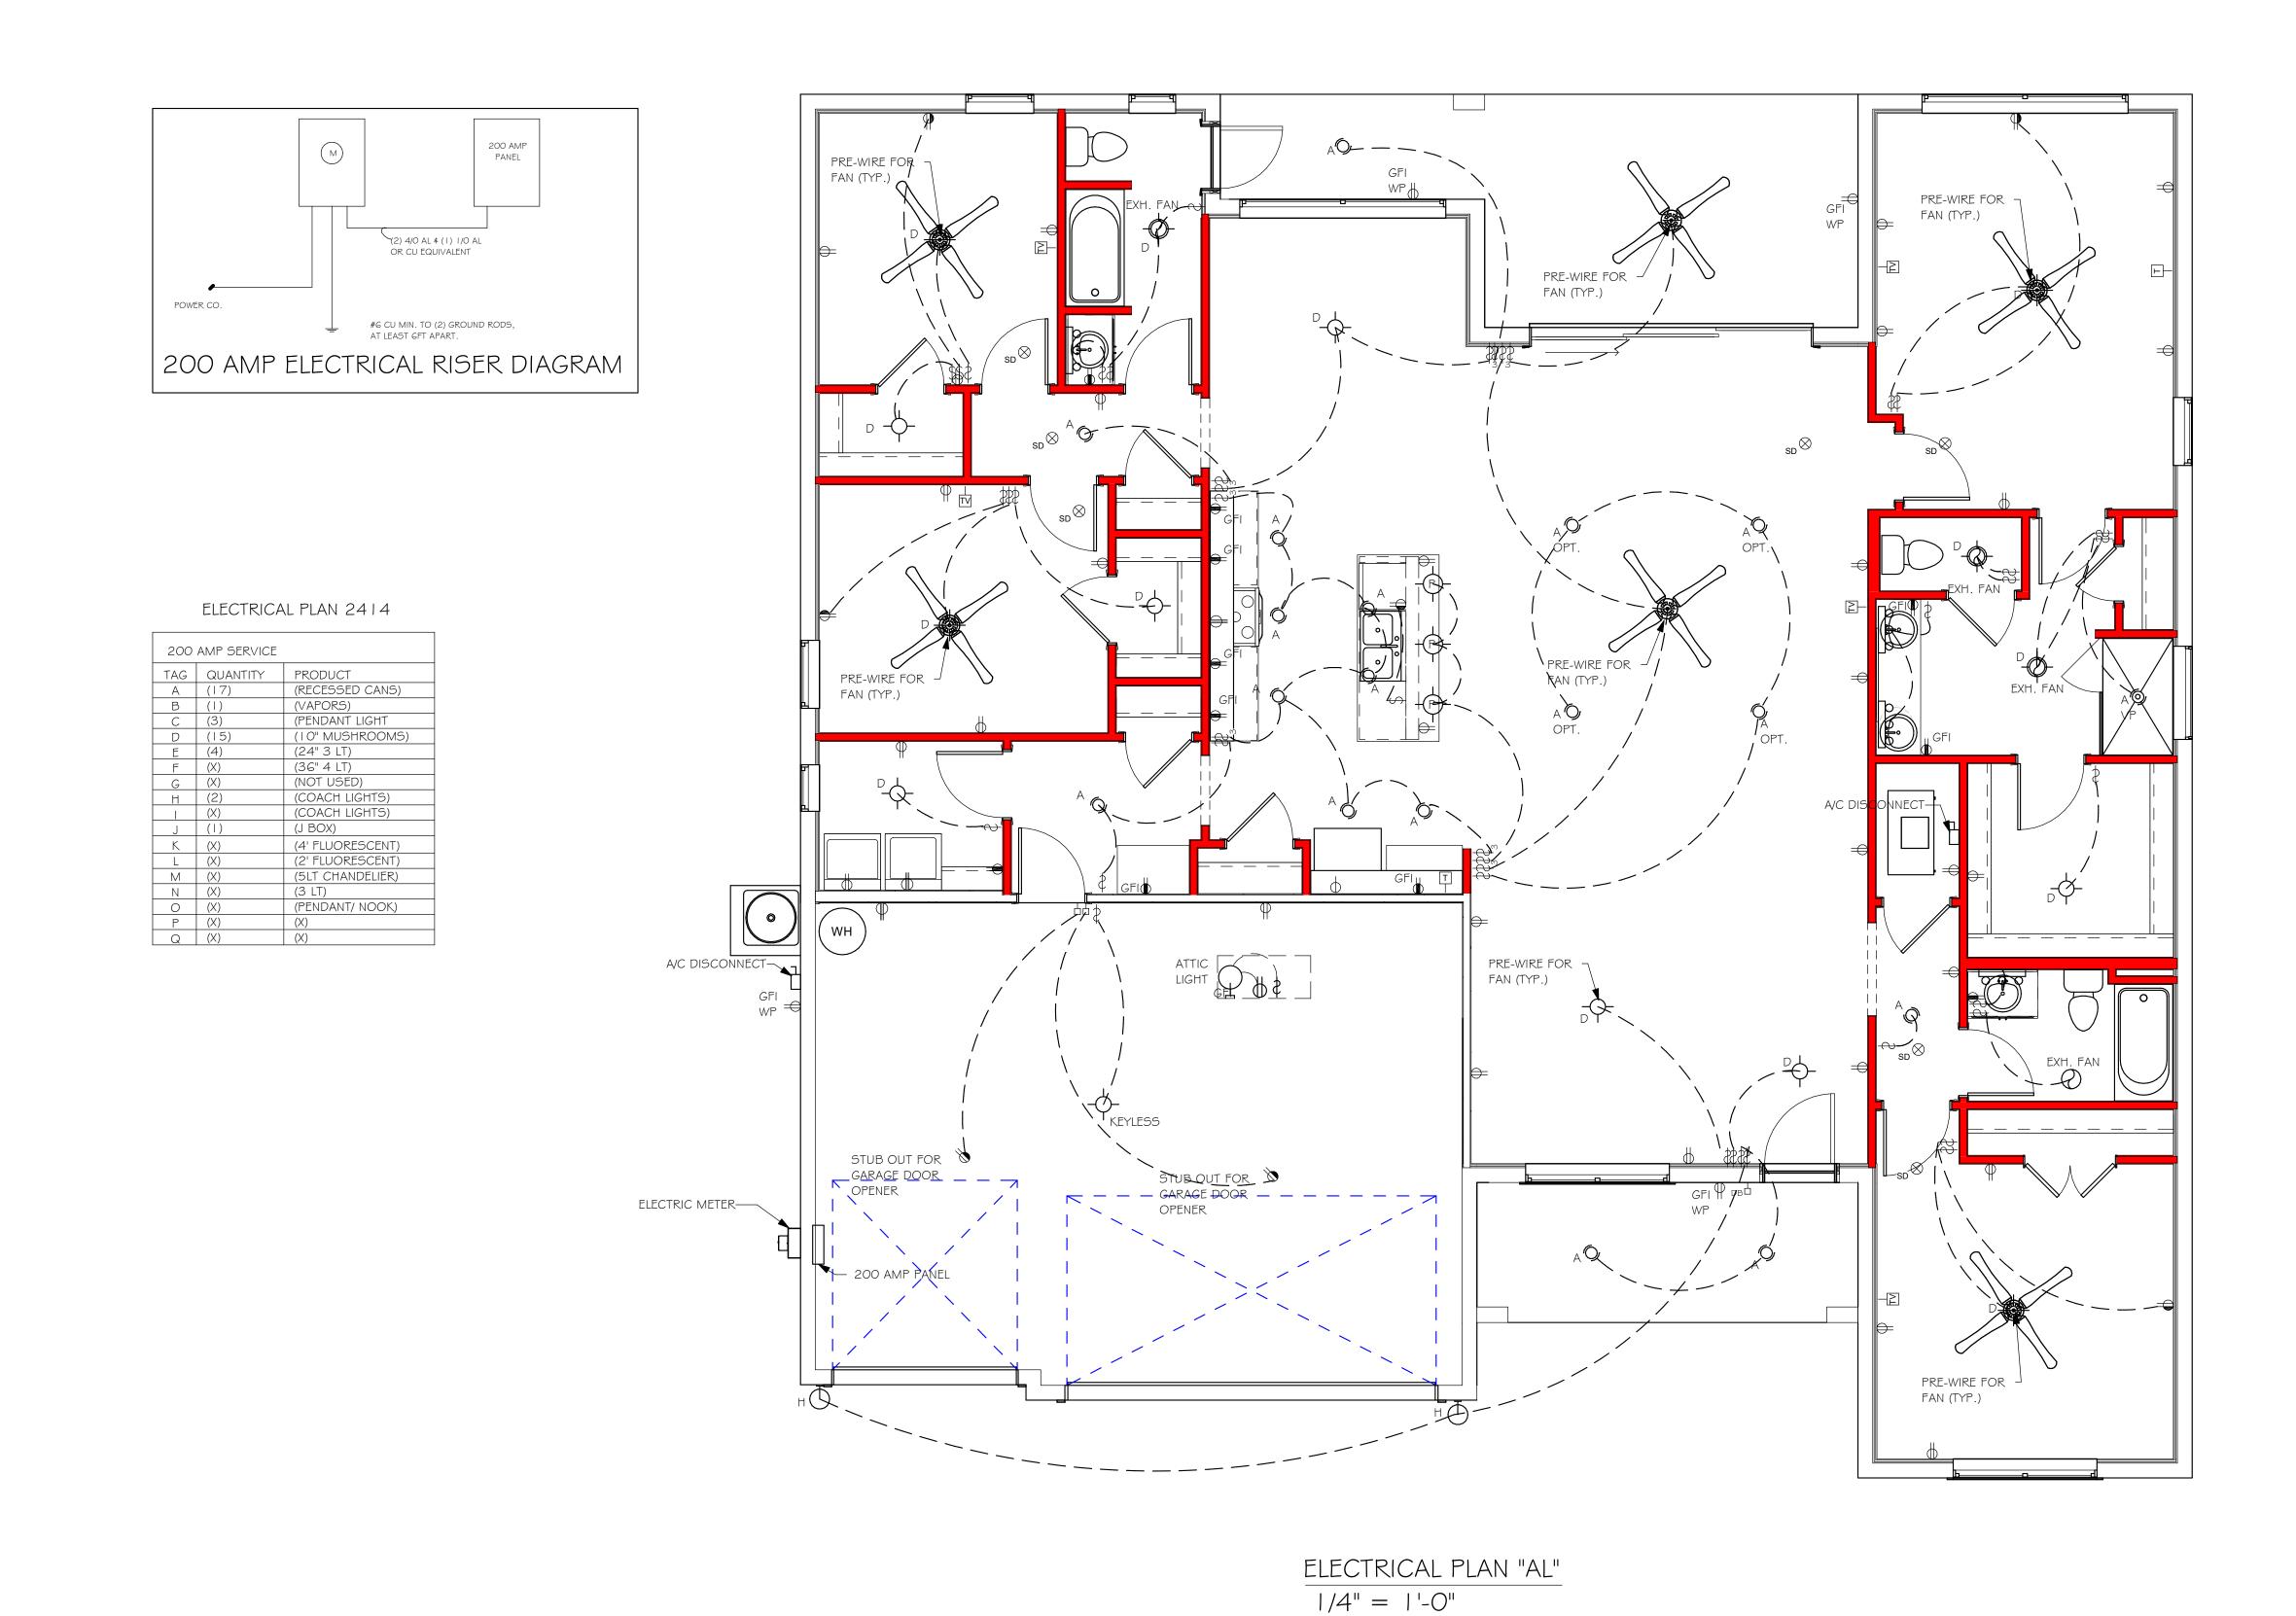



MODEL DATE: 03/27/19 DRAWN BY: CHECKED BY: JWC REVISED: PLAN: ELECTRICAL SCALE:

As indicated

A-5 AL

DESIGN IN ACCORDANCE WITH THE RESIDENTIAL FLORIDA BUILDING CODE 2017 - 6TH EDITION

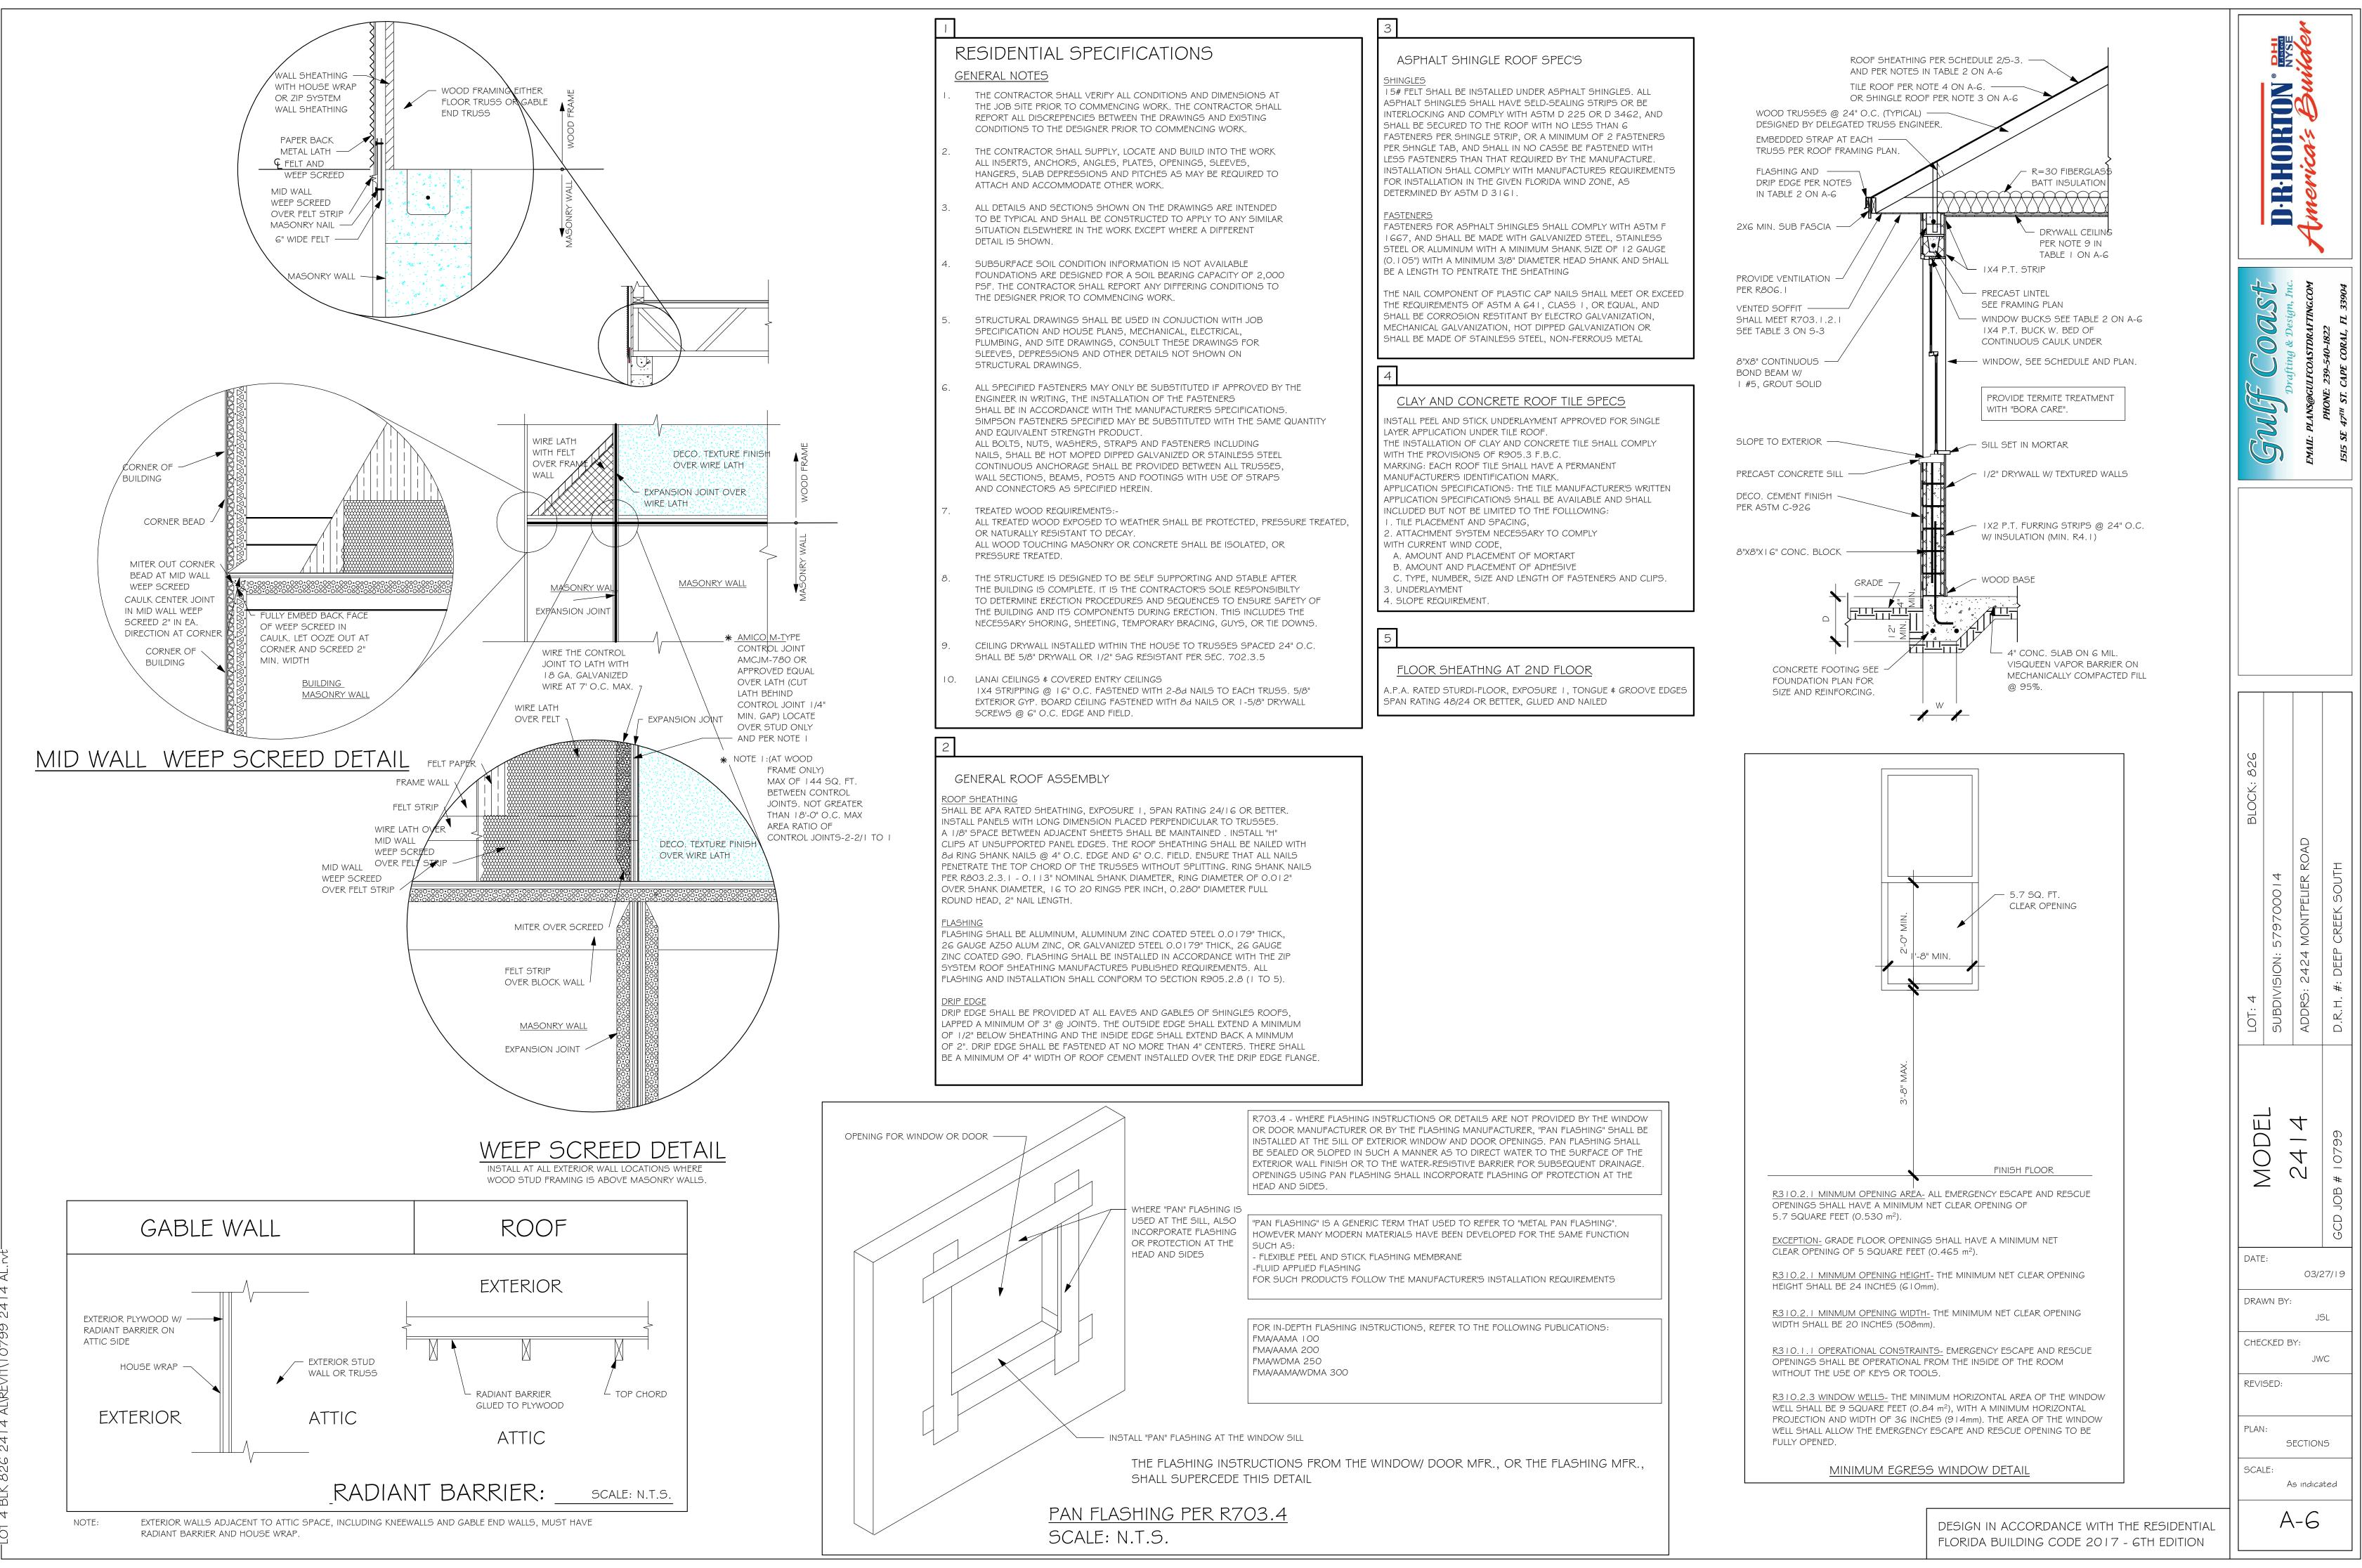

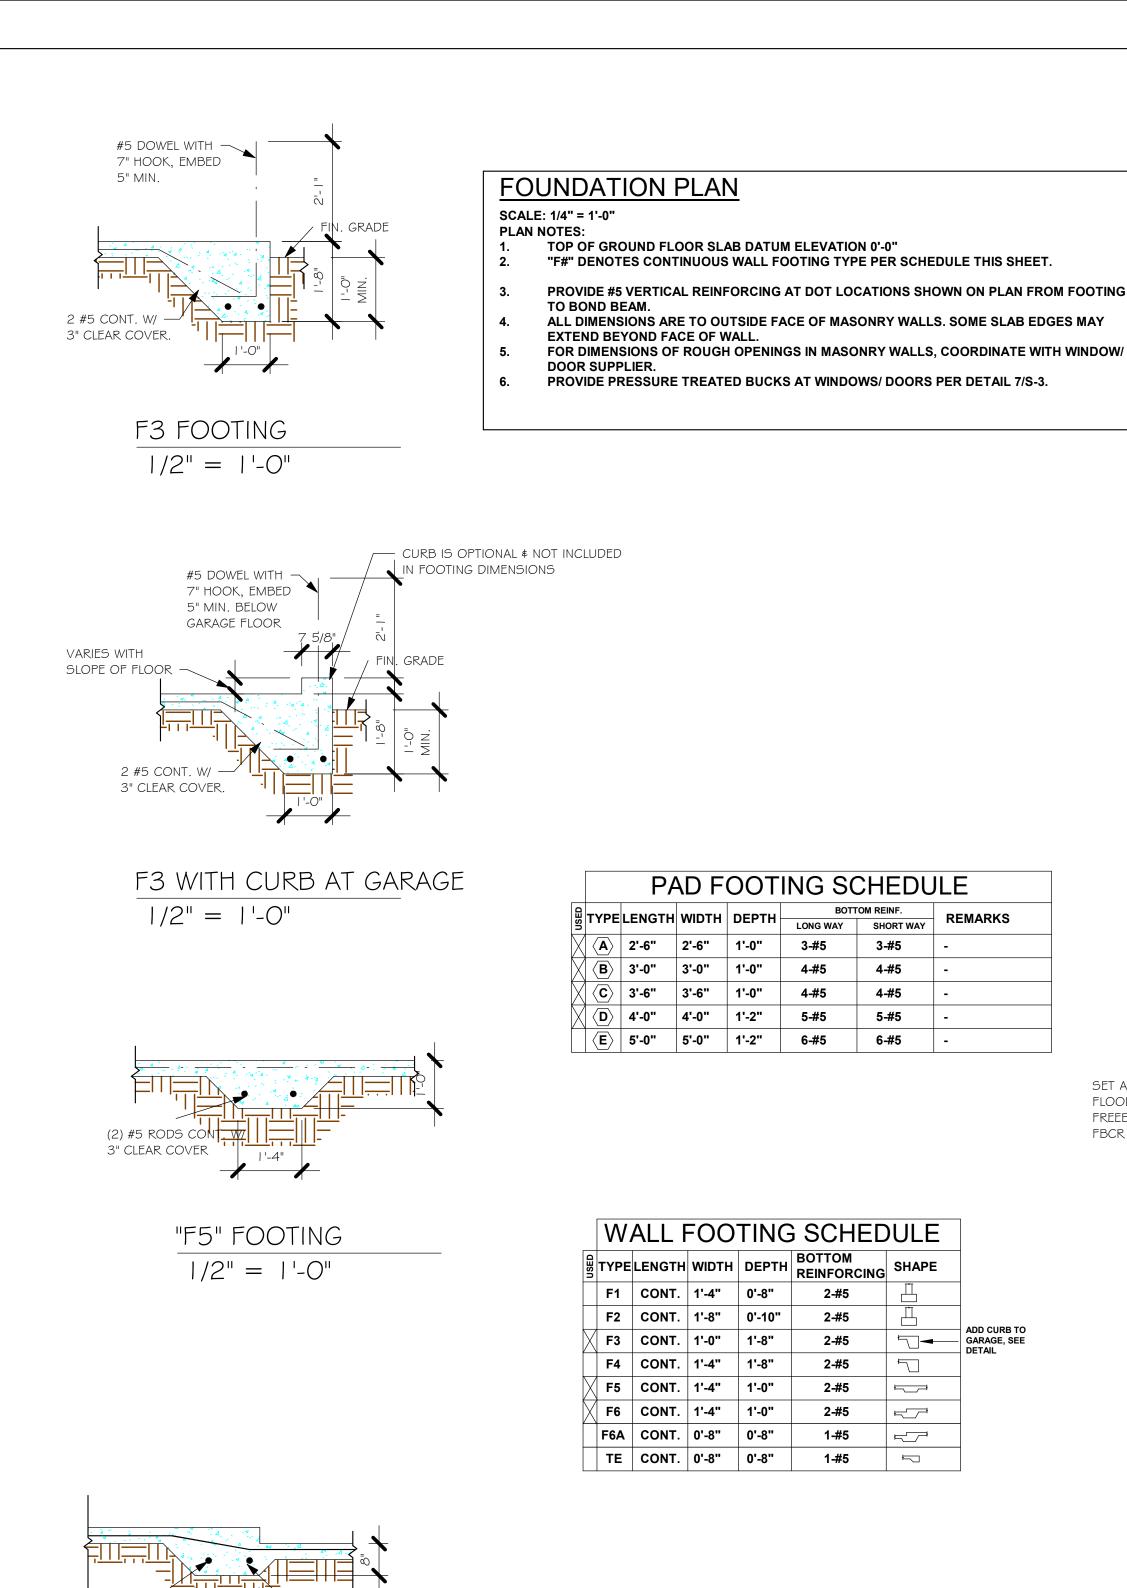

4-#5


5-#5

GARAGE, SEE

2-#5

2-#5

1-#5

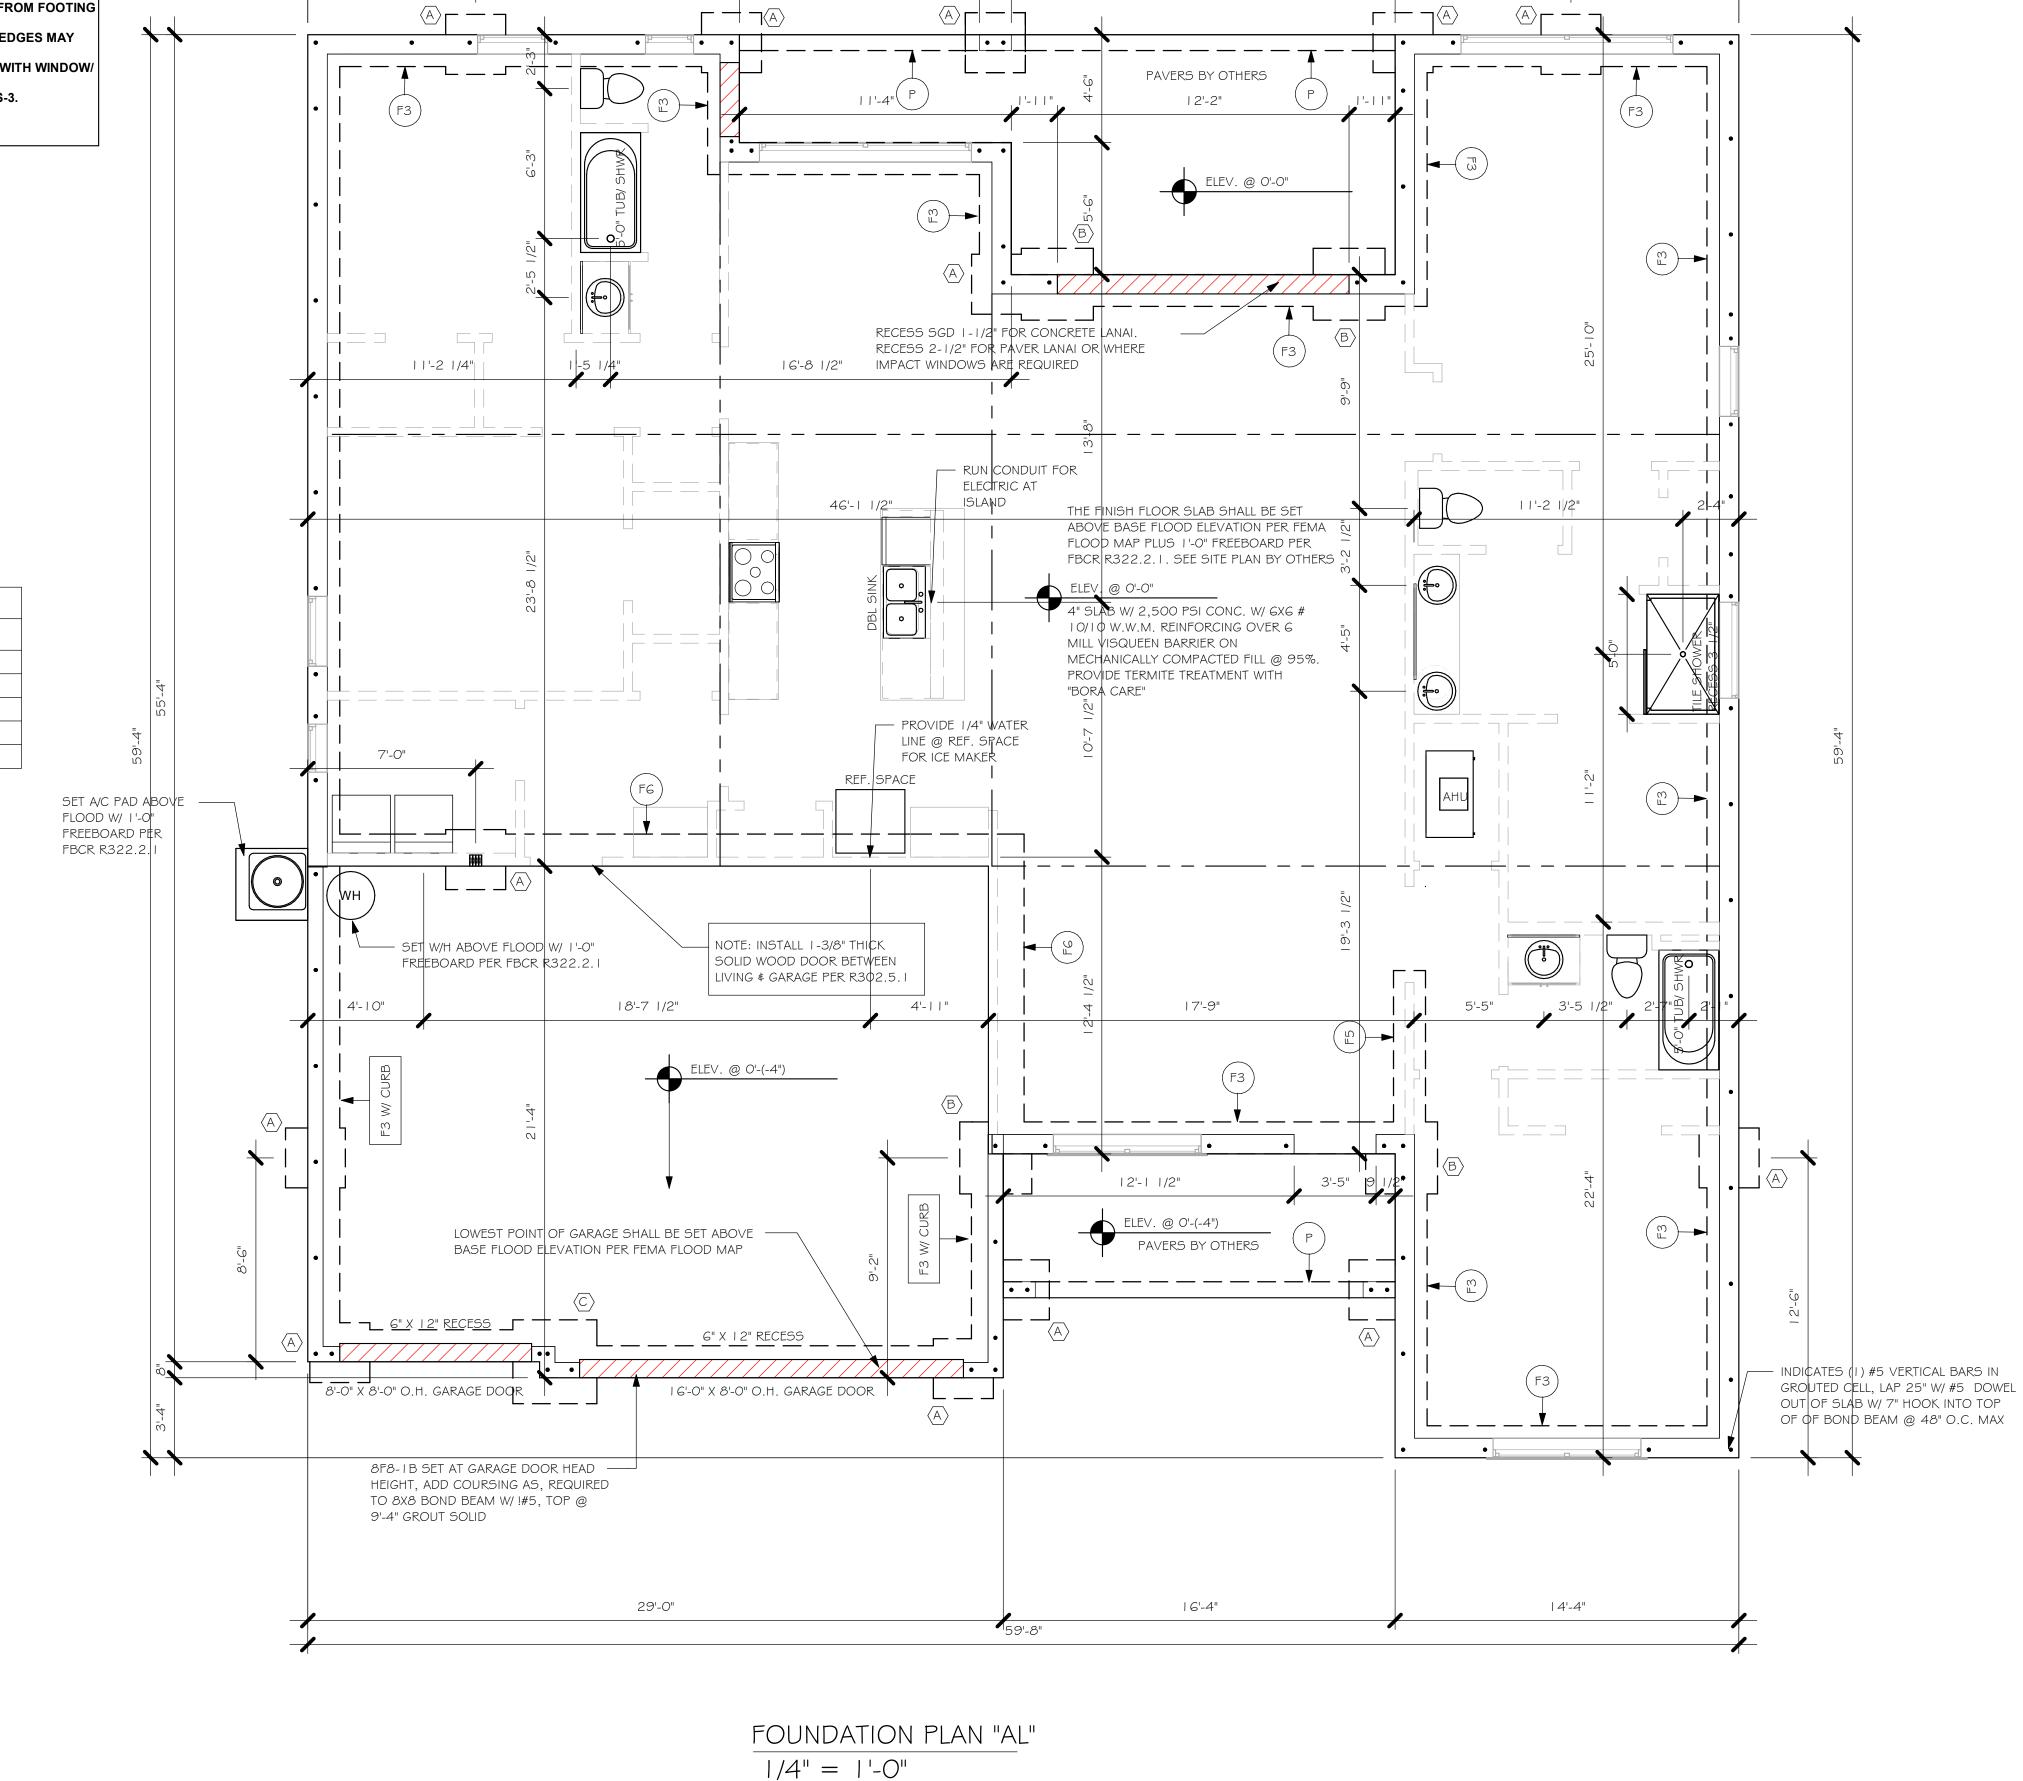


59'-8"

16'-0"

7'-0"

F6 STEP DOWN 1/2" = 1'-0"

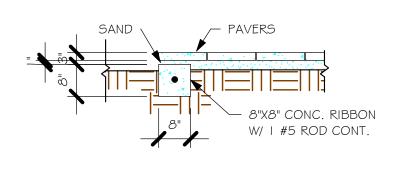

"P" PAVERS DETAIL ENTRY/LANAI 1/2" = 1'-0"

DESIGN IN ACCORDANCE WITH THE RESIDENTIAL FLORIDA BUILDING CODE 2017 - 6TH EDITION

MODEL

DATE:

DRAWN BY:

CHECKED BY:

FOUNDATION PLAN

As indicated

S-I AL

REVISED:

SCALE:

03/27/19


JWC


TRUSS STRAPPING TO MASONRY				
MAX TRUSS UPLIFT @ 24" OC (LBS)	CONNECTOR	FASTENER		
► 1615 1870 2430 (1 PLY) 2800 (2 PLY) 3170 (2 PLY) 5005	(1) HTA16-18 (1) HTA20 (2)HTA16-18 (2)HTA16-18 (2) HTA20 HTT45	10-10dx1/2", EMBED 4" 10-10dx1/2", EMBED 4" 10-10dx1/2", EMBED 4" 10-10dx1/2", EMBED 4" 10-10dx 1/2", EMBED 4" 5/8"ø ATR, EPOXY 12"		

- PROVIDE A STRAP FROM THE ABOVE LIST AT EACH ROOF TRUSS BEARING POINT, BASED ON THE TRUSS UPLIFT VALUES IN THE SIGNED AND SEALED TRUSS DESIGN PACKAGE AND SUITABLE FOR THE GEOMETRY. EMBED STRAP ON -C/L OF WALL.
- CONNECTORS ARE USP STRUCTURAL CONNECTORS. ALL CONNECTORS SHALL BE INSTALLED IN STRICT ACCORDANCE WITH USP PRINTED INSTUCTIONS. SUBSTITUTIONS MUST BE APPROVED IN WRITING BY THE ENGINEER OF RECORD.
- WHERE EMBEDDED STRAPS ARE MISSING, OR MIS-LOCATED, INSTALL RETROFIT STRAP PER 2/S-4.
- 'ATR' = ALLTHREAD. DRILL AND EPOXY WITH USP EPOXY PER MFR. INSTRUCTIONS.

INSTALL AT ALL	TRUSS STRAPPING TO	O STUDWALL/ WOOD BE	AM
TRUSSES TO 1005 Ib UPLIFT.	MAX TRUSS UPLIFT @ 24" OC (LBS)	CONNECTOR	FASTENER
FOR HIGHER UPLIFTS, SEE NOTES ON PLAN.	1005 2010 3015 1285 2570 3855 5140	(1)MTW16 (2) MTW16 (3) MTW16 (1) HTW20 (2) HTW20 (3) HTW20 (4) HTW20	2- OdX ~ /2" 2- OdX ~ /2" 2- OdX ~ /2" 24- OdX ~ /2" 24- OdX ~ /2" 24- OdX ~ /2" 24- OdX ~ /2"


- I. PROVIDE A STRAP FROM THE ABOVE LIST AT EACH ROOF TRUSS BEARING
- POINT, BASED ON THE TRUSS UPLIFT VALUES IN THE SIGNED AND SEALED TRUSS DESIGN PACKAGE.
- CONNECTORS ARE USP STRUCTURAL CONNECTORS. ALL CONNECTORS SHALL BE INSTALLED IN STRICT ACCORDANCE WITH USP PRINTED

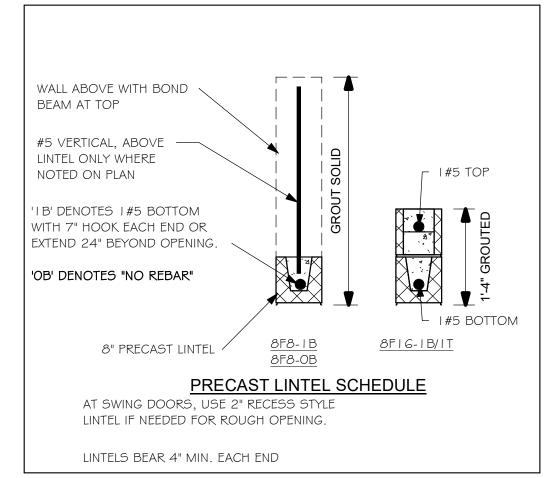

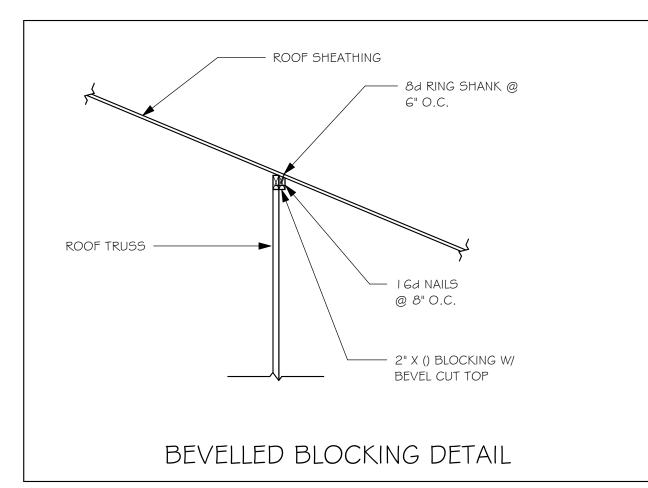


PLAN NOTES:

- ROOF TRUSS BEARING ELEVATION VARIES, SEE LEGEND.
- ROOF FRAMING SHALL BE WOOD TRUSSES DESIGNED BYA DELEGATED TRUSS ENGINEER PER DESIGN CRITERIA ON SHEET S-3.
- FOR NAILING OF ROOF DECK, SEE I AND 2 ON S-3. 8F8-1B etc., DENOTES PRECAST LINTEL ABOVE
- DOOR/WINDOW OPENING PER SCHEDULE THIS SHEET. AT TRUSS BEARING, PROVIDE 8x8 MASONRY BOND BEAM W/ I #5 CONTINUOUS, SEE DETAIL I I/S-3.

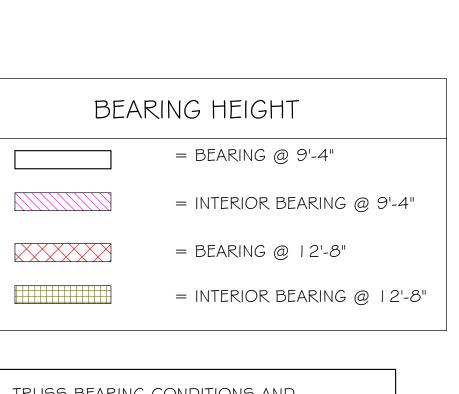

TRUSS BEARING CONDITIONS AND STRAPPING IS BASED ON TRUSS LAYOUT PREPARED BY SCOSTA JOB# 44142 DATED: 08/15/18 REVISED: 12/12/18

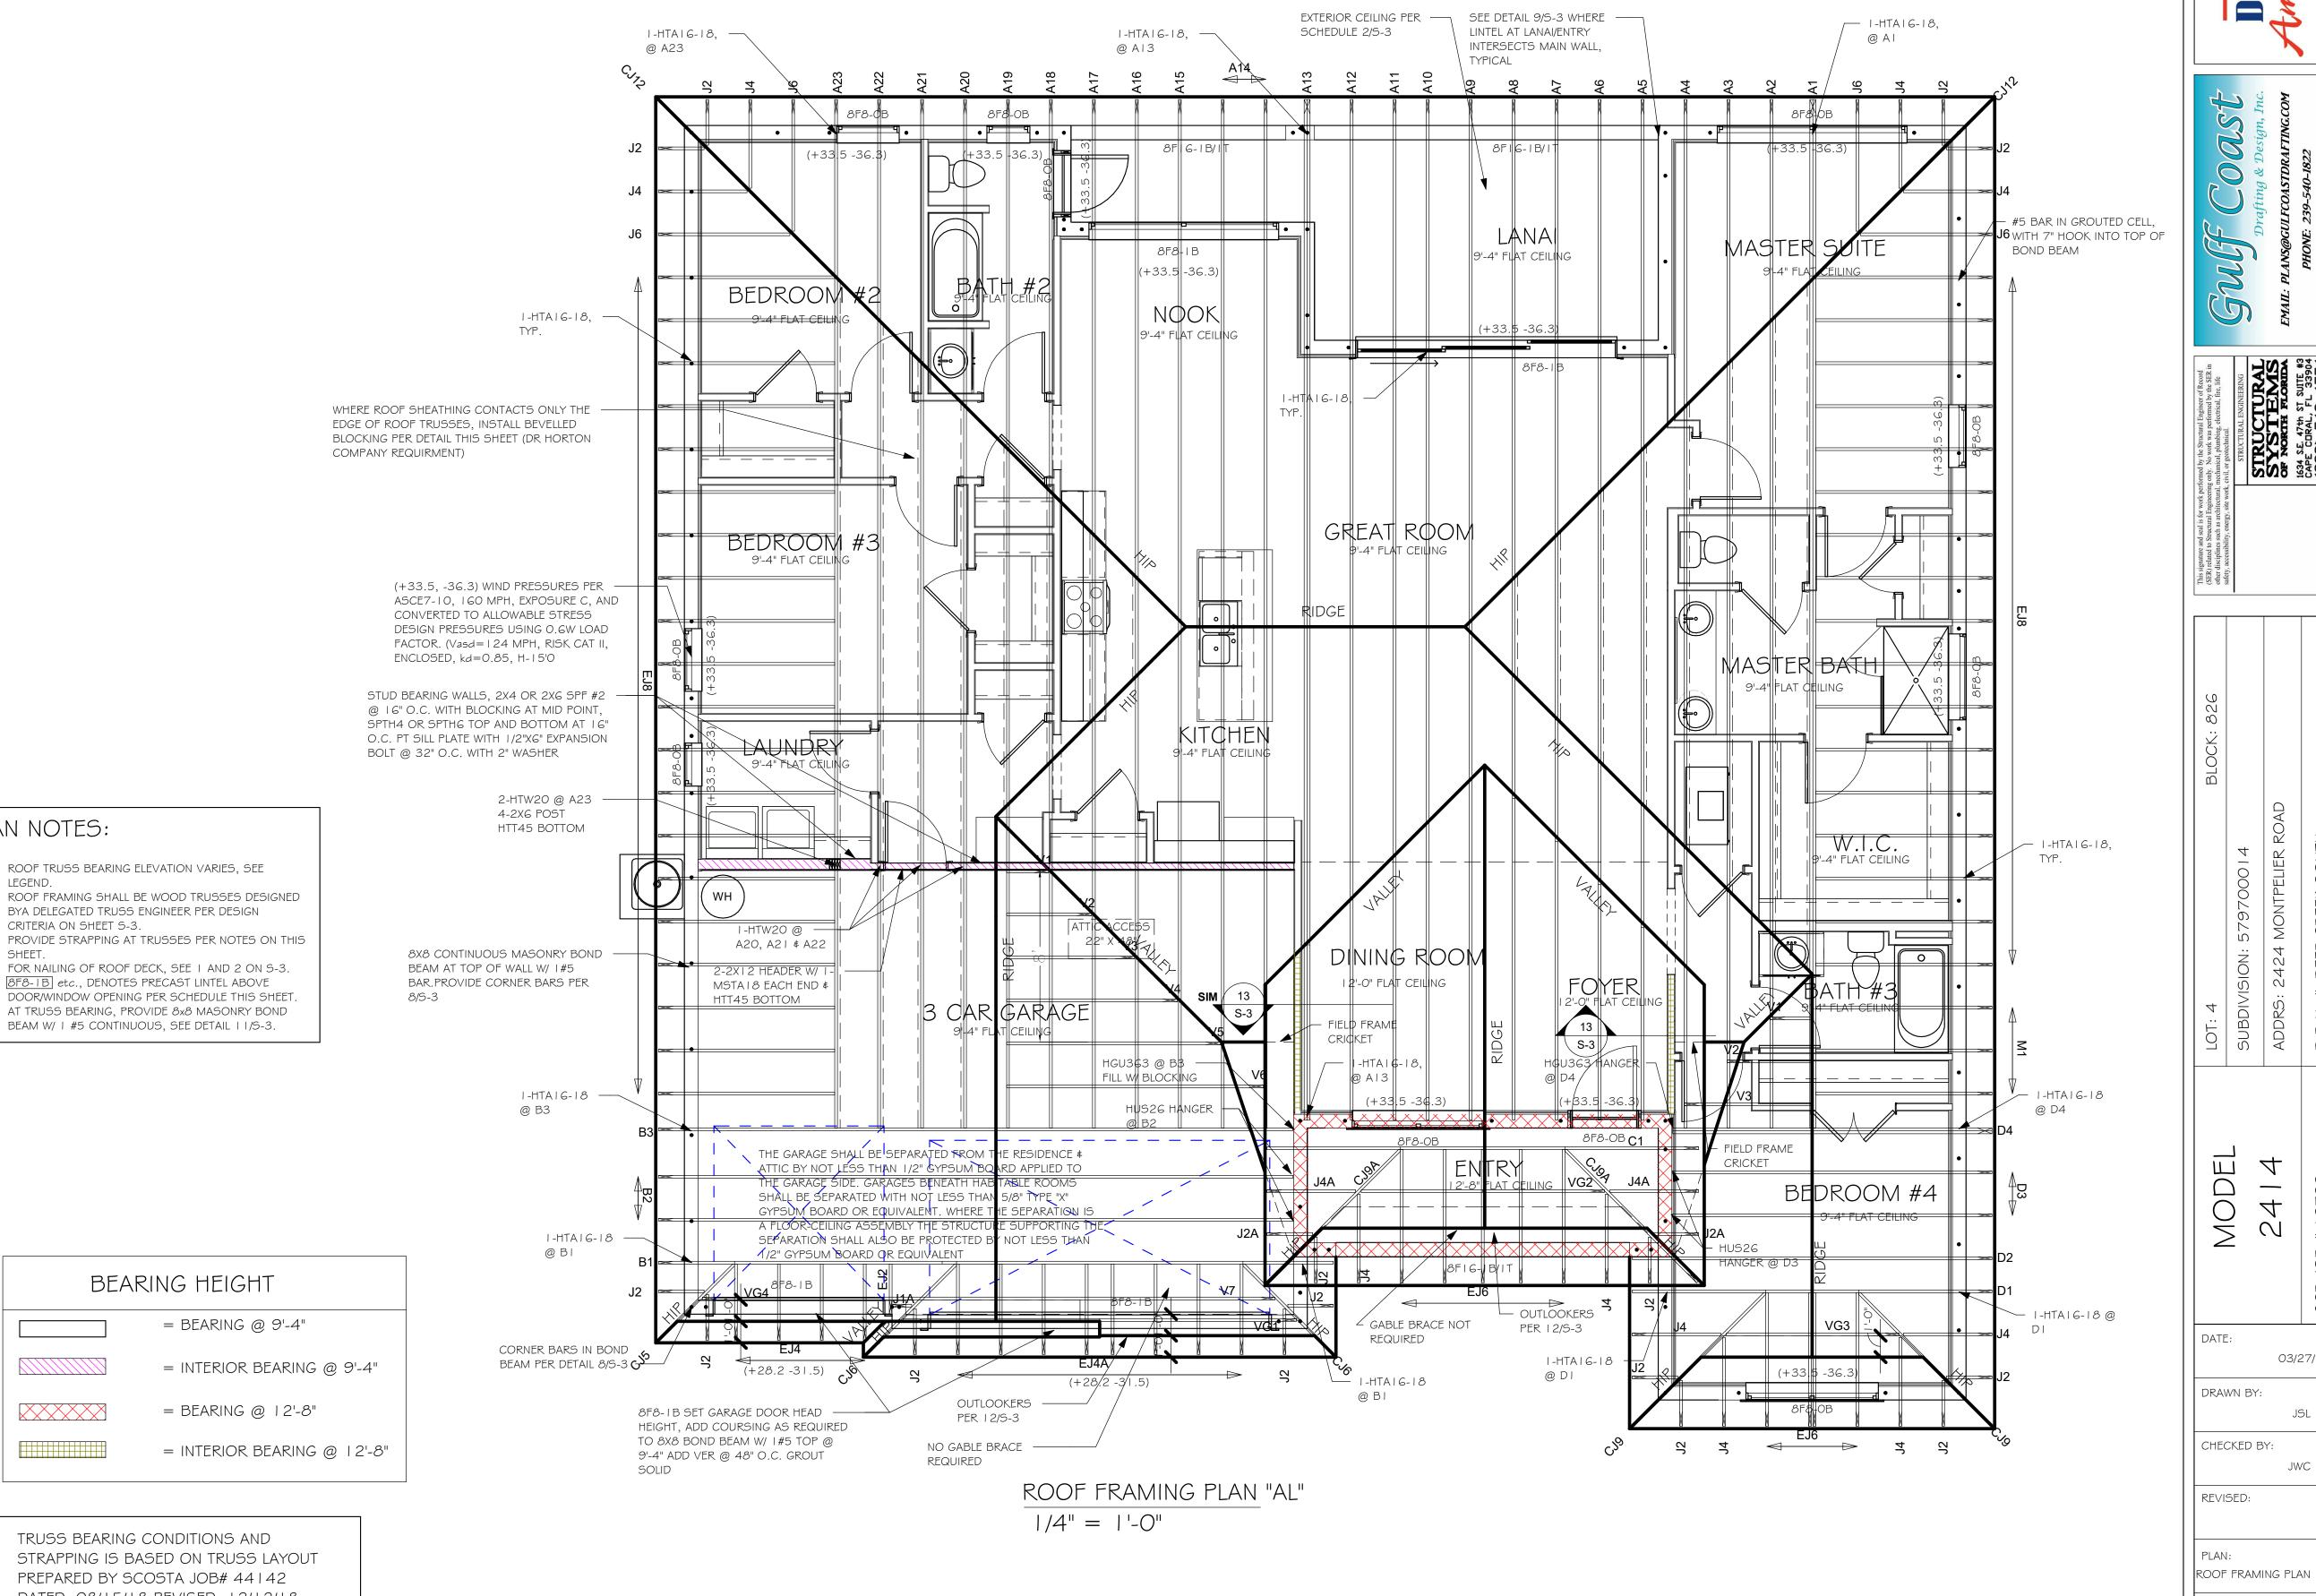

S-2 AL DESIGN IN ACCORDANCE WITH THE RESIDENTIAL FLORIDA BUILDING CODE 2017 - 6TH EDITION


SCALE:

03/27/19

JSL

JWC

As indicated

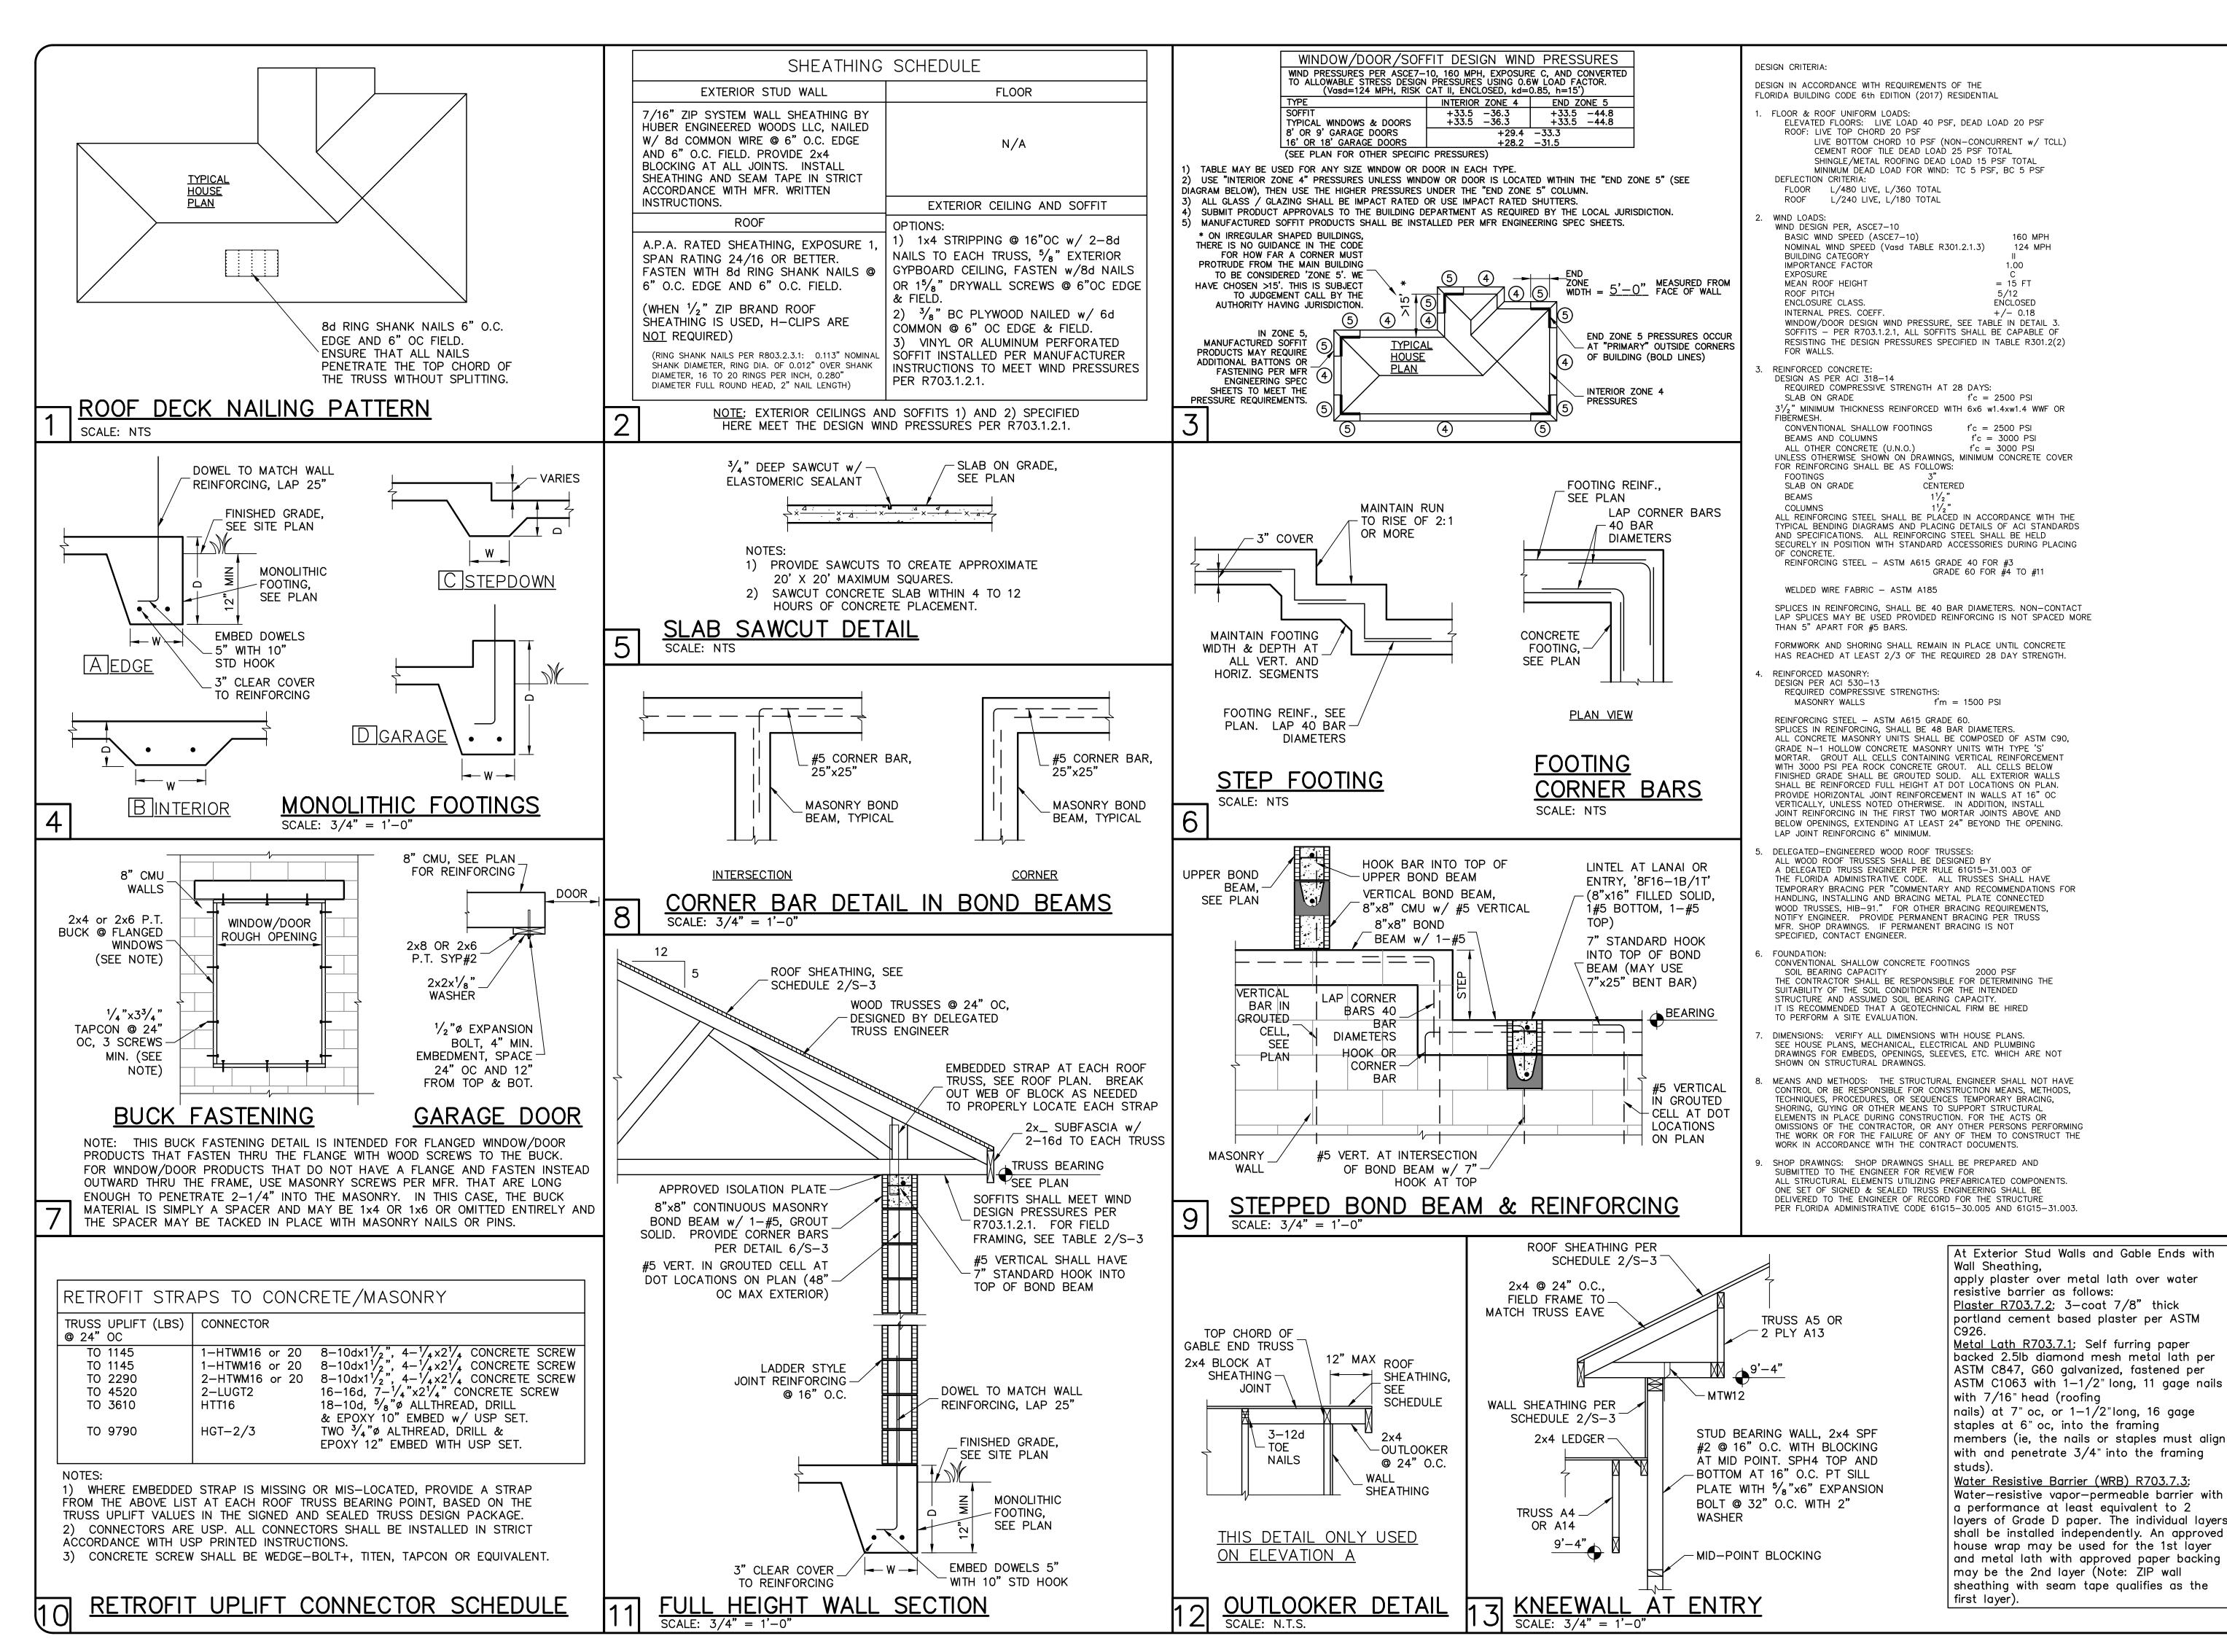

REVISIONS DR10799 SHEET

ORTON D-R-H

PE ROAD CREEK TURAL
DEL 2
2424 MONTPE
PUNTA GORDA
UBDIVICIONI T

DWB/GH CHECKED DWB 03/27/19 SCALE **VARIES** JOB NO.