

\*\*UNLESS NOTED\*\*

REACTION VALUES ARE UNDER 5000#

UPLIFT VALUES ARE UNDER 1000#

#### 

DO NOT ATTEMPT TO ERECT TRUSSES WITH—OUT REFERRING TO THE ENGINEERING DWGS.

IT IS NECESSARY TO REFER TO THE ENGINEERING DRAWINGS FOR NUMBER OF MEMBERS, BEARING LOCATION, ORIENTATION AND WEB BRACING

REFER TO WTCA/TPI BSCI-B1 SUMMARY
SHEET FOR HANDLING METHODS & TEMPORARY
BRACING, WHICH IS ALWAYS REQUIRED

# BEARING HEIGHTS BASED ON PLANS PROVIDED TO SCOSTA CORP. "+/-" BEARING DIFFERENCES SHOWN ARE CRITICAL. IF ANY HEIGHTS DEVIATE — INFORM SCOSTA CORP.

BEARING WALL & BEAM HEIGHTS

	0'-0"	ELEV.
7/////		ELEV.
		ELEV.
******************		ELEV.
HANGER SCHE	DULE	

 C USP HUS 26
 M USP THDH 28-3

 F USP HUS 28
 N USP THD 48

 H USP THDH 28
 P USP JUS 24

 I USP THDH 28-2
 B USP MSH 422

HANGER VALUES HAVE BEEN BASED ON 16D COMMON NAILS EXCEPT THE FOLLOWING LUS24 - 10D COMMON THJA26 - 10D x 1-1/2

# \*\*\*\*\*\*ATTENTION\*\*\*\*\*

W USP HJC 26

APPROVAL OF THIS TRUSS LAYOUT IS NECESSARY BEFORE FABRICATION CAN BEGIN. VERIFY DIMENSIONS, PITCHES, OVERHANGS, ELEVATIONS, CEILING & BEARING CONDITIONS. SCOSTA CORPORATION IS RESPONSIBLE FOR ACCURACY IN ACCORDANCE WITH PLANS AND/OR INFORMATION PROVIDED BY CUSTOMER, WITH ANY DEVIATIONS NOTED HEREIN. CUSTOMER IS RESPONSIBLE TO VERIFY ACCURACY OF INFORMATION AND PLANS PROVIDED TO SCOSTA CORPORATION, AND TO VERIFY CONFORMANCE TO FIELD CONDITIONS, AND/OR OWNER CHANGES. TRUSSES WILL BE BUILT IN ACCORDANCE WITH THE APPROVED LAYOUT.

APPROVED BY: \_\_\_\_\_\_


DATE: \_\_\_\_\_ REQUESTED DELIVERY DATE: \_\_\_\_\_

JOBSITE CONTACT NAME: \_\_\_\_\_


PHONE #: \_\_\_\_\_

E-MAIL:

SCO	STA	C	0	RP.
3	WOOD, STEE! ROOF & FLO  670 COMMERCE SEBRING, (863) 38	OOR TRUS:  E CENTER   FL 33870	SES	
SCALE: 1/4"=1'-0"	DATE: 05/24/18	REVISED BY: KD 09/15		DRAWN BY: KRISTY
	99 A RAGE LEFT		•	1 of 1
D.R. HORT	ON		JOB 44	# 1116

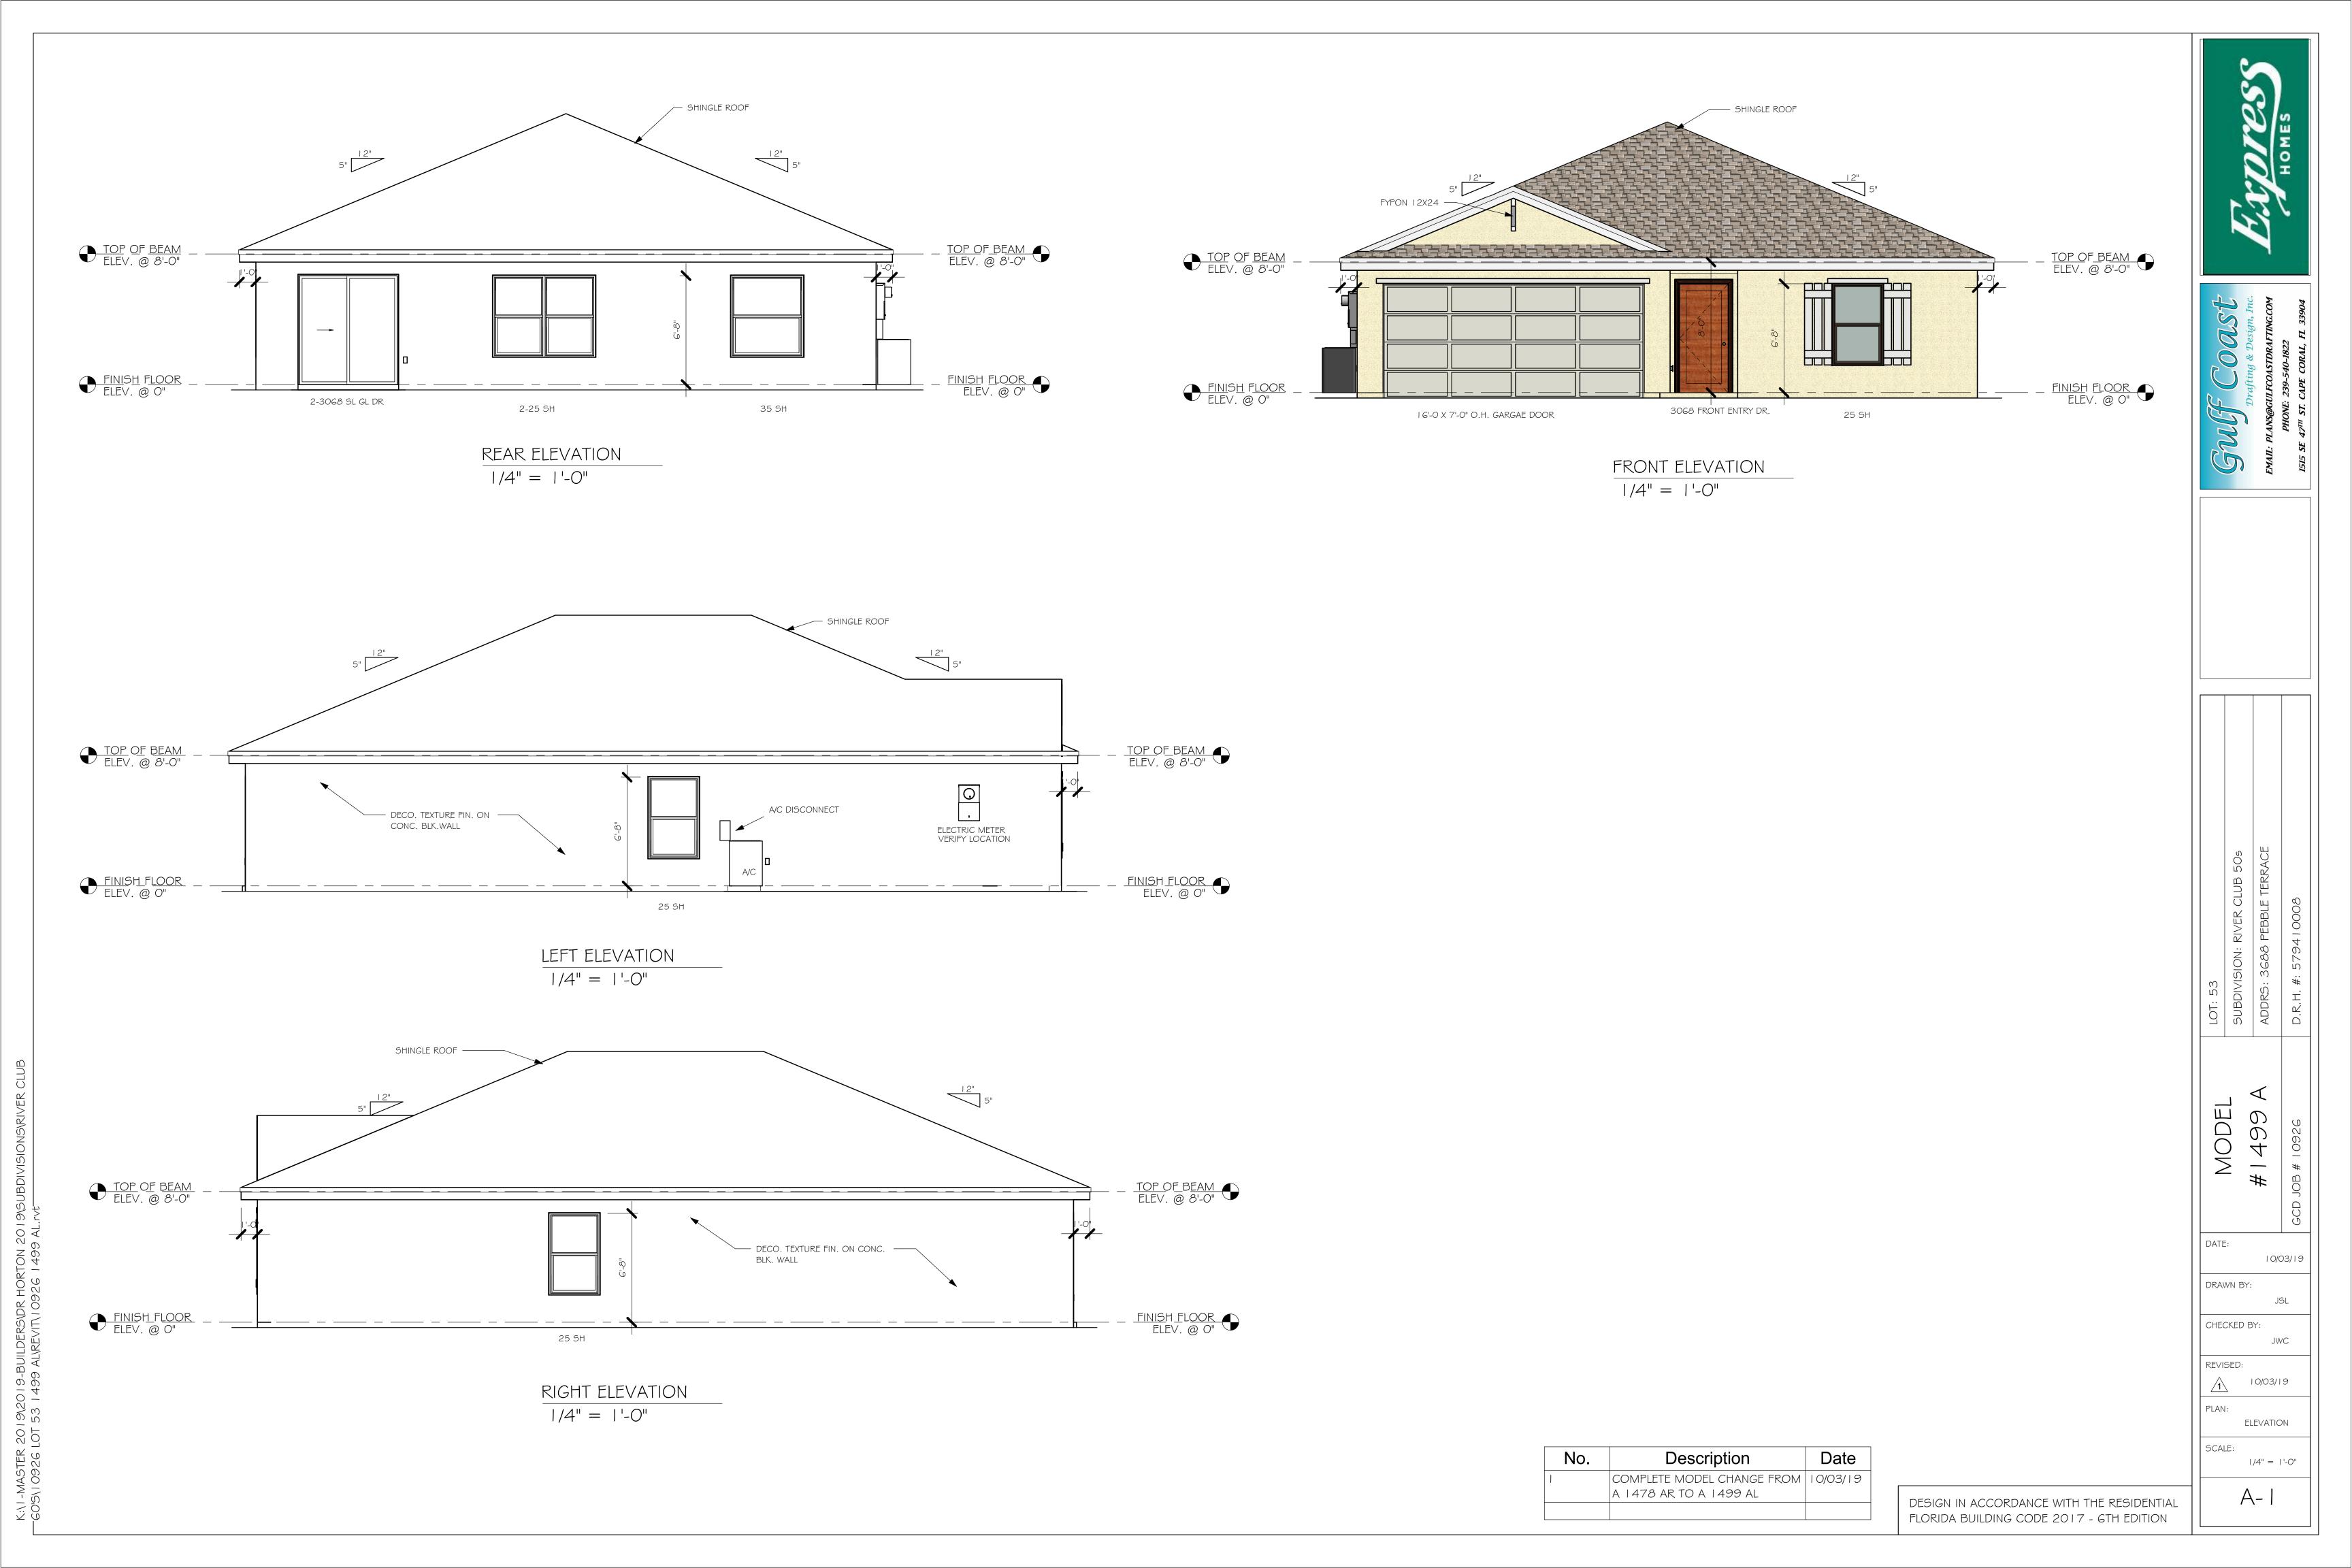



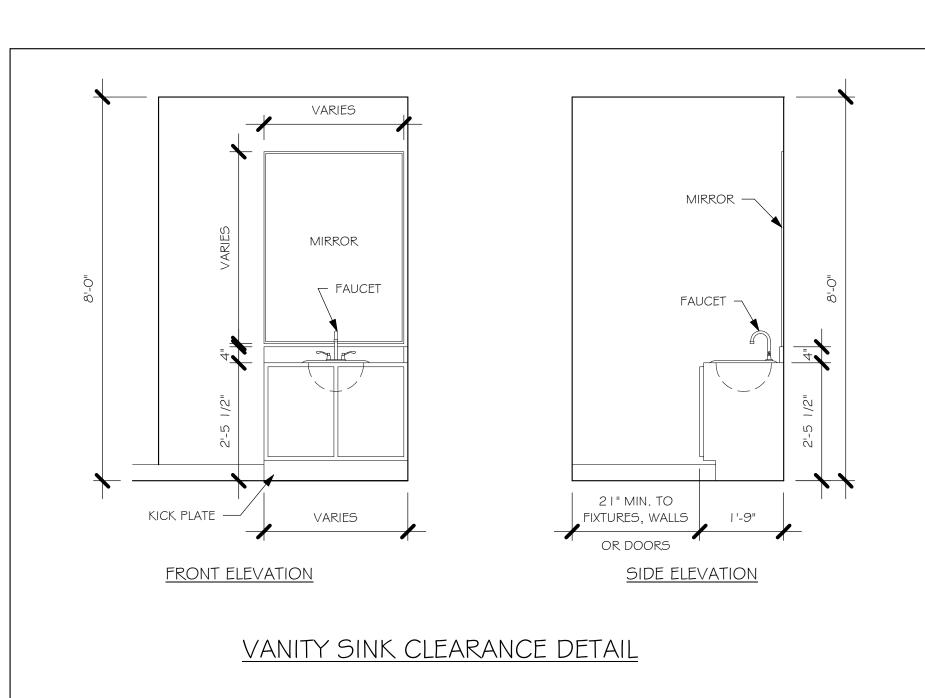



WATER CLOSET CLEARANCE DETAIL

FRONT ELEVATION

36" MAX.

SIDE ELEVATION

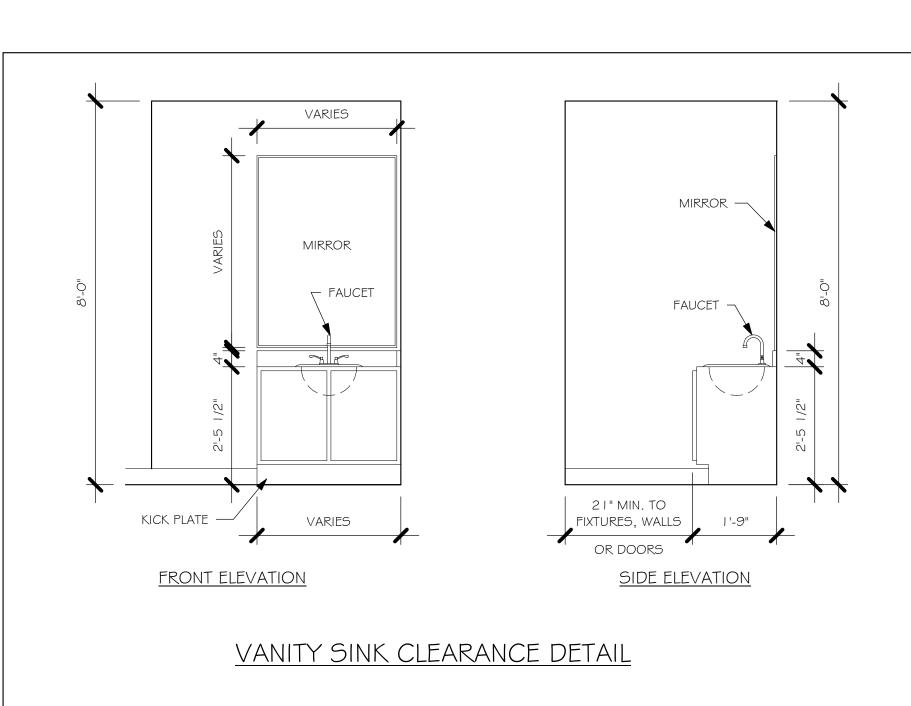

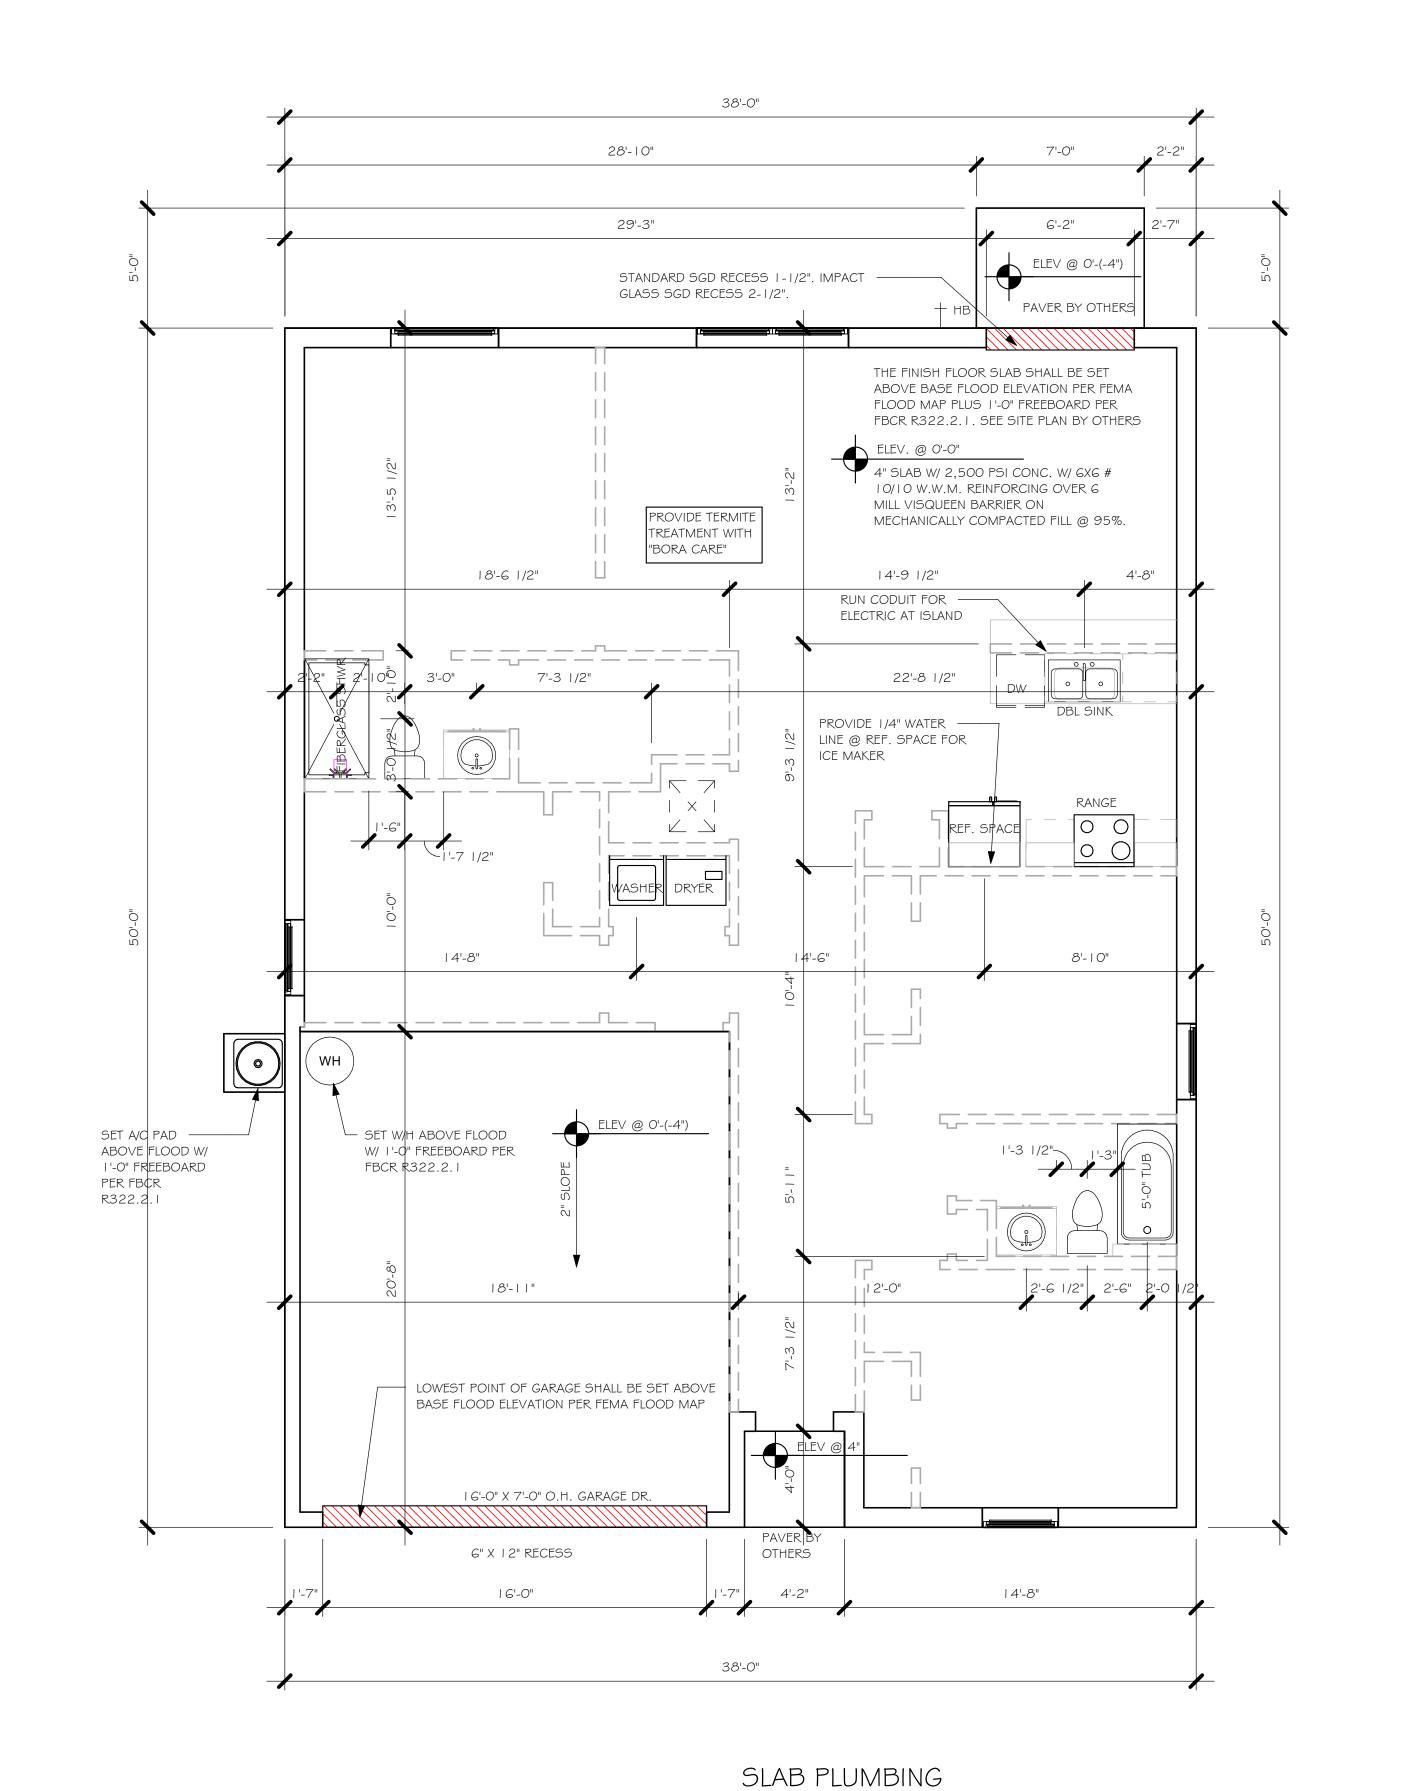

Description Date COMPLETE MODEL CHANGE FROM 10/03/19 A 1478 AR TO A 1499 AL

1/4" = 1'-0"

DESIGN IN ACCORDANCE WITH THE RESIDENTIAL FLORIDA BUILDING CODE 2017 - 6TH EDITION

MODEL

DATE:

DRAWN BY:

CHECKED BY:

REVISED:

PLAN:

SCALE:

10/03/19

JWC

10/03/19

As indicated

SLAB & PLUMBING



WINDOW SCHEDULE				
MARK	DESCRIPTION HEIGHT WIDTH COUNT		COUNT	
А	2-25 SH	5'-3"	6'-4"	1
В	25 SH	5'-3"	3'-2"	3
D	35 SH	5'-3"	4'-6"	1

D	OOR HEADE	RS
6'-8" BI-FOLD	HEADER HEIGHT	82" A.F.F.
6'-8" SWING	HEADER HEIGHT	82 I/2" A.F.F.
8'-0" SWING	HEADER HEIGHT	98 1/2" A.F.F.

## PLAN NOTES


- VERIFY ALL ROUGH OPENING DIMENSIONS FOR
   ALL WINDOWS AND DOORS
- 2) PROVIDE SAFETY GLAZING WITHIN 24" FROM EXIT PER FLORIDA BUILDING CODE R 308.4.2.
- 3) PROVIDE SAFETY GLAZING AT BATH/ SHOWER PER FLORIDA BUILDING CODE R 308.4.5.
- 4) NON BEARING INTERIOR FRAME WALLS SHALL BE FRAMED W/ WOOD OR METAL STUDS. SPACING SHALL NOT EXCEED 24" O.C. (NON BEARING WALLS ONLY)
- 5) PROVIDE DEAD WOOD IN ATTIC FOR OVERHEAD GARAGE DOOR HARDWARE
- 6) KITCHEN KNEE WALL TO BE FRAMED W/ TOP @ 34 1/2" A.F.F.
- 7) INSTALL SMOOTH WALLS IN KITCHEN AND ALL BATHROOM AREAS
- 8) WHERE DRYWALL CEILING IS APPLIED TO TRUSSES @ 24" O.C. USE 5/8" DRYWALL OR 1/2" SAG RESISTANT PER SEC. 702.3.5
- THE GARAGE SHALL BE SEPARATED FROM THE
  RESIDENCE \$ ATTIC BY NOT LESS THEN 1/2" GYPSUM
  BOARD APPLIED TO THE GARAGE SIDE. GARAGES
  BENEATH HABITABLE ROOMS SHALL BE SEPARATED
  WITH NOT LESS THAN 5/8" TYPE "X" GYPSUM BOARD
  OR EQUIVALENT. WHERE THE SEPARATIION IS A
  FLOOR CEILING ASSEMBLY, THE STRUCTURE
  SUPPORTING THE SEPARTION SHALL ALSO BE
  PROTECTED BY NOT LESS THAN 1/2" GYPSOM BOARD
  OR EQUIVALENT
- 10) INSTALL 1 3/8" THICK SOLID WOOD DOOR BETWEEN
  LIVING AND GARAGE PER FLORIDA BUILDING CODE
- II) ALL WINDOWS INSTALLED 72" ABOVE GRADE MUST COMPLY WITH RGI2.2 MIN 24" SILL HEIGHT OR PROVIDED WITH AN APPROVED WINDOW FALL PRVENTION DEVICE
- 12) ALL CLOSET SHELVES TO BE 12". ALL PANTRY \$
  LINEN TO BE (4)-16" SHELVES 18" O.F.F. W/ 15"
  INCREMENT.
- 13) ALL MECHANICAL AND ELECTRICAL EQUIPMENT TO BE INSTALLED AT OR ABOVE FLOOD PLUS 1'-0" FREEBOARD.


INTERIOR DOOR SCHEDULE				
MARK	DOOR WIDTH	NOTES		
	3'-0"	P.K. = POCKET DOOR		
2	2'-8"	B.F. = BI-FOLD DOOR		
3	2'-6"	D.1 .		
4	2'-4"	B.P. = BI-PASS DOOR		
5	2'-0"	L.V. = LOUVERED DOOR		
6	1'-8"			
7	1'-6"			
8	2'-11"			

	-		
		SQUARE FOOTAG	E
		LIVING AREA	1,499
		GARAGE AREA	385
2		FRONT PORCH/ ENTRY AREA	16
		TOTAL SQUARE FOOTAGE	1,900

		BATHROOM NOTES
TB	7 TOWEL BAR	ALL TUB DECKS @ 21" A.F.F
TP	TOILET PAPER	ALL BLOCKING TO BE PT IN SHOWERS
	"O-1-4	TOWEL BAR  TOILET PAPER ROLL  A A A A A A A A A A A A A A A A A A

CABINET BACKING				
KITCHEN	UPPER TOP @ 84"	BASE TOP @ 35"		
MASTER BATH	UPPER	BASE TOP @ 35"		
GUEST BATH	UPPER	BASE TOP @ 31"		
LAUNDRY ROOM	UPPER TOP @ 84" BASE			

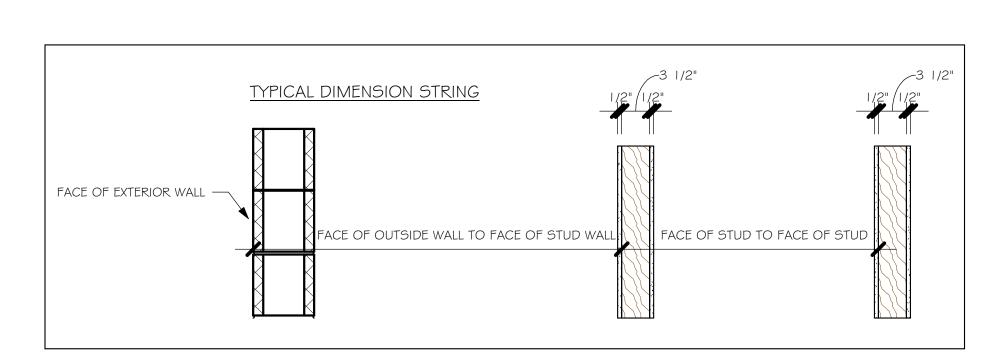

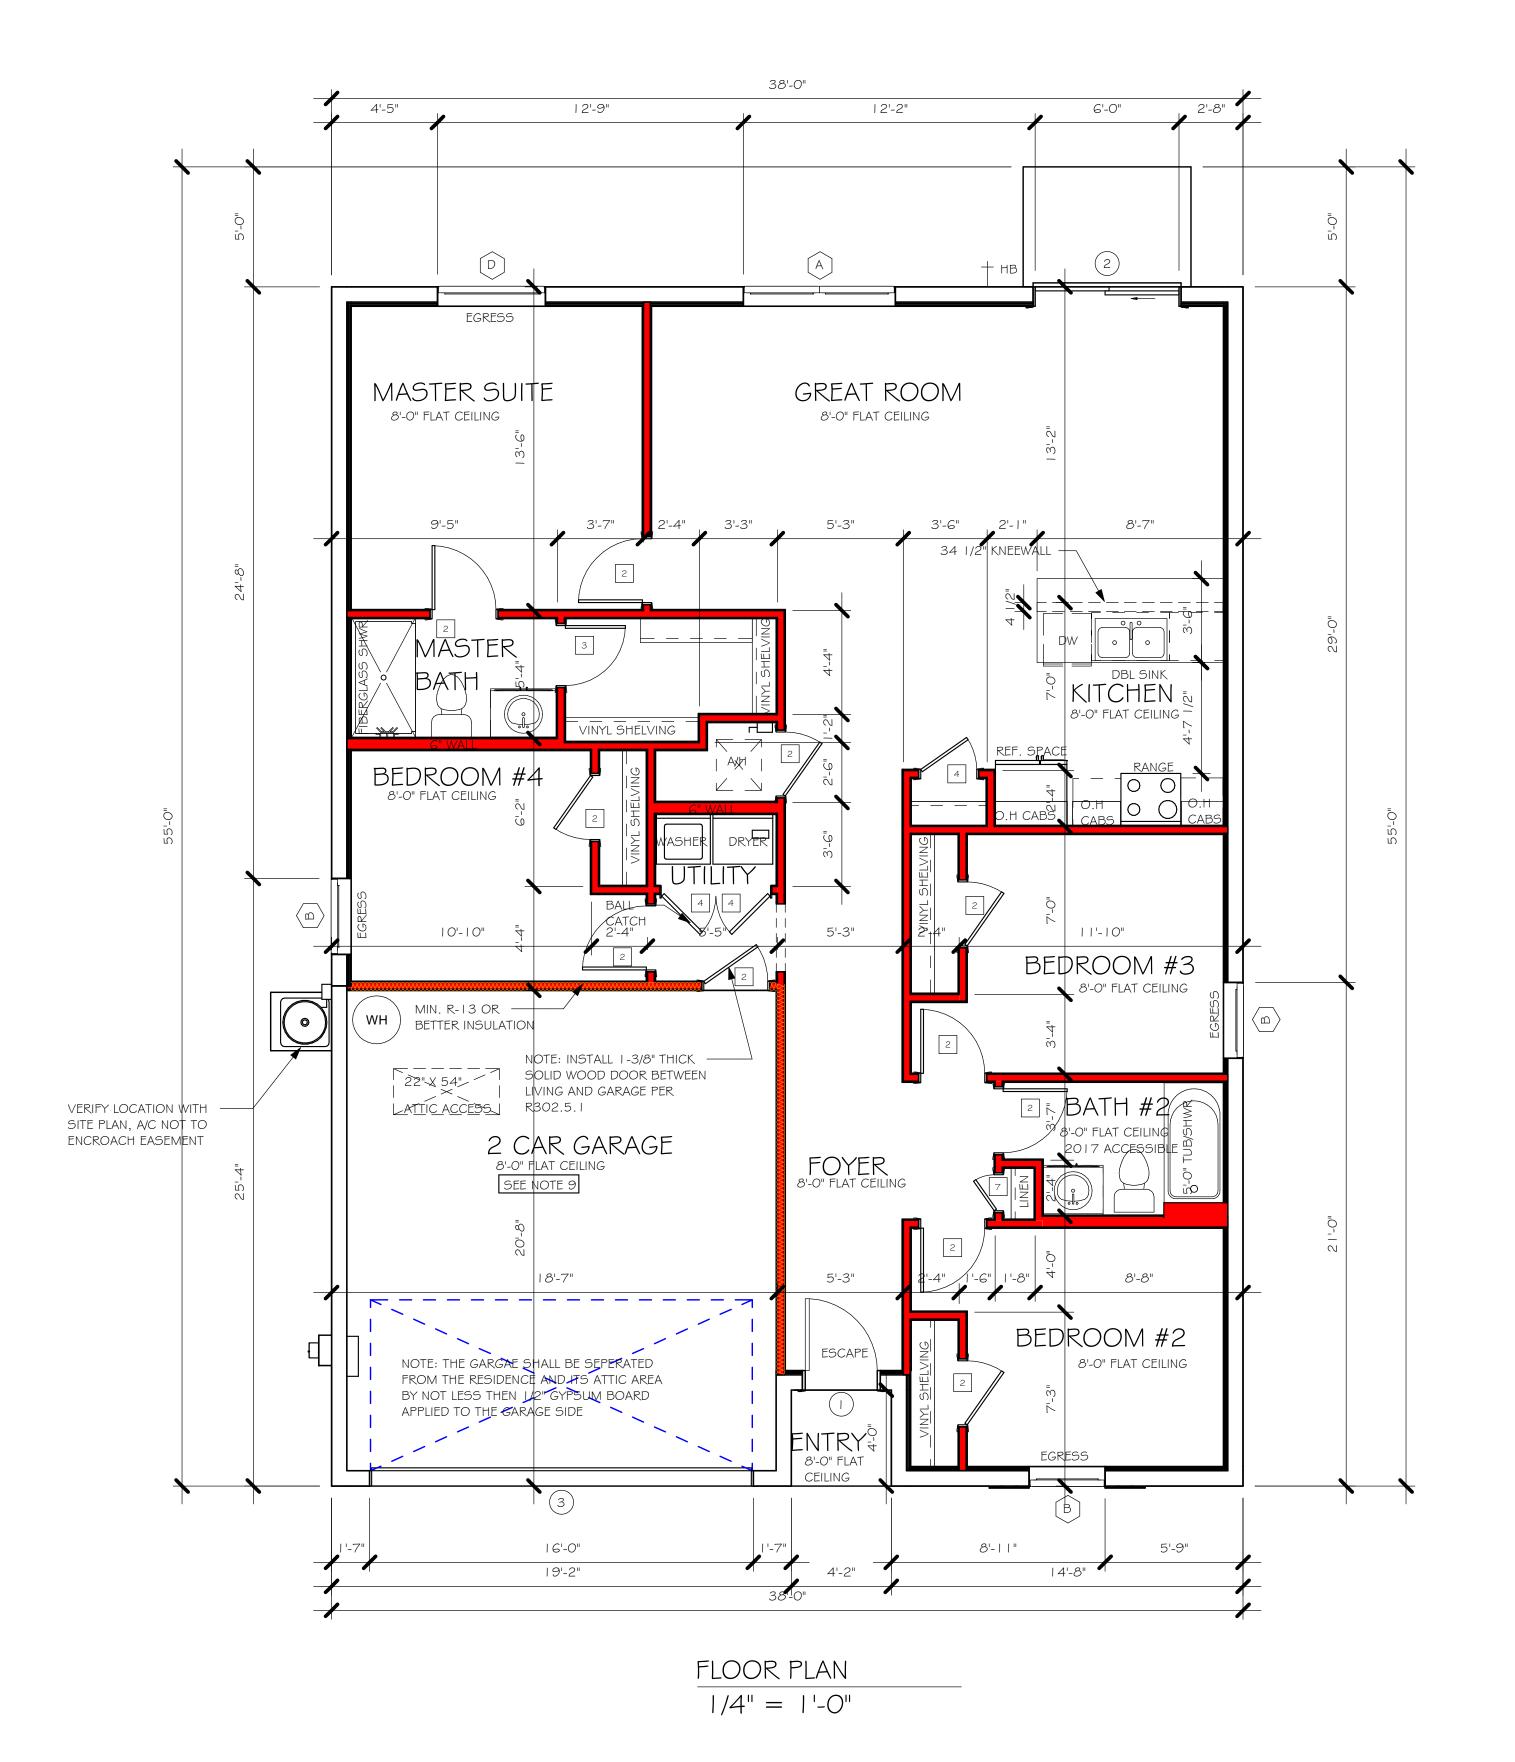

No. Description Date

COMPLETE MODEL CHANGE FROM 10/03/19
A 1478 AR TO A 1499 AL

DESIGN IN ACCORDANCE WITH THE RESIDENTIAL FLORIDA BUILDING CODE 2017 - 6TH EDITION

DATE:

DRAWN BY:

CHECKED BY:

REVISED:

PLAN:

SCALE:

10/03/19


JWC


10/03/19

FLOOR


As indicated

K:\I-MASTER 2019\2019-BUILDERS\DR HORTON 2019\SUBDIVISION! -60'S\10926 LOT 53 1499 AL\REVIT\10926 1499 AL.rvt

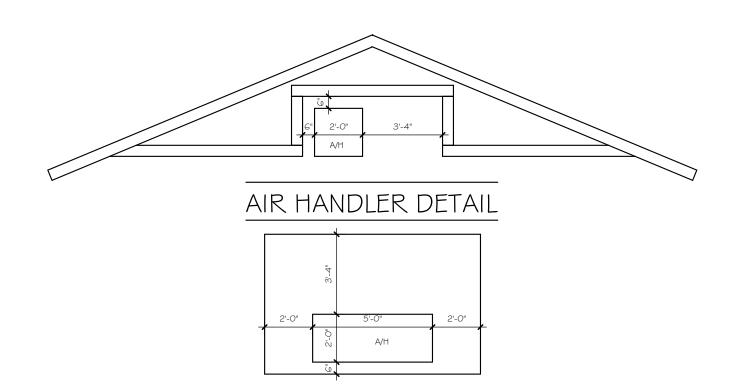

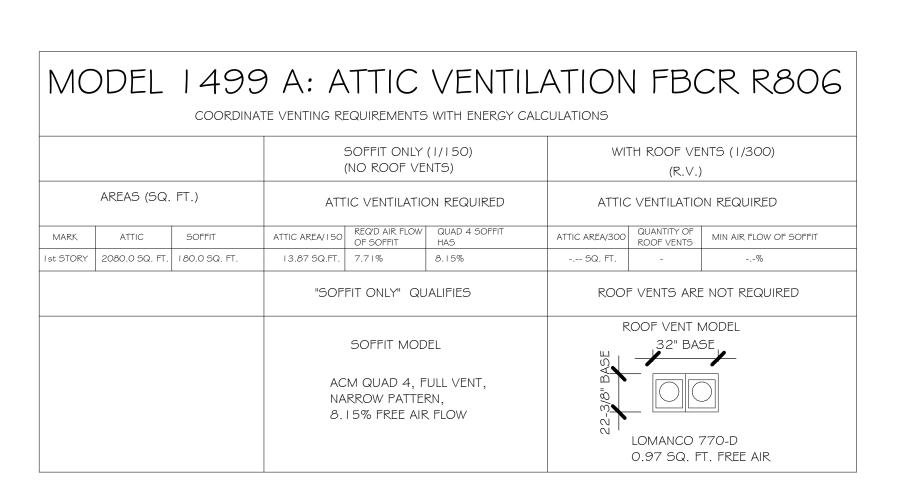

BEARING HEIGHT = BEARING @ 8'-0"

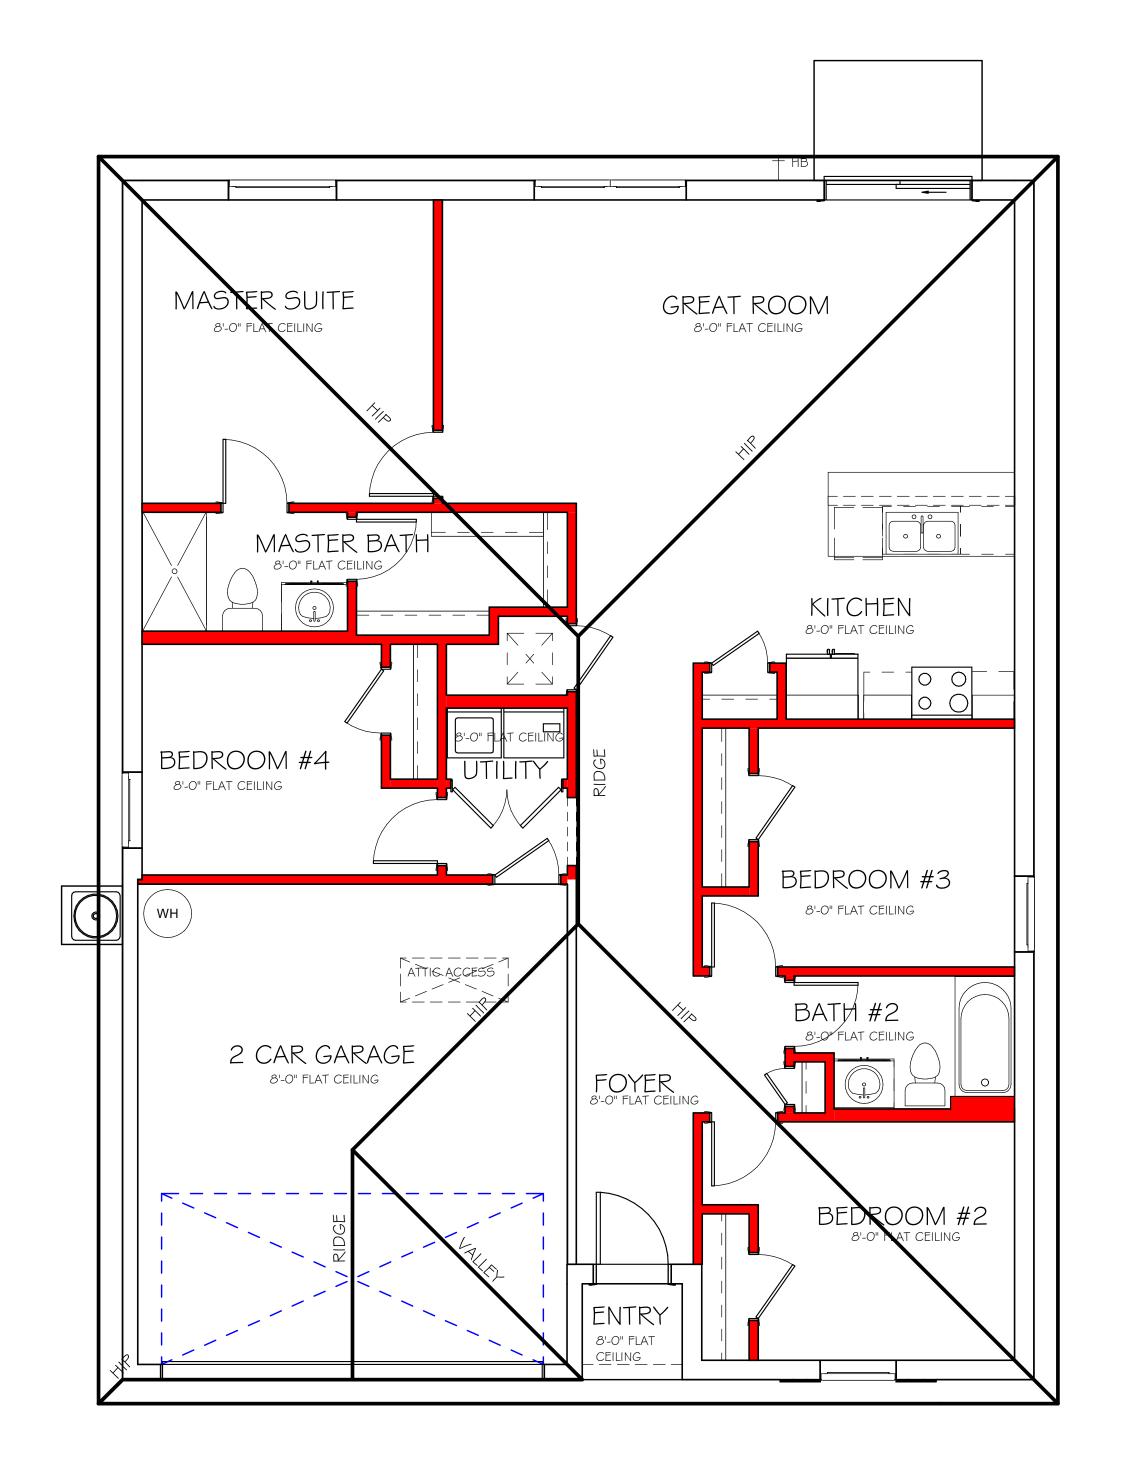

ROOF PLAN 1/4" = 1'-0"

No.	Description	Date
1	COMPLETE MODEL CHANGE FROM A 1478 AR TO A 1499 AL	10/03/19

DESIGN IN ACCORDANCE WITH THE RESIDENTIAL FLORIDA BUILDING CODE 2017 - 6TH EDITION

MODEL

DATE:

DRAWN BY:

CHECKED BY:

REVISED:

PLAN:

SCALE:

10/03/19

JWC

10/03/19

ROOF

As indicated

A-4

ELECTRICAL LEGEND

120 V JUNCTION BOX

SINGLE RECEPTACLE OUTLET

220 V RECEPTACLE OUTLET

4-PLEX RECEPTACLE OUTLET

DUPLEX RECEPTACLE OUTLET

1/2 SWITCHED DUPLEX OUTLET

DUPLEX RECEPTACLE AT ELEV. A.F.F.

ELECTRICAL METER

ELECTRICAL PANEL

				L L	( )	(2 1 0 21)
				F	(X)	(36" LT)
				G	(X)	(NOT USED)
				Н	(2)	(COACH LIGHTS)
				1	(X)	
				J	(X)	(J BOX)
				K	(1)	(4' FLUORESCENT)
				L	(X)	(2' FLUORESCENT)
				М	(X)	(5LT CHANDELIER)
				N	(X)	(3 LT)
				0	(X)	(PENDANT/ NOOK)
				Р	(X)	(X)
				Q	(X)	(X)
M		I 50 AMP PANEL				
	ı l		J			

(2) 4/0 AL \$ (1) 1/0 AL OR CU EQUIVALENT

#6 CU MIN. TO (2) GROUND RODS, AT LEAST GFT APART.

150 AMP ELECTRICAL RISER DIAGRAM

POWER CO.

ELECTRICAL PLAN


(RECESSED CANS)

(PENDANT LIGHT (10" MUSHROOMS)

(VAPORS)

TAG QUANTITY PRODUCT

150 AMP SERVICE

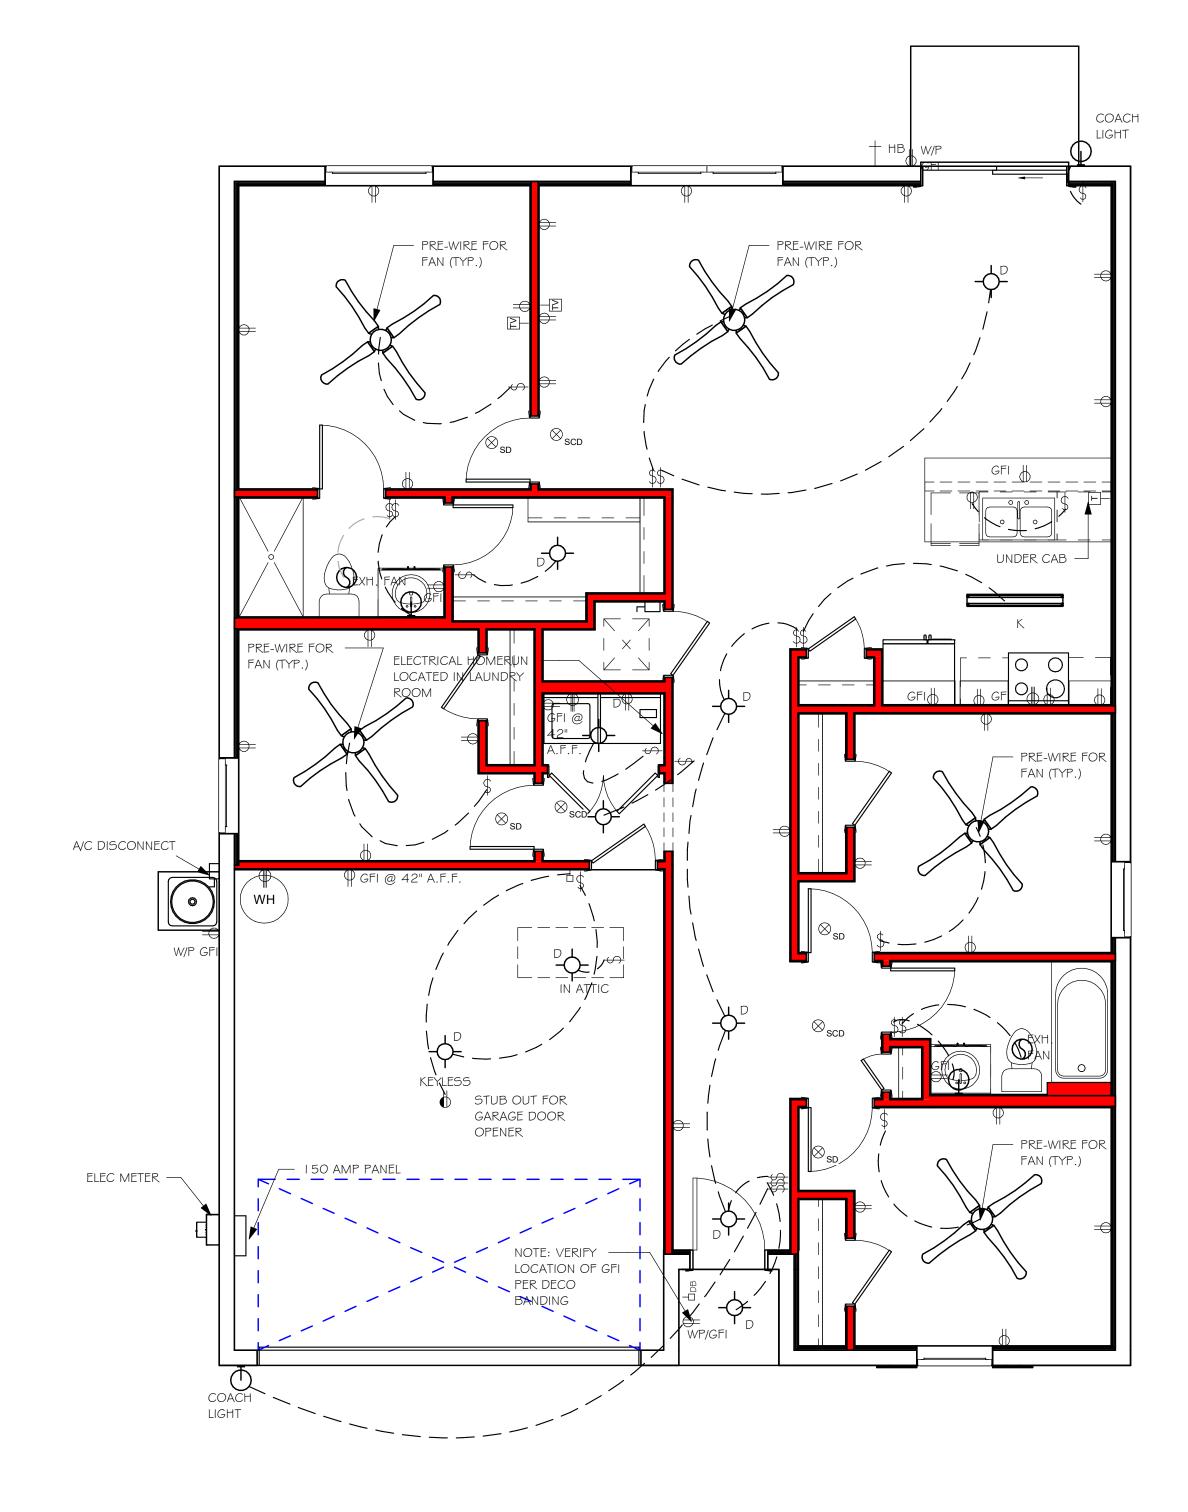

ELECTRICAL PLAN
1/4" = 1'-O"

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DESIGN IN ACCORDANCE WITH THE RESIDENTIAL FLORIDA BUILDING CODE 2017 - 6TH EDITION

Express HOMES	

DATE: 10/03/19 DRAWN BY:


CHECKED BY: REVISED:


10/03/19

ELECTRICAL


PLAN: As indicated

SCALE:

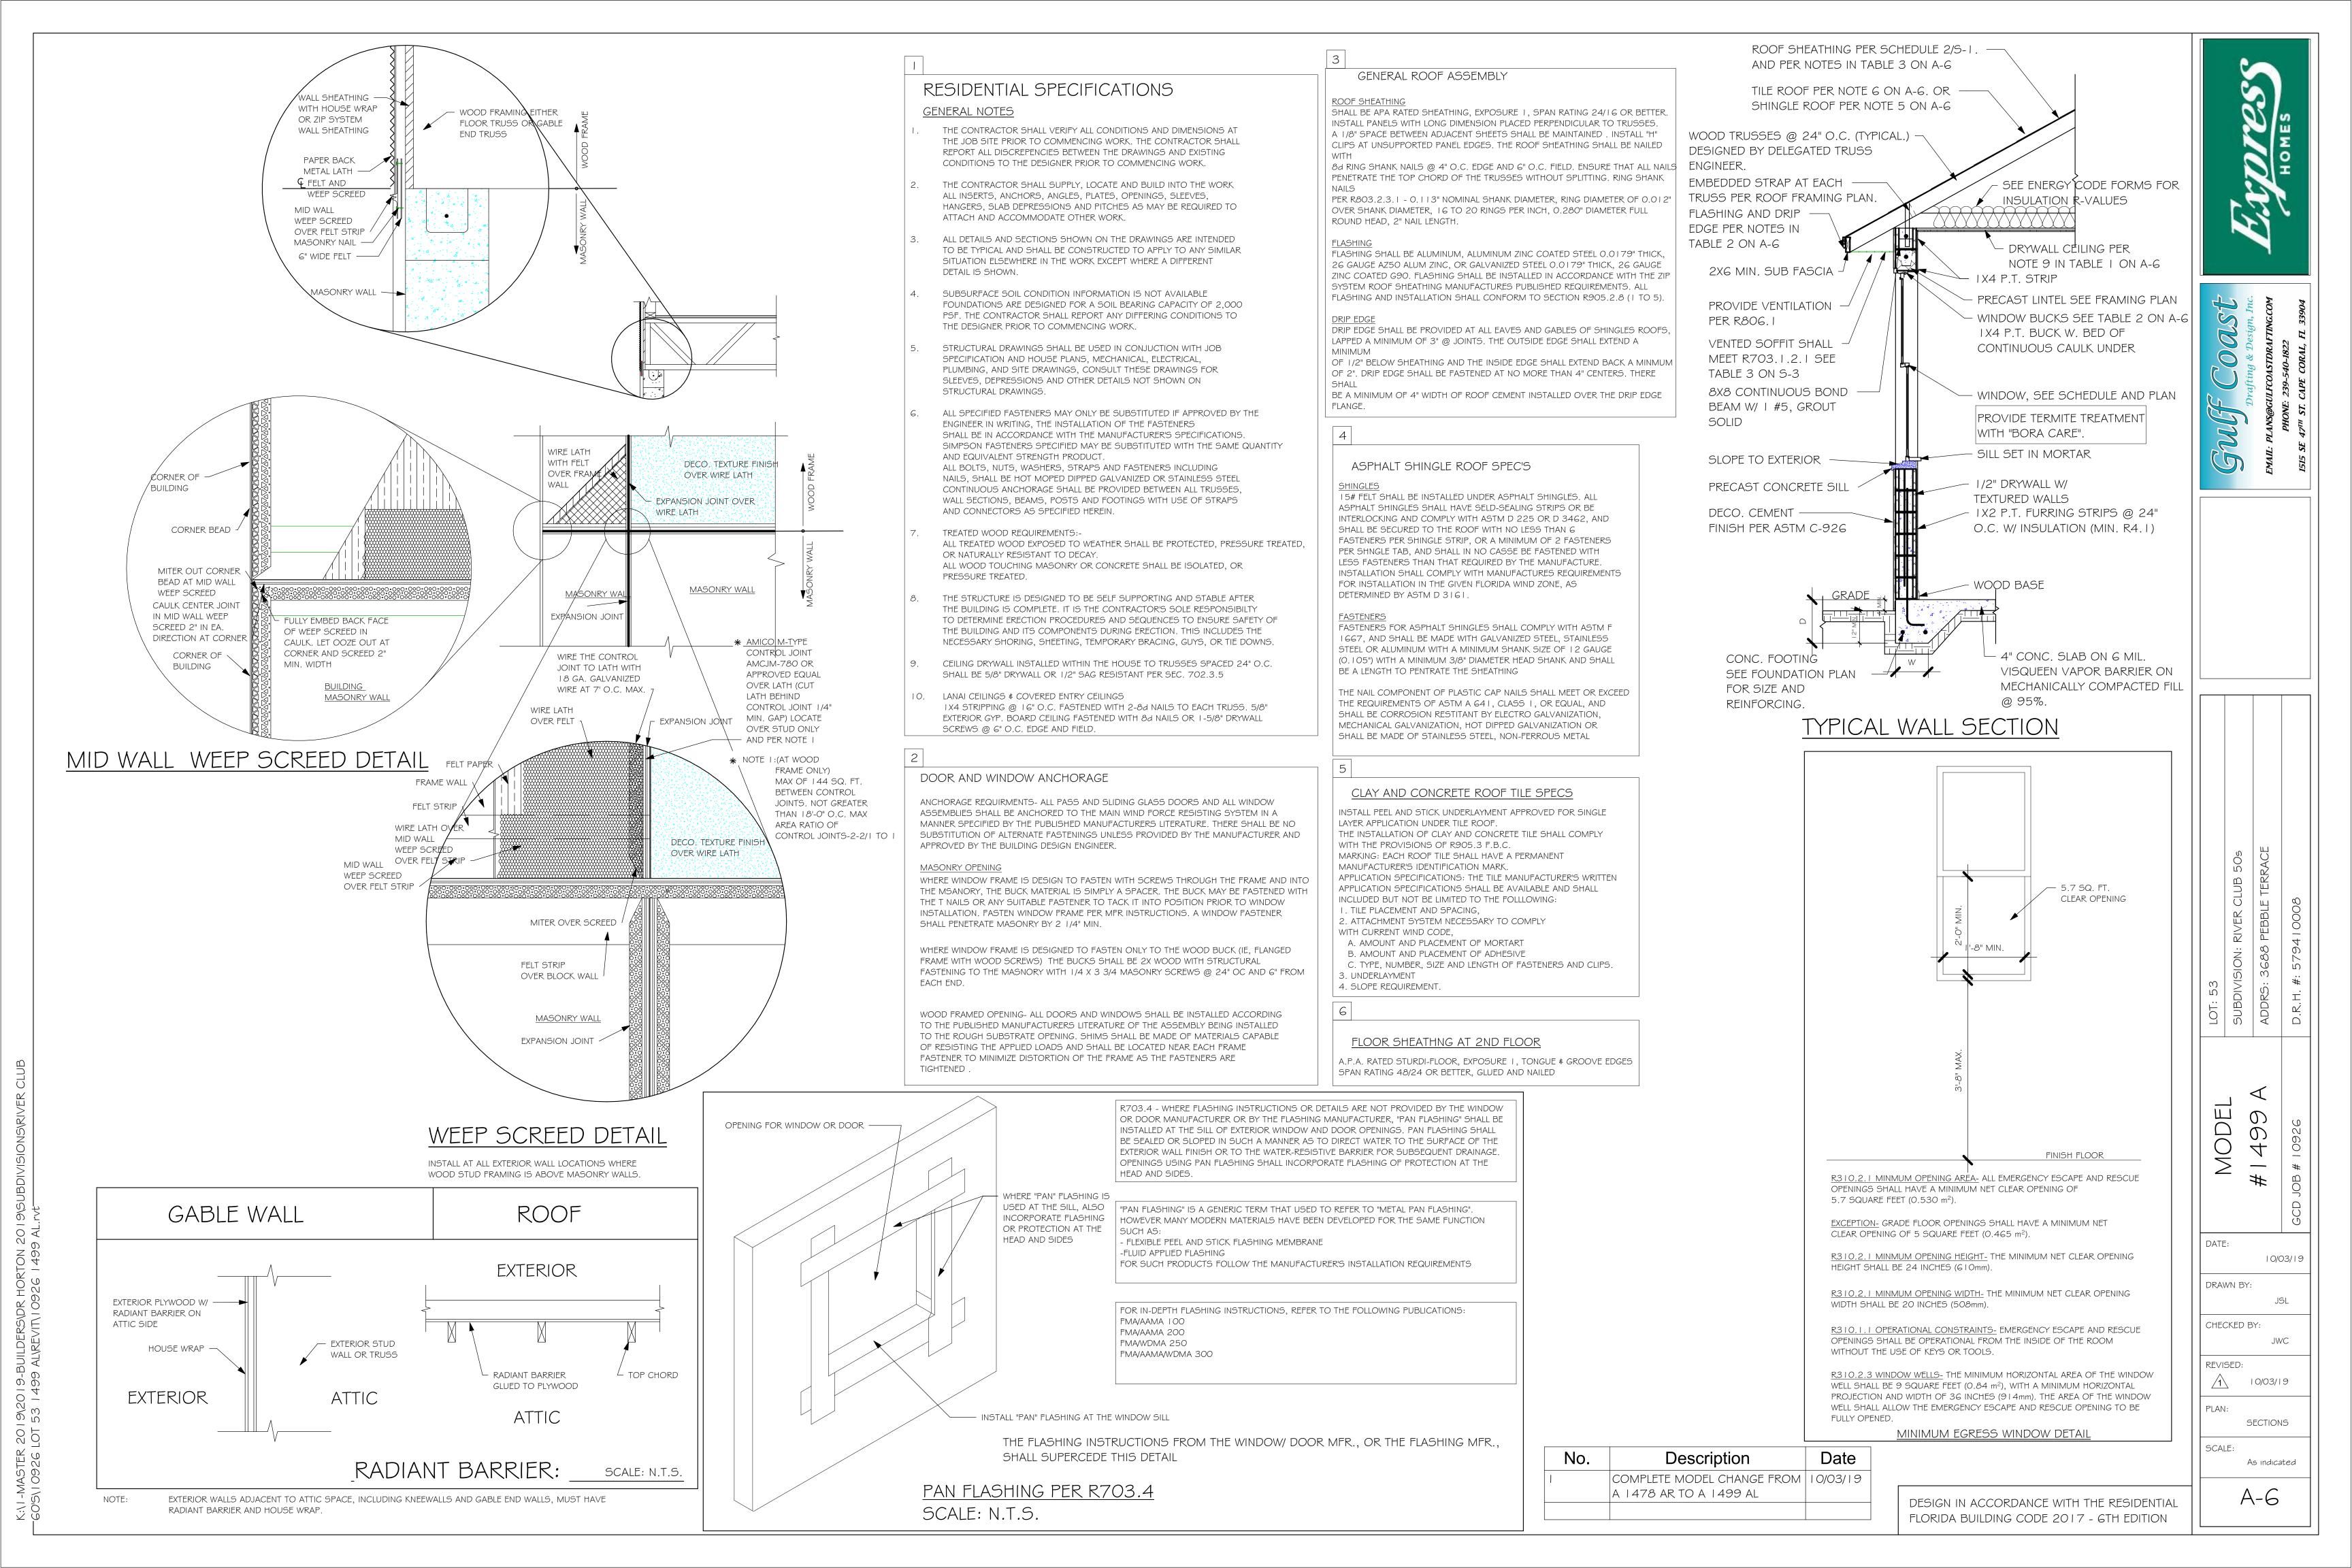


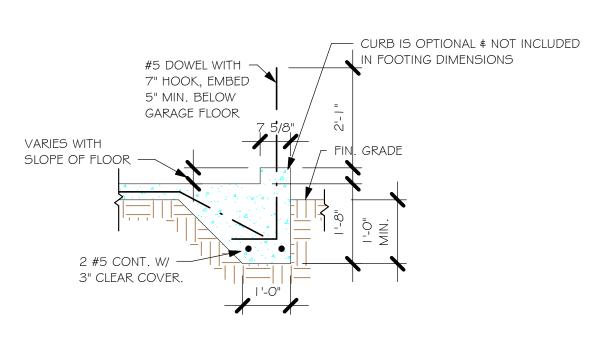


"F3" WITH CURB AT GARAGE 1/2" = 1'-0"

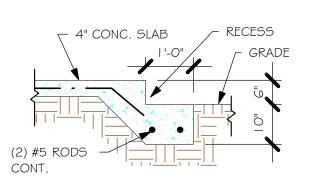

GARAGE DOOR RECESS 1/2" = 1'-0"

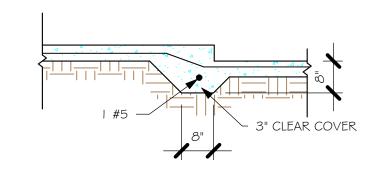

"F6A" STEP DOWN 1/2" = 1'-0"

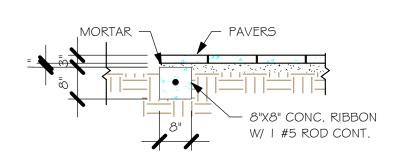

"P" PAVERS DETAIL ENTRY/ LANAI I 1/2" = 1'-0"

	PAD FOOTING SCHEDULE								
USED	TYPE	DEMARKS							
ns	ITPE	LENGTH	WIDTH	DEPTH LONG W		SHORT WAY	REMARKS		
X	$\langle \mathbf{A} \rangle$	2'-6"	2'-6"	1'-0"	3-#5	3-#5	-		
	$\langle \mathbf{B} \rangle$	3'-0"	3'-0"	1'-0"	4-#5	4-#5	-		
	$\langle \mathbf{c} \rangle$	3'-6"	3'-6"	1'-0"	4-#5	4-#5	-		
	$\langle \mathbf{D} \rangle$	4'-0"	4'-0"	1'-2"	5-#5	5-#5	-		
	⟨ <b>E</b> ⟩	5'-0"	5'-0"	1'-2"	6-#5	6-#5	-		

	WA	LL FO	OTING	SCH	HEDULE		
USED	TYPE	LENGTH	WIDTH	DEPTH	BOTTOM REINFORCING	SHAPE	
	F1	CONT.	1'-4"	0'-8"	2-#5		
	F2	CONT.	1'-8"	0'-10"	2-#5		]
X	F3	CONT.	1'-0"	1'-8"	2-#5		ADD CURB 1 GARAGE, SI DETAIL
	F4	CONT.	1'-4"	1'-8"	2-#5		DETAIL
	F5	CONT.	1'-4"	1'-0"	2-#5	<b>T</b>	
	F6	CONT.	1'-4"	1'-0"	2-#5	#	
X	F6A	CONT.	0'-8"	0'-8"	1-#5		
	TE	CONT.	0'-8"	0'-8"	1-#5	Ţ	

PROVIDE CORNER BARS PER 6/S-3



**PLAN NOTES:** TOP OF GROUND FLOOR SLAB DATUM ELEVATION 0'-0"

\_\_F#" DENOTES CONTINUOUS WALL FOOTING TYPE PER SCHEDULE THIS SHEET.


 $\langle extbf{\#} 
angle$  DENOTES PAD FOOTING AT CONCENTRATED LOADS PER SCHEDULE THIS SHEET. PROVIDE #5 VERTICAL REINFORCING AT DOT LOCATIONS SHOWN ON PLAN FROM FOOTING

TO BOND BEAM.

ALL DIMENSIONS ARE TO OUTSIDE FACE OF MASONRY WALLS. SOME SLAB EDGES MAY **EXTEND BEYOND FACE OF WALL.** 

FOR DIMENSIONS OF ROUGH OPENINGS IN MASONRY WALLS, COORDINATE WITH WINDOW/ DOOR SUPPLIER.

PROVIDE PRESSURE TREATED BUCKS AT WINDOWS/ DOORS PER DETAIL 7/S-3.

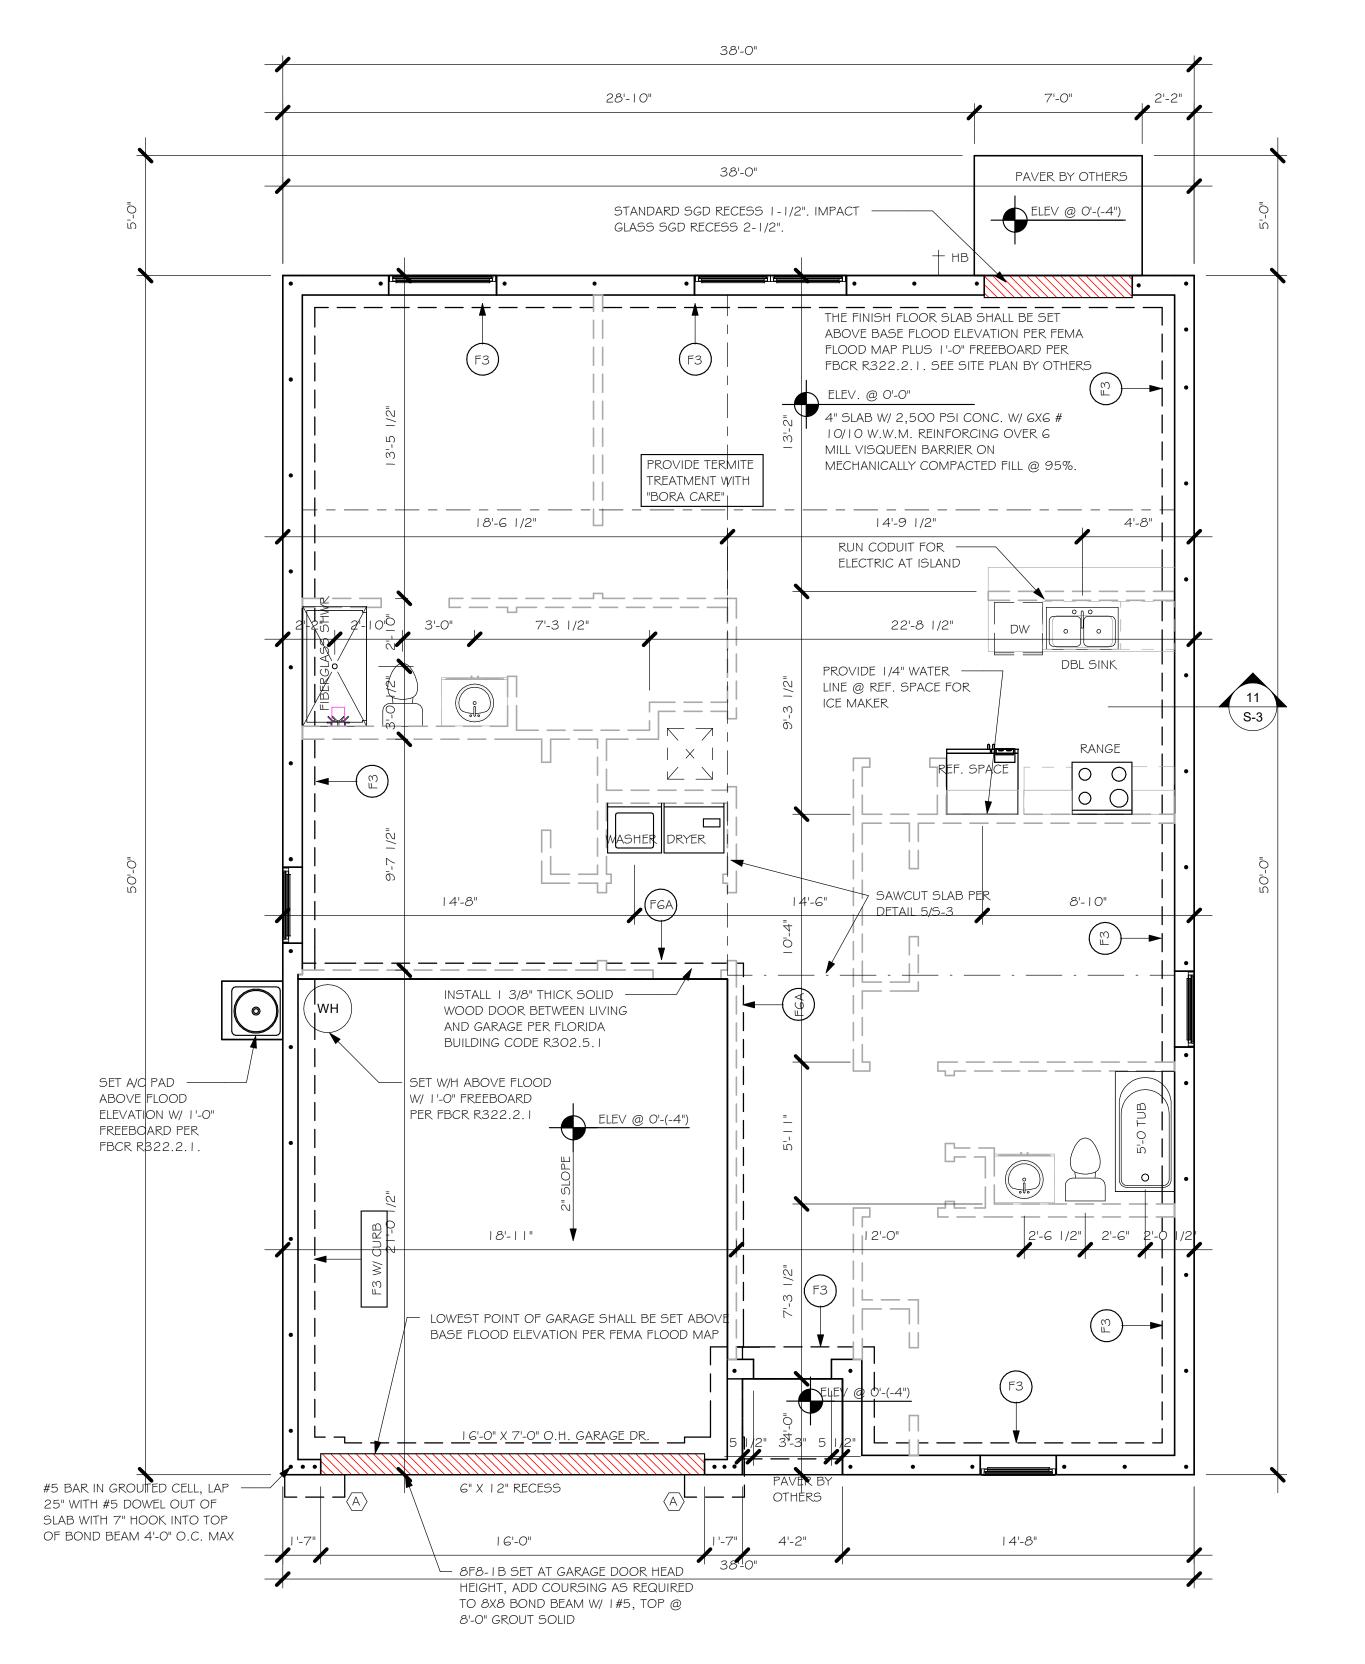

FOUNDATION 1/4" = 1'-0"

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1	COMPLETE MODEL CHANGE FROM A 1478 AR TO A 1499 AL	10/03/19	

FLORIDA BUILDING CODE 2017 - 6TH EDITION

DATE: 10/03/19 DRAWN BY:

CHECKED BY:

REVISED: 10/03/19 PLAN:

FOUNDATION PLAN


SCALE:

As indicated

I. PROVIDE A STRAP FROM THE ABOVE LIST AT EACH ROOF TRUSS BEARING POINT, BASED ON THE TRUSS UPLIFT VALUES IN THE SIGNED AND SEALED TRUSS DESIGN PACKAGE AND SUITABLE FOR THE GEOMETRY. EMBED STRAP

- ON -C/L OF WALL. CONNECTORS ARE USP STRUCTURAL CONNECTORS. ALL CONNECTORS SHALL BE INSTALLED IN STRICT ACCORDANCE WITH USP PRINTED INSTUCTIONS. SUBSTITUTIONS MUST BE APPROVED IN WRITING BY THE ENGINEER OF RECORD.
- WHERE EMBEDDED STRAPS ARE MISSING, OR MIS-LOCATED, INSTALL RETROFIT STRAP PER 2/S-4.
- 'ATR' = ALLTHREAD. DRILL AND EPOXY WITH USP EPOXY PER MFR.

INSTRUCTIONS.

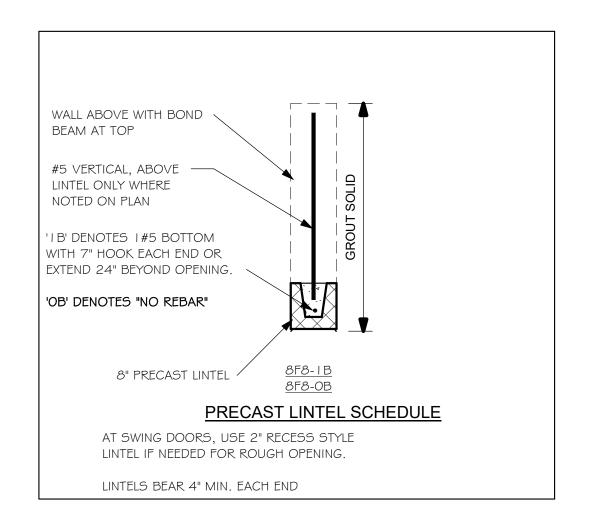

## PLAN NOTES:

- ROOF TRUSS BEARING 8'-O", SEE LEGEND. ROOF FRAMING SHALL BE WOOD TRUSSES DESIGNED BYA DELEGATED TRUSS ENGINEER PER DESIGN CRITERIA ON SHEET S-3.
- PROVIDE STRAPPING AT TRUSSES PER NOTES ON THIS
- FOR NAILING OF ROOF AND FLOOR DECK, SEE I AND 2 ON 5-3. 8F8-1B etc., DENOTES PRECAST LINTEL ABOVE
- DOOR, WINDOW OPENING PER SCHEDULE THIS SHEET. AT TRUSS BEARING, PROVIDE 8x8 MASONRY BOND BEAM W/ I #5 CONTINUOUS, SEE DETAIL I I/S-3.


BEARING HEIGHT


TRUSS BEARING CONDITIONS AND

PREPARED BY SCOSTA JOB# 44116 DATED: 05/24/18 REVISED: 9/15/18

STRAPPING IS BASED ON TRUSS LAYOUT

= BEARING @ 8'-0"

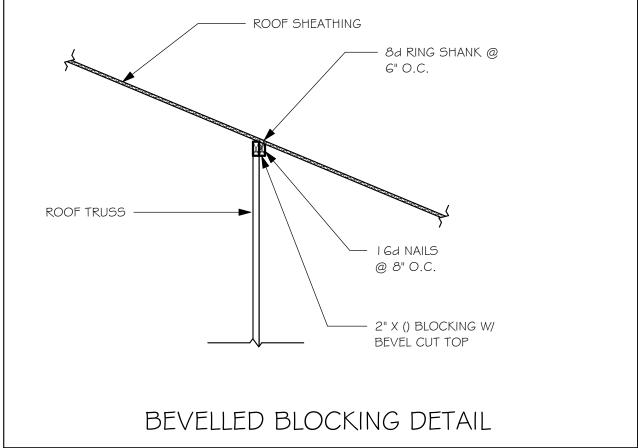

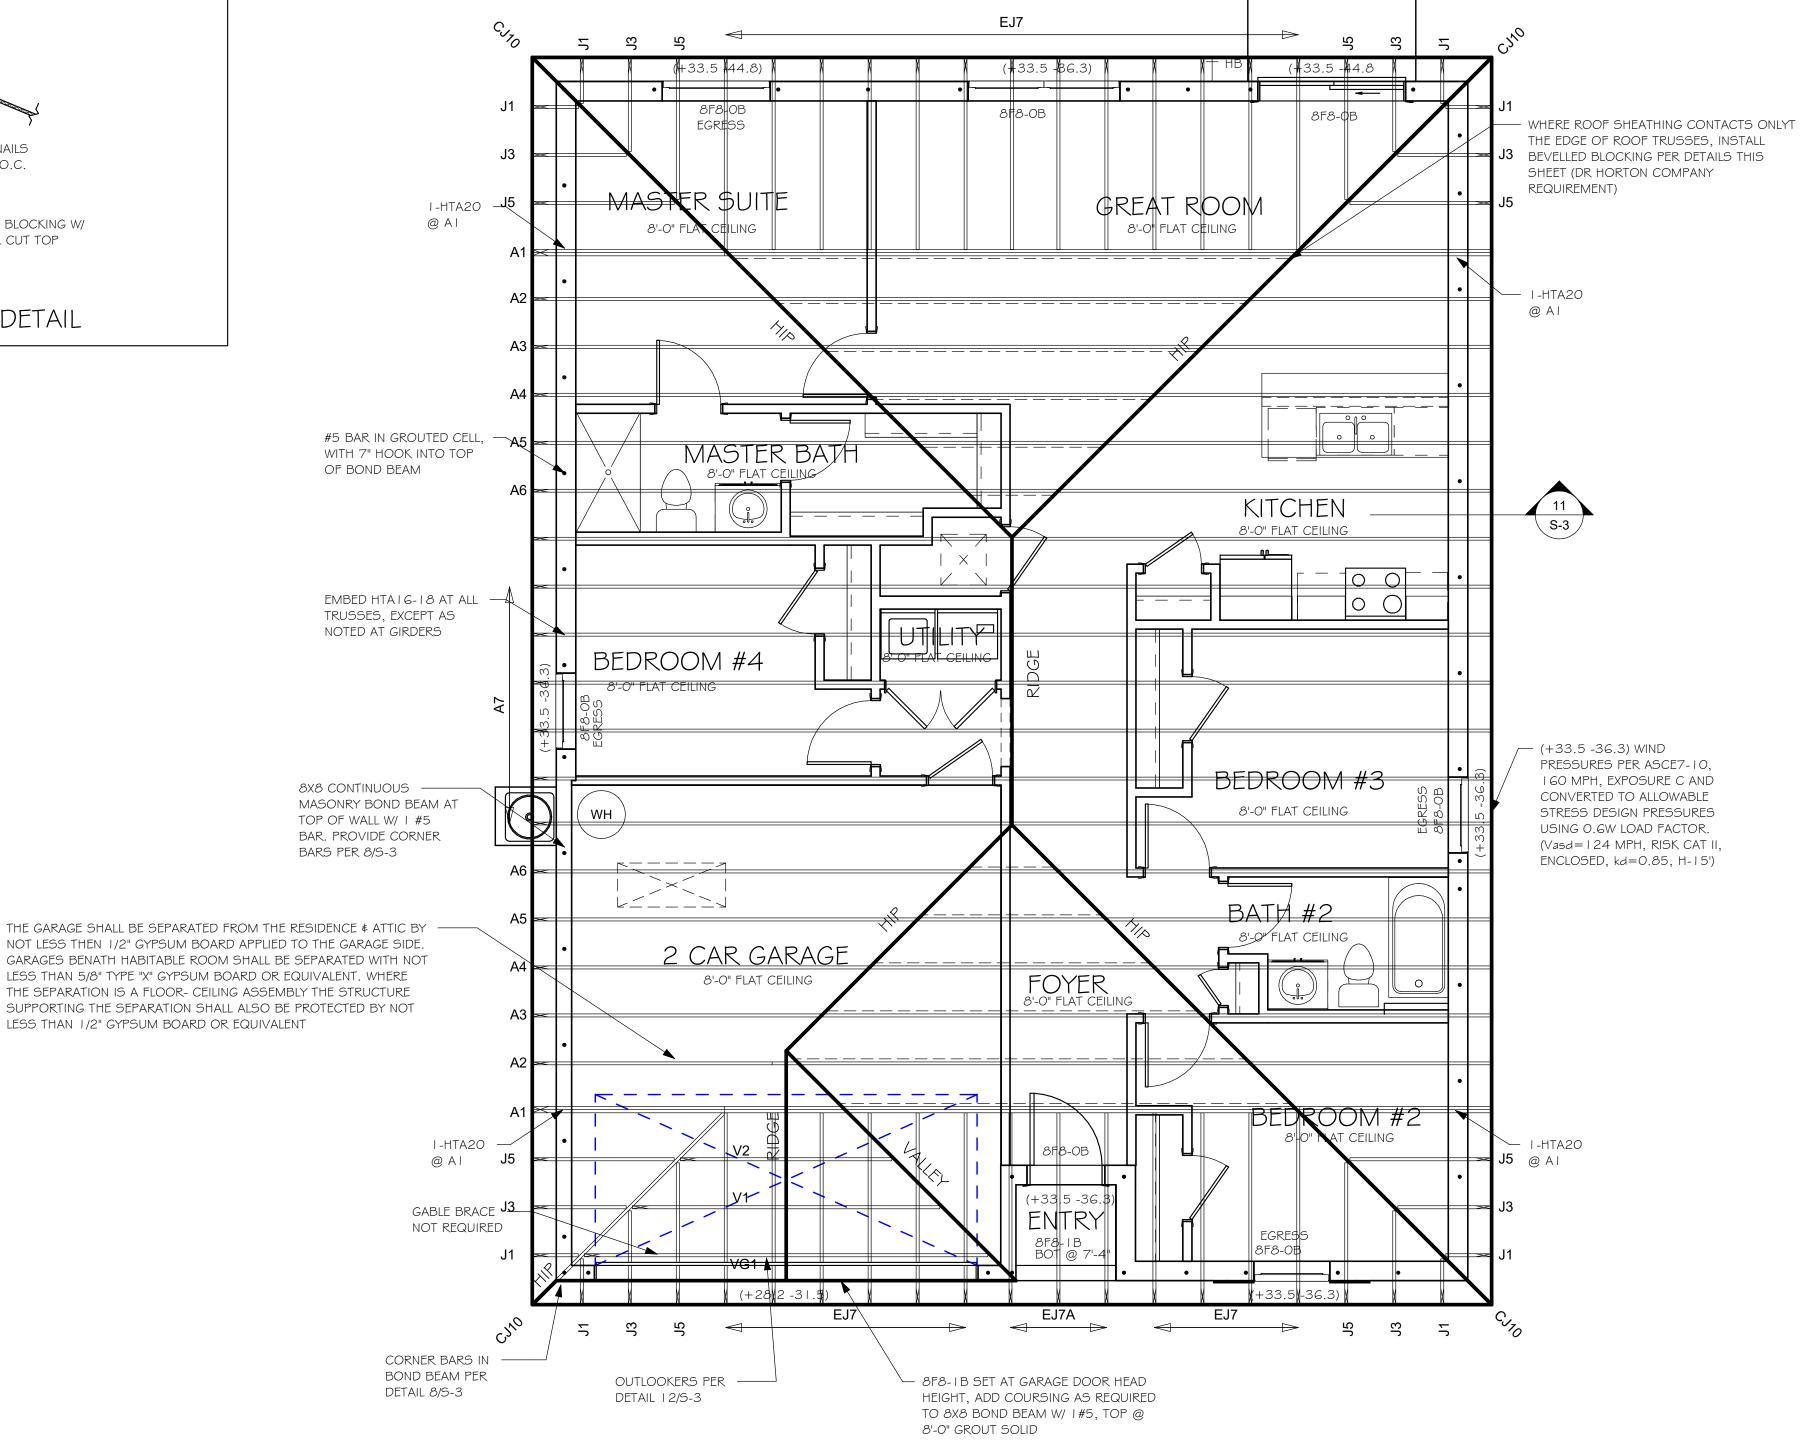

ROOF FRAMING PLAN 1/4" = 1'-0"

Date Description COMPLETE MODEL CHANGE FROM 10/03/19 A 1478 AR TO A 1499 AL

DESIGN IN ACCORDANCE WITH THE RESIDENTIAL FLORIDA BUILDING CODE 2017 - 6TH EDITION

DATE: 10/03/19 DRAWN BY: JSL

MODEL


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STRUCTURAL SYSTEMS of North Florida 1634 SE. 47th ST SUITE #3 CAPE CIRAL, FL 33904 <239> 549-4554

CHECKED BY: JWC REVISED: 1 10/03/19

PLAN: ROOF FRAMING PLAN SCALE:

As indicated

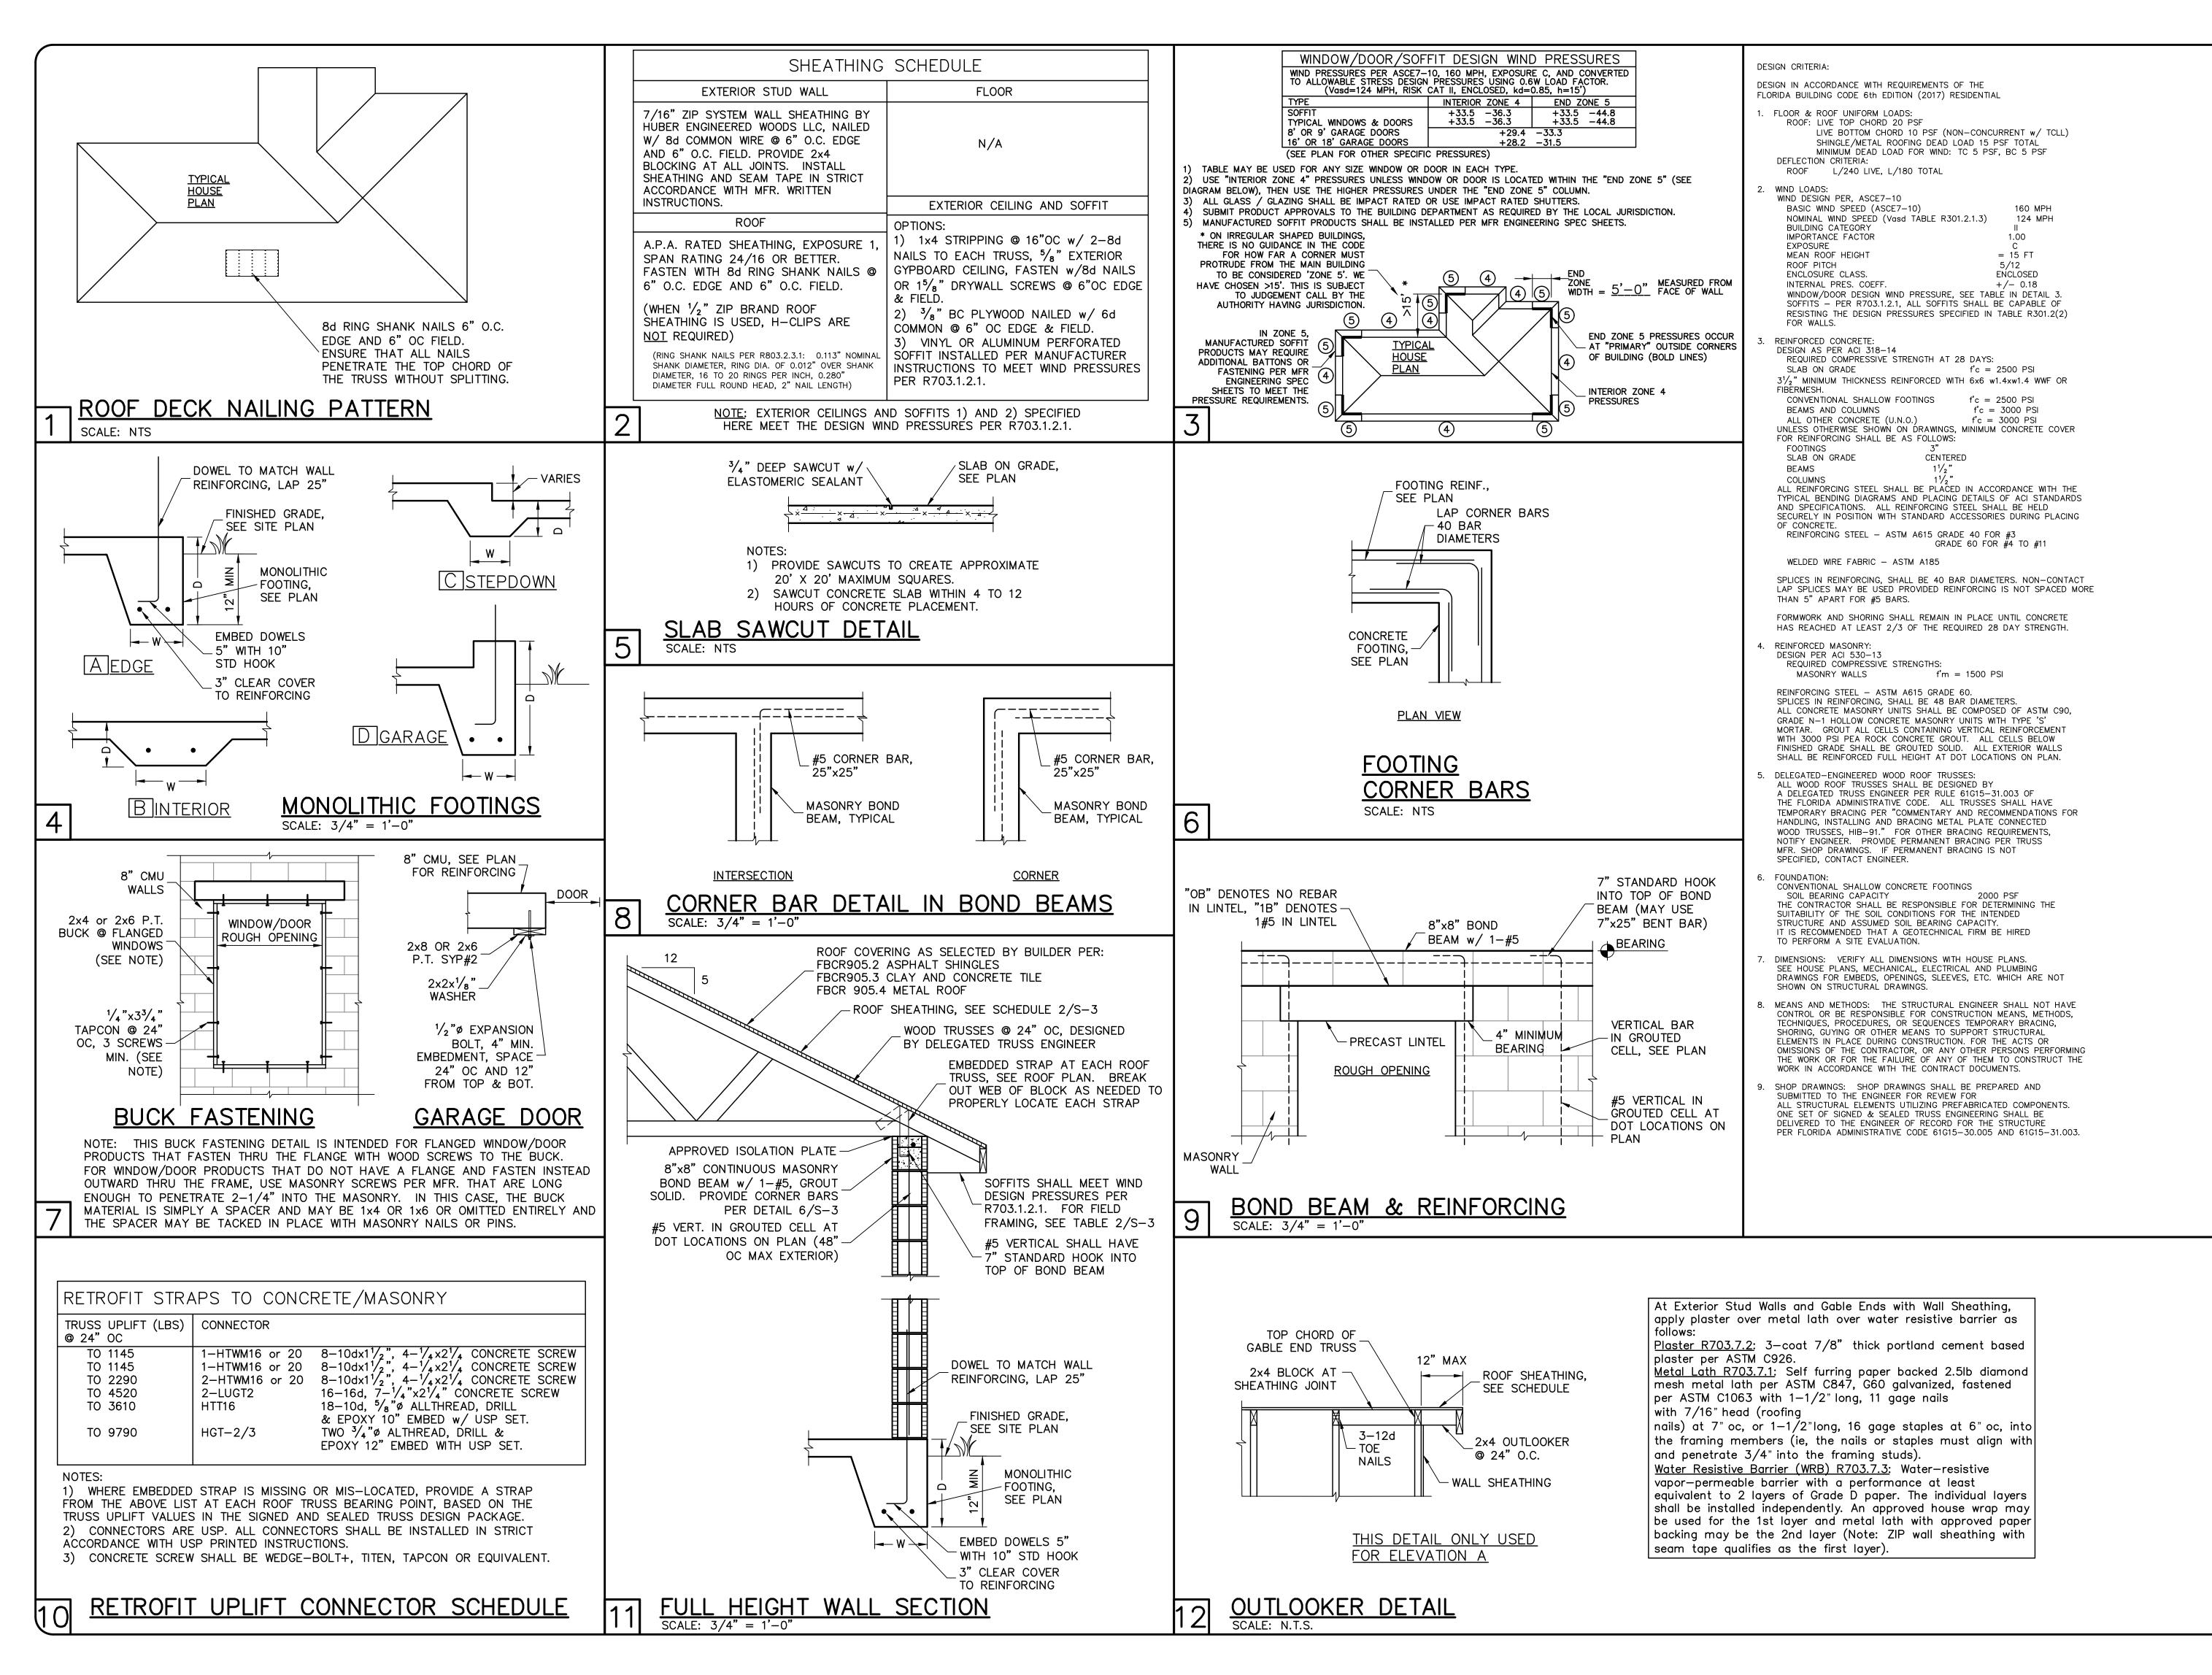

REVISIONS

ORTON D-R-H

P99 FRRACE FLORIDA RIVER 74, MODEI 3688 F PORT CH TR.

DWB/DWB CHECKED DWB 10/03/19 SCALE **VARIES** JOB NO. DR10926