


ERIA OAD 20 LOAD 7 VE LOAD NON-CONCURRENT 10# EAD LOAD 10 37 1.25
D (MPH) 160 I EXP C MWFRS FBC R WIND LOAD 8'-0"
5 12
8"
T ND DETAIL
NOTED** ARE UNDER 5000# RE UNDER 1000#
NLESS NOTED OTHERWISE ON****** ERECT TRUSSES WITH— THE ENGINEERING DWGS. FER TO THE ENGINEERING MEMBERS, BEARING LOCATION,
PI BSCI-B1 SUMMARY METHODS & TEMPORARY ALWAYS REQUIRED PLANS PROVIDED TO SCOSTA RENCES SHOWN ARE CRITICAL INFORM SCOSTA CORP. BEAM HEIGHTS
0'-0" ELEV.
ELEV.
ELEV.
ELEV.
DULE
M USP THDH 28-3 N USP THD 48 P USP JUS 24
B USP MSH 422 X BEEN BASED ON 16D PT THE FOLLOWING THJA26 - 10D x 1-1/2
LAYOUT IS NECESSARY BEGIN. VERIFY DIMENSIONS, VATIONS, CEILING & DISTA CORPORATION IS CY IN ACCORDANCE WITH DN PROVIDED BY ATIONS NOTED HEREIN. TO VERIFY ACCURACY OF PROVIDED TO SCOSTA RIFY CONFORMANCE TO COWNER CHANGES. ACCORDANCE WITH THE
TED DELIVERY DATE:
CORP.
EL OR TIMBER LOOR TRUSSES CE CENTER DRIVE
REVISED BY: DRAWN BY: KD 09/15/18 KRISTY
1 of 1 JOB # 44116
1


D.R. HORTON

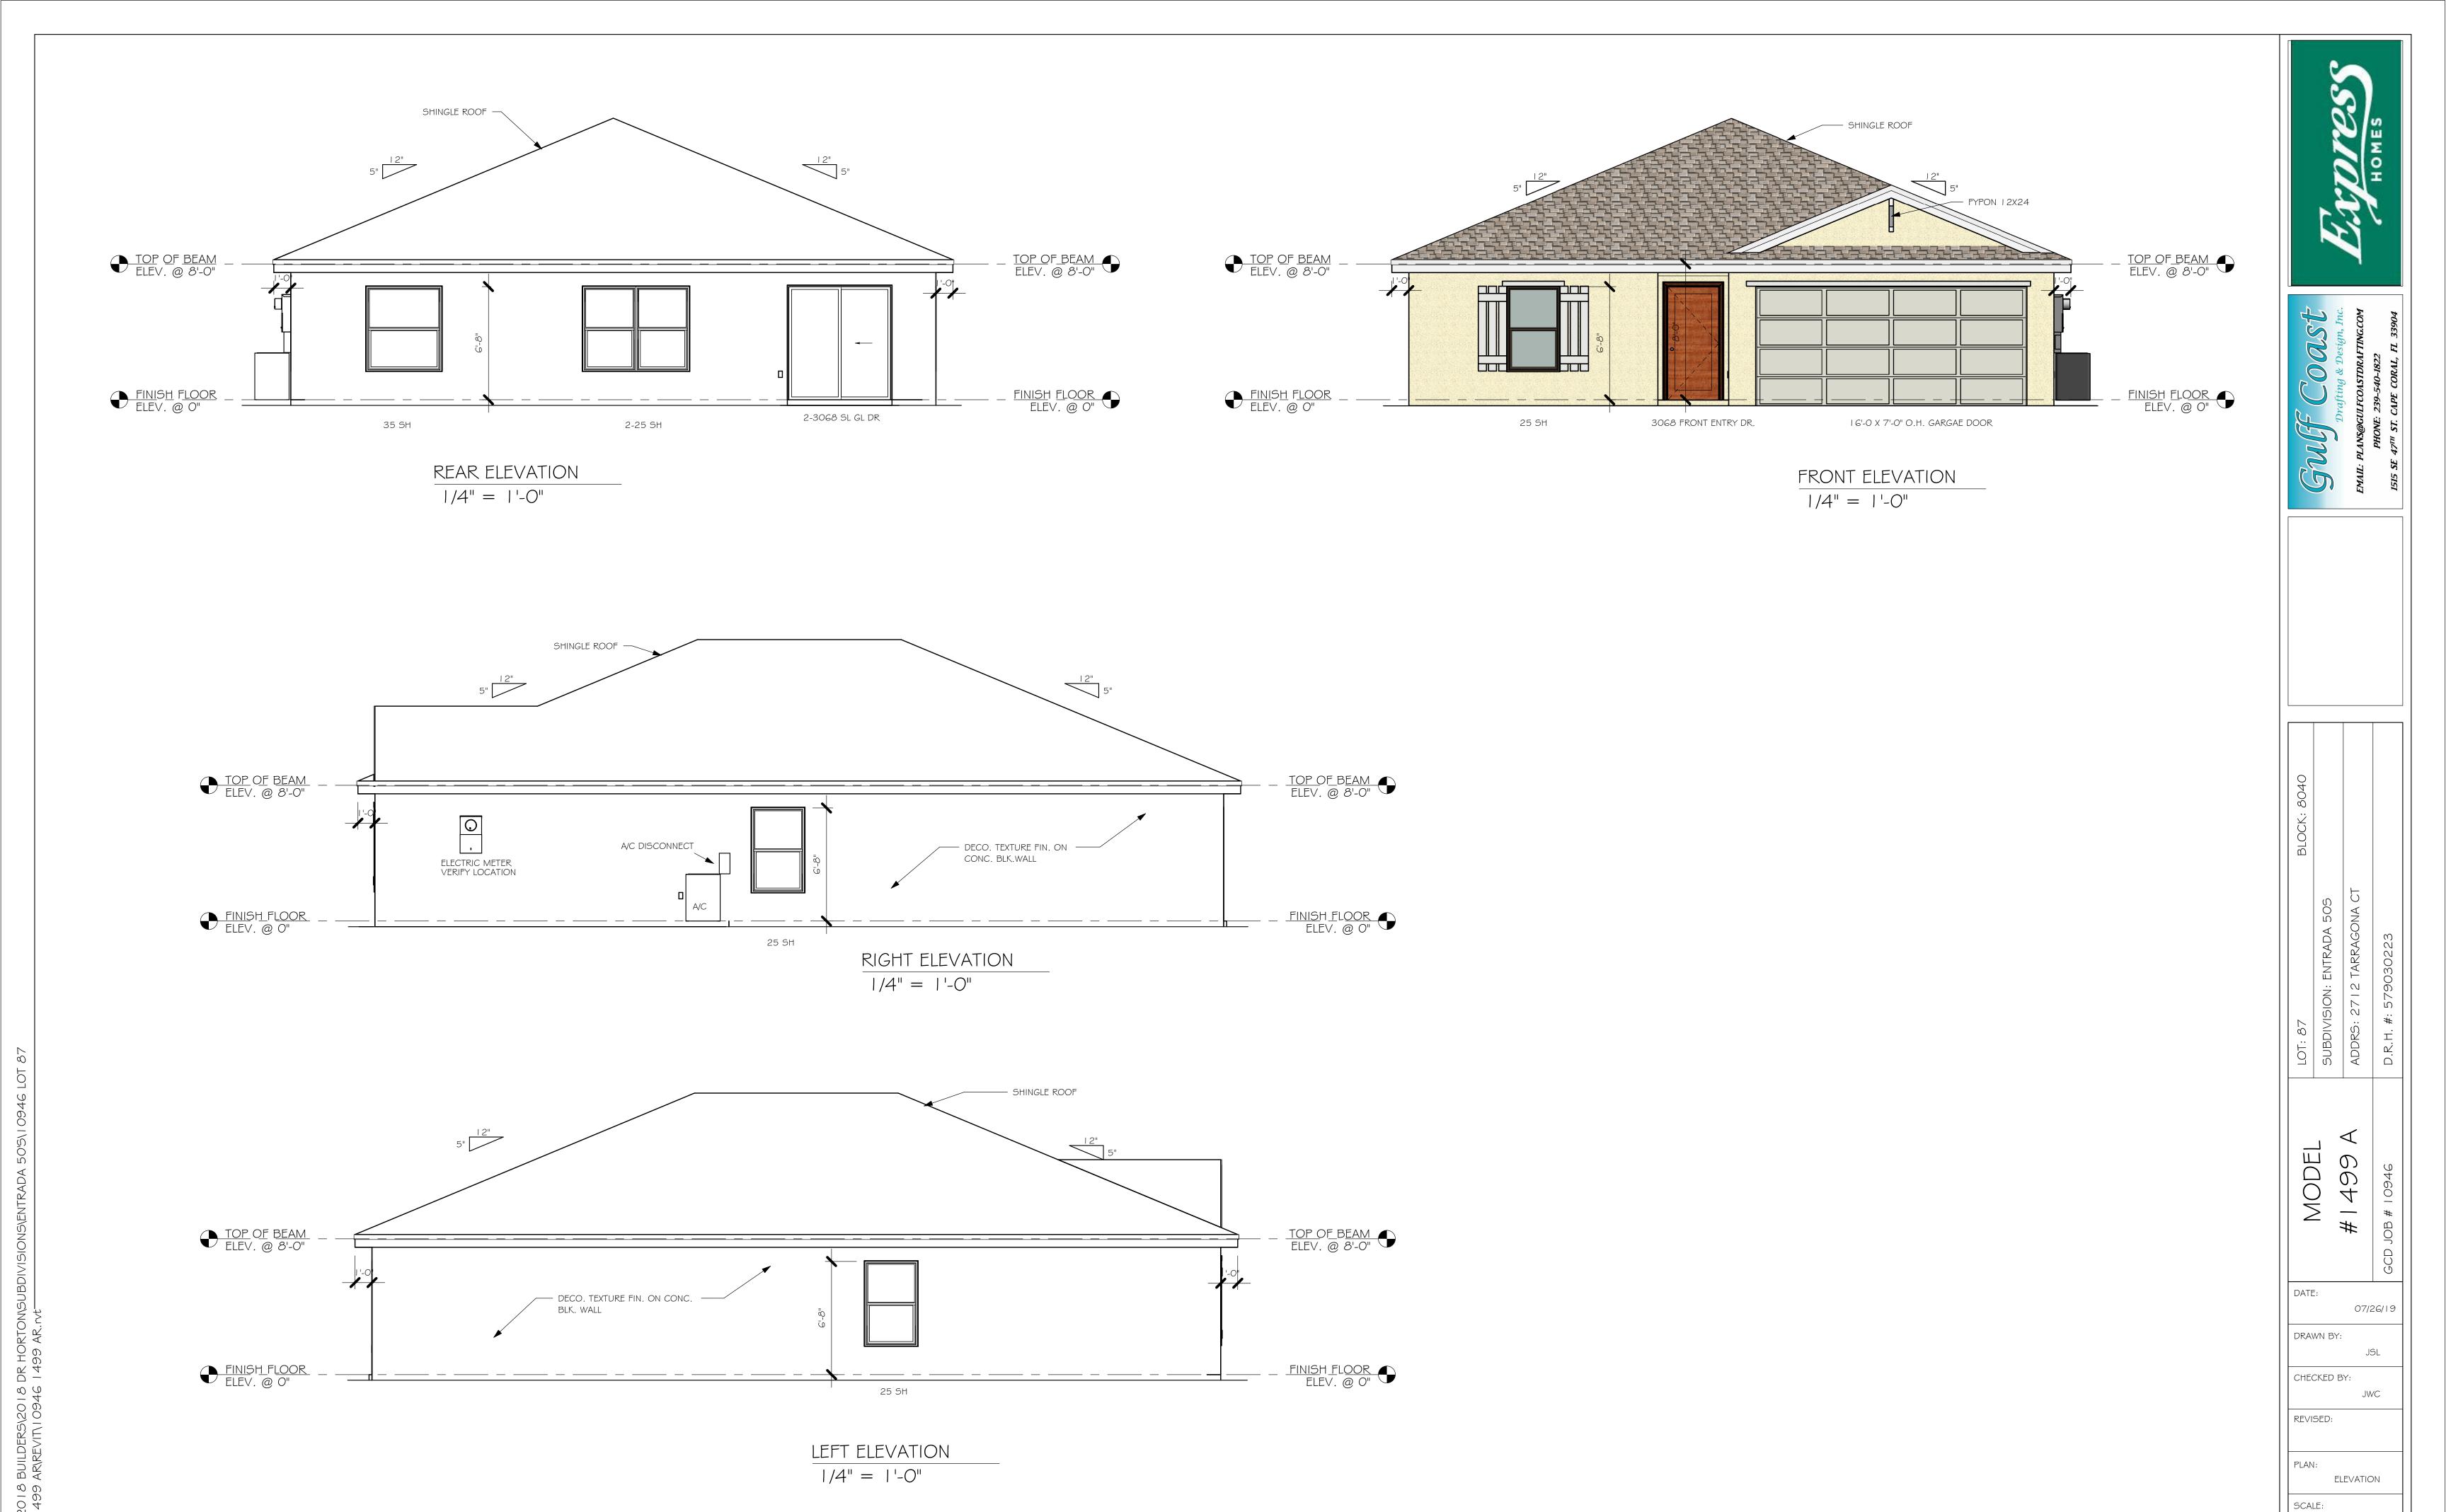



DESIGN IN ACCORDANCE WITH THE RESIDENTIAL FLORIDA BUILDING CODE 2017 - 6TH EDITION

1/4" = 1'-0"

A-1

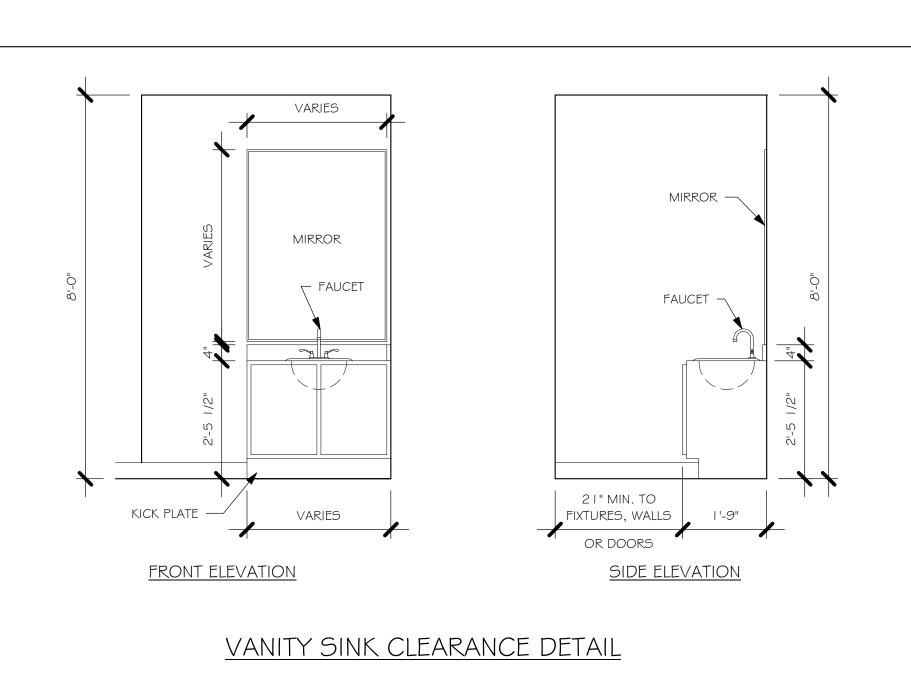

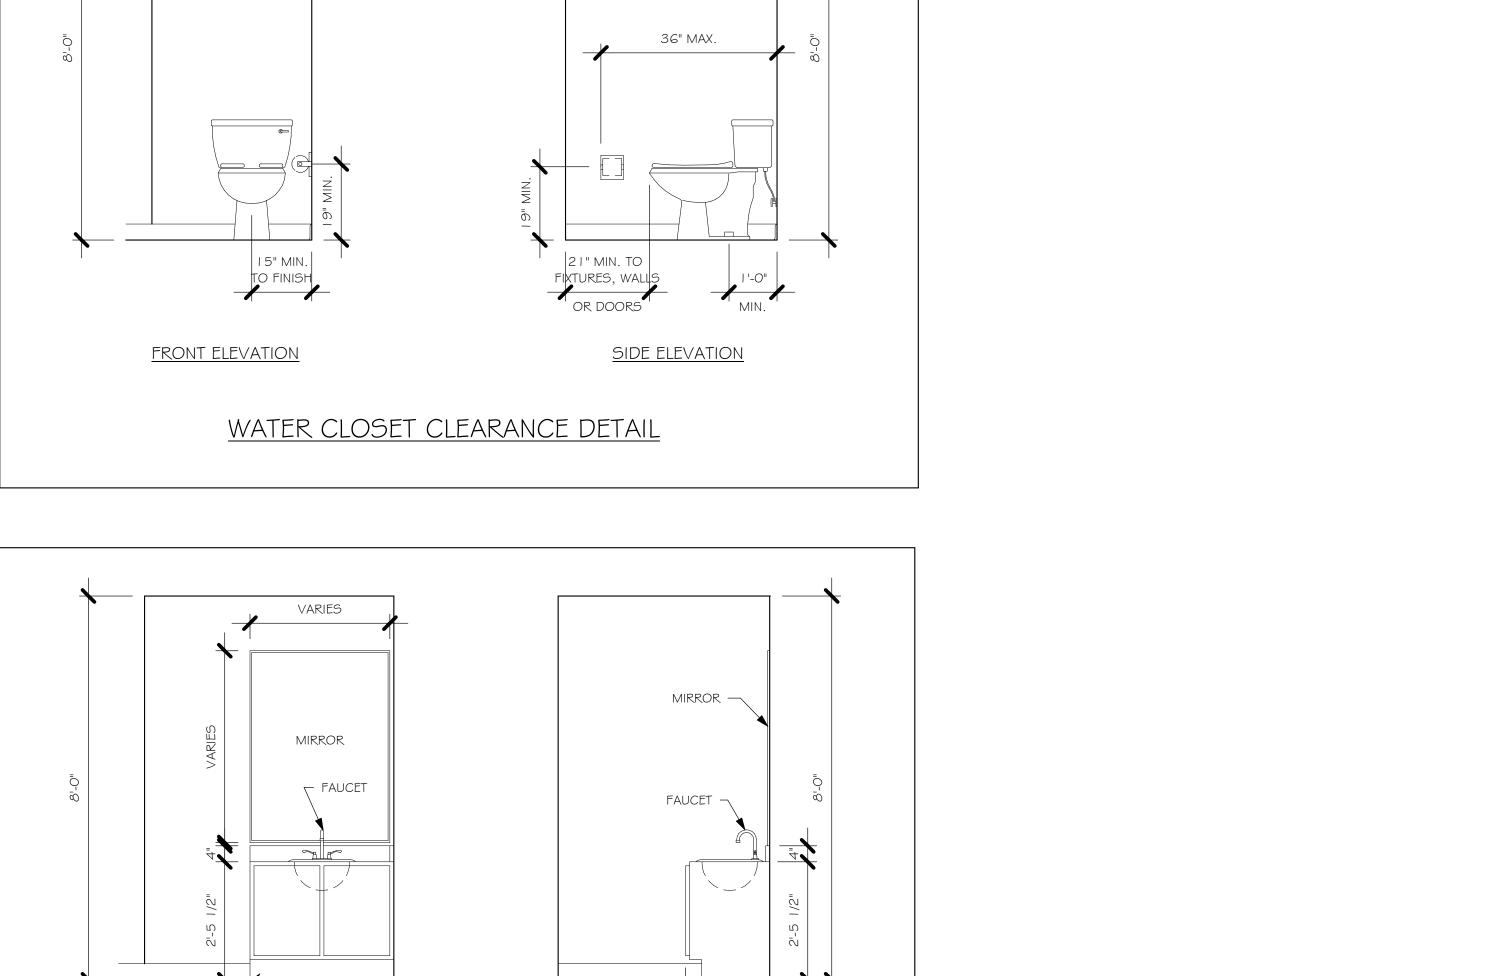

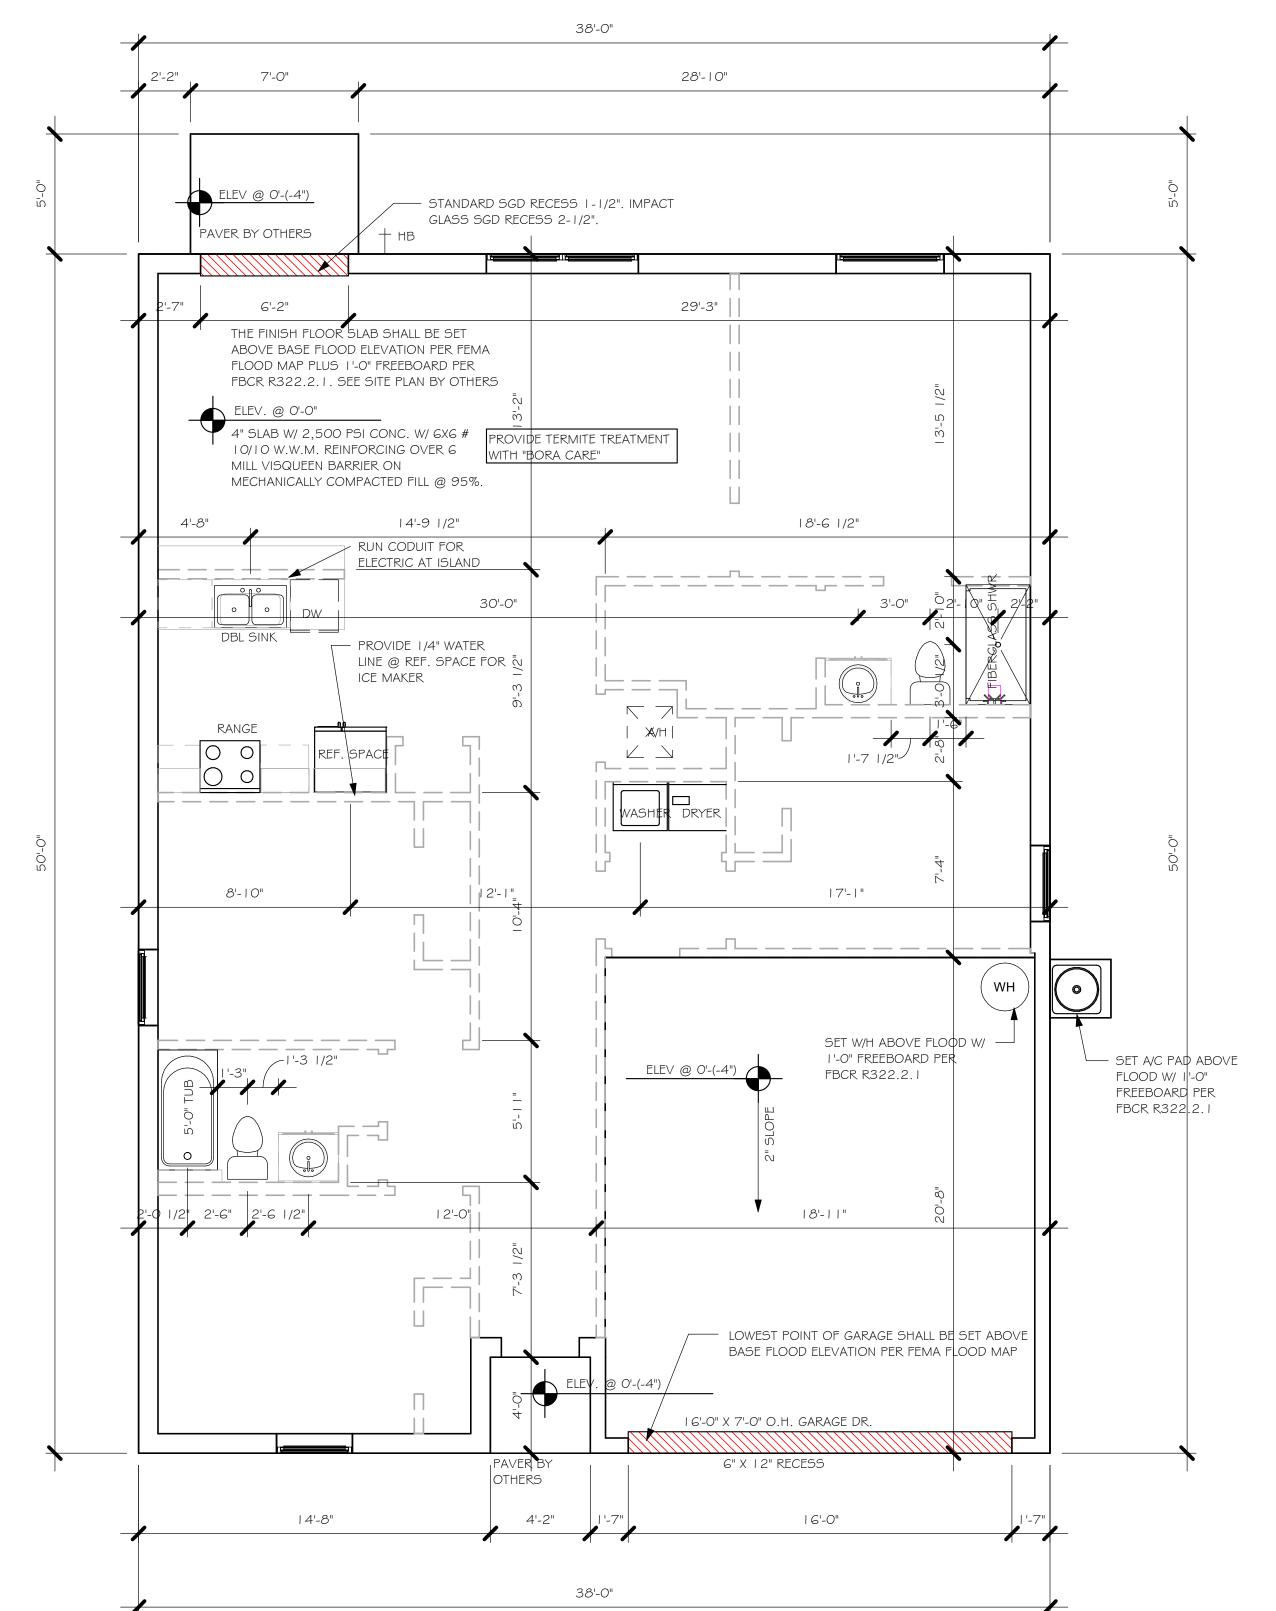

SLAB PLUMBING

1/4" = 1'-0"

MODEL

DATE:

DRAWN BY:

CHECKED BY:

REVISED:

PLAN:

SCALE:

DESIGN IN ACCORDANCE WITH THE RESIDENTIAL FLORIDA BUILDING CODE 2017 - 6TH EDITION


SLAB & PLUMBING

As indicated

A-2

07/26/19

JWC

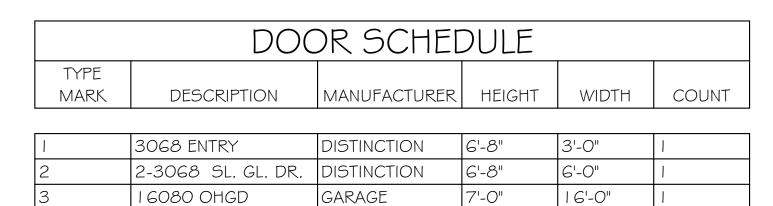

WINDOW SCHEDULE						
MARK DESCRIPTION HEIGHT WIDTH COUNT						
A	2-25 SH	5'-3"	6'-4"	1		
В	25 SH	5'-3"	3'-2"	3		
D	35 SH	5'-3"	4'-6"	1		

DOOR HEADERS				
6'-8" BI-FOLD HEADER HEIGHT 82" A.F.F.				
6'-8" SWING	HEADER HEIGHT	82 I/2" A.F.F.		
8'-0" SWING	HEADER HEIGHT	98 1/2" A.F.F.		

PLAN NOTES


- VERIFY ALL ROUGH OPENING DIMENSIONS FOR
 ALL WINDOWS AND DOORS
- 2) PROVIDE SAFETY GLAZING WITHIN 24" FROM EXIT PER FLORIDA BUILDING CODE R 308.4.2.
- 3) PROVIDE SAFETY GLAZING AT BATH/ SHOWER PER FLORIDA BUILDING CODE R 308.4.5.
- 4) NON BEARING INTERIOR FRAME WALLS SHALL BE FRAMED W/ WOOD OR METAL STUDS. SPACING SHALL NOT EXCEED 24" O.C. (NON BEARING WALLS ONLY)
- 5) PROVIDE DEAD WOOD IN ATTIC FOR OVERHEAD GARAGE DOOR HARDWARE
- 6) KITCHEN KNEE WALL TO BE FRAMED W/ TOP @ 34 1/2" A.F.F.
- 7) INSTALL SMOOTH WALLS IN KITCHEN AND ALL BATHROOM AREAS
- 8) WHERE DRYWALL CEILING IS APPLIED TO TRUSSES
 @ 24" O.C. USE 5/8" DRYWALL OR 1/2" SAG
 RESISTANT PER SEC. 702.3.5
- THE GARAGE SHALL BE SEPARATED FROM THE
 RESIDENCE & ATTIC BY NOT LESS THEN 1/2" GYPSUM
 BOARD APPLIED TO THE GARAGE SIDE. GARAGES
 BENEATH HABITABLE ROOMS SHALL BE SEPARATED
 WITH NOT LESS THAN 5/8" TYPE "X" GYPSUM BOARD
 OR EQUIVALENT. WHERE THE SEPARATION IS A
 FLOOR CEILING ASSEMBLY, THE STRUCTURE
 SUPPORTING THE SEPARTION SHALL ALSO BE
 PROTECTED BY NOT LESS THAN 1/2" GYPSOM BOARD
 OR EQUIVALENT
- 10) INSTALL 1 3/8" THICK SOLID WOOD DOOR BETWEEN
 LIVING AND GARAGE PER FLORIDA BUILDING CODE
 R302 1 5
- II) ALL WINDOWS INSTALLED 72" ABOVE GRADE MUST COMPLY WITH RGI2.2 MIN 24" SILL HEIGHT OR PROVIDED WITH AN APPROVED WINDOW FALL PRVENTION DEVICE
- | 12) ALL CLOSET SHELVES TO BE | 2". ALL PANTRY & LINEN TO BE (4)-|6" SHELVES |8" O.F.F. W/ |5"


IN	INTERIOR DOOR SCHEDULE						
MARK	DOOR WIDTH	NOTES					
	3'-0"	P.K. = POCKET DOOR					
2	2'-8"	BF = BI-FOLD DOOR					
3	2'-6"	D.1 DI-1 OLD DOOK					
4	2'-4"	B.P. = BI-PASS DOOR					
5	2'-0"	L.V. = LOUVERED DOOR					
6	1'-8"						
7	1'-6"						
8	2'-11"						

	-				
K. = POCKET DOOR		SOLIADE FOOTACE			
F. = BI-FOLD DOOR		SQUARE FOOTAGE			
B BLBAGG DOOR		LIVING AREA	1499		
P. = BI-PASS DOOR		GARAGE AREA	385		
/. = LOUVERED DOOR		FRONT PORCH/ ENTRY AREA	16		
		TOTAL SQUARE FOOTAGE	1,900		

	BATHROOM NOTES
TB TOWEL BAR	ALL TUB DECKS @ 21" A.F.F
TP TOILET PAPER	ALL BLOCKING TO BE PT IN SHOWERS
1.O.14	TOWEL BAR TOILET PAPER ROLL 4" 4" 4" MINMIN.

CABINET BACKING					
KITCHEN UPPER TOP @ 84" BASE TOP @ 35"					
MASTER BATH	UPPER	BASE TOP @ 35"			
GUEST BATH	UPPER	BASE TOP @ 31"			
LAUNDRY ROOM	UPPER TOP @ 84"	BASE			

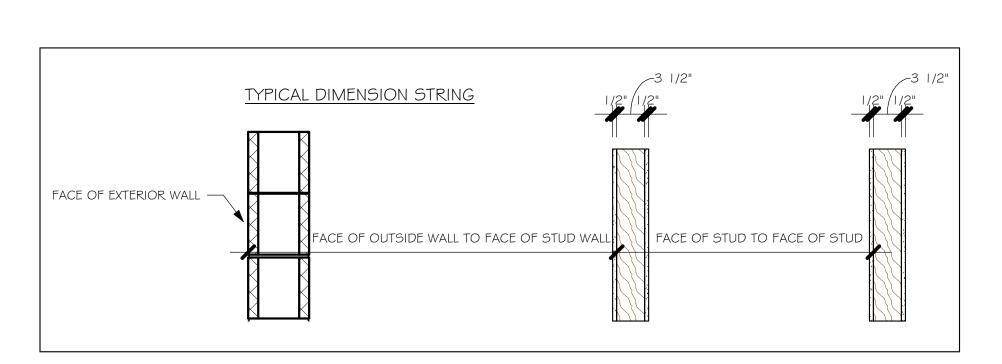

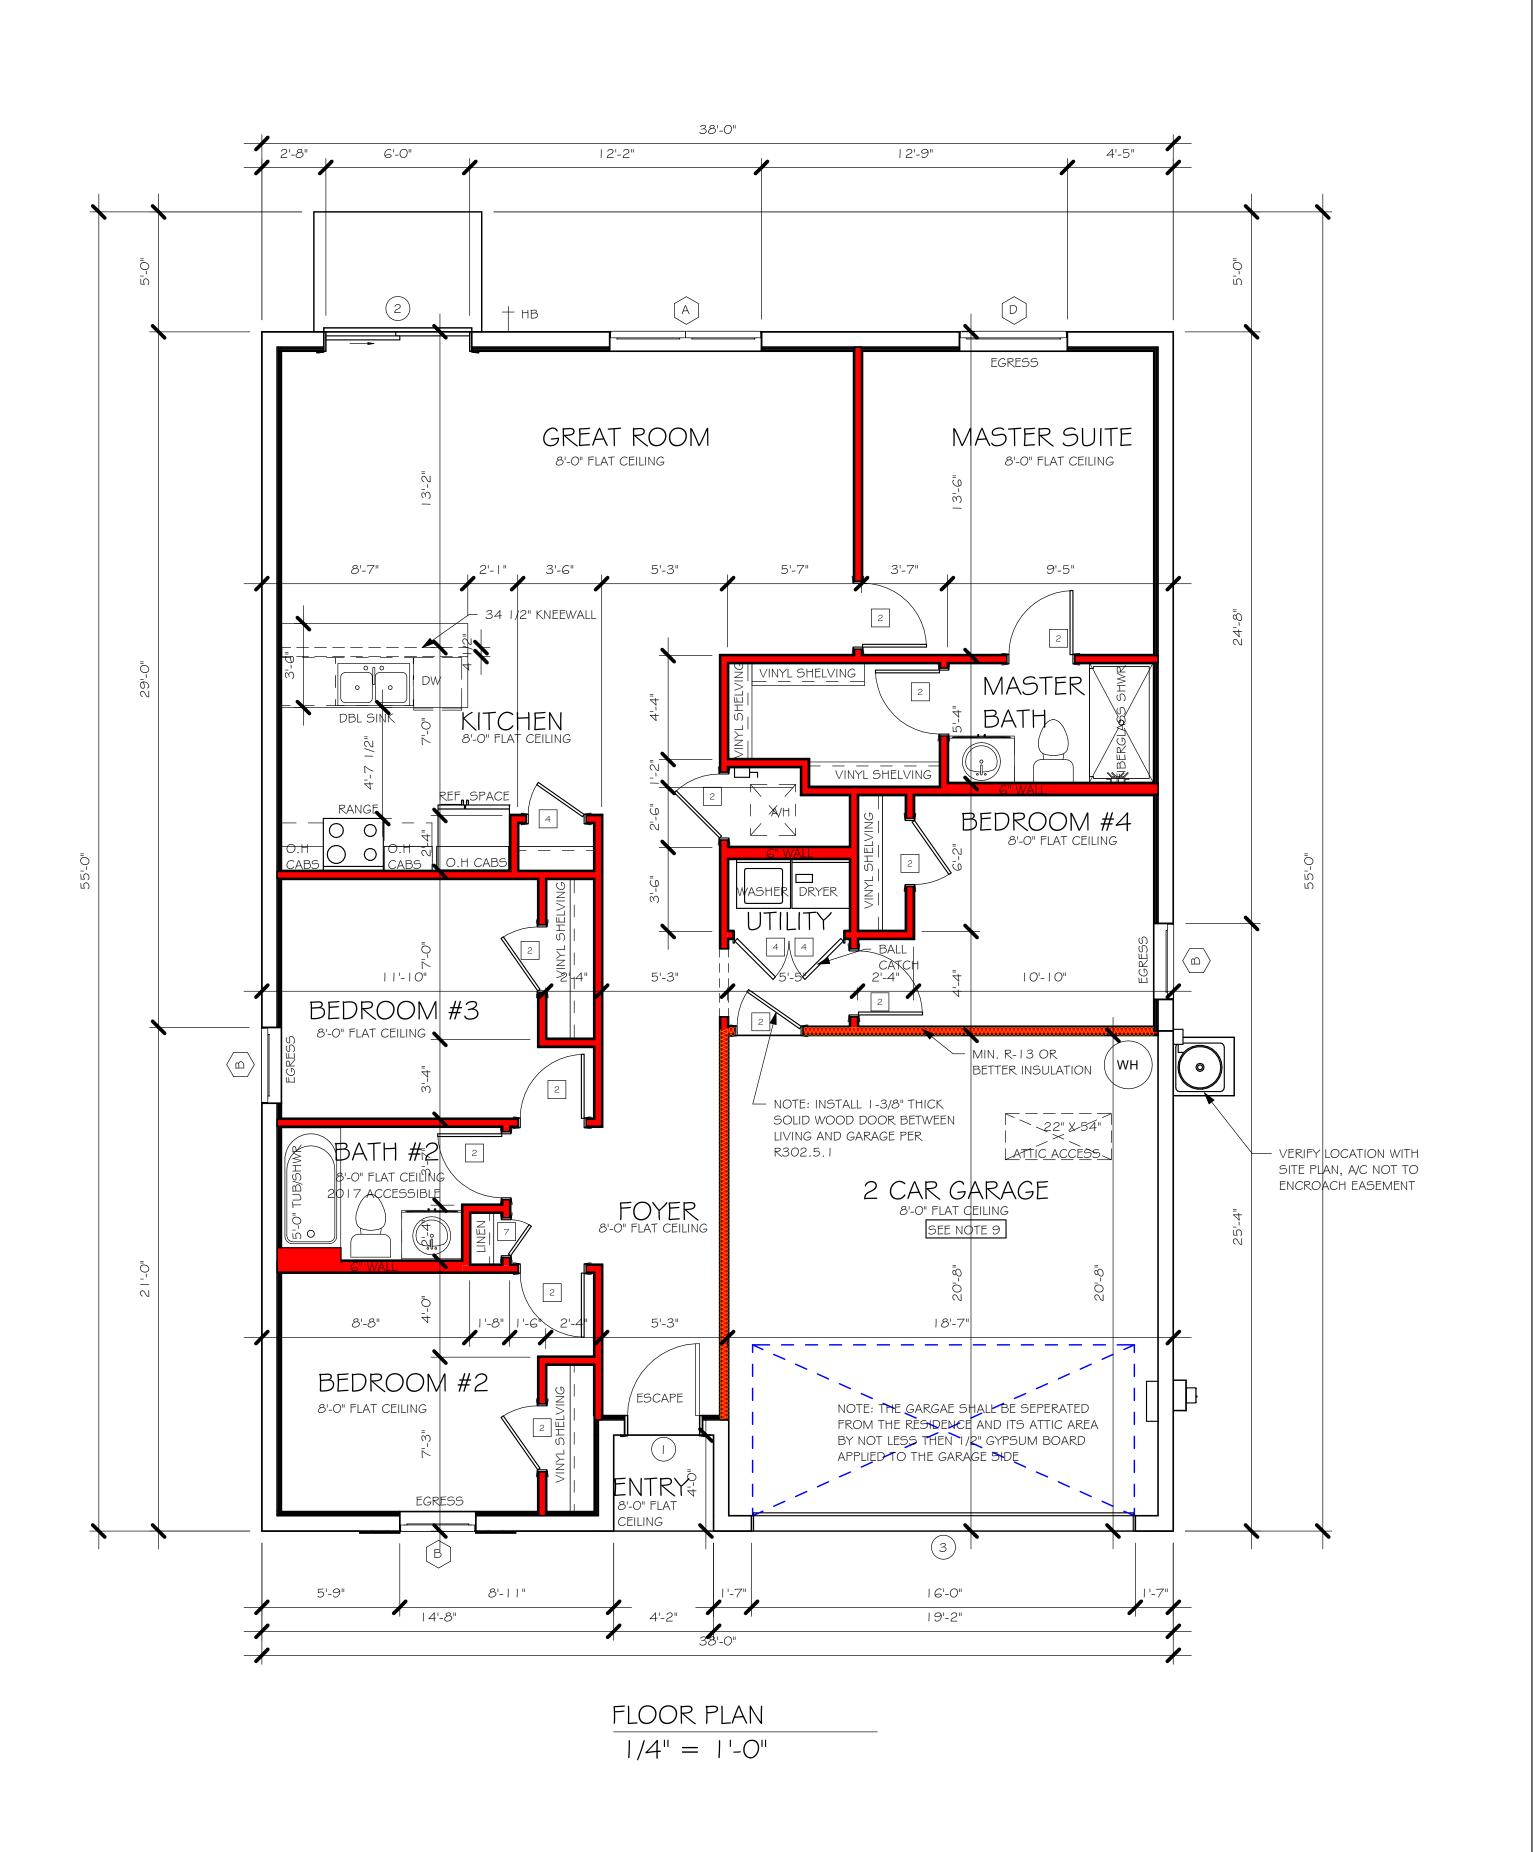

1SION: ENTRADA 5

DATE:

DRAWN BY:

CHECKED BY:

REVISED:

SCALE:

DESIGN IN ACCORDANCE WITH THE RESIDENTIAL FLORIDA BUILDING CODE 2017 - 6TH EDITION


07/26/19

JWC

FLOOR


As indicated

Z:\MASTER\2018 BUILDERS\2018 DR HORTON\SUBDIVISIONS\ENTRADA 50'S\109

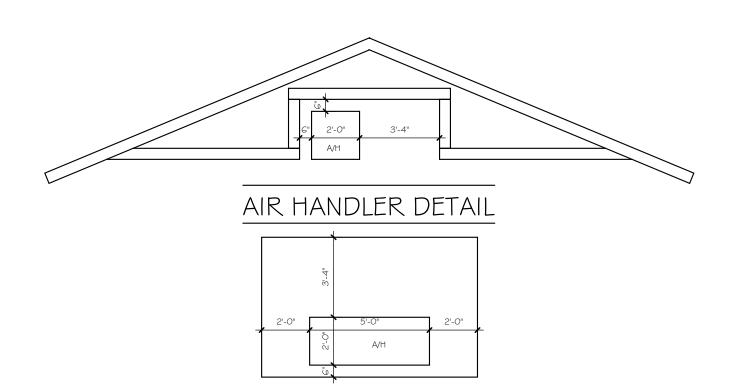

MODEL 1499 A: ATTIC VENTILATION FBCR R806 COORDINATE VENTING REQUIREMENTS WITH ENERGY CALCULATIONS								
				SOFFIT ONLY (NO ROOF VE		WIT	ΓΗ ROOF VE (R.V.)	NTS (1/300)
	AREAS (SQ.	FT.)	ATI	TIC VENTILATIO	ON REQUIRED	ATTIC VENTILATION REQUIRED		ON REQUIRED
MARK	ATTIC	SOFFIT	ATTIC AREA/150	REQ'D AIR FLOW OF SOFFIT	QUAD 4 SOFFIT HAS	ATTIC AREA/300	QUANTITY OF ROOF VENTS	MIN AIR FLOW OF SOFFIT
1st STORY	2080.0 SQ. FT.	180.0 SQ. FT.	13.87 SQ.FT.	7.71%	8.15%	SQ. FT.	-	%
			"SOFFIT ONLY" QUALIFIES		ROOF VENTS ARE NOT REQUIRED			
			SOFFIT MODEL ACM QUAD 4, FULL VENT, NARROW PATTERN, 8.15% FREE AIR FLOW		22-3/8" BASE	LOMANCO O.97 SQ. F	SE	



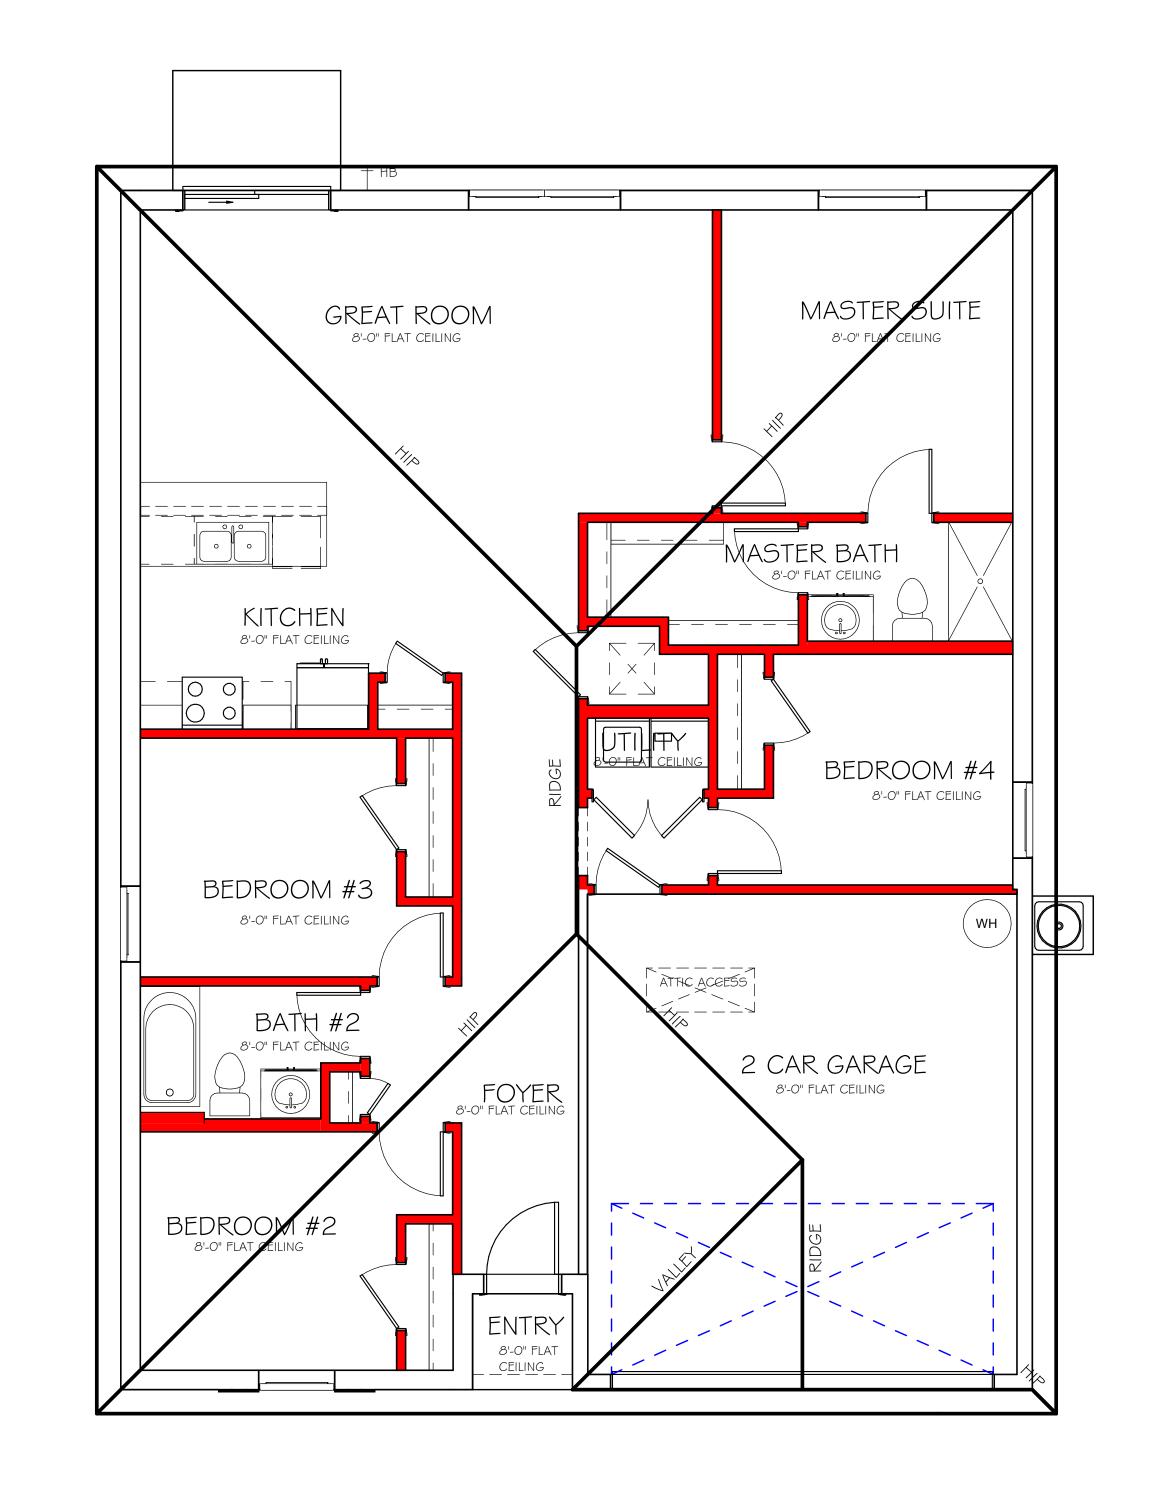

 $\frac{\text{ROOF PLAN}}{1/4" = 1'-0"}$

MODEL DATE: 07/26/19 DRAWN BY: CHECKED BY: JWC REVISED: PLAN: ROOF SCALE: As indicated A-4


STER\2018 BUILDERS\2018 DR H 040 1499 AR\REVIT\10946 149


DESIGN IN ACCORDANCE WITH THE RESIDENTIAL FLORIDA BUILDING CODE 2017 - 6TH EDITION

INSTALL PHONE AND T.V PER CONTRACT.

INSTALL ALL ELECTRICAL PER NEC 2014

	ELECTRIC		
150	AMP SERVICE		
TAG	QUANTITY	PRODUCT	
Α	(X)	(RECESSED CANS)	
В	(X)	(VAPORS)	
С	(X)	(PENDANT LIGHT	
D	(9)	(10" MUSHROOMS)	
E (2)		(24" 3 LT)	
F	(X)	(36" LT)	
G	(X)	(NOT USED)	
Н	(2)	(COACH LIGHTS)	
	(X)		
J	(X)	(J BOX)	
K	(1)	(4' FLUORESCENT)	
L	(X)	(2' FLUORESCENT)	
М	(X)	(5LT CHANDELIER)	
Ν	(X)	(3 LT)	
0	(X)	(PENDANT/ NOOK)	
Р	(X)	(X)	

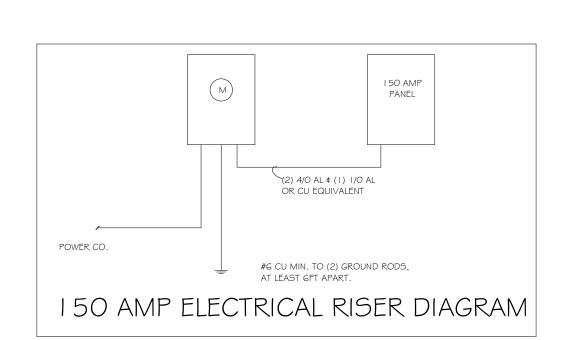

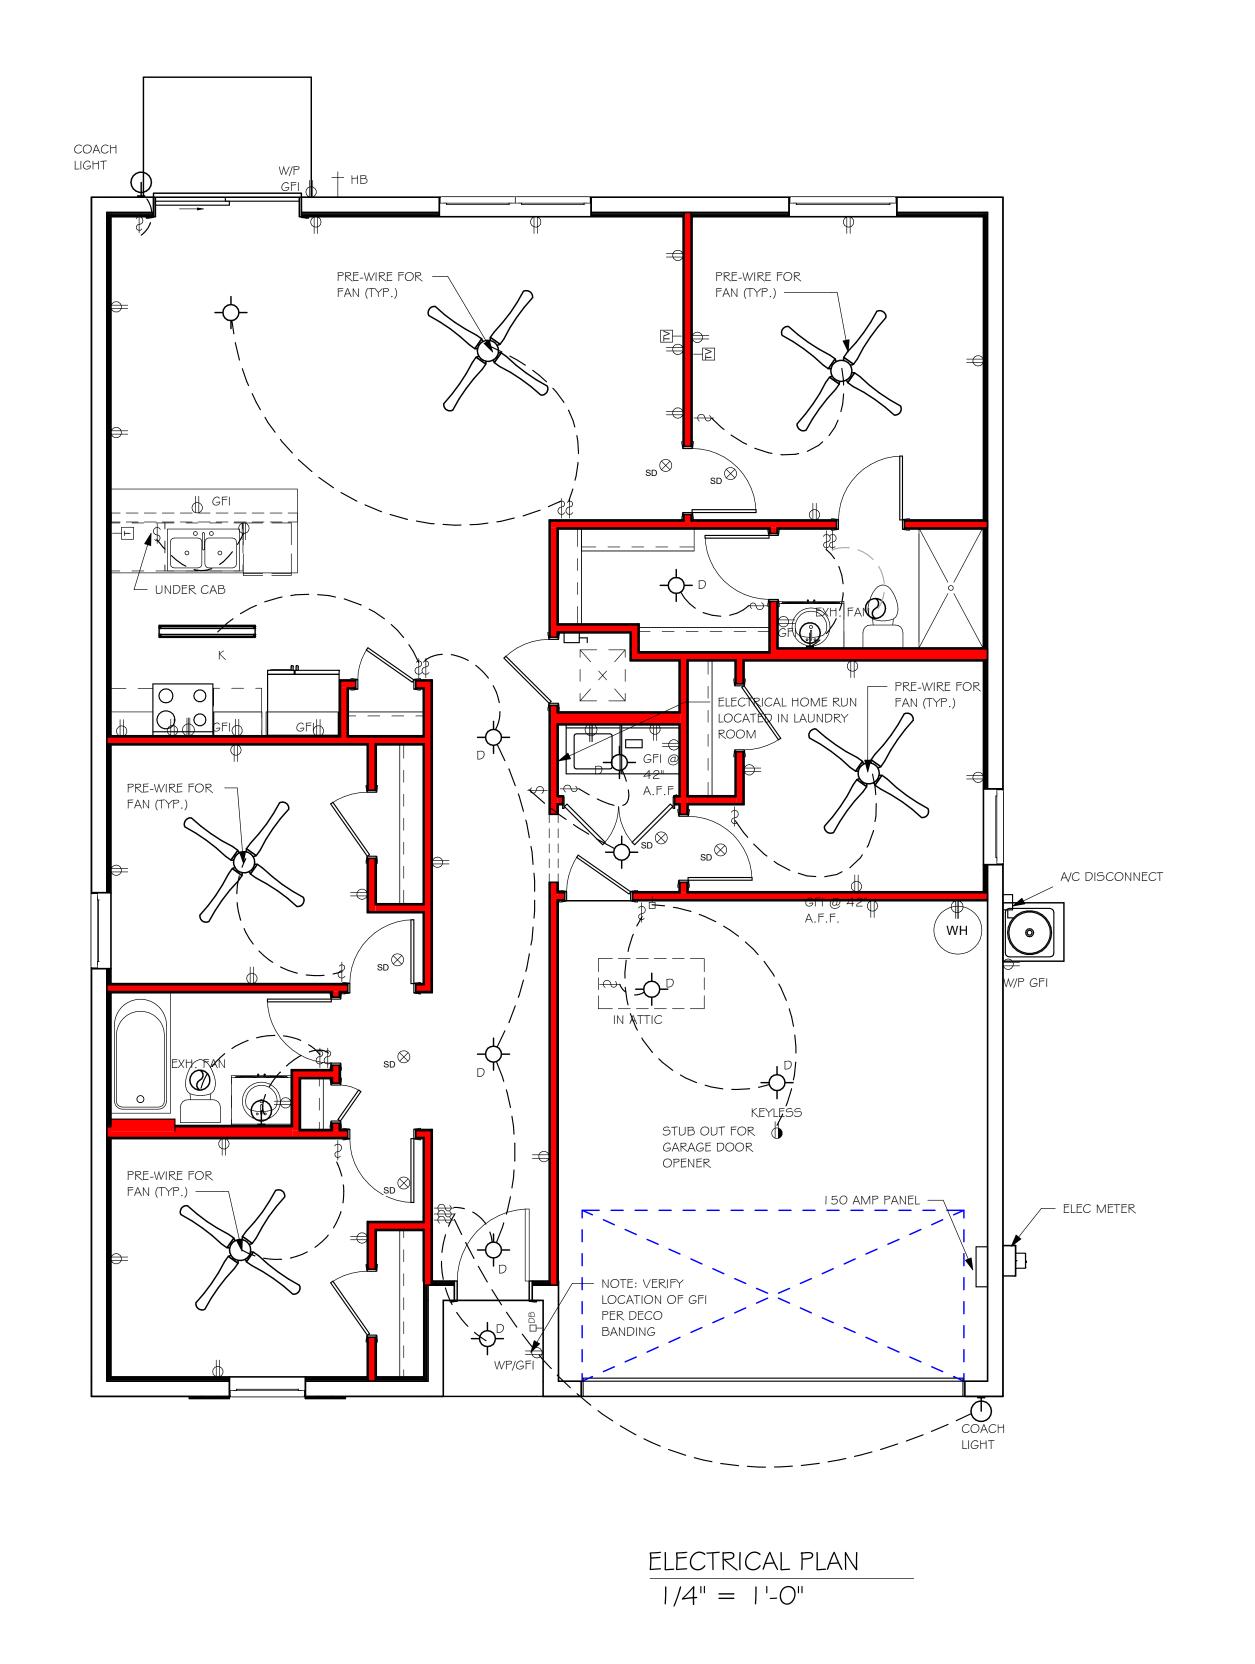

DATE:

DRAWN BY:

CHECKED BY:

REVISED:

PLAN:

SCALE:

DESIGN IN ACCORDANCE WITH THE RESIDENTIAL FLORIDA BUILDING CODE 2017 - 6TH EDITION


07/26/19

JWC

ELECTRICAL

As indicated

Z:\MASTER\2018 BUILDERS\2018 DR HORTON\SUBDIVISIONS\ENTRADA 50'S\10946 LOT 87

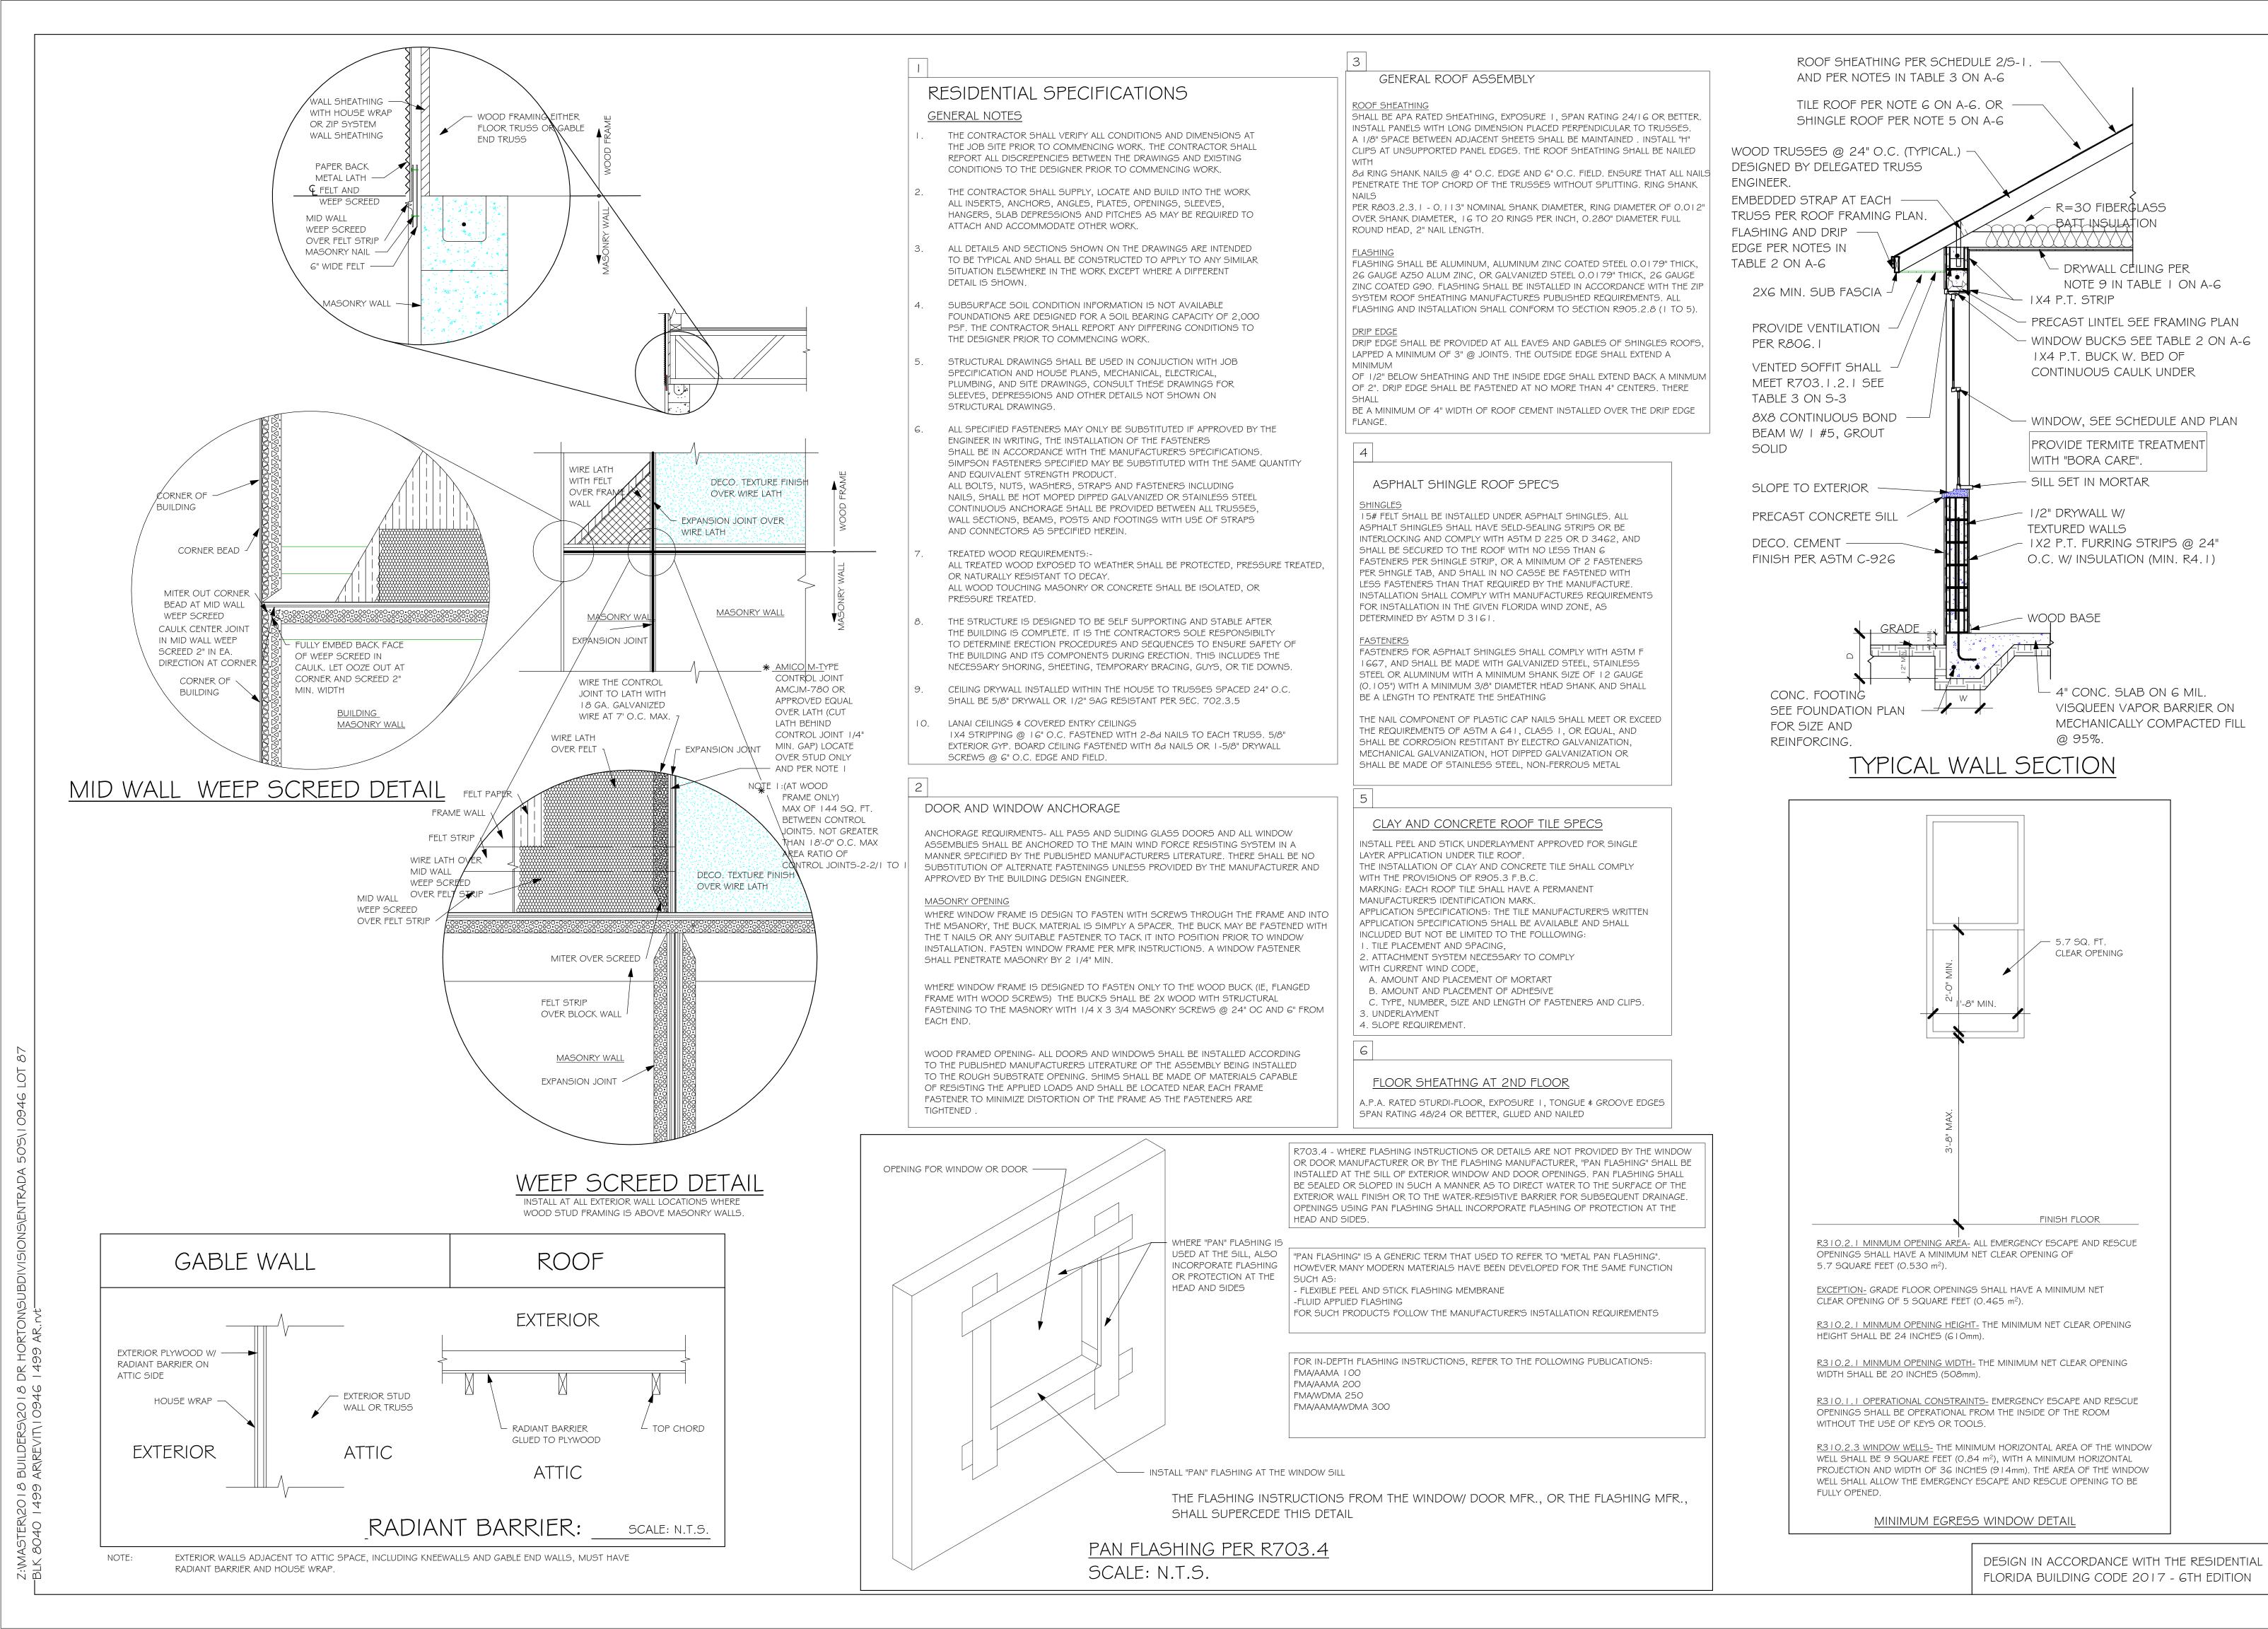

Express HOMES

GWIF COOST
Drafting & Design, IN
EMAIL: PLANS@GULFCOASTDRAFTING.CO
PHONE: 239-540-1822

LOT: 87
SUBDIVISION: ENTRADA 50S
ADDRS: 27 I 2 TARRAGONA CT
D.R.H. #: 579030223

MODEL #1499 A

DATE: 07/26/19

DRAWN BY:

CHECKED BY:

JWC


REVISED:

SECTIONS


CALE:

As indicated


A-6

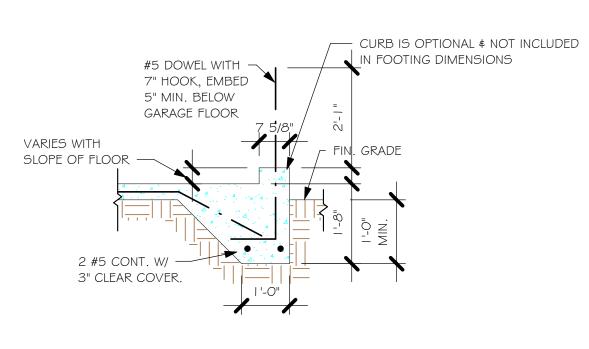


 $\frac{\text{"F3" WITH CURB AT GARAGE}}{1/2\text{"} = 1\text{'-0"}}$

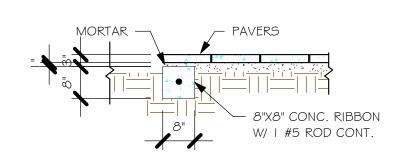


 $\frac{\text{"P" PAVERS DETAIL ENTRY/ LANAII}}{\text{1/2"} = \text{1'-0"}}$

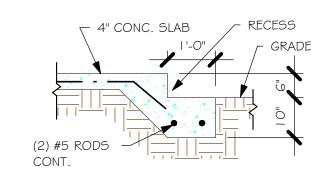

 $\frac{\text{GARAGE DOOR RECESS}}{1/2" = 1'-0"}$

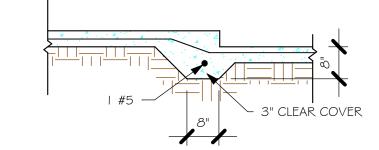

 $\frac{\text{"F6A" STEP DOWN}}{1/2\text{"} = 1\text{'-0"}}$

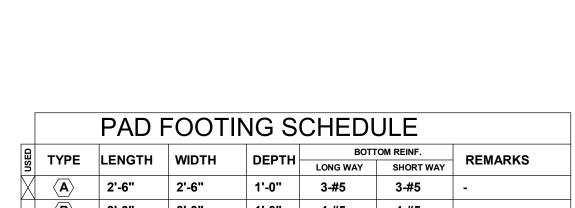

1'-0"

1'-2"

1'-2"

5-#5

6-#5

5-#5

6-#5

WALL FOOTING SCHEDULE							
USED	TYPE	LENGTH	WIDTH	DEPTH	BOTTOM REINFORCING	SHAPE	
	F1	CONT.	1'-4"	0'-8"	2-#5		
	F2	CONT.	1'-8"	0'-10"	2-#5		
X	F3	CONT.	1'-0"	1'-8"	2-#5		ADD CURB TO GARAGE, SEE DETAIL
Ì	F4	CONT.	1'-4"	1'-8"	2-#5		DETAIL
	F5	CONT.	1'-4"	1'-0"	2-#5	—	
	F6	CONT.	1'-4"	1'-0"	2-#5	#	
X	F6A	CONT.	0'-8"	0'-8"	1-#5		


0'-8" 1-#5 🔄

PROVIDE CORNER BARS PER 6/S-3

| TE | CONT. | 0'-8"

5'-0"


5'-0"

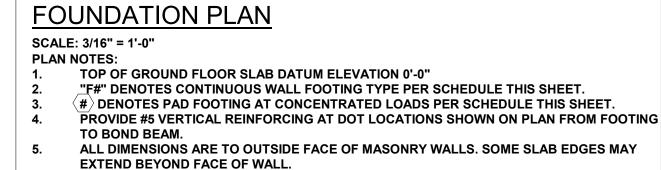

PROVIDE PRESSURE TREATED BUCKS AT WINDOWS/ DOORS PER DETAIL 7/S-3.

DOOR SUPPLIER.

FOR DIMENSIONS OF ROUGH OPENINGS IN MASONRY WALLS, COORDINATE WITH WINDOW/

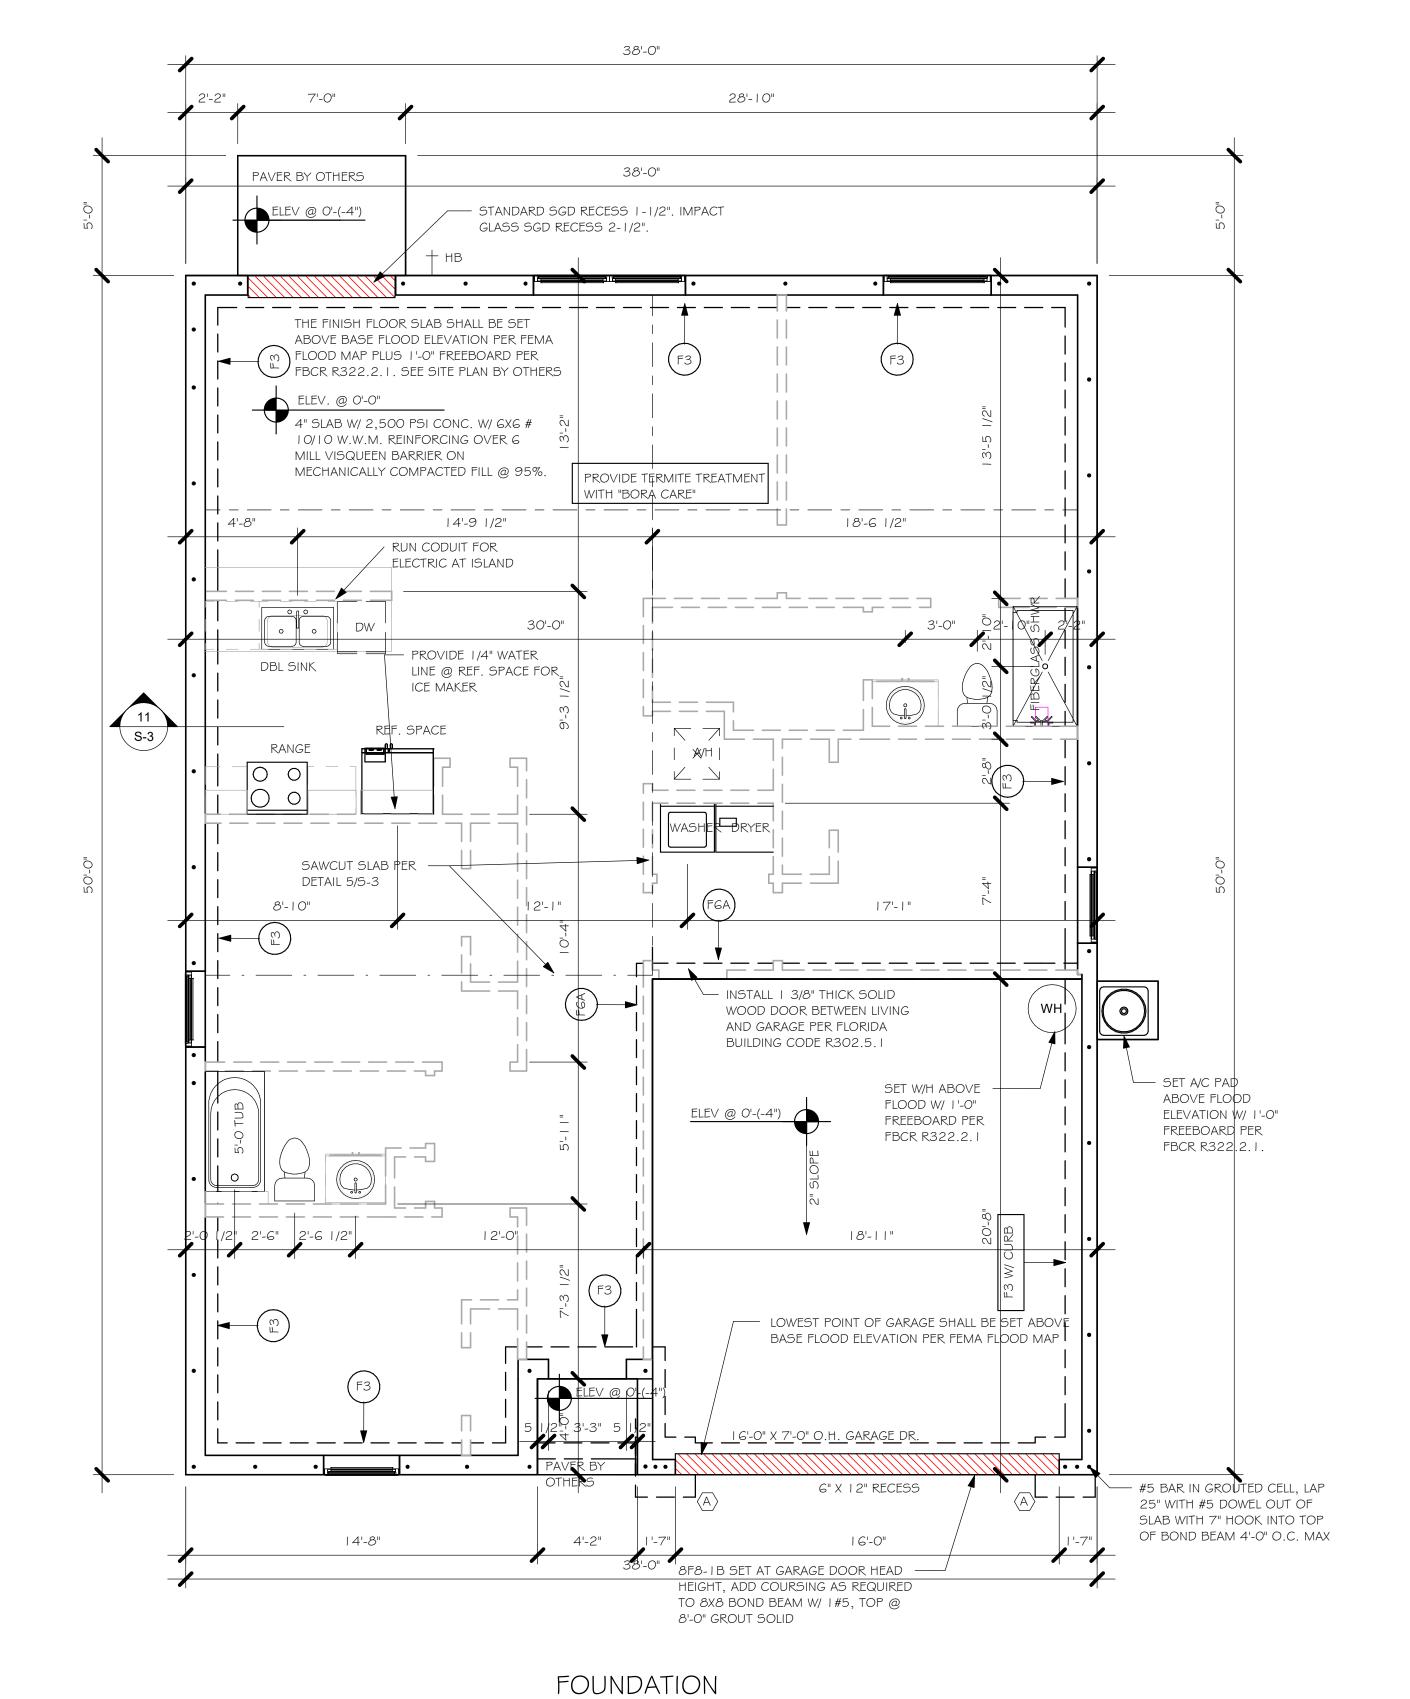

1/4" = 1'-0"

DESIGN IN ACCORDANCE WITH THE RESIDENTIAL FLORIDA BUILDING CODE 2017 - 6TH EDITION

Z:\MASTER\2018 BUILDERS\2018 DR HORTON\SUBDIVISIONS\ENTRADA !

PLAN:
FOUNDATION PLAN

SCALE:
As indicated

07/26/19

JWC

DATE:

DRAWN BY:

CHECKED BY:

REVISED:

2712 TARRA

07/26/19

DRAWN BY: JSL CHECKED BY: JWC

DATE:

REVISED:

ROOF FRAMING PLAN SCALE:

As indicated


DESIGN IN ACCORDANCE WITH THE RESIDENTIAL FLORIDA BUILDING CODE 2017 - 6TH EDITION


TRUSS STRAPPING TO MASONRY INSTALL HTA MAX TRUSS UPLIFT **FASTENER** 16-18 AT ALL CONNECTOR @ 24" OC (LBS) TRUSSES TO (I) HTAI6-18 1615 lb UPLIFT 10-10dx1/2", EMBED 4" **1**615 FOR HIGHER (I) HTA20 10-10dx1/2", EMBED 4" 1870 UPLIFTS, SEE 2430 (1 PLY) (2)HTA16-18 10-10dx1/2", EMBED 4" NOTES ON PLAN. (2)HTA16 -18 10-10dx1/2", EMBED 4" 2800 (2 PLY) (2) HTA20 10-10dx 1/2", EMBED 4" 3170 (2 PLY) 5005 HTT45 5/8"ø ATR, EPOXY 12"

I. PROVIDE A STRAP FROM THE ABOVE LIST AT EACH ROOF TRUSS BEARING POINT, BASED ON THE TRUSS UPLIFT VALUES IN THE SIGNED AND SEALED TRUSS DESIGN PACKAGE AND SUITABLE FOR THE GEOMETRY. EMBED STRAP ON -C/L OF WALL.

- CONNECTORS ARE USP STRUCTURAL CONNECTORS. ALL CONNECTORS SHALL BE INSTALLED IN STRICT ACCORDANCE WITH USP PRINTED INSTUCTIONS. SUBSTITUTIONS MUST BE APPROVED IN WRITING BY THE ENGINEER OF RECORD.
- WHERE EMBEDDED STRAPS ARE MISSING, OR MIS-LOCATED, INSTALL RETROFIT STRAP PER 2/S-4.
- 'ATR' = ALLTHREAD. DRILL AND EPOXY WITH USP EPOXY PER MFR.

INSTRUCTIONS.

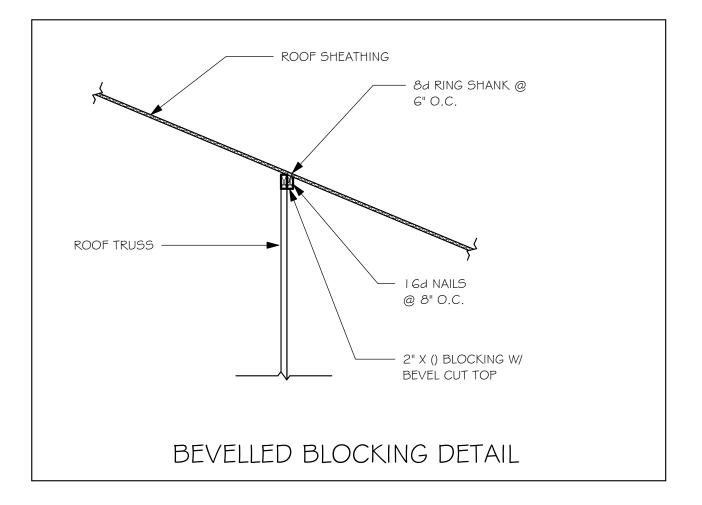

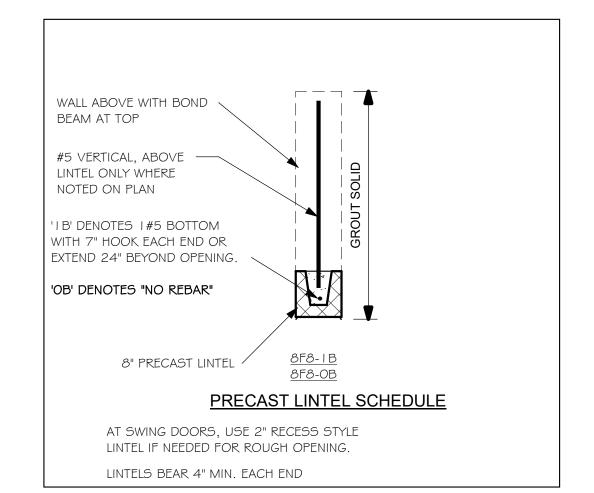


PLAN NOTES:

- ROOF TRUSS BEARING 8'-O", SEE LEGEND. ROOF FRAMING SHALL BE WOOD TRUSSES DESIGNED BYA DELEGATED TRUSS ENGINEER PER DESIGN CRITERIA ON SHEET S-3.
- PROVIDE STRAPPING AT TRUSSES PER NOTES ON THIS FOR NAILING OF ROOF AND FLOOR DECK, SEE I AND 2


ON 5-3. 8F8-1B etc., DENOTES PRECAST LINTEL ABOVE DOOR, WINDOW OPENING PER SCHEDULE THIS SHEET. AT TRUSS BEARING, PROVIDE 8x8 MASONRY BOND BEAM W/ I #5 CONTINUOUS, SEE DETAIL I I/S-3.

BEARING HEIGHT

TRUSS BEARING CONDITIONS AND STRAPPING IS BASED ON TRUSS LAYOUT PREPARED BY SCOSTA JOB# 44116 DATED: 05/24/18 REVISED 9/15/18

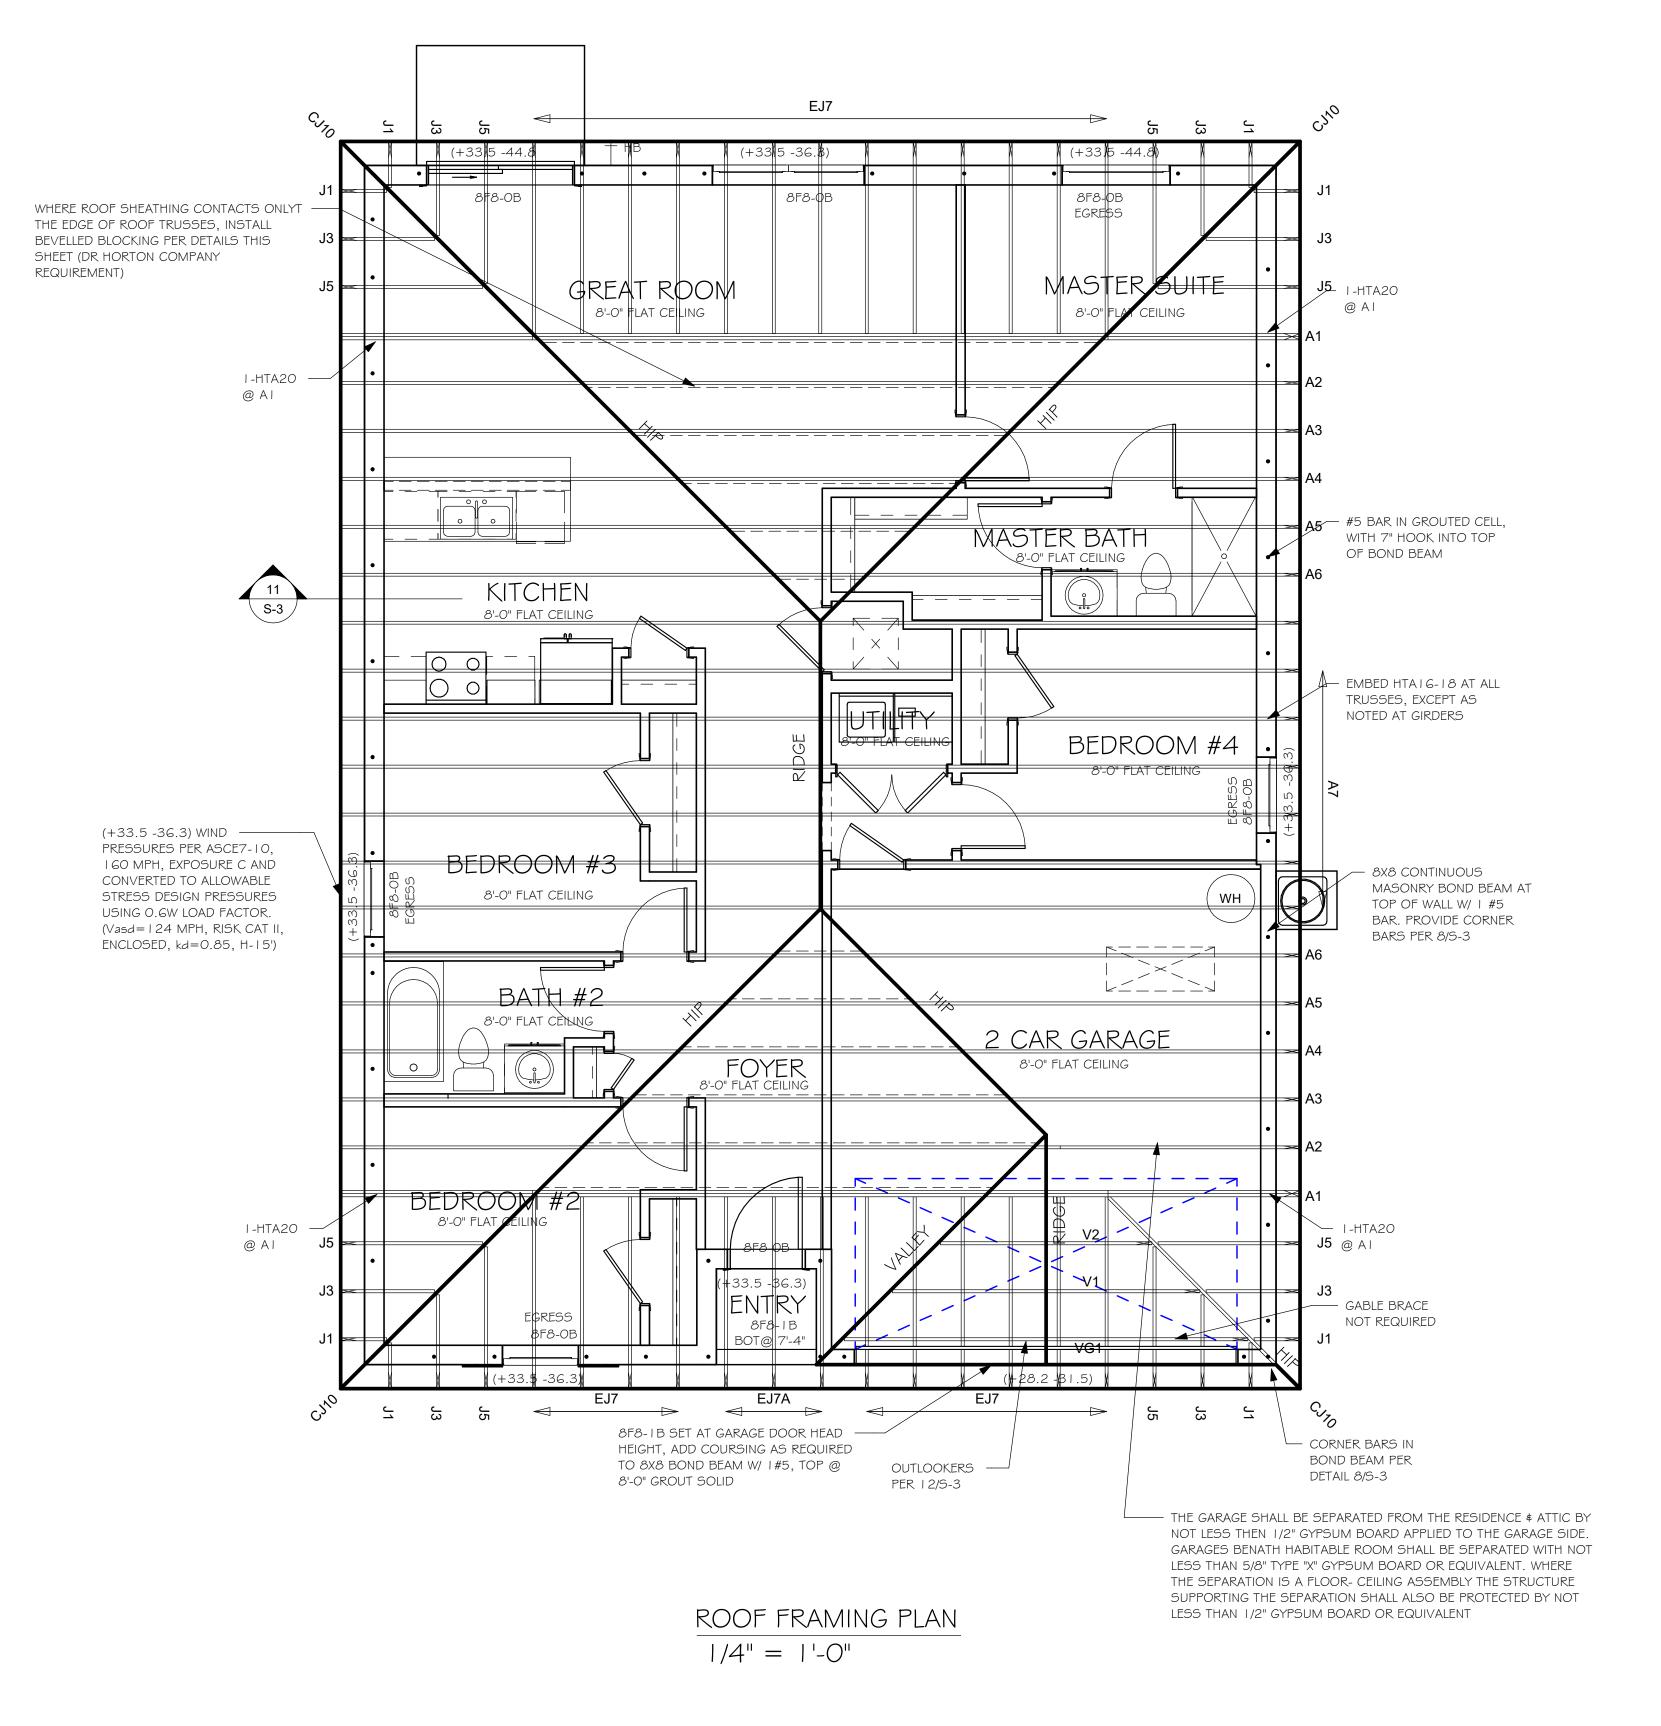

= BEARING @ 8'-0"

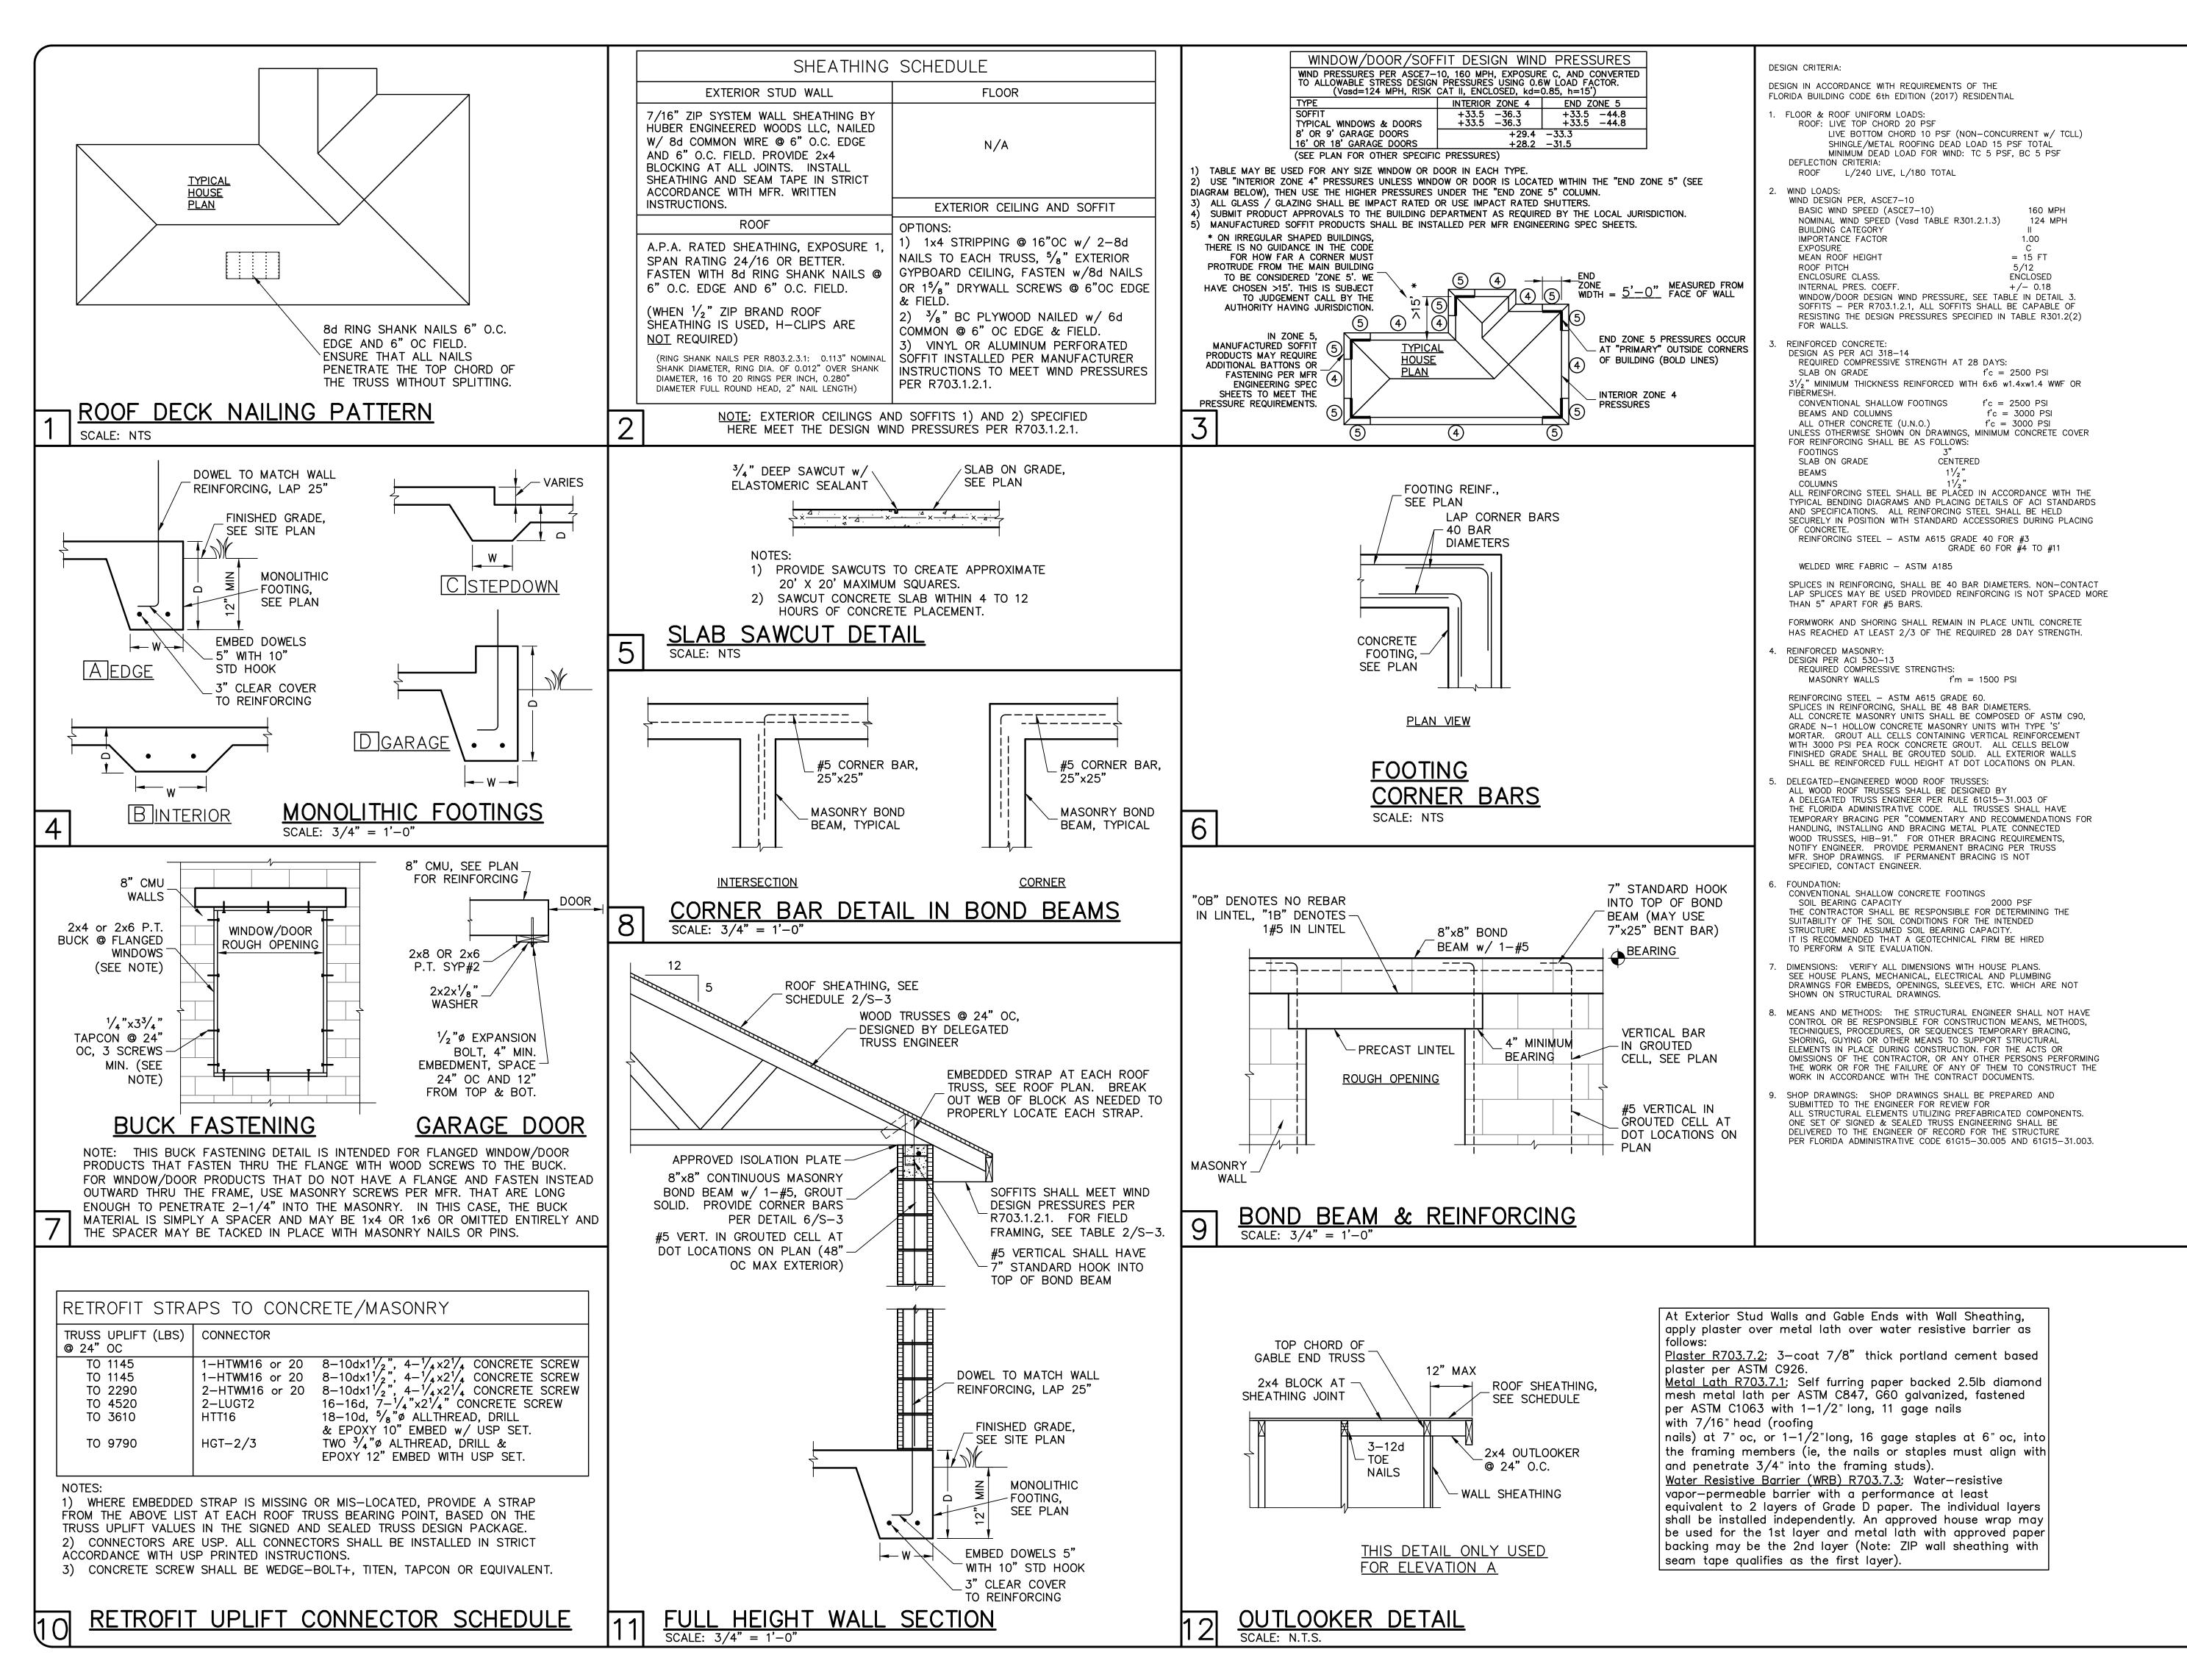

REVISIONS

STRUS SYSS OF NOR 1634 S.E. 47th CAPE COR. (239) E

OKTON -R-H

A 0

DE 39 A 4 10E $\supset \Sigma$

DWB/DWB CHECKED DWB 07/31/19 SCALE **VARIES**

JOB NO. DR10946 SHEET

SHEET 3 OF 3