

BEAMS BY OTHER TOP @ 0'-0"	

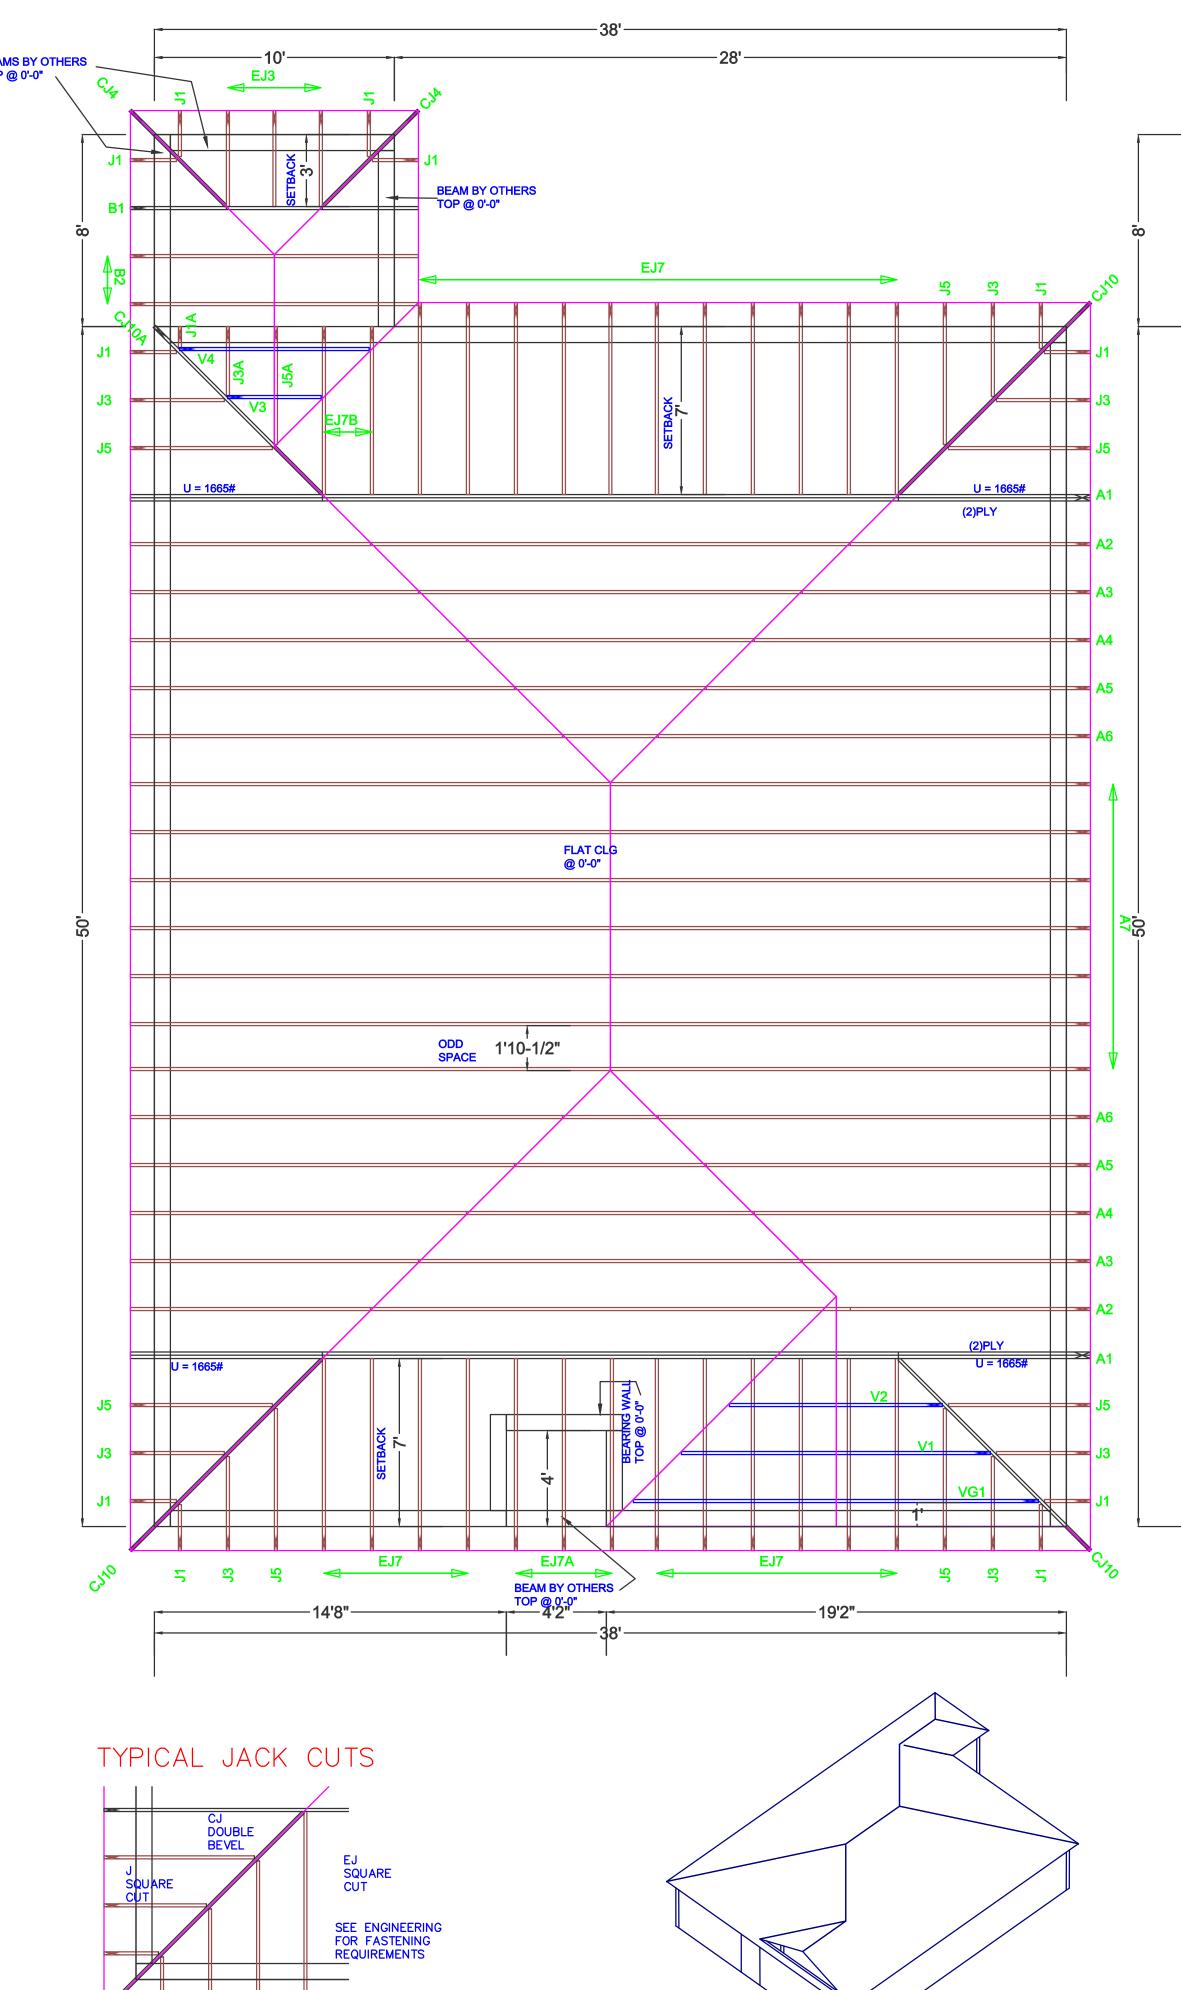

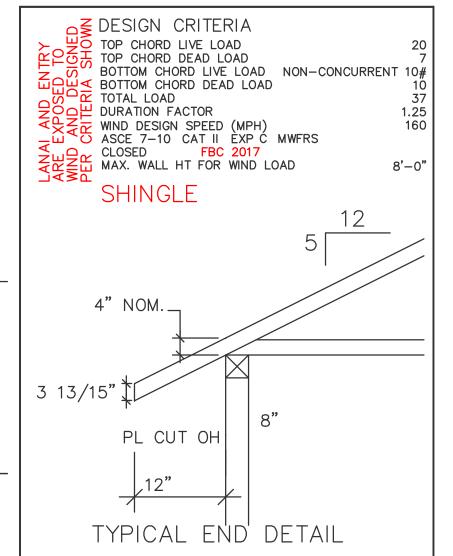

UNLESS NOTED

REACTION VALUES ARE UNDER 5000#

UPLIFT VALUES ARE UNDER 1000#

DO NOT ATTEMPT TO ERECT TRUSSES WITH-OUT REFERRING TO THE ENGINEERING DWGS.

IT IS NECESSARY TO REFER TO THE ENGINEERING DRAWINGS FOR NUMBER OF MEMBERS, BEARING LOCATION, ORIENTATION AND WEB BRACING

REFER TO WTCA/TPI BSCI-B1 SUMMARY
SHEET FOR HANDLING METHODS & TEMPORARY
BRACING, WHICH IS ALWAYS REQUIRED

BEARING HEIGHTS BASED ON PLANS PROVIDED TO SCOSTA CORP. "+/-" BEARING DIFFERENCES SHOWN ARE CRITICAL. IF ANY HEIGHTS DEVIATE - INFORM SCOSTA CORP.

BEARING WALL & BEAM HEIGHTS

0'-0"	ELEV.
	ELEV.
	0'-0"

TYPICAL HANGER SCHEDULE

- C SIMPSON HUS 26 M SIMPSON HGUS 28-3

 F SIMPSON HUS 28 N SIMPSON HHUS 48

 H SIMPSON HGUS 28 P SIMPSON LUS 24
- I SIMPSON HGUS 28-2 B SIMPSON THA 422
- W SIMPSON THJA26 X

 HANGER VALUES HAVE BEEN BASED ON 16D
 COMMON NAILS EXCEPT THE FOLLOWING
 LUS24 10D COMMON THJA26 10D x 1-1/2

******ATTENTION*****

APPROVAL OF THIS TRUSS LAYOUT IS NECESSARY BEFORE FABRICATION CAN BEGIN. VERIFY DIMENSIONS, PITCHES, OVERHANGS, ELEVATIONS, CEILING & BEARING CONDITIONS. SCOSTA CORPORATION IS RESPONSIBLE FOR ACCURACY IN ACCORDANCE WITH PLANS AND/OR INFORMATION PROVIDED BY CUSTOMER, WITH ANY DEVIATIONS NOTED HEREIN. CUSTOMER IS RESPONSIBLE TO VERIFY ACCURACY OF INFORMATION AND PLANS PROVIDED TO SCOSTA CORPORATION, AND TO VERIFY CONFORMANCE TO FIELD CONDITIONS, AND/OR OWNER CHANGES. TRUSSES WILL BE BUILT IN ACCORDANCE WITH THE APPROVED LAYOUT.


APPROVED BY: _____


DATE: _____ REQUESTED DELIVERY DATE: ____

JOBSITE CONTACT NAME: ____


PHONE #: _____ E-MAIL: _____


SCOSTA CORP

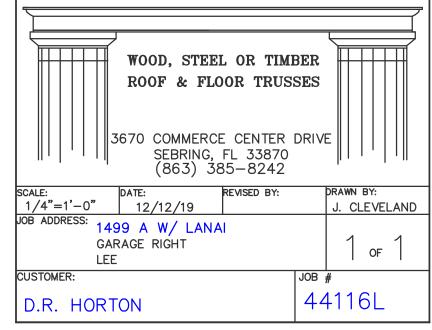


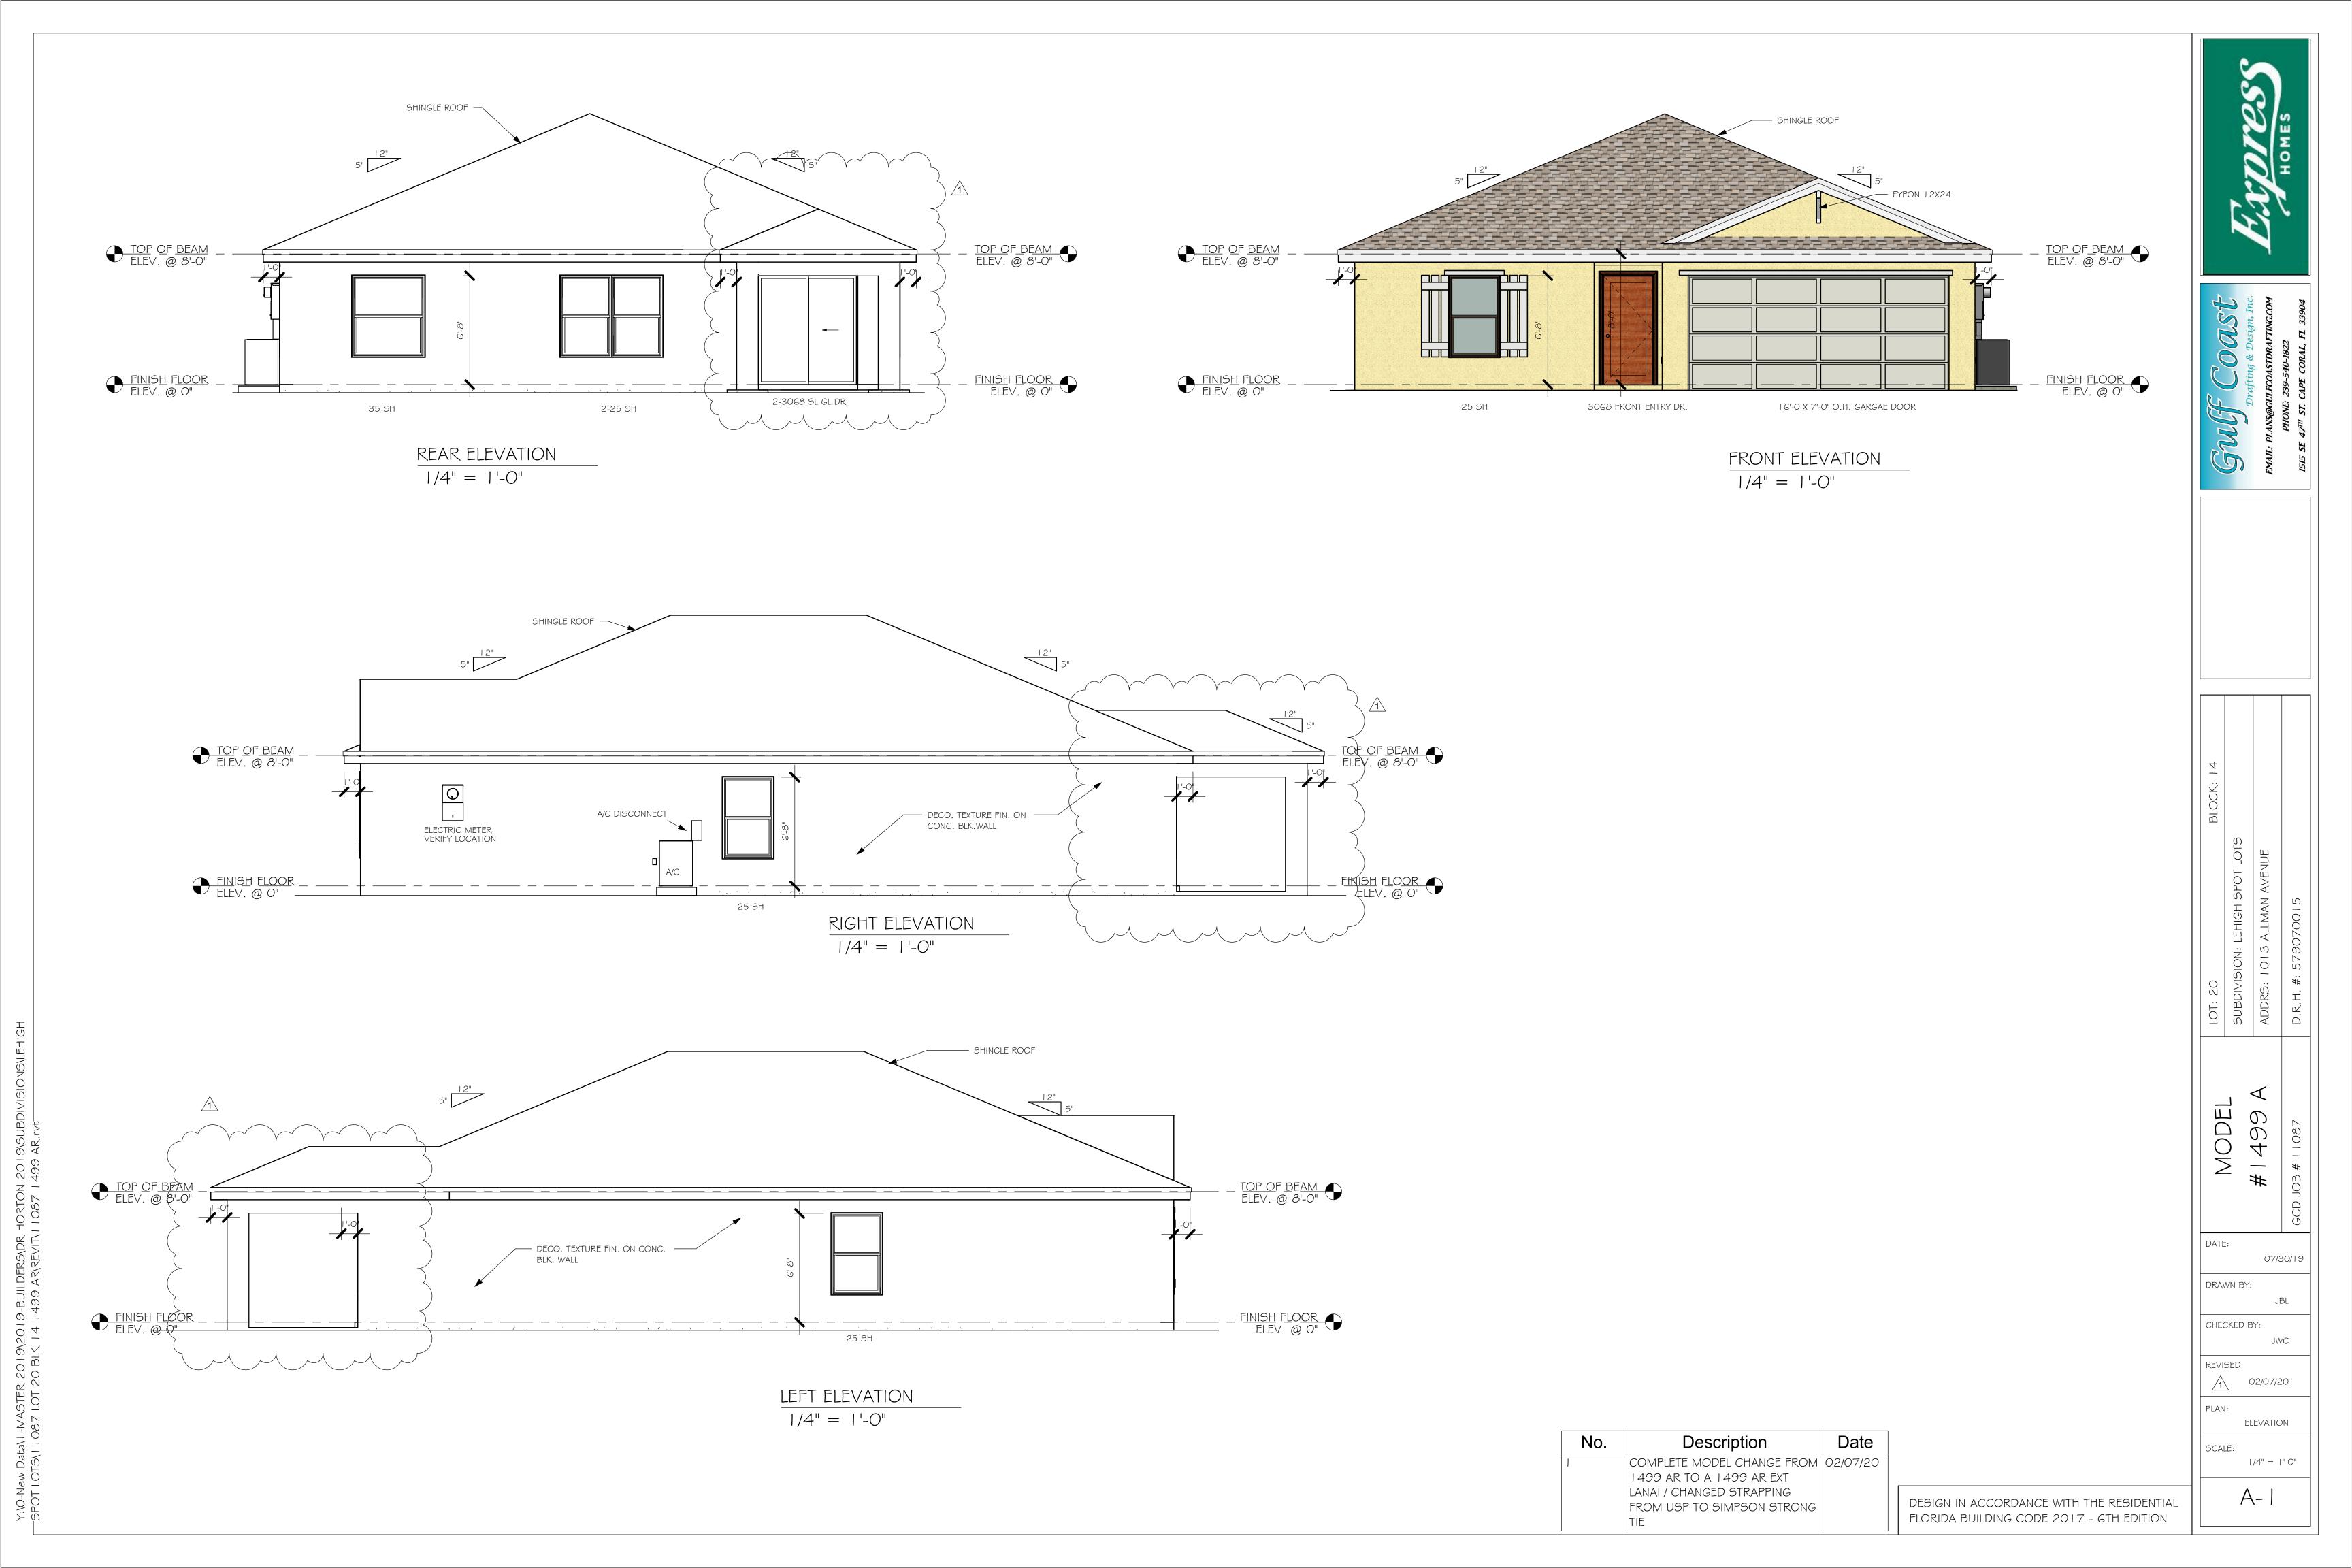



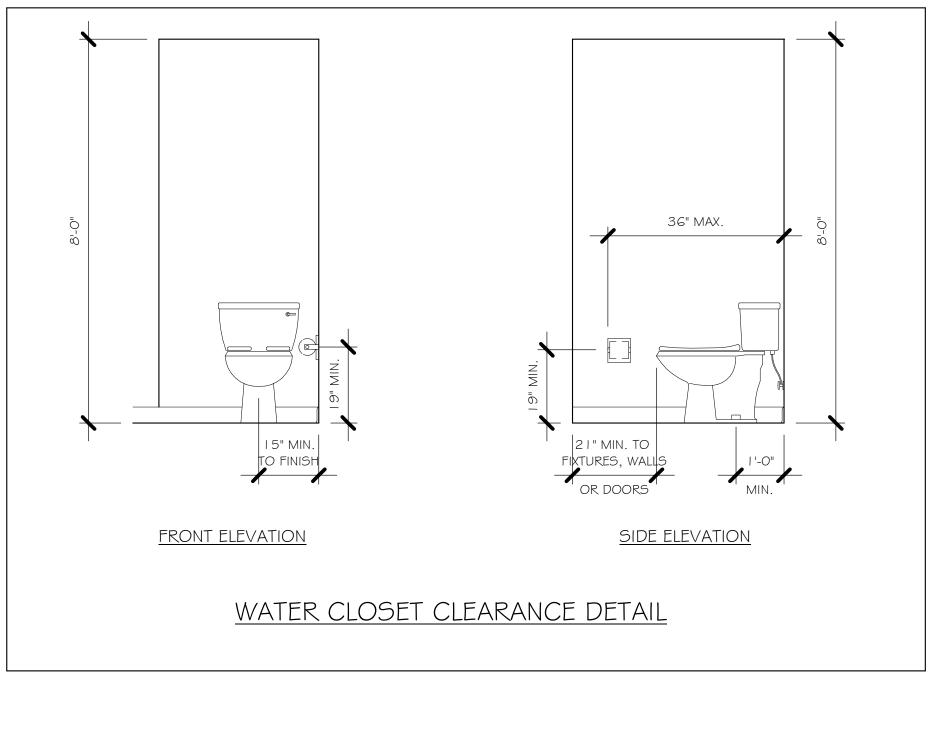

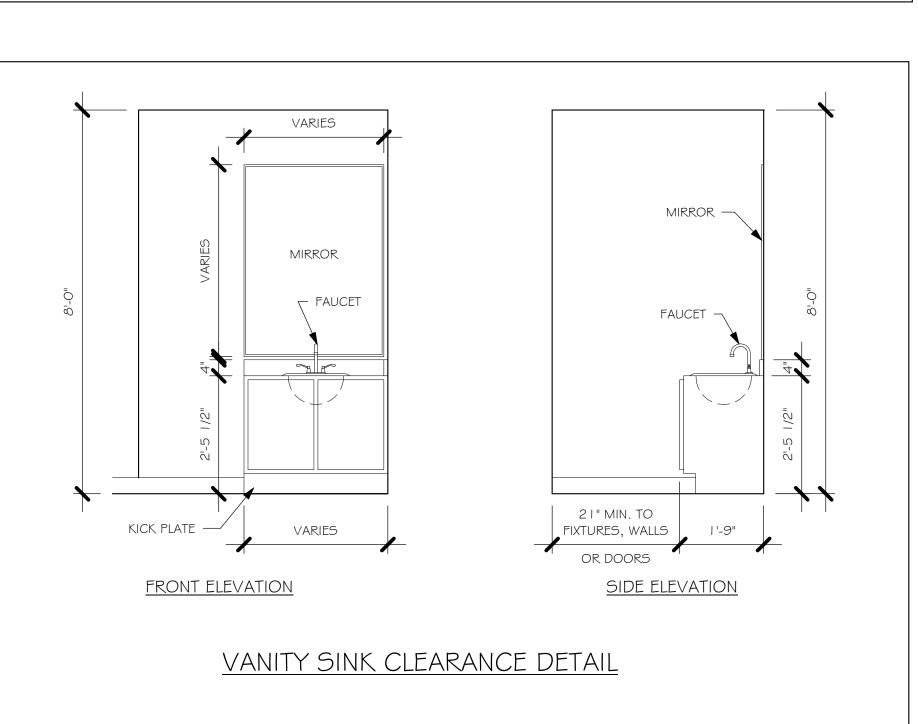

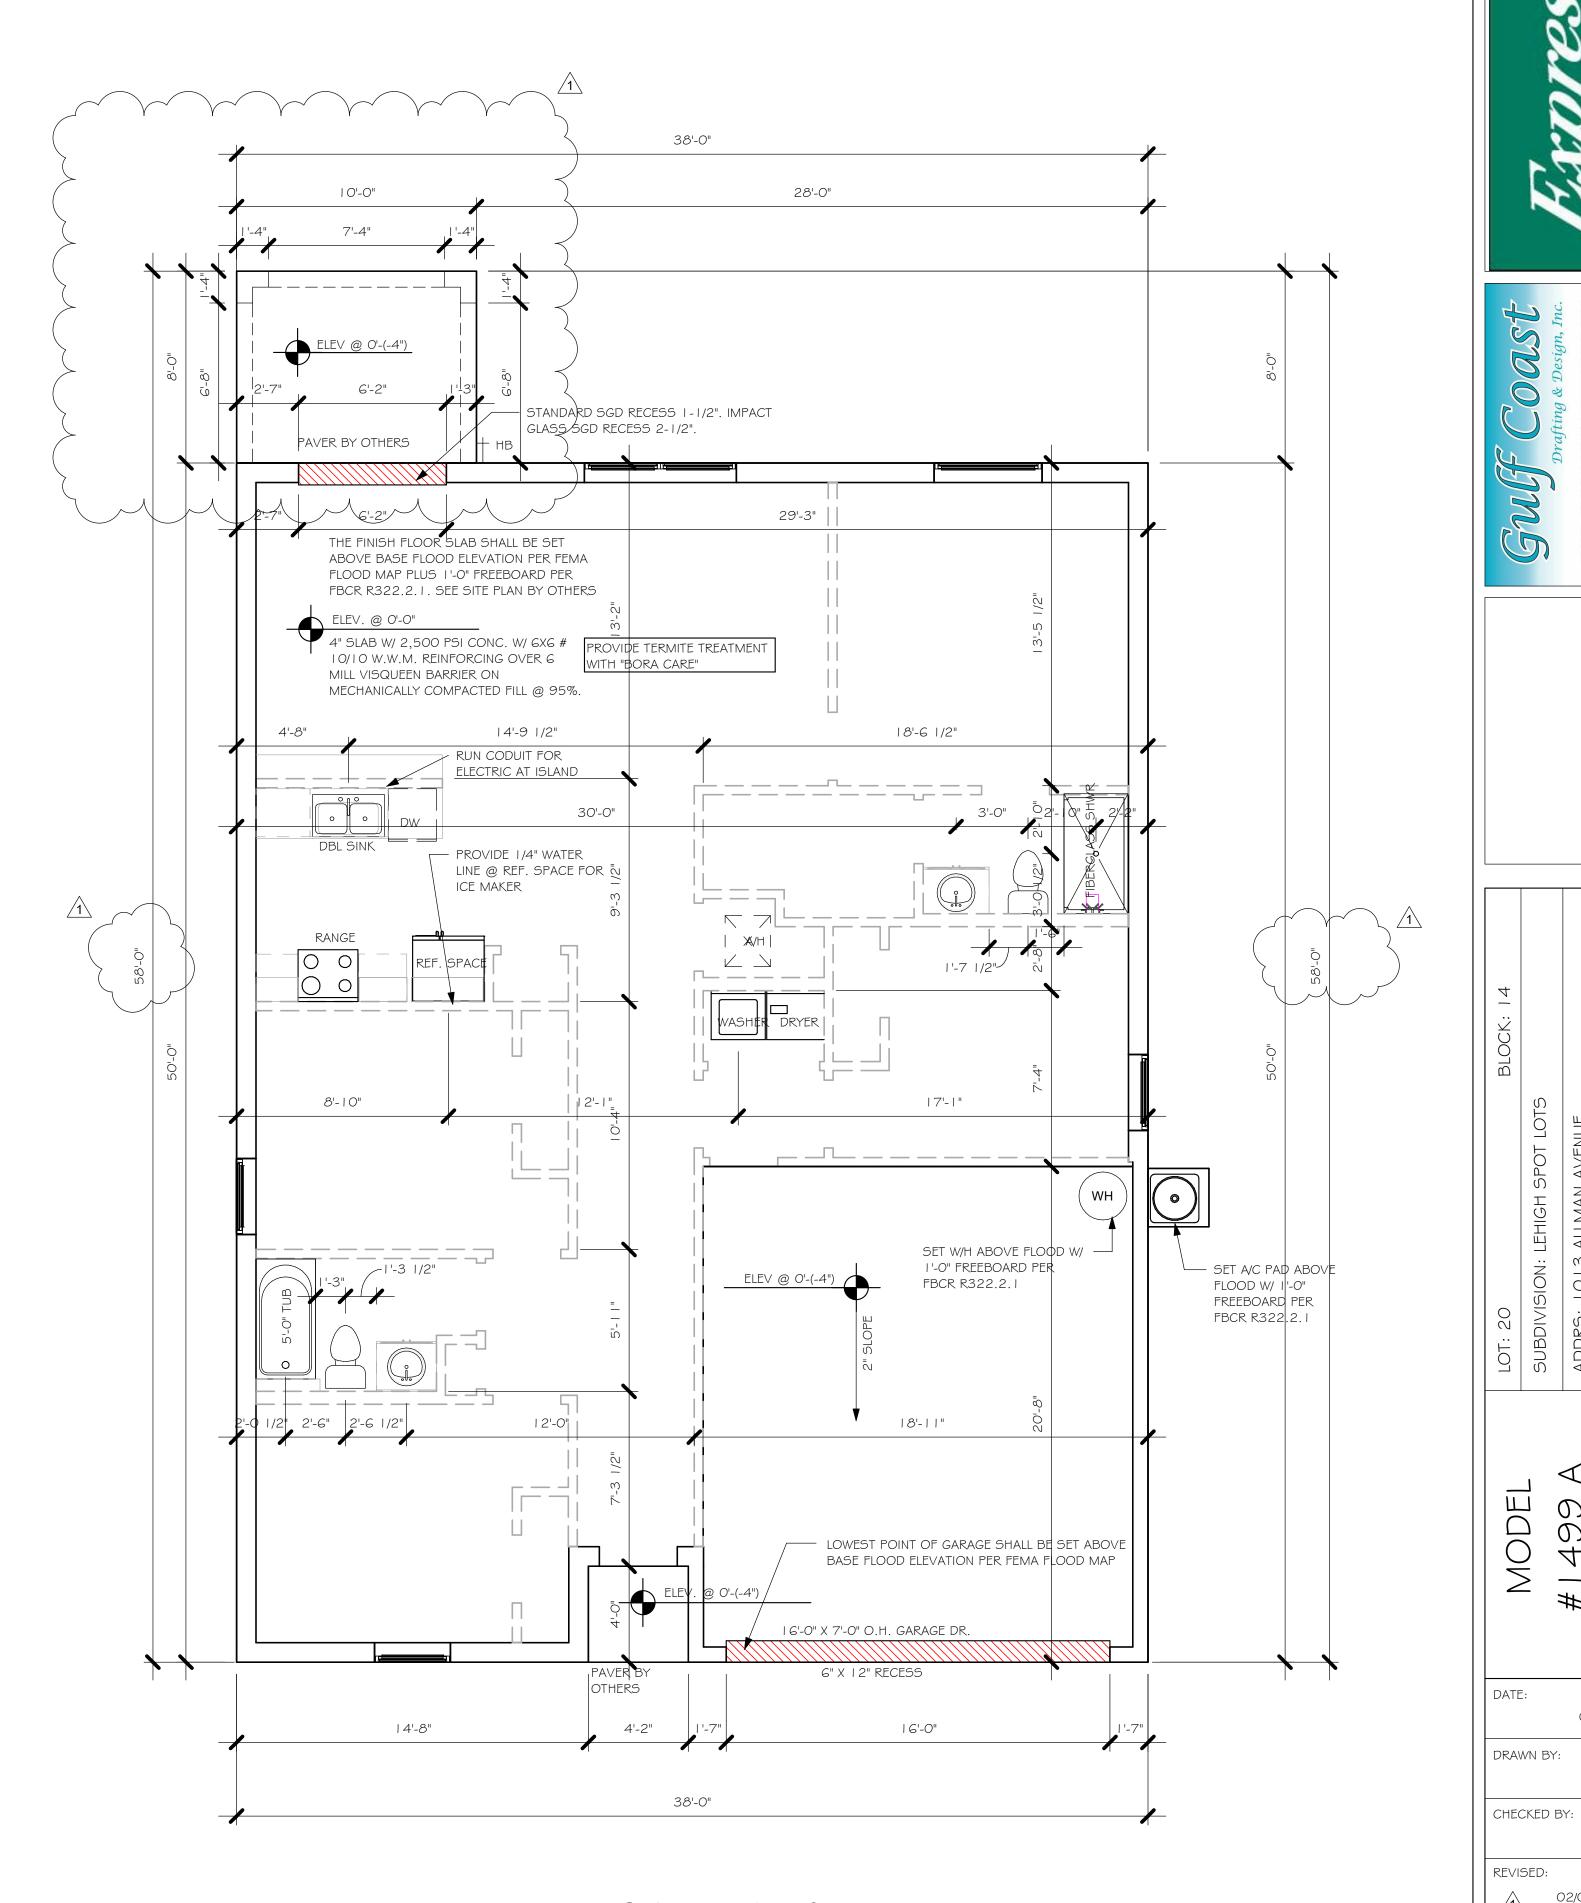

SLAB PLUMBING

1/4" = 1'-0"

	1/4 - 1 -0	
No.	Description	Date
1	COMPLETE MODEL CHANGE FROM	02/07/20
	1499 AR TO A 1499 AR EXT	
	LANAI / CHANGED STRAPPING	
	FROM USP TO SIMPSON STRONG	
	TIF	

DESIGN IN ACCORDANCE WITH THE RESIDEN	TIAL
FLORIDA BUILDING CODE 2017 - 6TH EDITION	NC

07/30/19

JWC

02/07/20

As indicated

A-2

SLAB & PLUMBING

PLAN:

SCALE:

	DOOR SCHEDULE				
TYPE	DECORPTION	NAANU ISA OTU DED	LIFLOUT	NA AIDTLA	COLINIT
MARK	DESCRIPTION	MANUFACTURER	HEIGHT	WIDTH	COUNT
	3068 ENTRY	DISTINCTION	6'-8"	3'-0"	1
2	2-3068 SL. GL. DR.	DISTINCTION	6'-8"	6'-0"	1

7'-0"

16'-0"

GARAGE

WINDOW SCHEDULE				
MARK	DESCRIPTION	HEIGHT	WIDTH	COUNT
А	2-25 SH	5'-3"	6'-4"	1
В	25 SH	5'-3"	3'-2"	3
С	35 SH	5'-3"	4'-6"	1

DOOR HEADERS		
6'-8" BI-FOLD	HEADER HEIGHT	82" A.F.F.
6'-8" SWING	HEADER HEIGHT	82 I/2" A.F.F.
8'-0" SWING	HEADER HEIGHT	98 I/2" A.F.F.

PLAN NOTES

16080 OHGD


- 1) VERIFY ALL ROUGH OPENING DIMENSIONS FOR ALL WINDOWS AND DOORS
- PROVIDE SAFETY GLAZING WITHIN 24" FROM EXIT PER FLORIDA BUILDING CODE R 308.4.2.
- PROVIDE SAFETY GLAZING AT BATH/ SHOWER PER FLORIDA BUILDING CODE R 308.4.5.
- NON BEARING INTERIOR FRAME WALLS SHALL BE FRAMED W/ WOOD OR METAL STUDS. SPACING SHALL NOT EXCEED 24" O.C. (NON BEARING WALLS ONLY)
- 5) PROVIDE DEAD WOOD IN ATTIC FOR OVERHEAD GARAGE DOOR HARDWARE
- 6) KITCHEN KNEE WALL TO BE FRAMED W/ TOP @ 34 1/2" A.F.F.
- 7) INSTALL SMOOTH WALLS IN KITCHEN AND ALL BATHROOM AREAS
- WHERE DRYWALL CEILING IS APPLIED TO TRUSSES @ 24" O.C. USE 5/8" DRYWALL OR 1/2" SAG RESISTANT PER SEC. 702.3.5
- THE GARAGE SHALL BE SEPARATED FROM THE RESIDENCE & ATTIC BY NOT LESS THEN 1/2" GYPSUM BOARD APPLIED TO THE GARAGE SIDE. GARAGES BENEATH HABITABLE ROOMS SHALL BE SEPARATED WITH NOT LESS THAN 5/8" TYPE "X" GYPSUM BOARD OR EQUIVALENT. WHERE THE SEPARATIION IS A FLOOR - CEILING ASSEMBLY, THE STRUCTURE SUPPORTING THE SEPARTION SHALL ALSO BE PROTECTED BY NOT LESS THAN 1/2" GYPSOM BOARD OR EQUIVALENT
- 10) INSTALL 1 3/8" THICK SOLID WOOD DOOR BETWEEN LIVING AND GARAGE PER FLORIDA BUILDING CODE
- II) ALL WINDOWS INSTALLED 72" ABOVE GRADE MUST COMPLY WITH R6 | 2.2 MIN 24" SILL HEIGHT OR PROVIDED WITH AN APPROVED WINDOW FALL PRVENTION DEVICE
- 12) ALL CLOSET SHELVES TO BE 12". ALL PANTRY \$ LINEN TO BE (4)-16" SHELVES 18" O.F.F. W/ 15"
- 13) ALL MECHANICAL AND ELECTRICAL EQUIPMENT TO BE INSTALLED AT OR ABOVE FLOOD PLUS 1'-O" FREEBOARD.


IN	INTERIOR DOOR SCHEDULE				
MARK	DOOR WIDTH	NOTES			
1	3'-0"	P.K. = POCKET DOOR			
2	2'-8"	B.F. = BI-FOLD DOOR			
3	2'-6"	D.1 DI-1 OLD DOOK			
4	2'-4"	B.P. = BI-PASS DOOR			
5	2'-0"	L.V. = LOUVERED DOOR			
6	1'-8"				
7	1'-6"				
8	2'-11"				

SQUARE FOOTAGE		
LIVING AREA	1499	
GARAGE AREA	385	
LANAI AREA	80	
FRONT PORCH/ ENTRY AREA	16	
TOTAL SQUARE FOOTAGE	1,980	

	BATHROOM NOTES
TB TOWEL BAR	ALL TUB DECKS @ 21" A.F.F
TP TOILET PAPER	ALL BLOCKING TO BE PT IN SHOWERS
,0-1-4	TOWEL BAR TOILET PAPER ROLL


CABINET BACKING		
KITCHEN	UPPER TOP @ 84"	BASE TOP @ 35"
MASTER BATH	UPPER	BASE TOP @ 35"
GUEST BATH	UPPER	BASE TOP @ 31"
LAUNDRY ROOM	UPPER TOP @ 84"	BASE

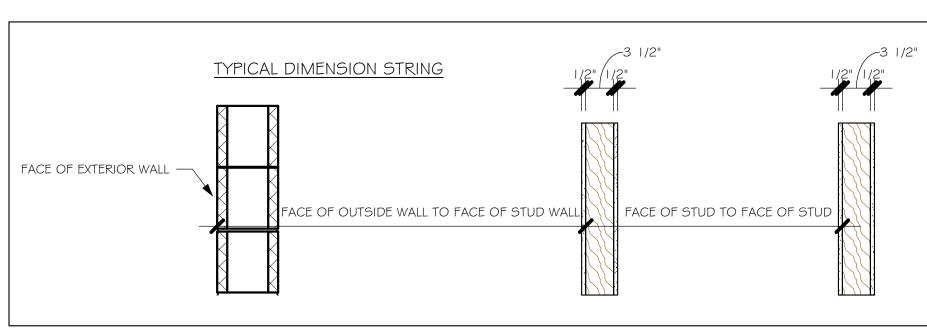

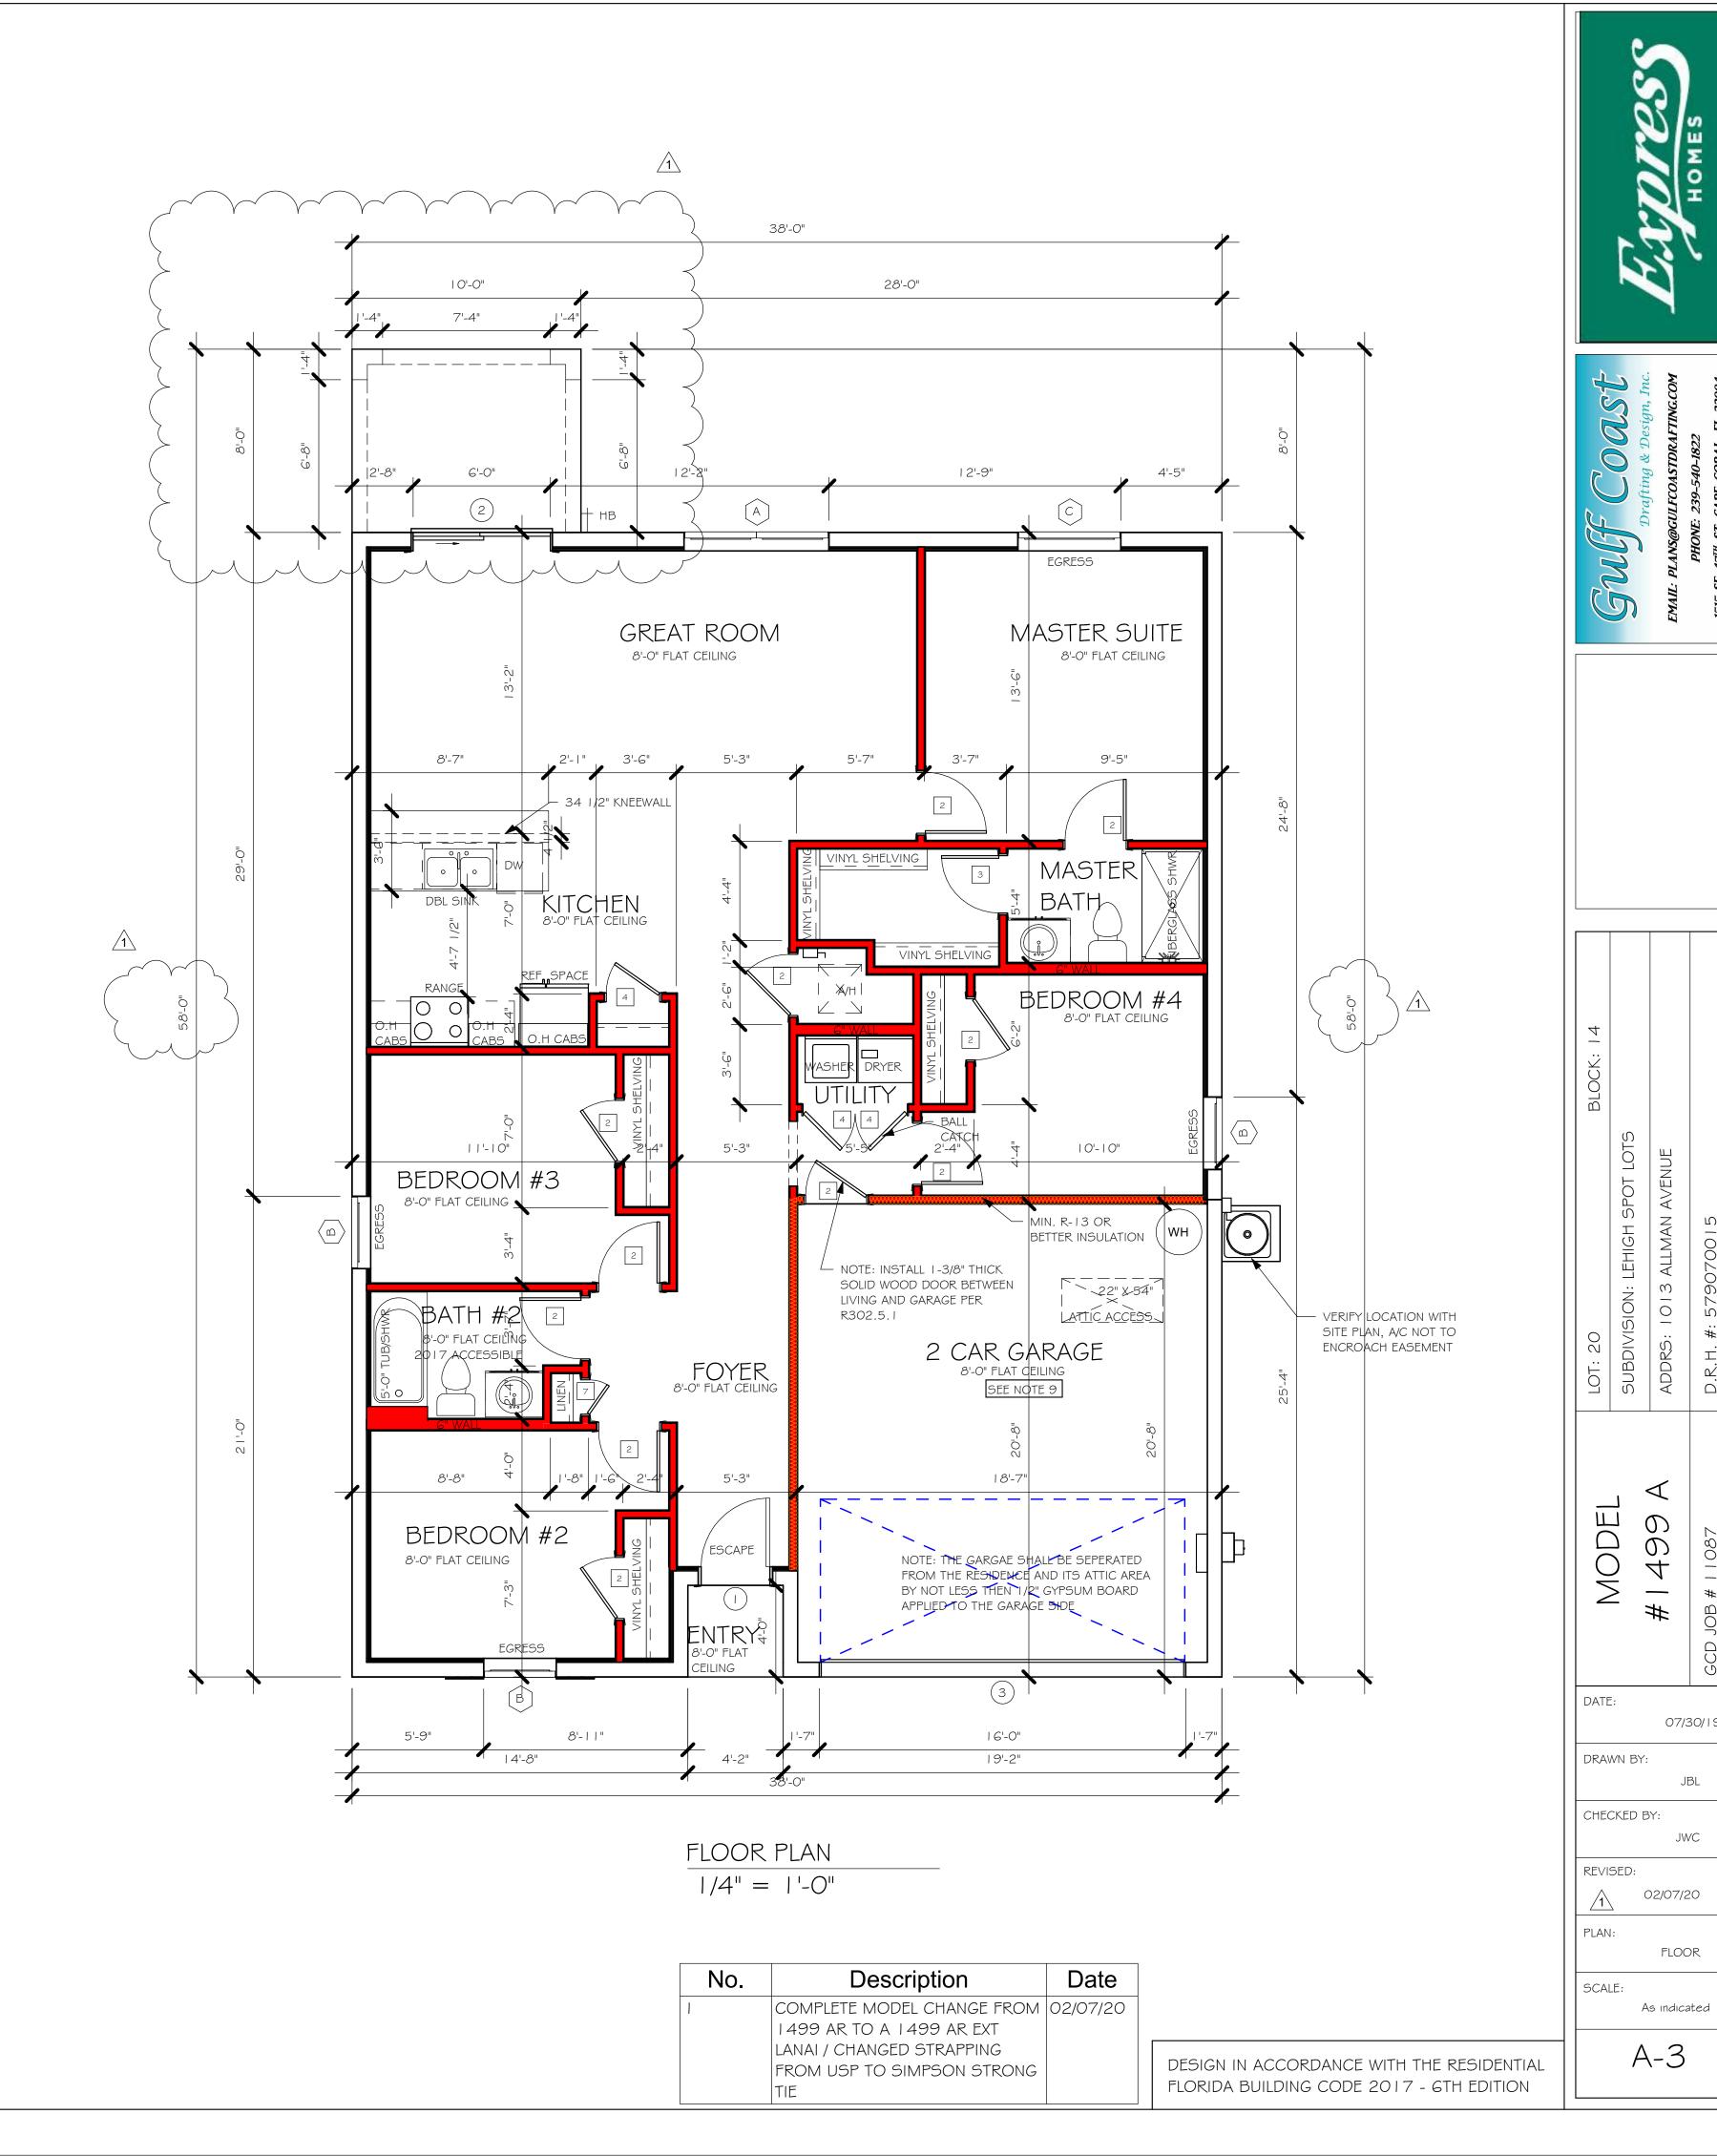


07/30/19

FLOOR

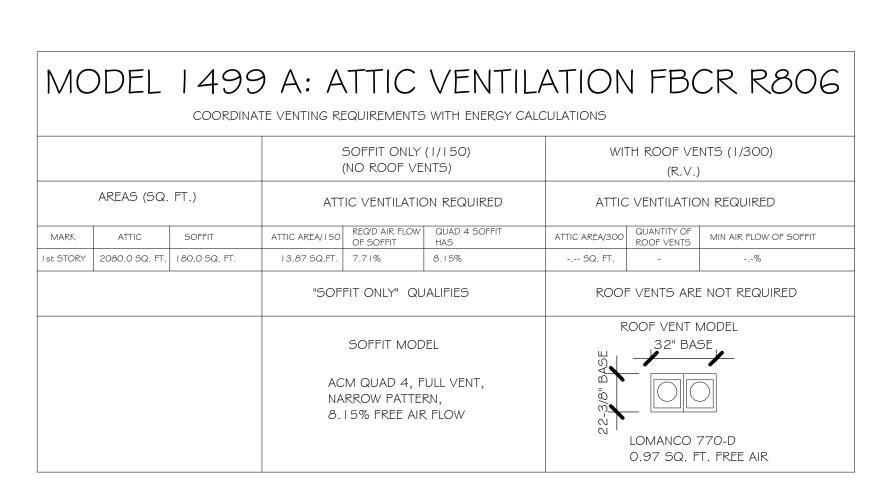



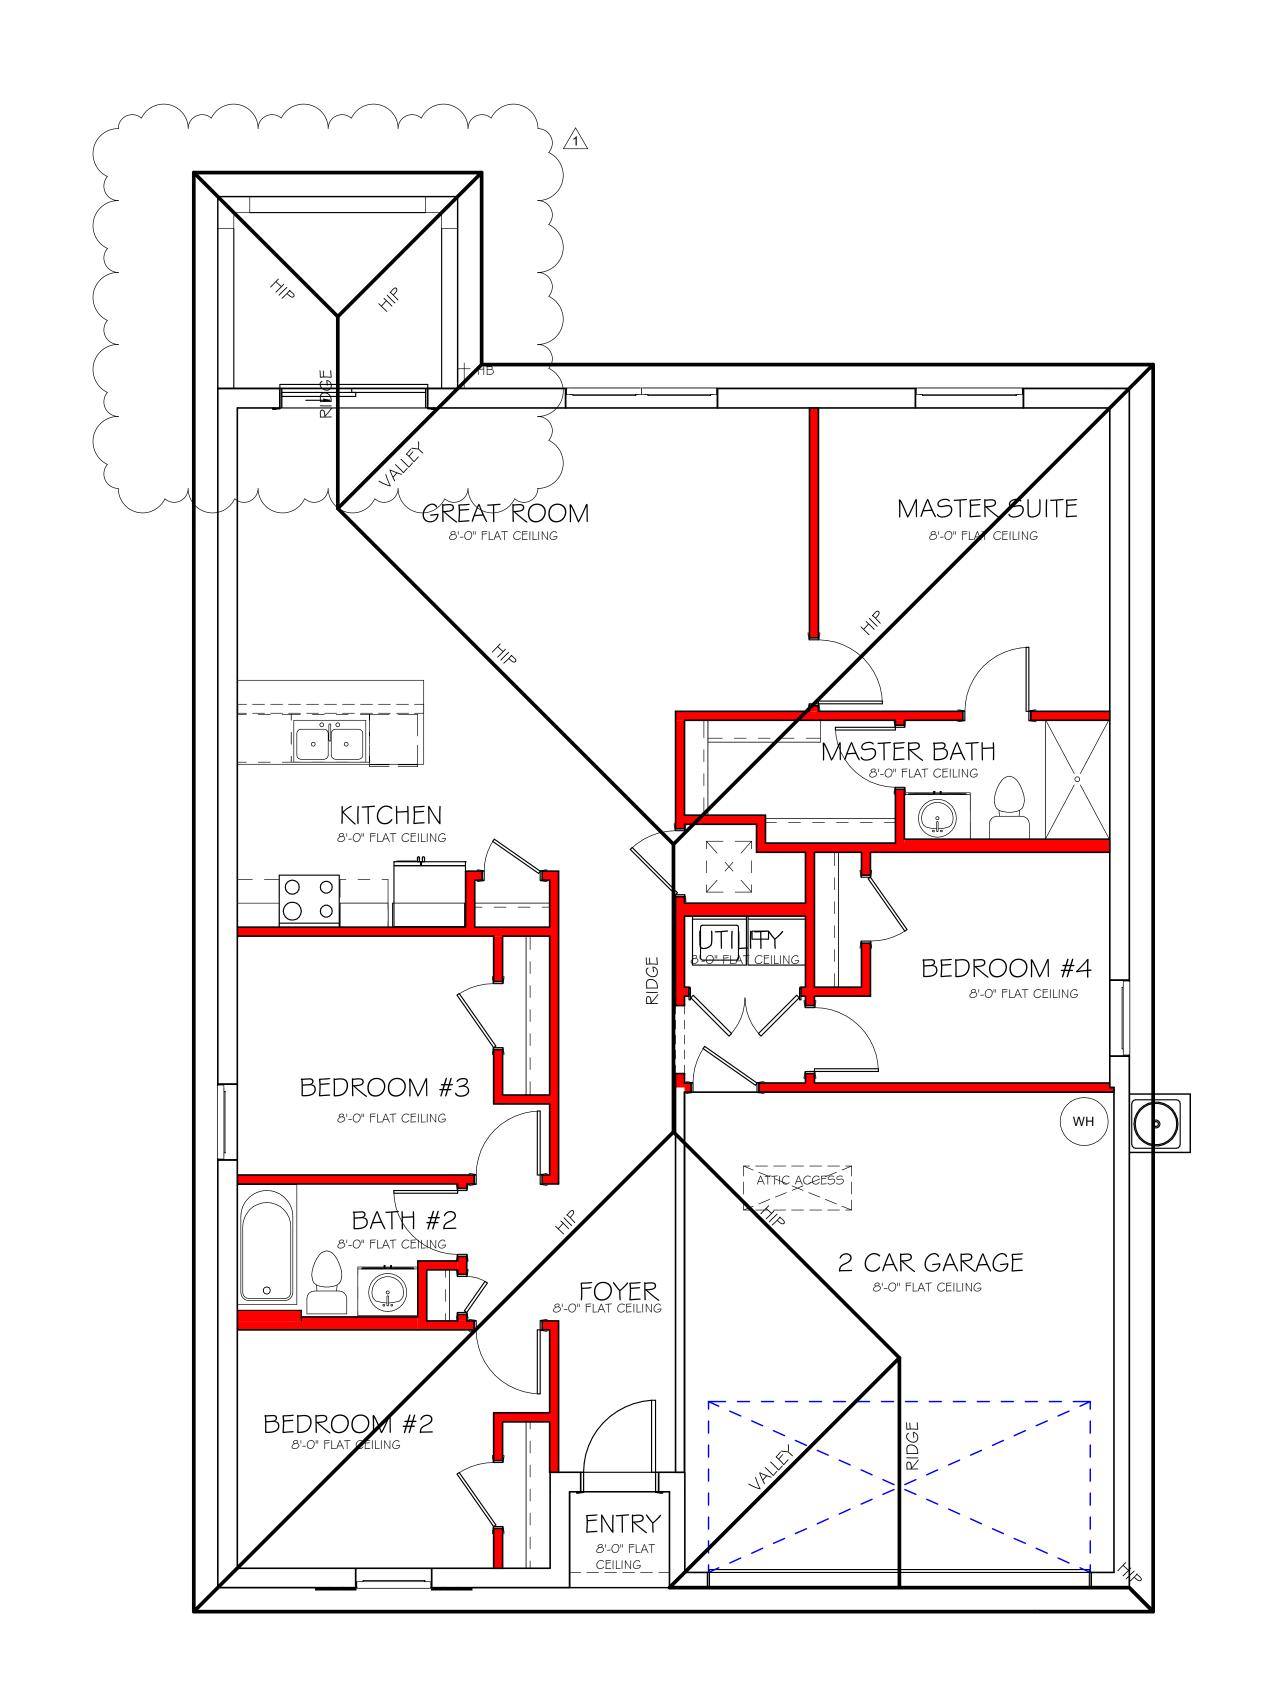

ROOF PLAN 1/4" = 1'-0"

No.	Description	Date
1	COMPLETE MODEL CHANGE FROM	02/07/20
	1499 AR TO A 1499 AR EXT	
	LANAI / CHANGED STRAPPING	
	FROM USP TO SIMPSON STRONG	
	TIE	

FLORIDA BUILDING CODE 2017 - 6TH EDITION

DESIGN IN ACCORDANCE WITH THE RESIDENTIAL

MODEL

DATE:

DRAWN BY:

CHECKED BY:

REVISED:

1

PLAN:

SCALE:

07/30/19

JWC


02/07/20

ROOF

As indicated

A-4

EL	ELECTRICAL LEGEND				
	ELECTRICAL METER				
	ELECTRICAL PANEL				
	I 20 V JUNCTION BOX				
	SINGLE RECEPTACLE OUTLET				
	220 V RECEPTACLE OUTLET				
	4-PLEX RECEPTACLE OUTLET				
	DUPLEX RECEPTACLE OUTLET				
	1/2 SWITCHED DUPLEX OUTLET				
AFF	DUPLEX RECEPTACLE AT ELEV. A.F.F.				
	DUPLEX RECEPTACLE - ABOVE COUNTER				
⇔	SINGLE POLE SWITCH				
↔ 3	3 WAY SWITCH				
	DIMMER SWITCH				
₩S	MOTION SENSOR SWITCH				
S _{SD}	AC/DC SMOKE DETECTOR TO BE INTERCONNECTED ANY RESIDENT HAVING A FOSSIL-BURNING HEATER OR APPLIANCE, A FIREPLACE, OR AN ATTACHED GARAGE SHALL HAVE AN OPERATIONAL CARBON MONOXIDE ALARM INSTALLED WITHIN 10 FEET OF EACH ROOM USED FOR SLEEPING PERPOSES. PER RULE 9B-3.04.72 SD (SMOKE DETECTOR) SCD (CARBON MONOXIDE/ SMOKE DETECTOR)				
	TELEPHONE OUTLET				
-TV	TELEVISION RECEPTION OUTLET				
<u></u>	SURFACE MOUNTED CEILING LIGHT				
	FLUSH MOUNTED LIGHT				
Ю	WALL MTD. BRACKET LIGHT				
400	DUPLEX FLOOD LIGHT				
	EXHAUST FAN				
	TRACK MTD. LIGHTS				
	A/C DISCONNECT				
Н	PUSH BUTTON (PB) / DOOR BELL (DB)				
IC	INTERCOM				
	KEYPAD				
	4' FLUORESCENT LIGHT				
<u> </u>	2' UNDER COUNTER LIGHT				
PROJECT ELECTRIC	NOTE: NOT ALL SYMBOLS ARE USED FOR THIS PROJECT. ELECTRICAL NOTES: ARC-FAULT CIRCUIT-INTERRUPTERS AND TAMPER				

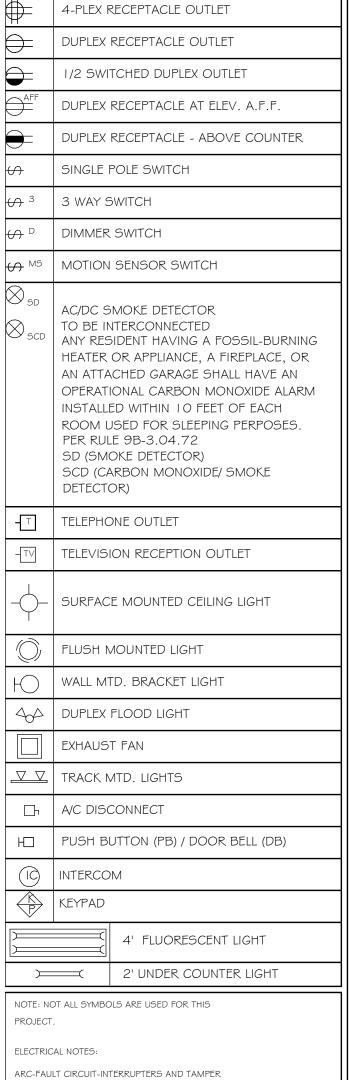

RESISTANT RECEPTACLES SHALL BE INSTALLED

ALL OUTLETS IN WET AREAS AND ALL

INSTALL PHONE AND T.V PER CONTRACT.

INSTALL ALL ELECTRICAL PER NEC 2014


EXTERIOR OUTLETS TO BE GFI'S.


IN DWELLING UNITS PER N.E.C 210.12 AND 406.11

ALL ELECTRIC, ELECTRICAL EQUIPMENT AND APPLIANCES TO BE SET AT OR ABOVE BASE FLOOD ELEVATIONS PLUS 1'-0" FREEBOARD.



LLLC I RICAL FLAN				
I 50 AMP SERVICE				
TAG	QUANTITY	PRODUCT		
Α	(X)	(FLUSH MOUNTED LT)		
В	(X) (VAPORS)			
С	(X) (PENDANT LIGHT			
D	(9)	(10" MUSHROOMS)		
E	(2)	(24" 3 LT)		
F	(X)	(36" LT)		
G	(X)	(NOT USED)		
Н	(2)	(COACH LIGHTS)		
	(X)			
J	(X)	(J BOX)		
K	(1)	(4' FLUORESCENT)		
L	(X)	(2' FLUORESCENT)		
М	(X)	(5LT CHANDELIER)		
Ν	(X)	(3 LT)		
0	(X)	(PENDANT/ NOOK)		
Р	(X)	(X)		
Q	(X)	(X)		
		·	·	

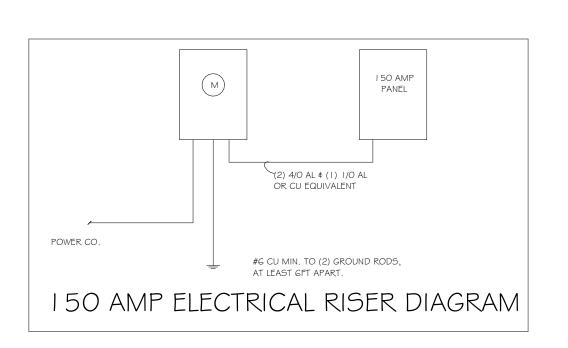

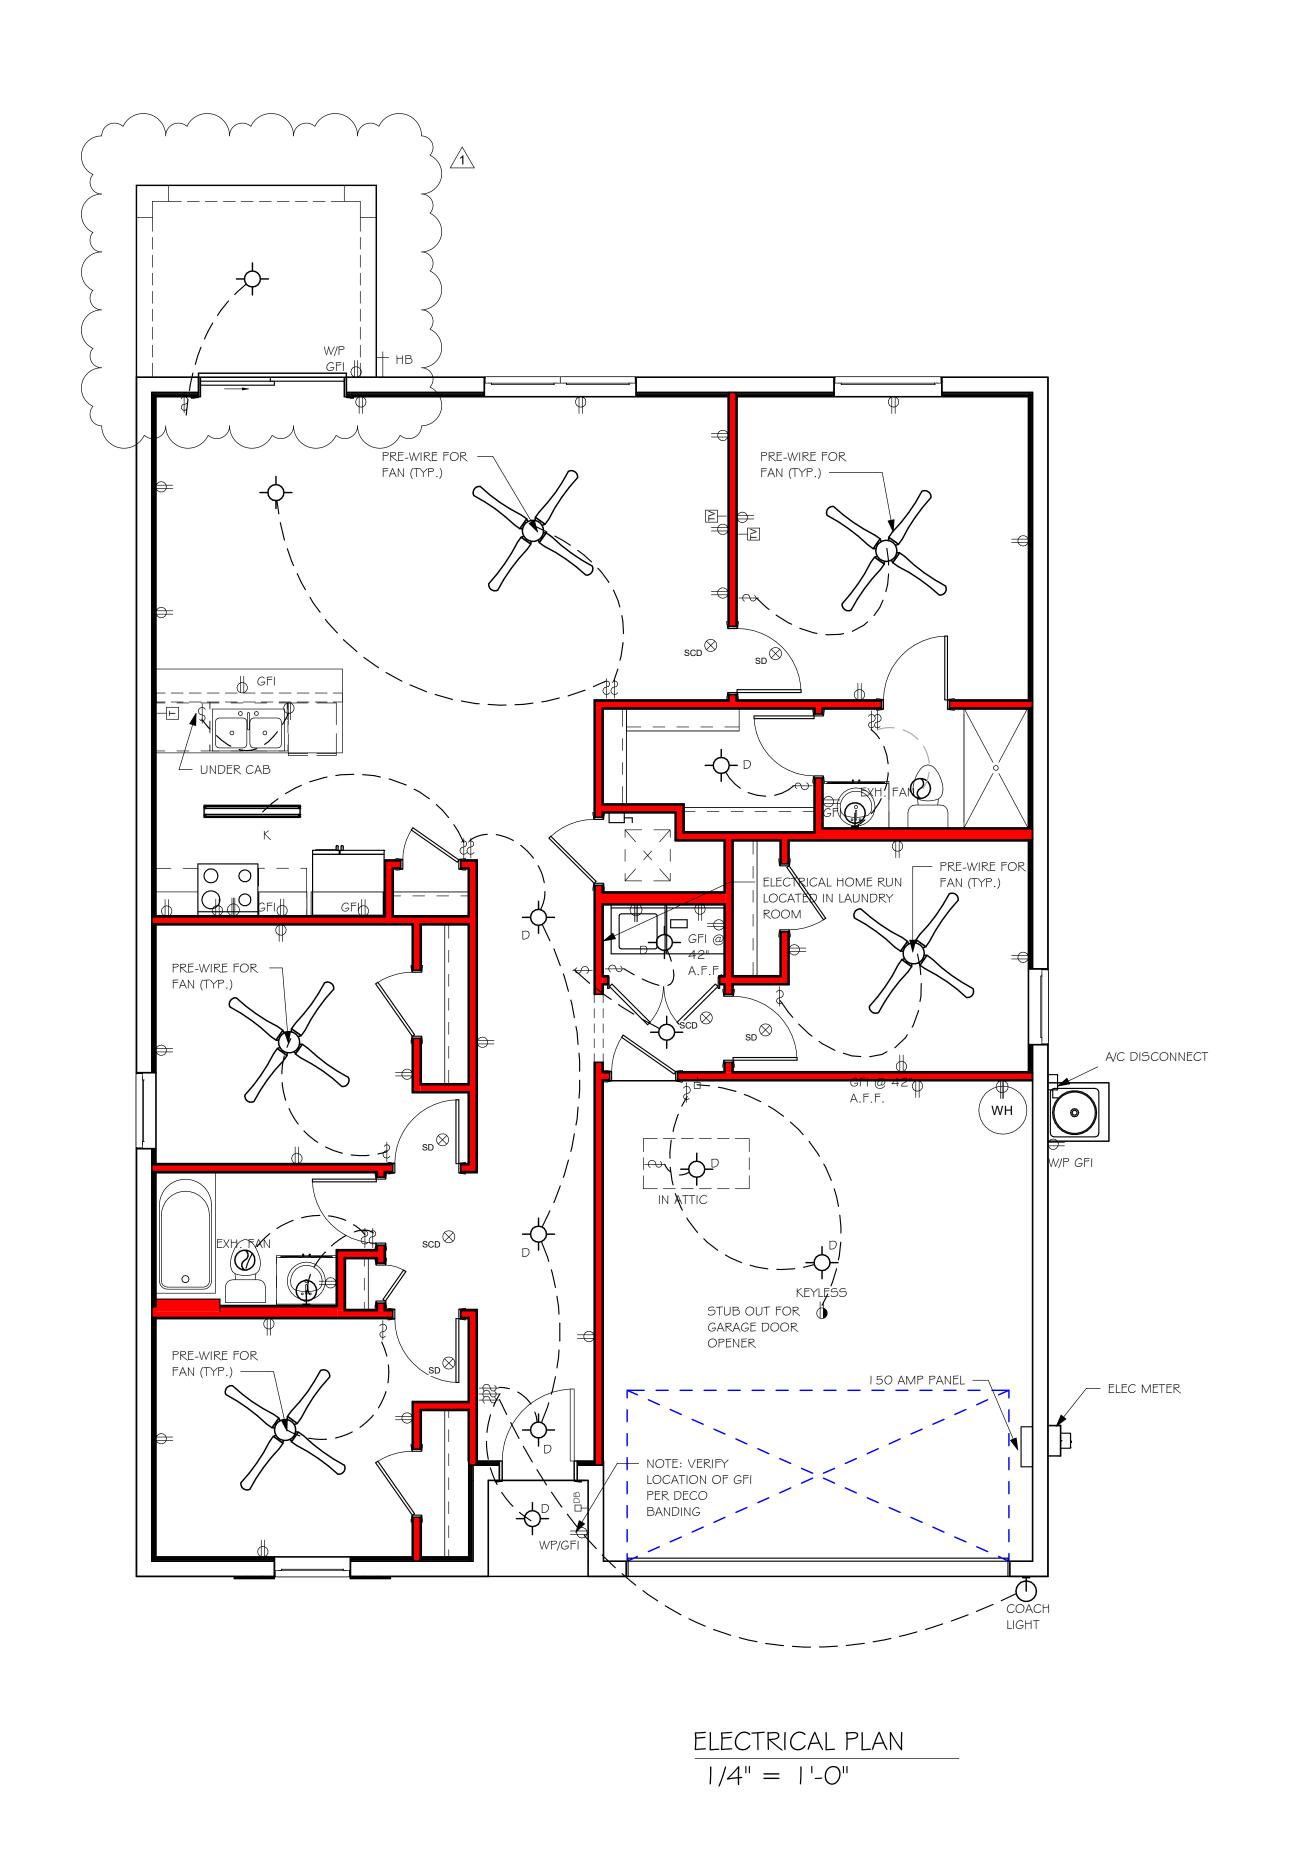

No.	Description	Date
1	COMPLETE MODEL CHANGE FROM	02/07/20
	1499 AR TO A 1499 AR EXT	
	LANAI / CHANGED STRAPPING	
	FROM USP TO SIMPSON STRONG	
	TIE	

DESIGN IN ACCORDANCE WITH THE RESIDENTIAL FLORIDA BUILDING CODE 2017 - 6TH EDITION

DATE:

DRAWN BY:

CHECKED BY:

REVISED:

PLAN:

SCALE:


07/30/19


JWC

02/07/20


ELECTRICAL

As indicated

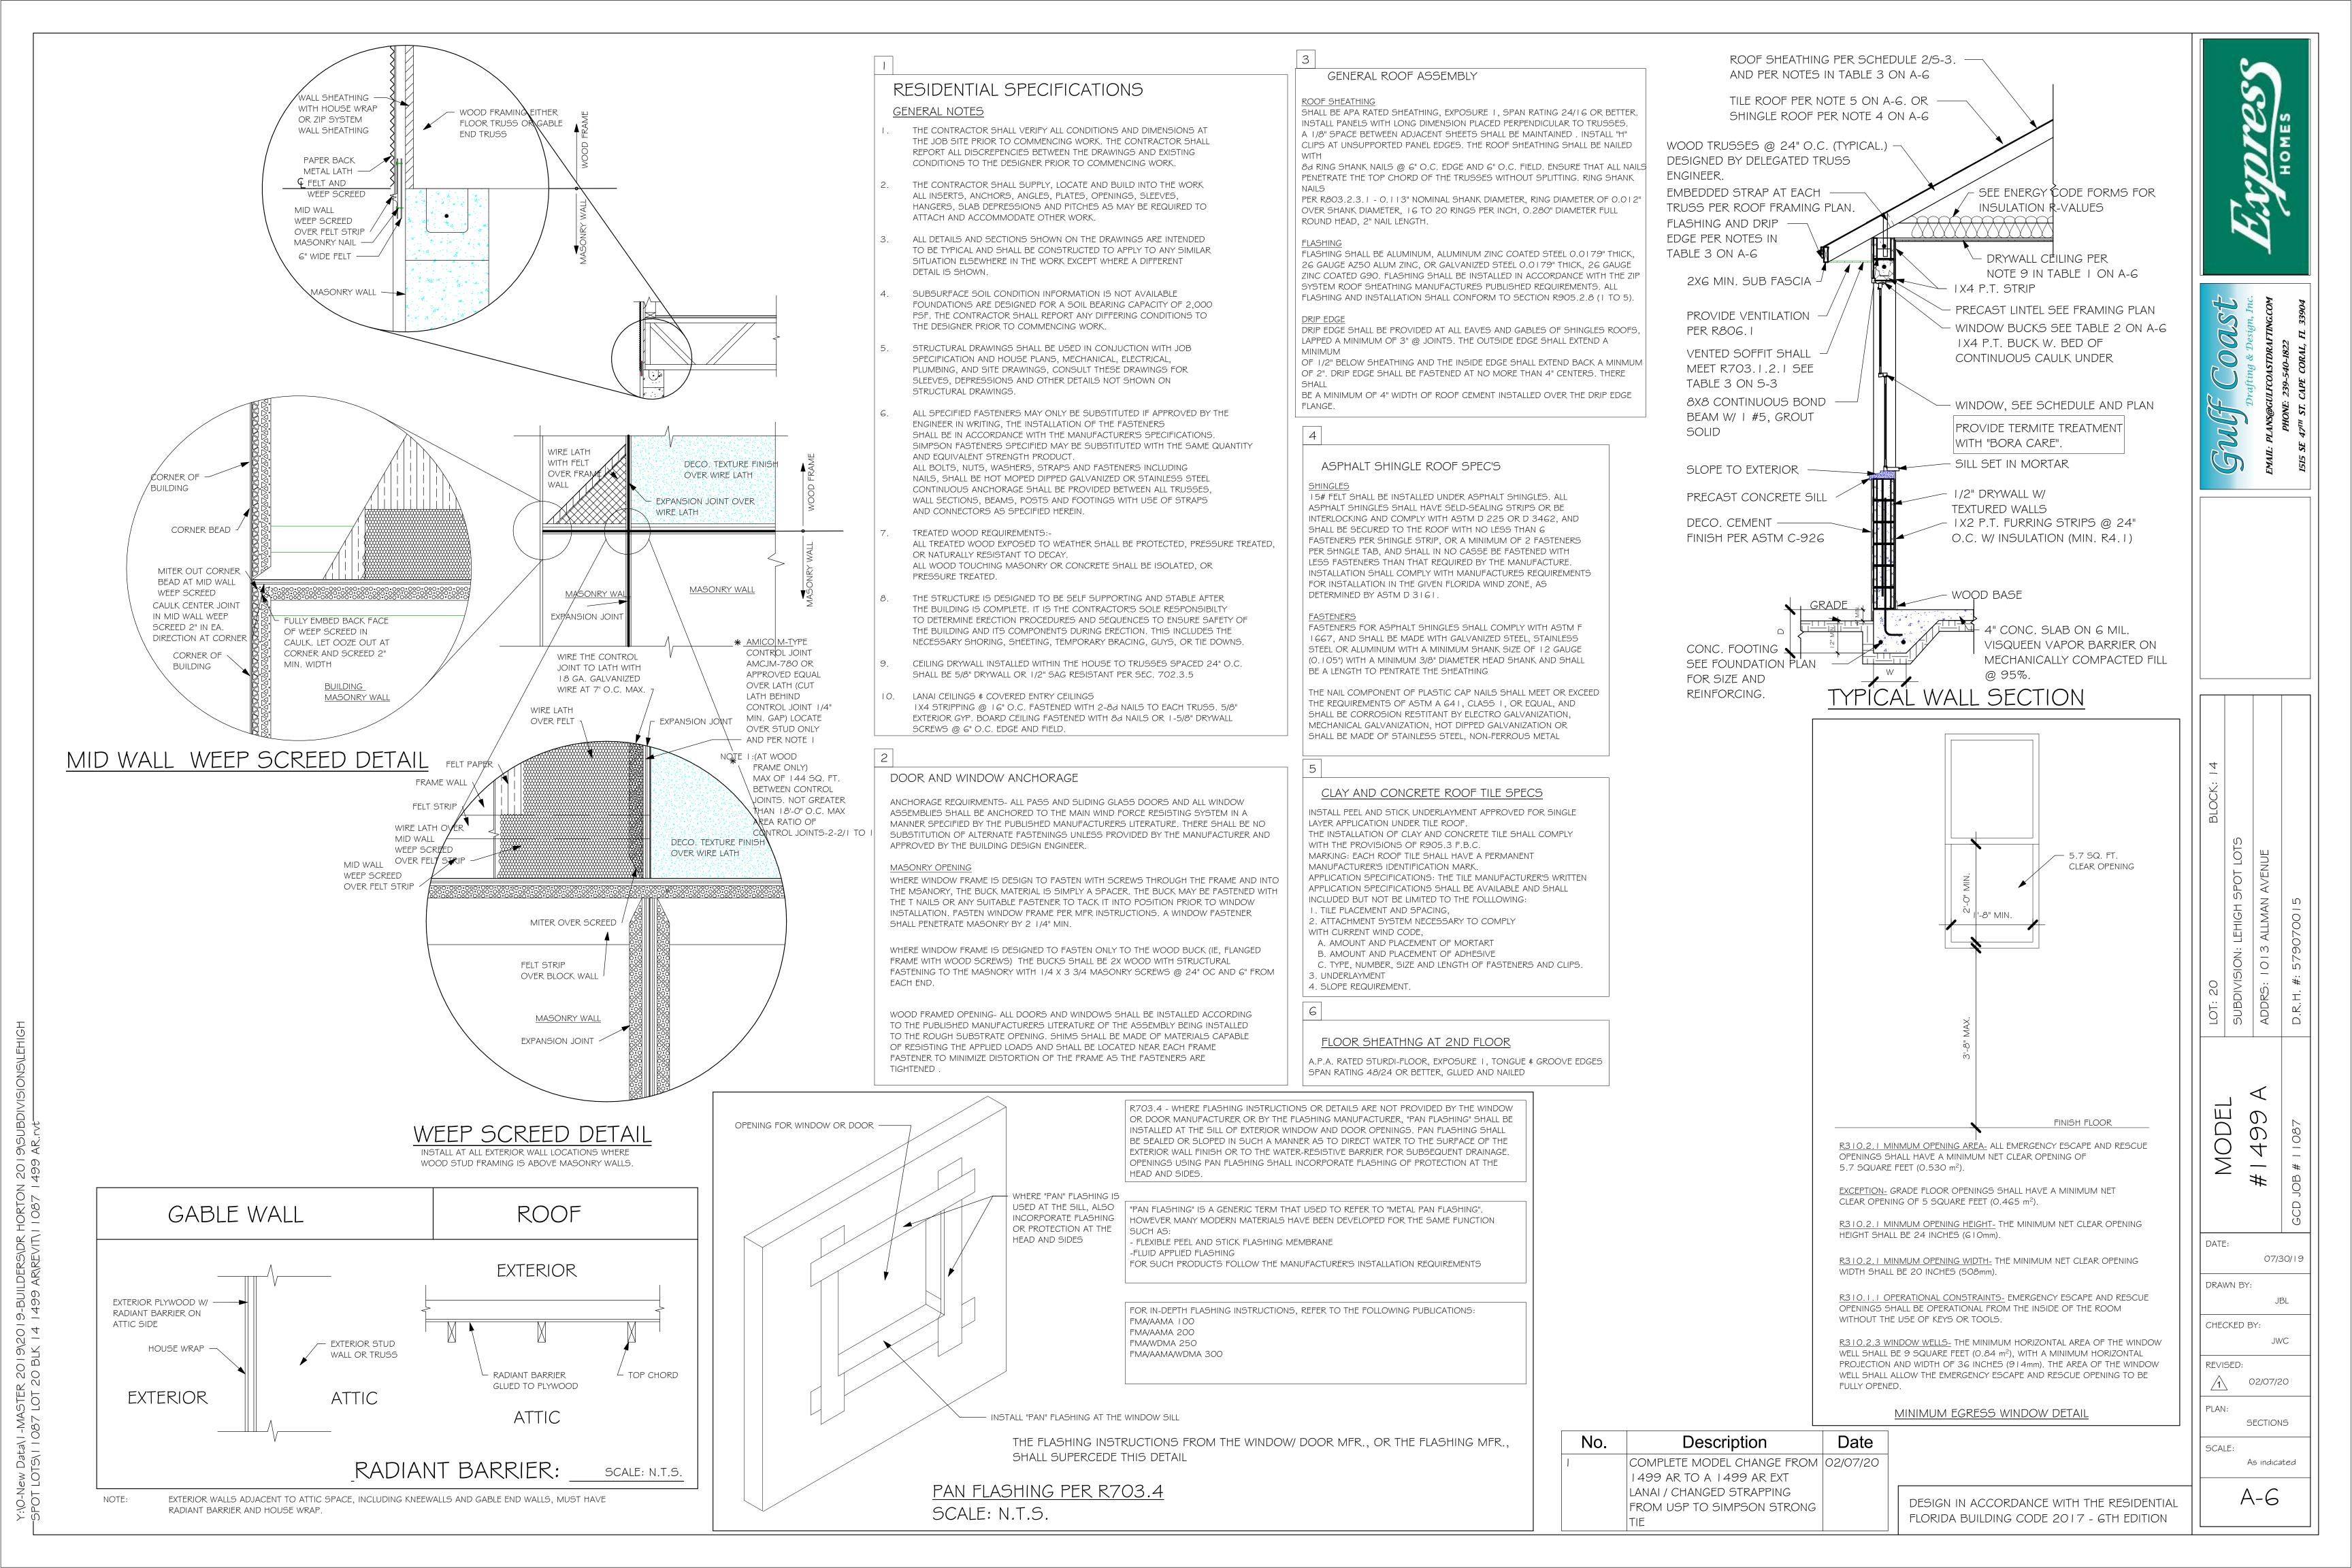


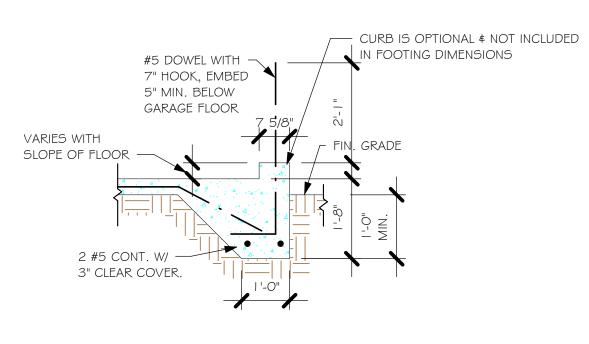


"F3" WITH CURB AT GARAGE 1/2" = 1'-0"

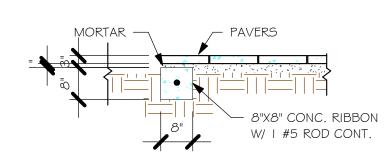

"P" PAVERS DETAIL ENTRY/ LANAI I 1/2" = 1'-0"

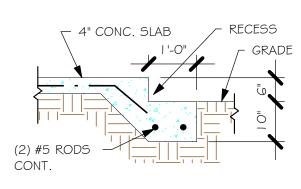

GARAGE DOOR RECESS 1/2" = 1'-0"

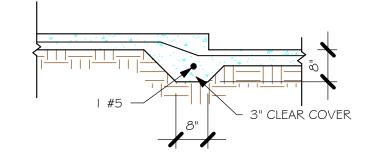

"F6A" STEP DOWN 1/2" = 1'-0"

	PAD FOOTING SCHEDULE						
USED	TYPE	LENGTH	WIDTH	DEPTH	ВОТ		REMARKS
Š					LONG	SHORT	
X	A	2'-	2'-	1'-	3-	3-	_
	$\langle B \rangle$	3'-	3'-	1'-	4-	4-	_
	C	3'-	3'-	1'-	4-	4-	_
	D	4'-	4'-	1'-	5-	5-	_
	⟨E⟩	5'-	5'-	1'-	6-	6-	_

							_
	WALL FOOTING SCHEDULE						
USED	TYPE	LENGTH	WIDTH	DEPTH	BOTTOM REINFORCIN	SHAP	
	F1	CONT	1'-	0'-	2-		
	F2	CONT	1'-	0'-1	2-		
X	F3	CONT	1'-	1'-	2-	\-	ADD CUR TO GARAGE,
	F4	CONT	1'-	1'-	2-	₩	GARAGE,
	F5	CONT	1'-	1'-	2-	F	
	F6	CONT	1'-	1'-	2-	£	
X	F6A	CONT	0'-	0'-	1-	£	
	TE	CONT	0'-	0'-	1-#5	T I	

PROVIDE CORNER BARS PER 6/S-3

FOUNDATION

SC ALE: 3/16" = PLAN NOTES:

1. TOP OF GROUND FLOOR SLAB DATUM ELEVATION 0'-0"


"F#" DENOTES CONTINUOUS WALL FOOTING TYPE PER SCHEDULE THIS SHEET. 3. \#\ DENOTES PAD FOOTING AT CONCENTRATED LOADS PER SCHEDULE THIS

PROVIDE #5 VERTICAL REINFORCING AT DOT LOCATIONS SHOWN ON PLAN FROM

FOOTING TO BOND BEAM.

ALL DIMENSIONS ARE TO OUTSIDE FACE OF MASONRY WALLS. SOME SLAB EDGES MAY EXTEND BEYOND FACE OF WALL.

FOR DIMENSIONS OF ROUGH OPENINGS IN MASONRY WALLS, COORDINATE WITH

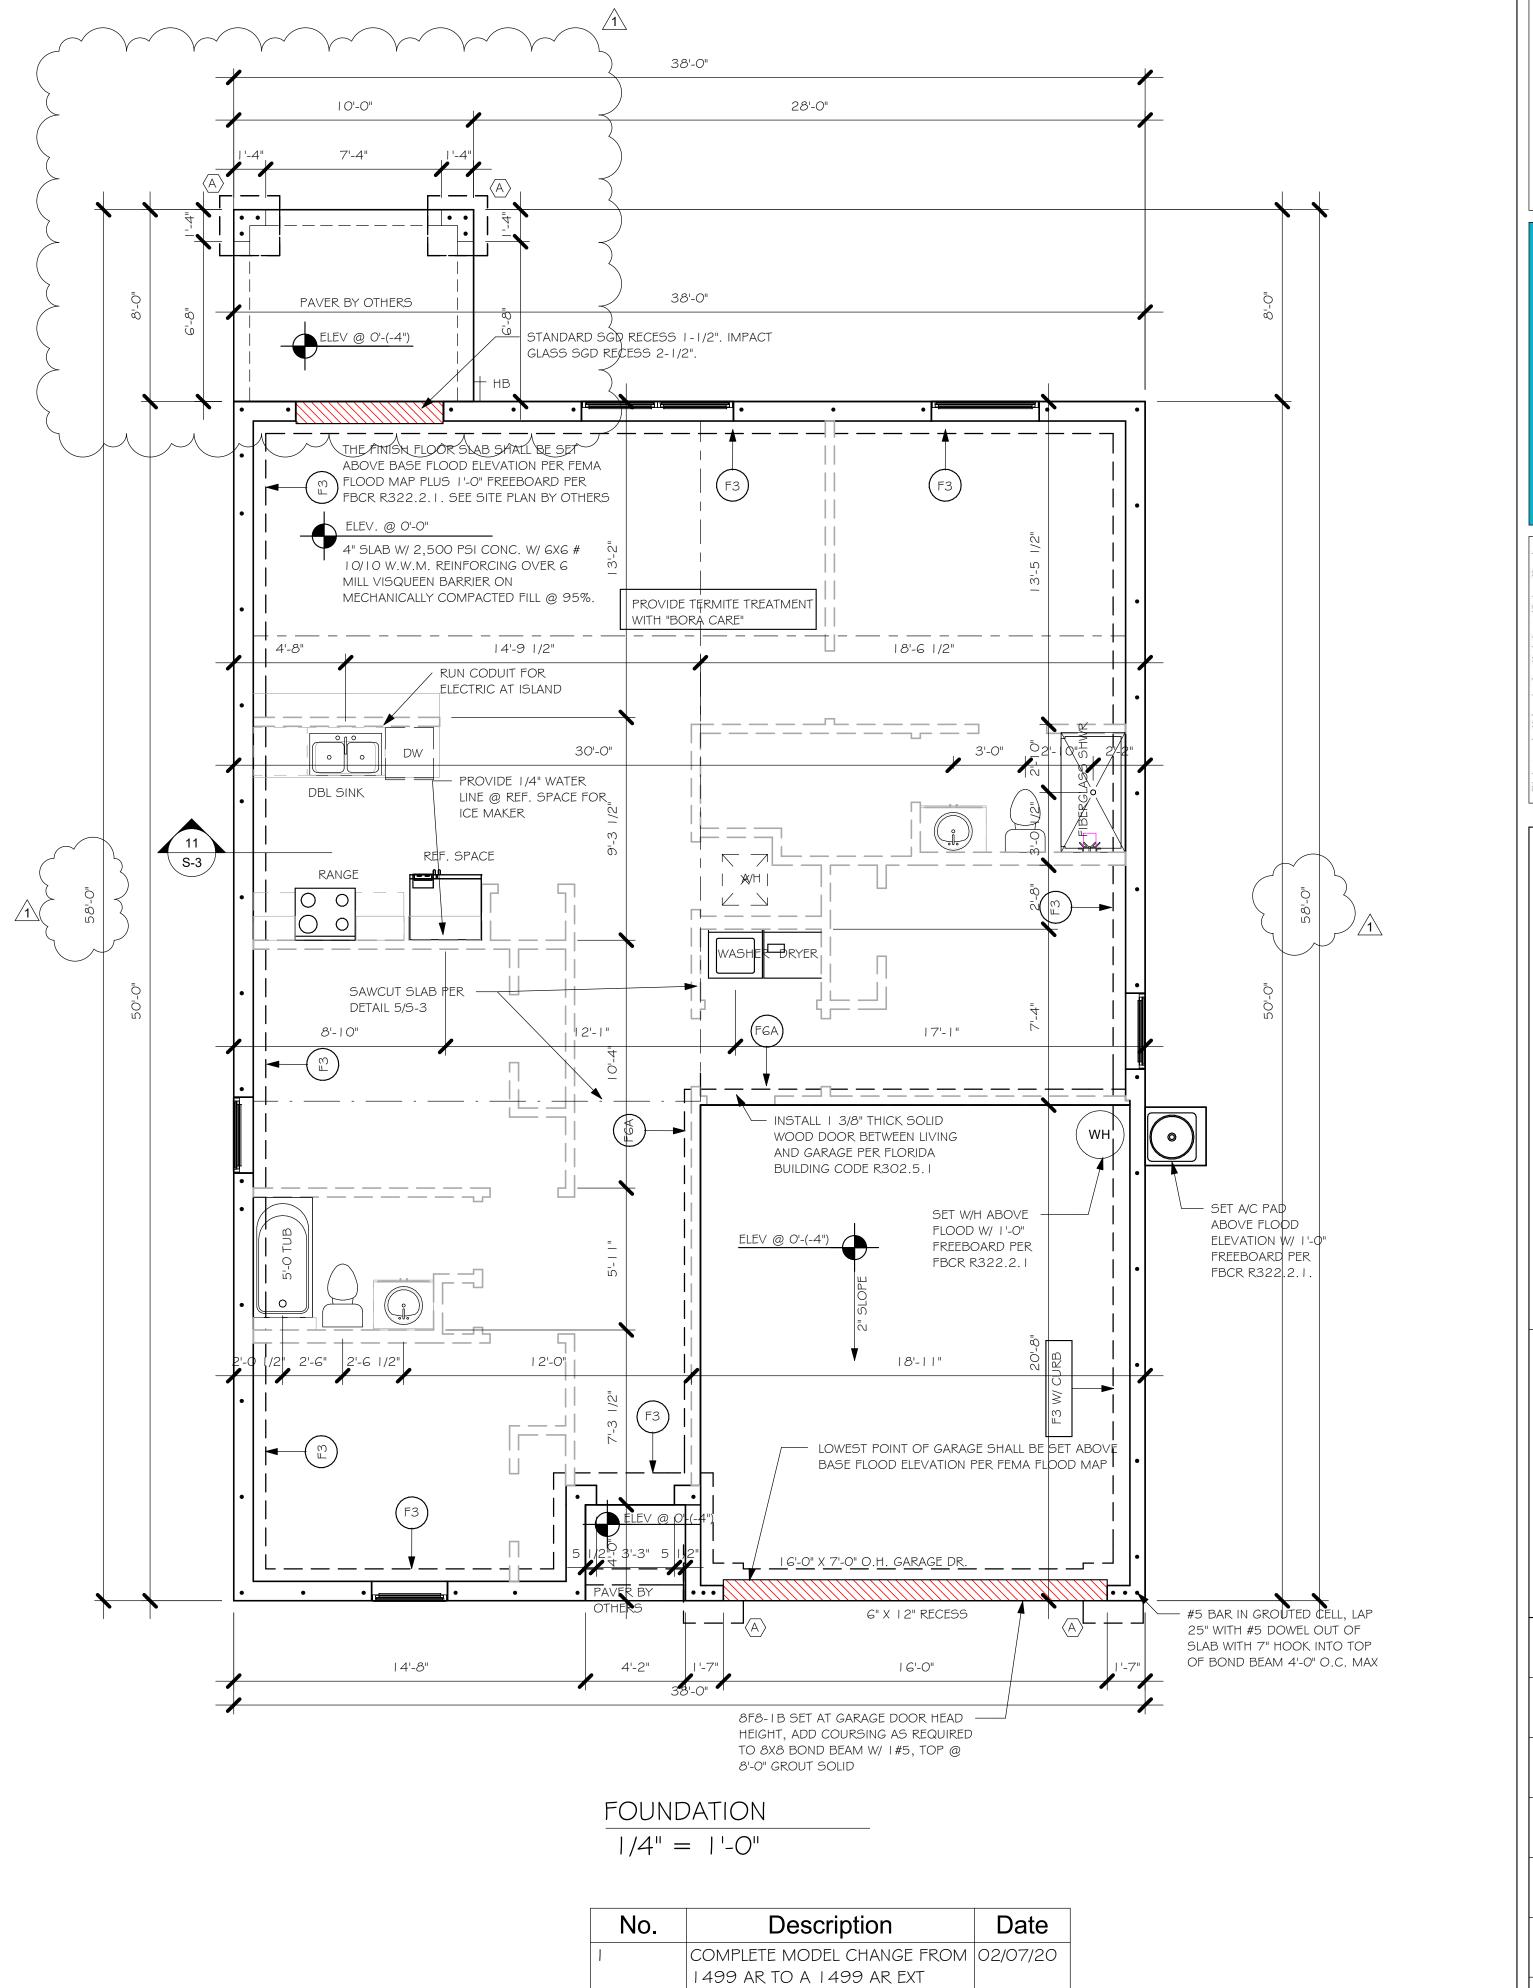

DESIGN IN ACCORDANCE WITH THE RESIDENTIAL FLORIDA BUILDING CODE 2017 - 6TH EDITION

LANAI / CHANGED STRAPPING FROM USP TO SIMPSON STRONG

ISION: LEH

DATE: 07/30/19 DRAWN BY:

CHECKED BY: JWC

REVISED: 02/07/20

PLAN: FOUNDATION PLAN

SCALE: As indicated

NOTES:

10790/SYP 10790/SPF

INSTALL

TRUSSES

HIGHER

UPLIFTS.

ON PLAN.

SEE NOTES

TO 1450 lb

I. PROVIDE A STRAP FROM THE ABOVE LIST AT EACH ROOF TRUSS BEARING POINT, BASED ON THE TRUSS UPLIFT VALUES IN THE SIGNED AND SEALED TRUSS DESIGN PACKAGE AND SUITABLE FOR THE GEOMETRY. EMBED STRAP ON -C OF WALL.

(1)HGT - 3


CONNECTORS ARE SIMPSON STRUCTURAL CONNECTORS. ALL CONNECTORS SHALL BE INSTALLED IN STRICT ACCORDANCE WITH SIMPSON PRINTED INSTUCTIONS.


SUBSTITUTIONS MUST BE APPROVED IN WRITING BY THE ENGINEER OF RECORD. WHERE EMBEDDED STRAPS ARE MISSING, OR MIS-LOCATED, INSTALL RETROFIT STRAP PER

R4-021020

16-0.148x3" TO GIRGER,

(2)^{3/4}" ATR, EPOXY 12"

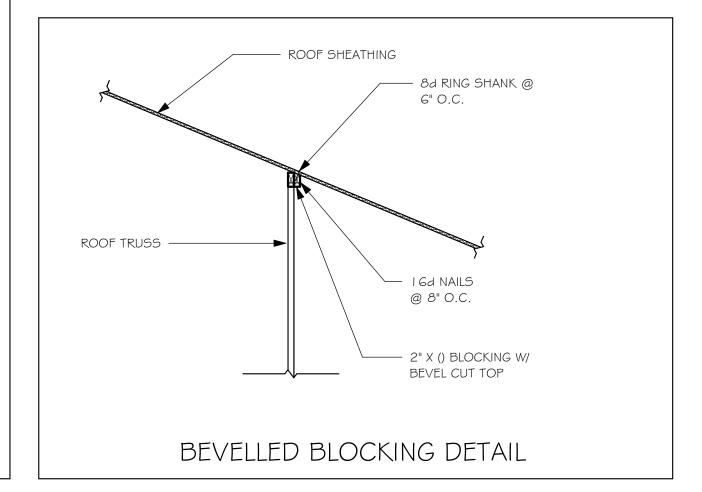

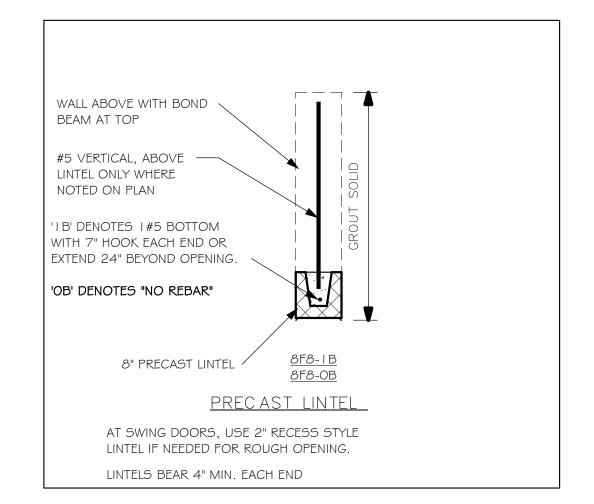

PLAN NOTES:


- ROOF TRUSS BEARING 8'-O", SEE LEGEND. ROOF FRAMING SHALL BE WOOD TRUSSES DESIGNED BYA DELEGATED TRUSS ENGINEER PER DESIGN CRITERIA ON SHEET S-3.
- PROVIDE STRAPPING AT TRUSSES PER NOTES ON THIS
- FOR NAILING OF ROOF AND FLOOR DECK, SEE | AND 2 ON 5-3.
- 8F8-1B etc., DENOTES PRECAST LINTEL ABOVE
- DOOR, WINDOW OPENING PER SCHEDULE THIS SHEET. AT TRUSS BEARING, PROVIDE 8x8 MASONRY BOND

BEAM W/ I #5 CONTINUOUS, SEE DETAIL I I/S-3.

BEARING HEIGHT

= BEARING @ 8'-0"

TRUSS BEARING CONDITIONS AND STRAPPING IS BASED ON TRUSS LAYOUT PREPARED BY SCOSTA JOB# 44116L DATED: 12/12/19 REVISED: NONE

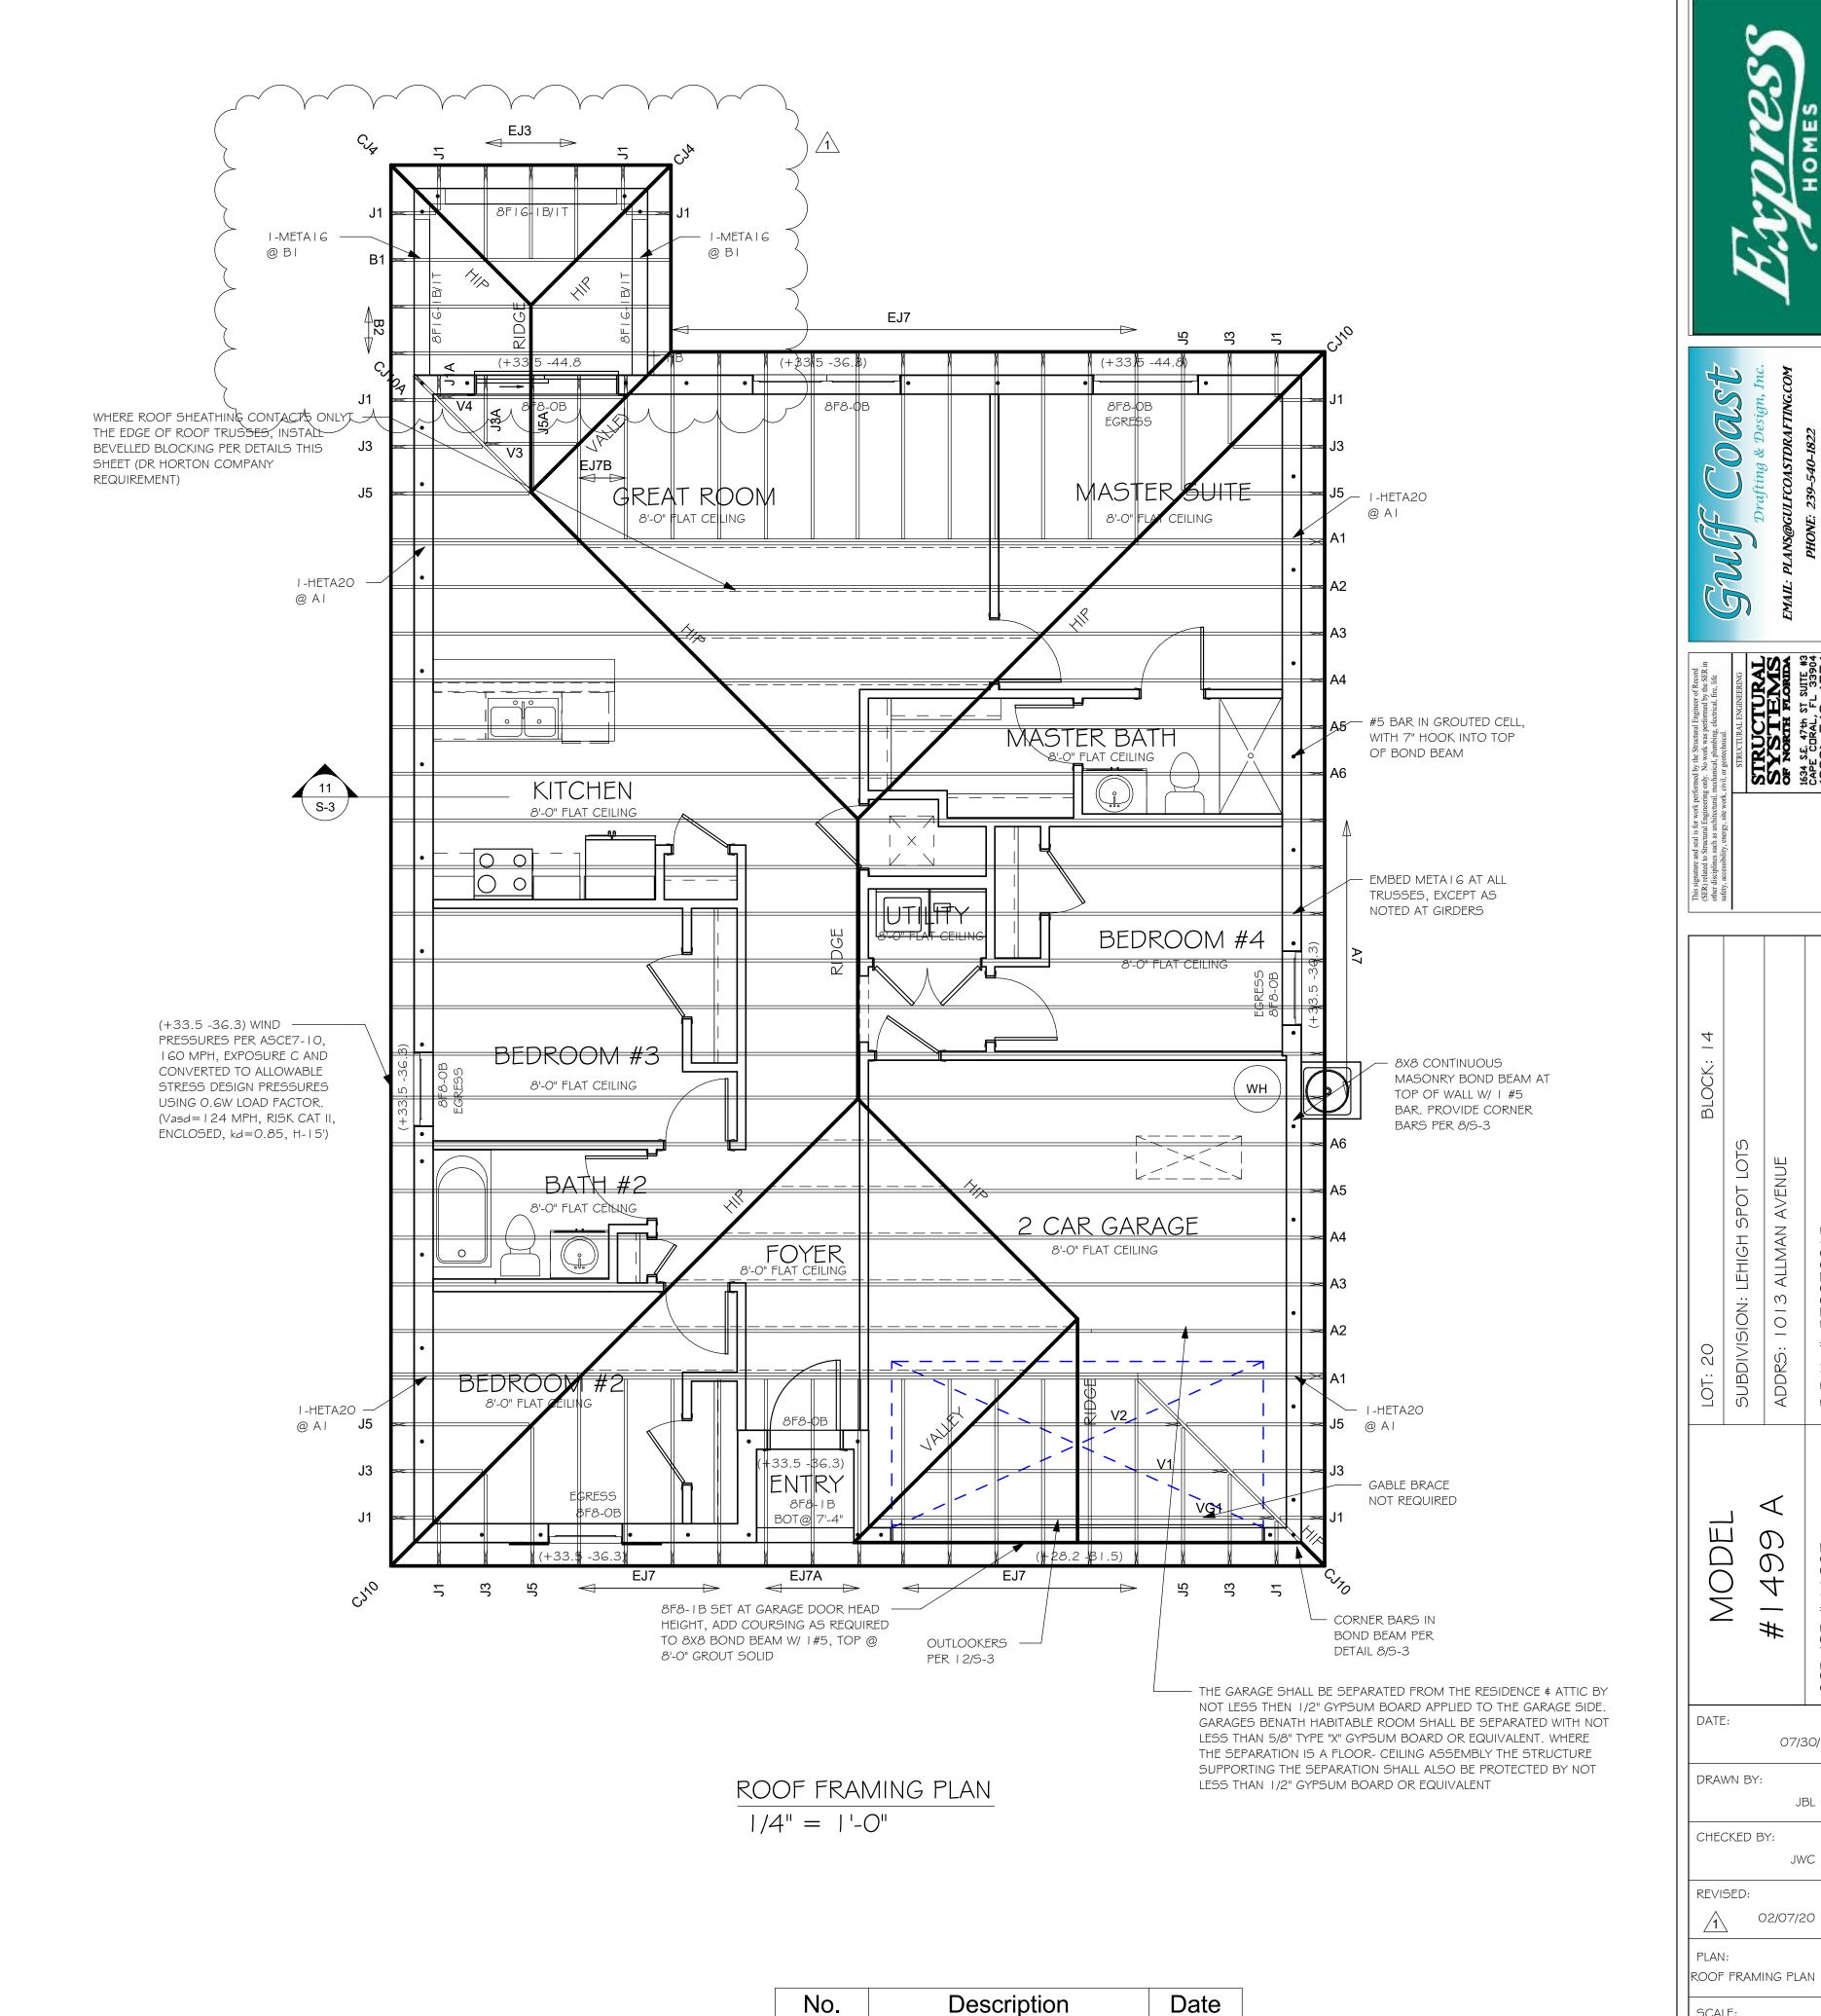

COMPLETE MODEL CHANGE FROM 02/07/20

1499 AR TO A 1499 AR EXT LANAI / CHANGED STRAPPING

FROM USP TO SIMPSON STRONG

STRUCTURAL SYSTEMS OF NORTH FLORUM 1634 SE, 47th ST SUITE #3 CAPE CIRAL, FL 33904 (239) 549-4554

1013

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07/30/19

JBL

JWC


02/07/20

As indicated

SCALE:

DESIGN IN ACCORDANCE WITH THE RESIDENTIAL

FLORIDA BUILDING CODE 2017 - 6TH EDITION

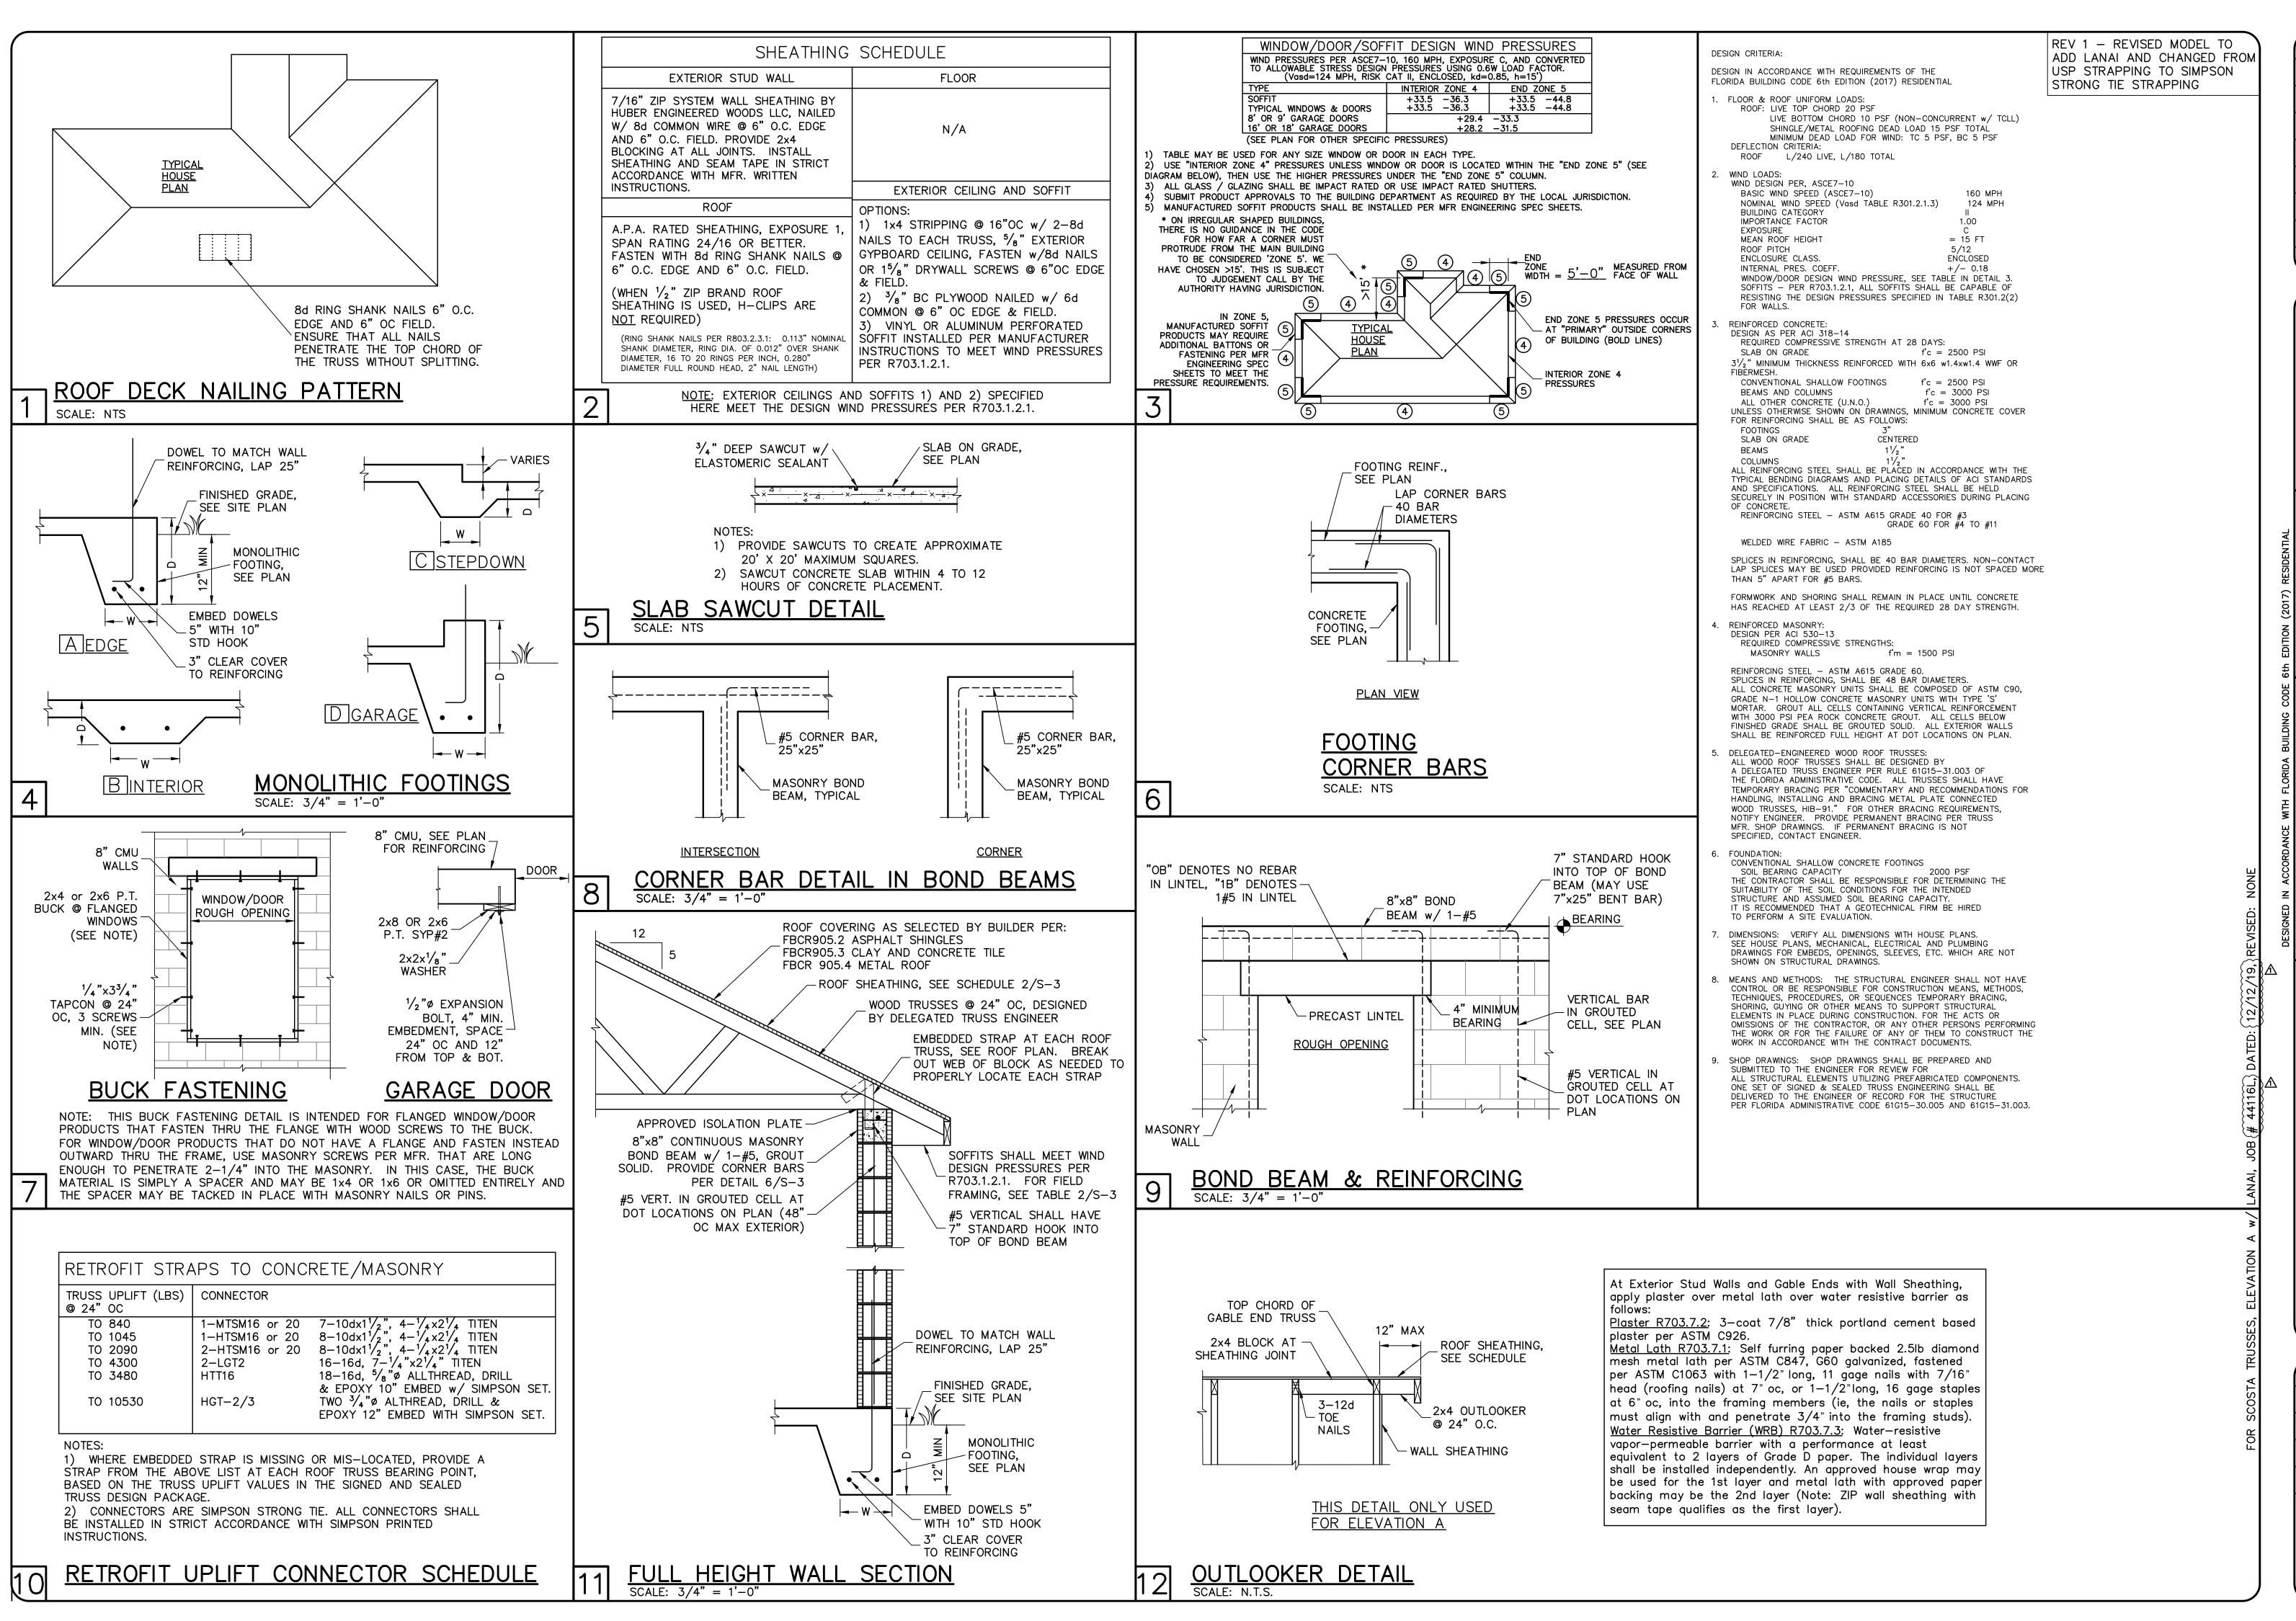

REVISIONS <u>/1</u>\02/11/20

W. W. BERG ... CENS No. 58552 STATE OF NORIO! W. STONAL F

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TR

DWB/DWB CHECKED DWB 02/11/20

SCALE VARIES JOB NO. DR11087

SHEET 3 OF 3