

UNLESS NOTED

REACTION VALUES ARE UNDER 5000# UPLIFT VALUES ARE UNDER 1000#

ALL TRUSSES 24"o.c. UNLESS NOTED OTHERWISE *******CAUTION*****

DO NOT ATTEMPT TO ERECT TRUSSES WITH-OUT REFERRING TO THE ENGINEERING DWGS.

IT IS NECESSARY TO REFER TO THE ENGINEERING DRAWINGS FOR NUMBER OF MEMBERS, BEARING LOCATION, ORIENTATION AND WEB BRACING

REFER TO WTCA/TPI BSCI-B1 SUMMARY SHEET FOR HANDLING METHODS & TEMPORARY BRACING, WHICH IS ALWAYS REQUIRED

BEARING HEIGHTS BASED ON PLANS PROVIDED TO SCOSTA CORP. "+/-" BEARING DIFFERENCES SHOWN ARE CRITICAL. IF ANY HEIGHTS DEVIATE — INFORM SCOSTA CORP.

BEARING WALL & BEAM HEIGHTS

	0'-0"	ELEV.
7//////		ELEV.
		ELEV. ELEV.

TYPICAL HANGER SCHEDULE

- C SIMPSON HUS 26 M SIMPSON HGUS 28-3
- F SIMPSON HUS 28 N SIMPSON HHUS 48 H SIMPSON HGUS 28 P SIMPSON LUS 24
- I SIMPSON HGUS 28-2 B SIMPSON THA 422
- W SIMPSON THJA26 X

HANGER VALUES HAVE BEEN BASED ON 16D COMMON NAILS EXCEPT THE FOLLOWING LUS24 - 10D COMMON THJA26 - 10D x 1-1/2

*****ATTENTION*****


APPROVAL OF THIS TRUSS LAYOUT IS NECESSARY BEFORE FABRICATION CAN BEGIN. VERIFY DIMENSIONS, PITCHES, OVERHANGS, ELEVATIONS, CEILING & BEARING CONDITIONS. SCOSTA CORPORATION IS RESPONSIBLE FOR ACCURACY IN ACCORDANCE WITH PLANS AND/OR INFORMATION PROVIDED BY CUSTOMER, WITH ANY DEVIATIONS NOTED HEREIN. CUSTOMER IS RESPONSIBLE TO VERIFY ACCURACY OF INFORMATION AND PLANS PROVIDED TO SCOSTA CORPORATION, AND TO VERIFY CONFORMANCE TO FIELD CONDITIONS, AND/OR OWNER CHANGES. TRUSSES WILL BE BUILT IN ACCORDANCE WITH THE APPROVED LAYOUT.

APPROVED BY: _____


JOBSITE CONTACT NAME: _____

DATE: _____ REQUESTED DELIVERY DATE: _____


PHONE #:_

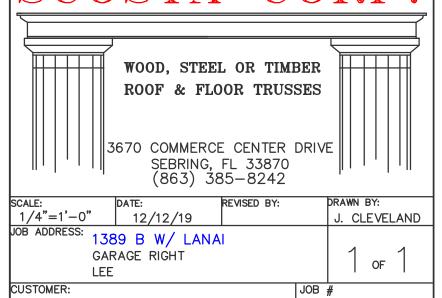



E-MAIL:	
SCOSTA C	ORP.
WOOD, STEEL OR TIME ROOF & FLOOR TRUS 3670 COMMERCE CENTER SEBRING, FL 33870 (863) 385-8242	SES
E: DATE: REVISED BY: 12/12/19	DRAWN BY: J. CLEVELAND
ADDRESS: 1389 B W/ LANAI GARAGE RIGHT LEE	1 of 1
TOMER:	JOB #
.R. HORTON	44115BL

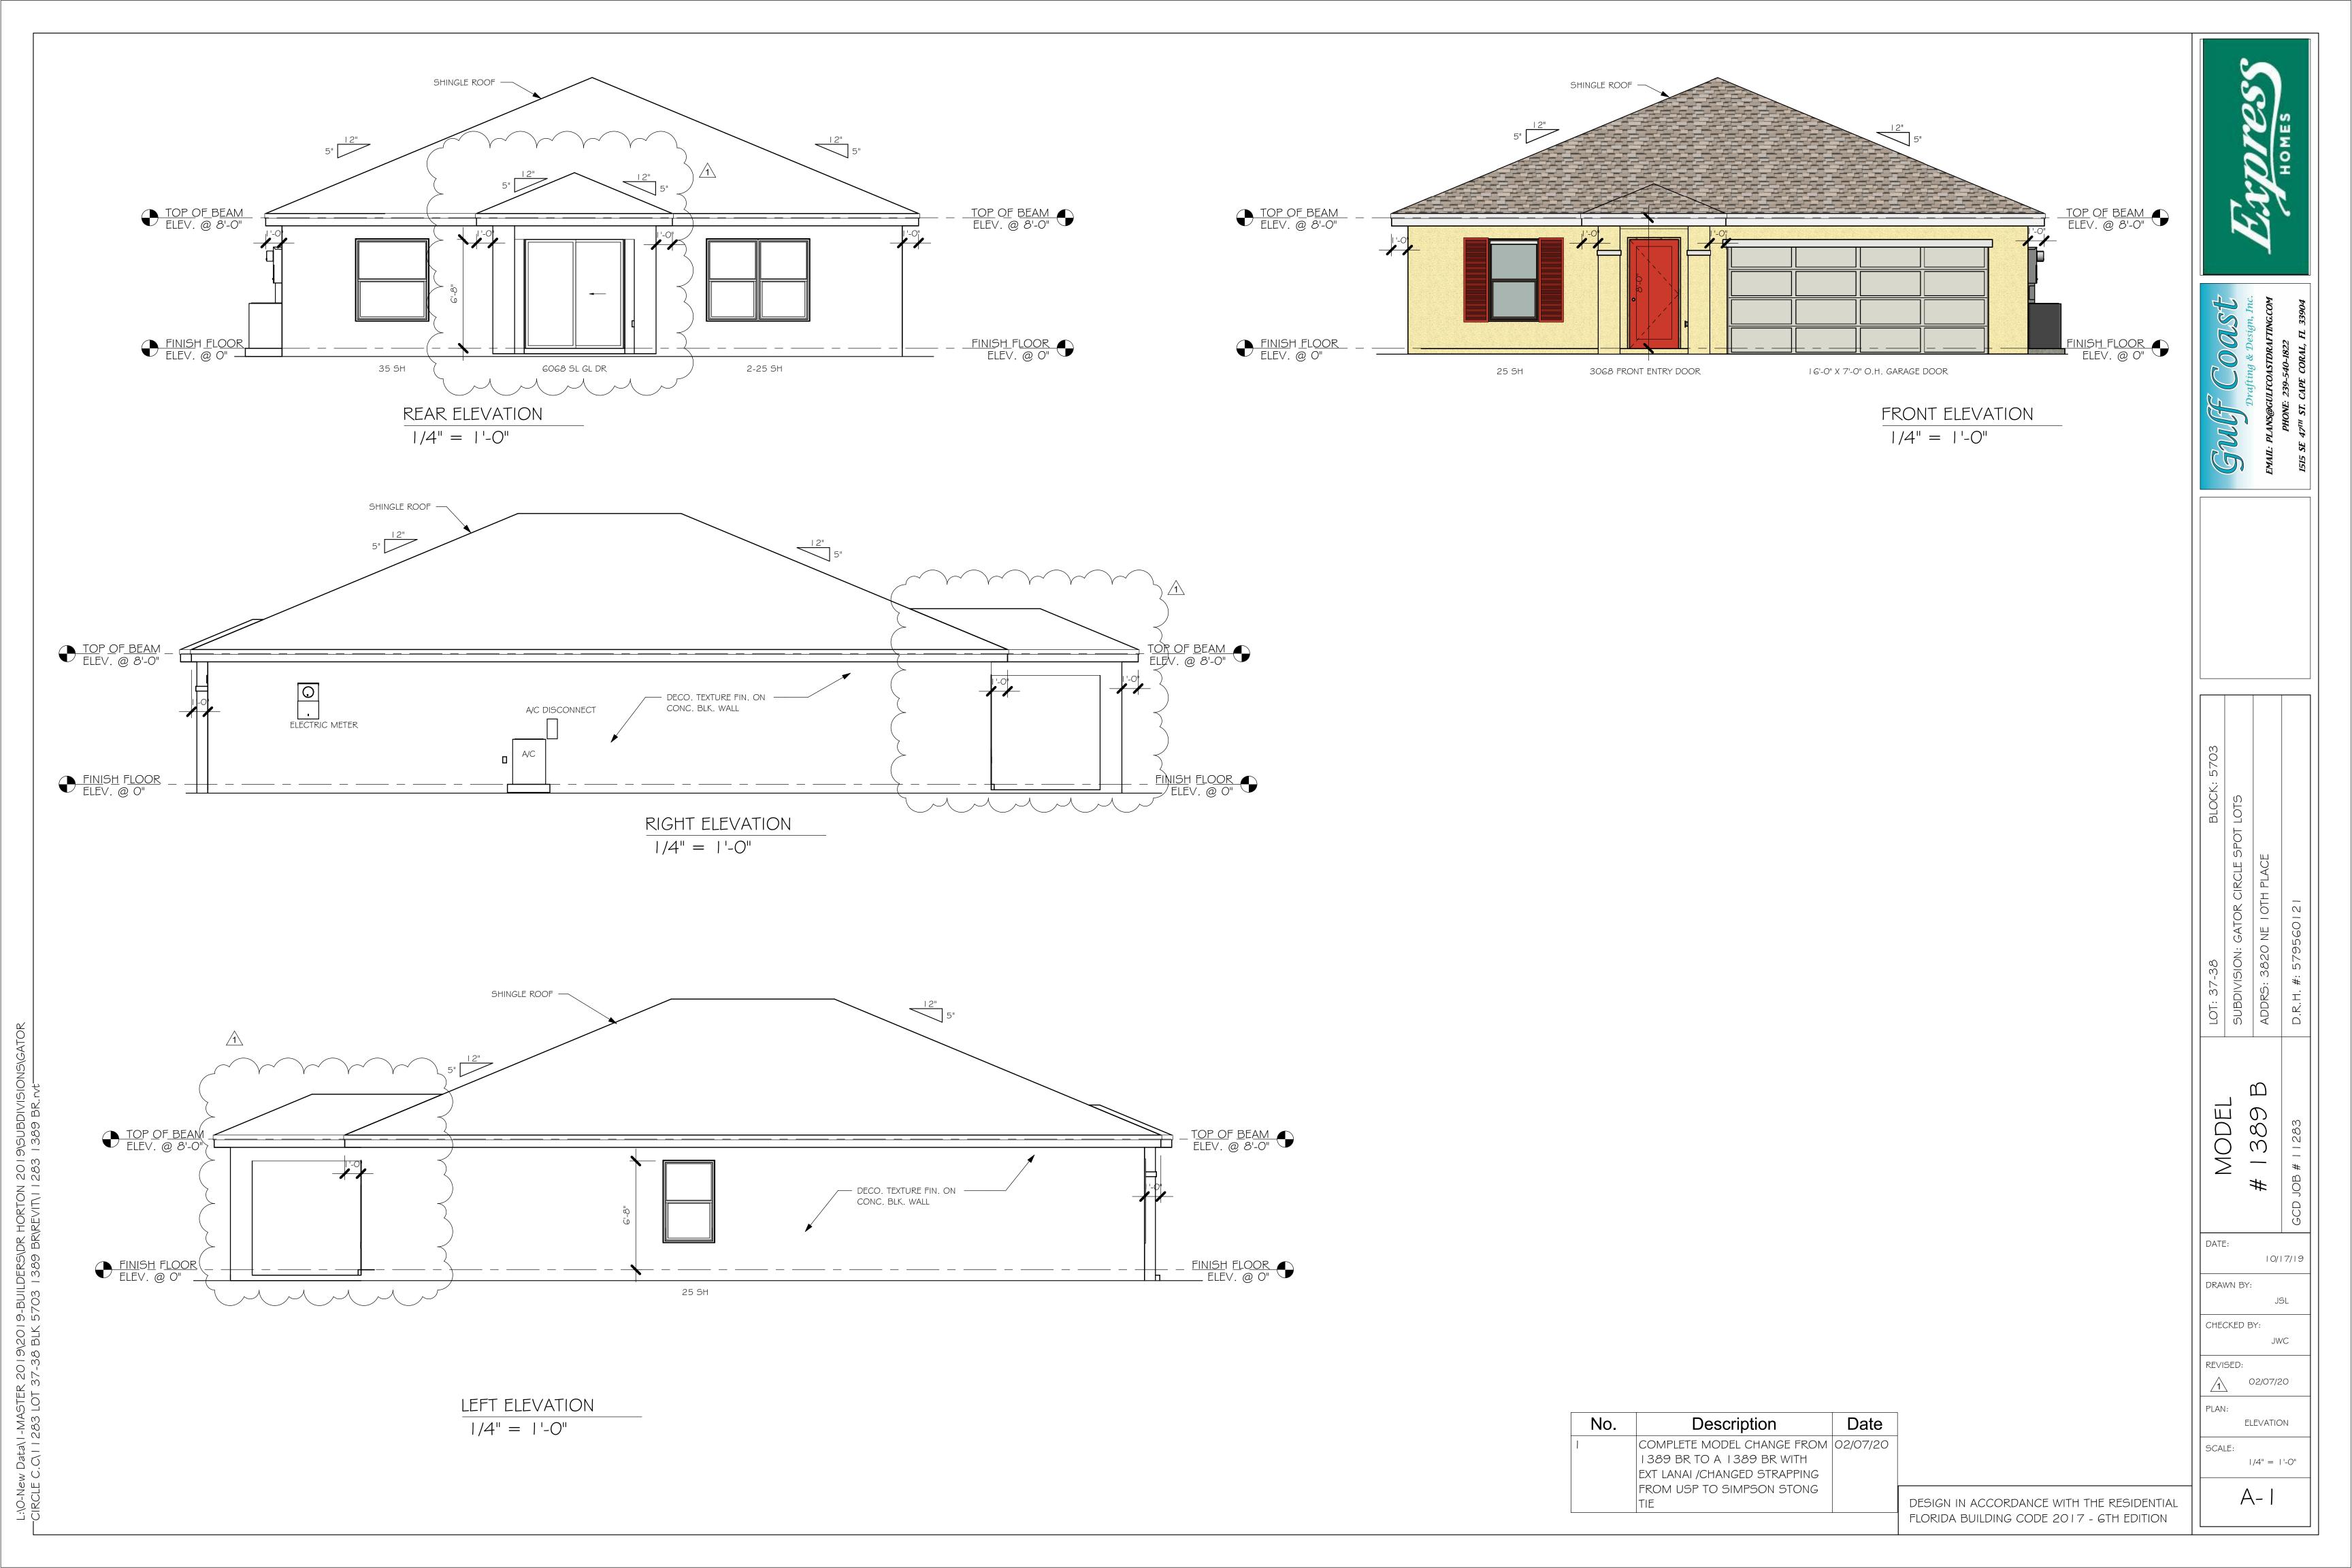



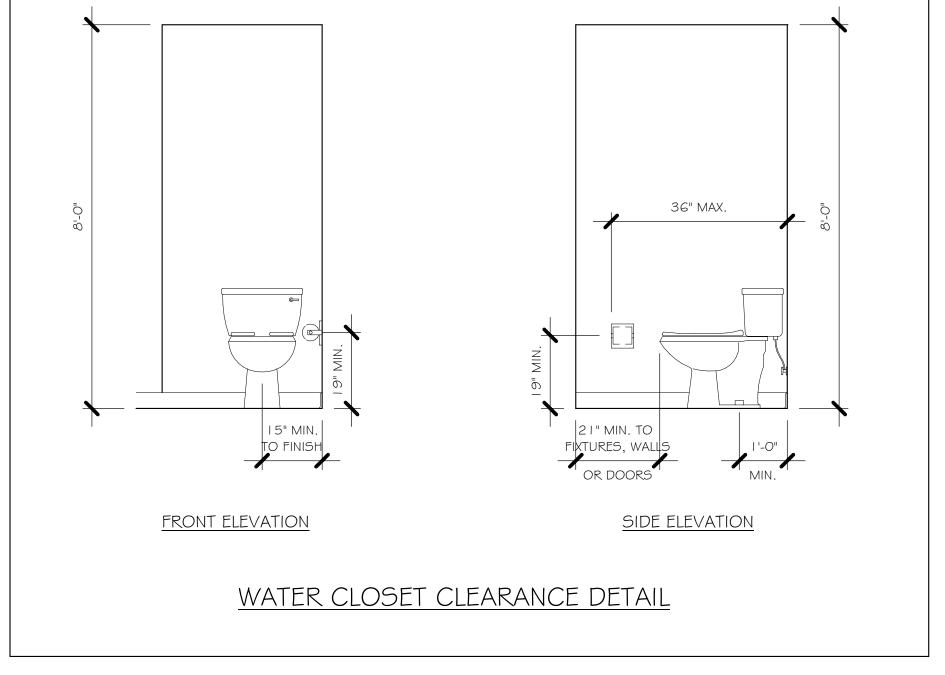

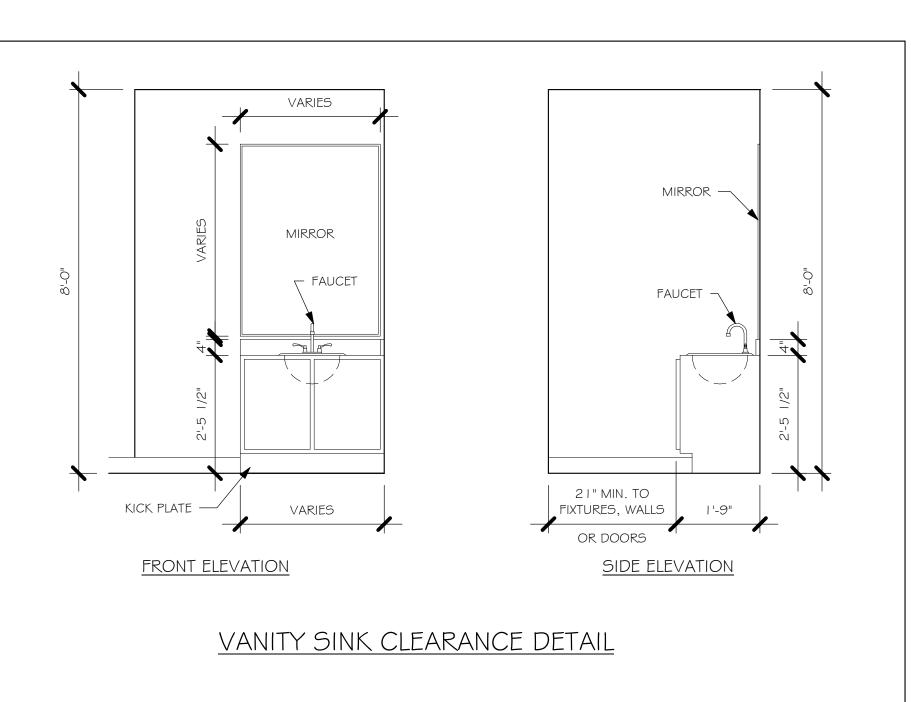

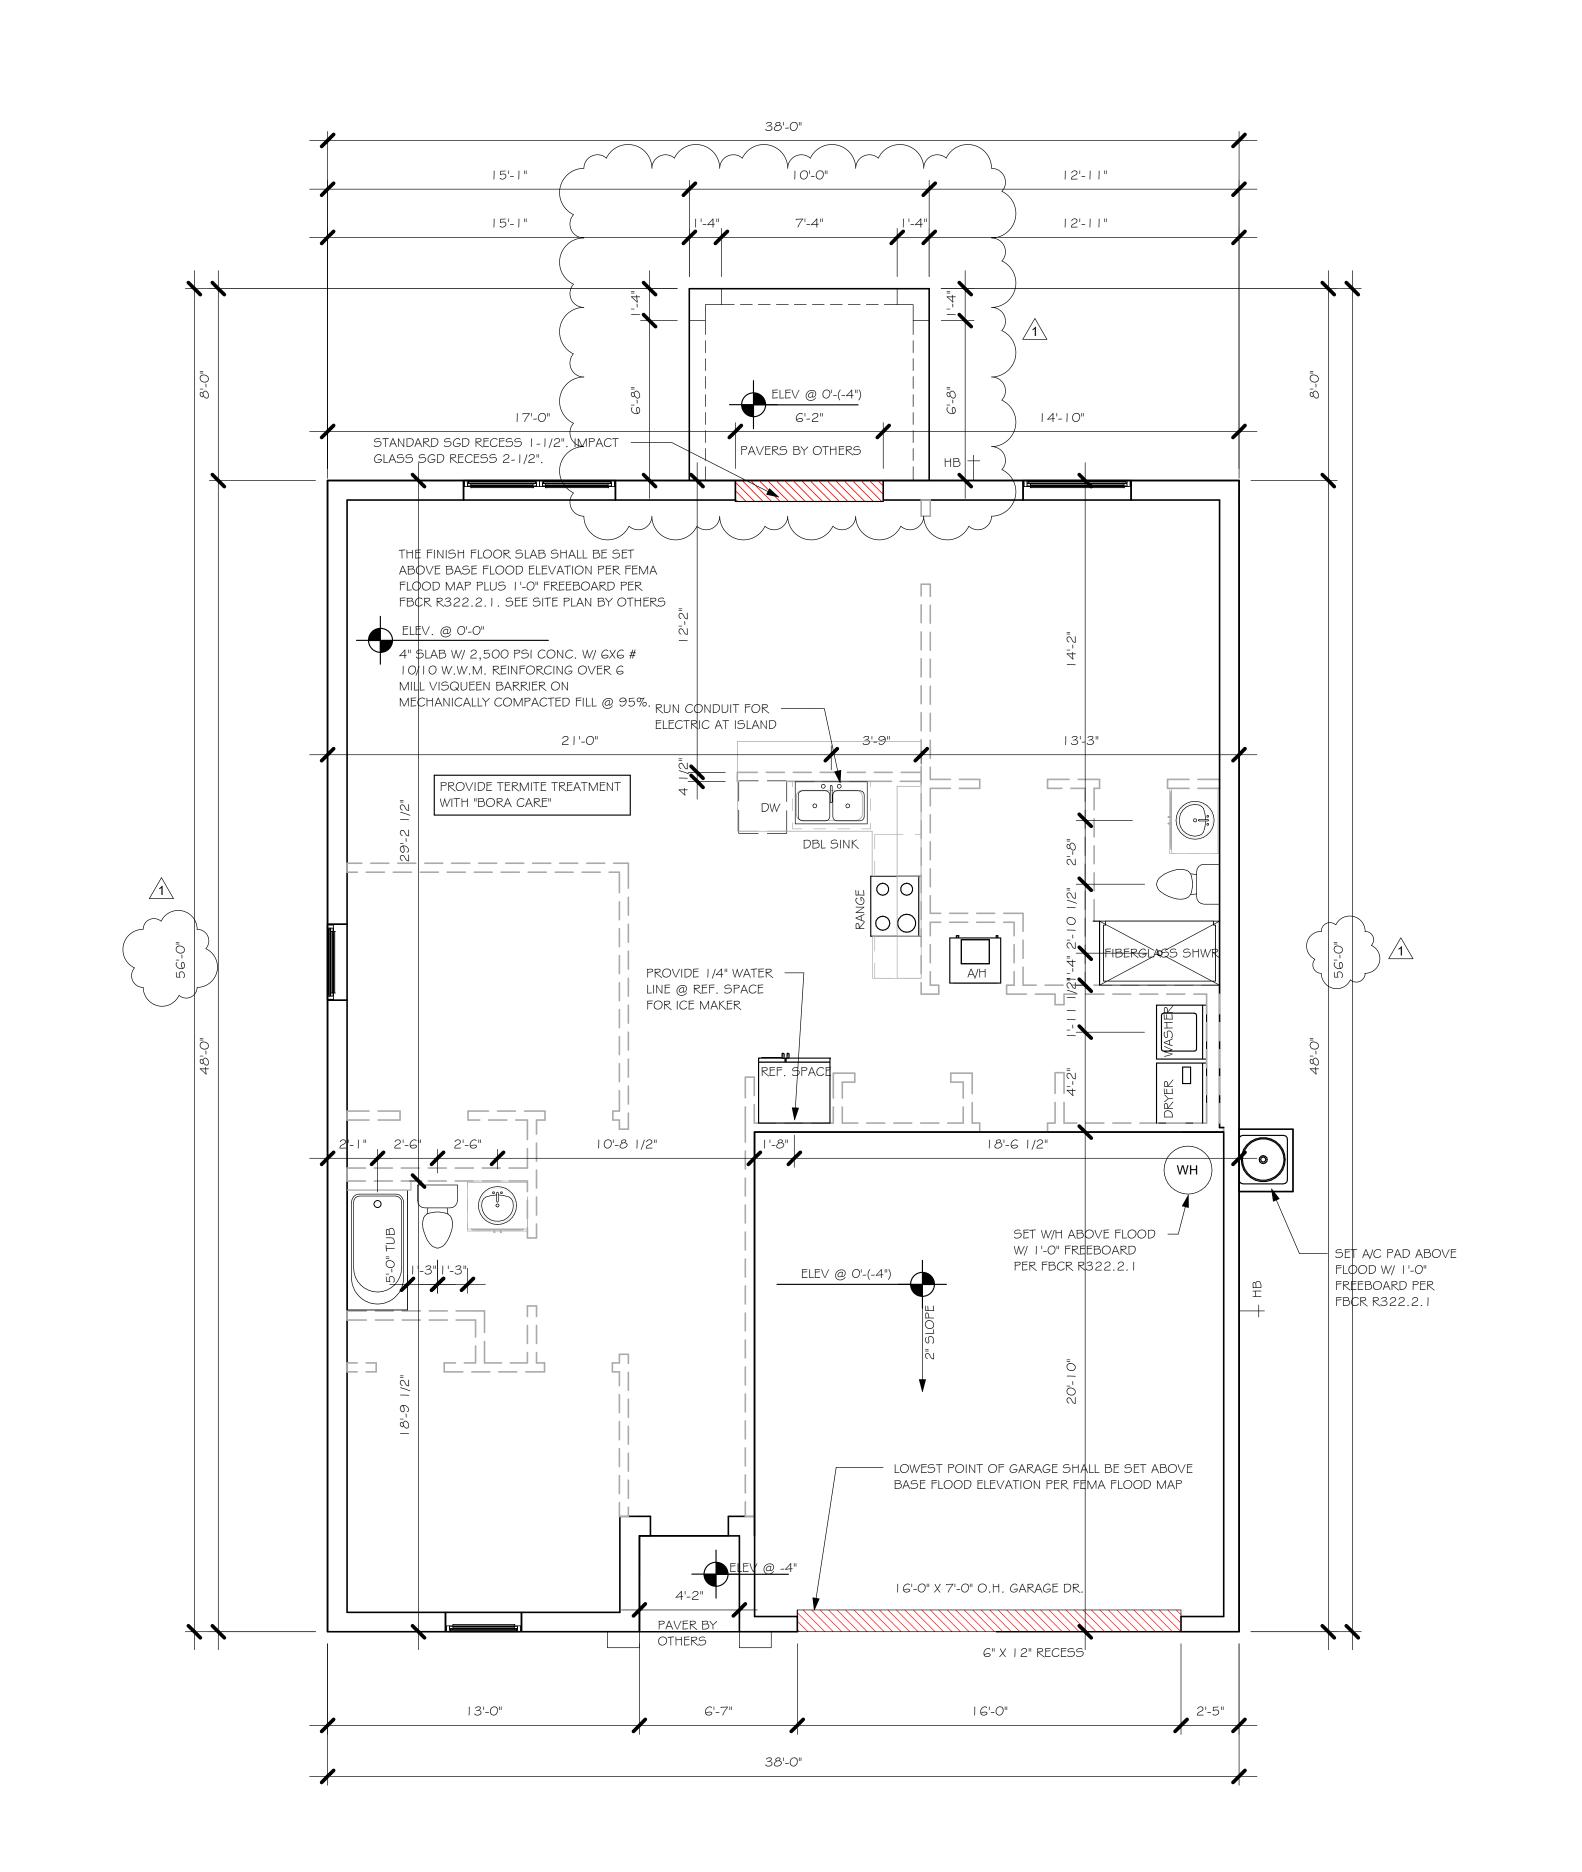

SLAB & PLUMBING 1/4" = 1'-0"


No.	Description	Date
	COMPLETE MODEL CHANGE FROM	02/07/20
	1389 BR TO A 1389 BR WITH	
	EXT LANAI /CHANGED STRAPPING FROM USP TO SIMPSON STONG	
	FROM USP TO SIMPSON STONG	
	TIE	

FLORIDA BUILDING CODE 2017 - 6TH EDITION

DESIGN IN ACCORDANCE WITH THE RESIDENTIAL

MODEL DATE: 10/17/19 DRAWN BY: CHECKED BY: REVISED: 02/07/20 PLAN: SLAB & PLUMBING SCALE: As indicated

A-2

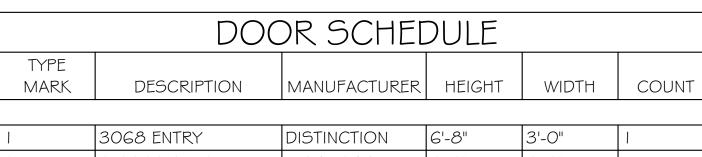

1	3068 ENTRY	DISTINCTION	6'-8"	3'-0"	
2	2-3068 SL. GL. DR.	DISTINCTION	6'-8"	6'-0"	1
3	16070 OHGD	GARAGE DOOR	7'-0"	16'-0"	1

	WII	NDOW SC	CHEDU	LE	
MARK	DESCRIPTION	MANUFACTURER	COUNT	HEIGHT	WIDTH

Α	2-25 SH		5'-3"	6'-4"
В	25 SH	2	5'-3"	3'-2"
С	35 SH	1	5'-3"	4'-6"

Do	OOR HEADE	RS
6'-8" BI-FOLD	HEADER HEIGHT	82" A.F.F.
6'-8" SWING	HEADER HEIGHT	82 I/2" A.F.F.
8'-0" SWING	HEADER HEIGHT	98 I/2" A.F.F.

PLAN NOTES


- VERIFY ALL ROUGH OPENING DIMENSIONS FOR ALL WINDOWS AND DOORS
- PROVIDE SAFETY GLAZING WITHIN 24" FROM EXIT PER FLORIDA BUILDING CODE R 308.4.2.
- PROVIDE SAFETY GLAZING AT BATH/ SHOWER PER FLORIDA BUILDING CODE R 308.4.5.
- NON BEARING INTERIOR FRAME WALLS SHALL BE FRAMED W/ WOOD OR METAL STUDS. SPACING SHALL NOT EXCEED 24" O.C. (NON BEARING WALLS ONLY)
- PROVIDE DEAD WOOD IN ATTIC FOR OVERHEAD GARAGE DOOR HARDWARE
- KITCHEN KNEE WALL TO BE FRAMED W/ TOP @ 34 I/2" A.F.F.
- INSTALL SMOOTH WALLS IN KITCHEN AND ALL
- BATHROOM AREAS WHERE DRYWALL CEILING IS APPLIED TO TRUSSES
- @ 24" O.C. USE 5/8" DRYWALL OR 1/2" SAG RESISTANT PER SEC. 702.3.5 THE GARAGE SHALL BE SEPARATED FROM THE RESIDENCE & ATTIC BY NOT LESS THEN 1/2" GYPSUM BOARD APPLIED TO THE GARAGE SIDE. GARAGES
- BENEATH HABITABLE ROOMS SHALL BE SEPARATED WITH NOT LESS THAN 5/8" TYPE "X" GYPSUM BOARD OR EQUIVALENT. WHERE THE SEPARATIION IS A FLOOR - CEILING ASSEMBLY, THE STRUCTURE SUPPORTING THE SEPARTION SHALL ALSO BE PROTECTED BY NOT LESS THAN 1/2" GYPSOM BOARD OR EQUIVALENT
- 10) INSTALL 1 3/8" THICK SOLID WOOD DOOR BETWEEN LIVING AND GARAGE PER FLORIDA BUILDING CODE R302.1.5,
- II) ALL WINDOWS INSTALLED 72" ABOVE GRADE MUST COMPLY WITH R6 | 2.2 MIN 24" SILL HEIGHT OR PROVIDED WITH AN APPROVED WINDOW FALL PRVENTION DEVICE
- 12) ALL CLOSET SHELVES TO BE 12". ALL PANTRY \$ LINEN TO BE (4)-16" SHELVES 18" O.F.F. W/ 15" INCREMENT.
- 13) ALL MECHANICAL AND ELECTRICAL EQIUPMENT TO BE INSTALLED AT OR ABOVE FLOOD PLUS 1'-O" FREEBOARD.

IN	TERIOR DO	OR SCHEDULE
MARK	DOOR WIDTH	NOTES
	3'-0"	P.K. = POCKET DOOR
2	2'-8"	B.F. = BI-FOLD DOOR
3	2'-6"	D.1 DI-10LD DOOK
4	2'-4"	B.P. = BI-PASS DOOR
5	2'-0"	L.V. = LOUVERED DOO
6	1'-8"	
7	1'-6"	
8	2'-11"	


SQUARE FOOTAG	涯
LIVING AREA	1,389
GARAGE AREA	419
LANAI AREA	80
FRONT PORCH/ ENTRY AREA	16
TOTAL SQUARE FOOTAGE	1,904

CA	BINET BACK	KING
KITCHEN	UPPER TOP @ 84"	BASE TOP @ 35"
MASTER BATH	UPPER	BASE TOP @ 35"
GUEST BATH	UPPER	BASE TOP @ 31"
LAUNDRY ROOM	UPPER TOP @ 84"	BASE

	BATHROOM NOTES
TB TOWEL BAR	ALL TUB DECKS @ 21" A.F.F
TP TOILET PAPER	ALL BLOCKING TO BE PT IN SHOWERS
	_
	3'-2"

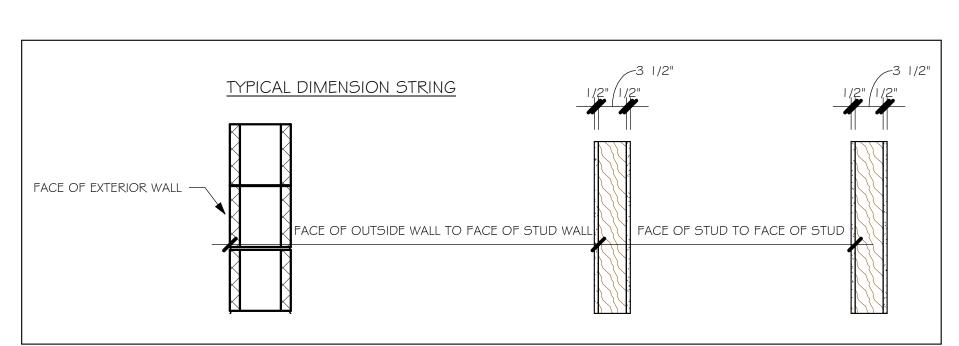

3'-2"
TOWEL BAR
TOILET PAPER ROLL
-

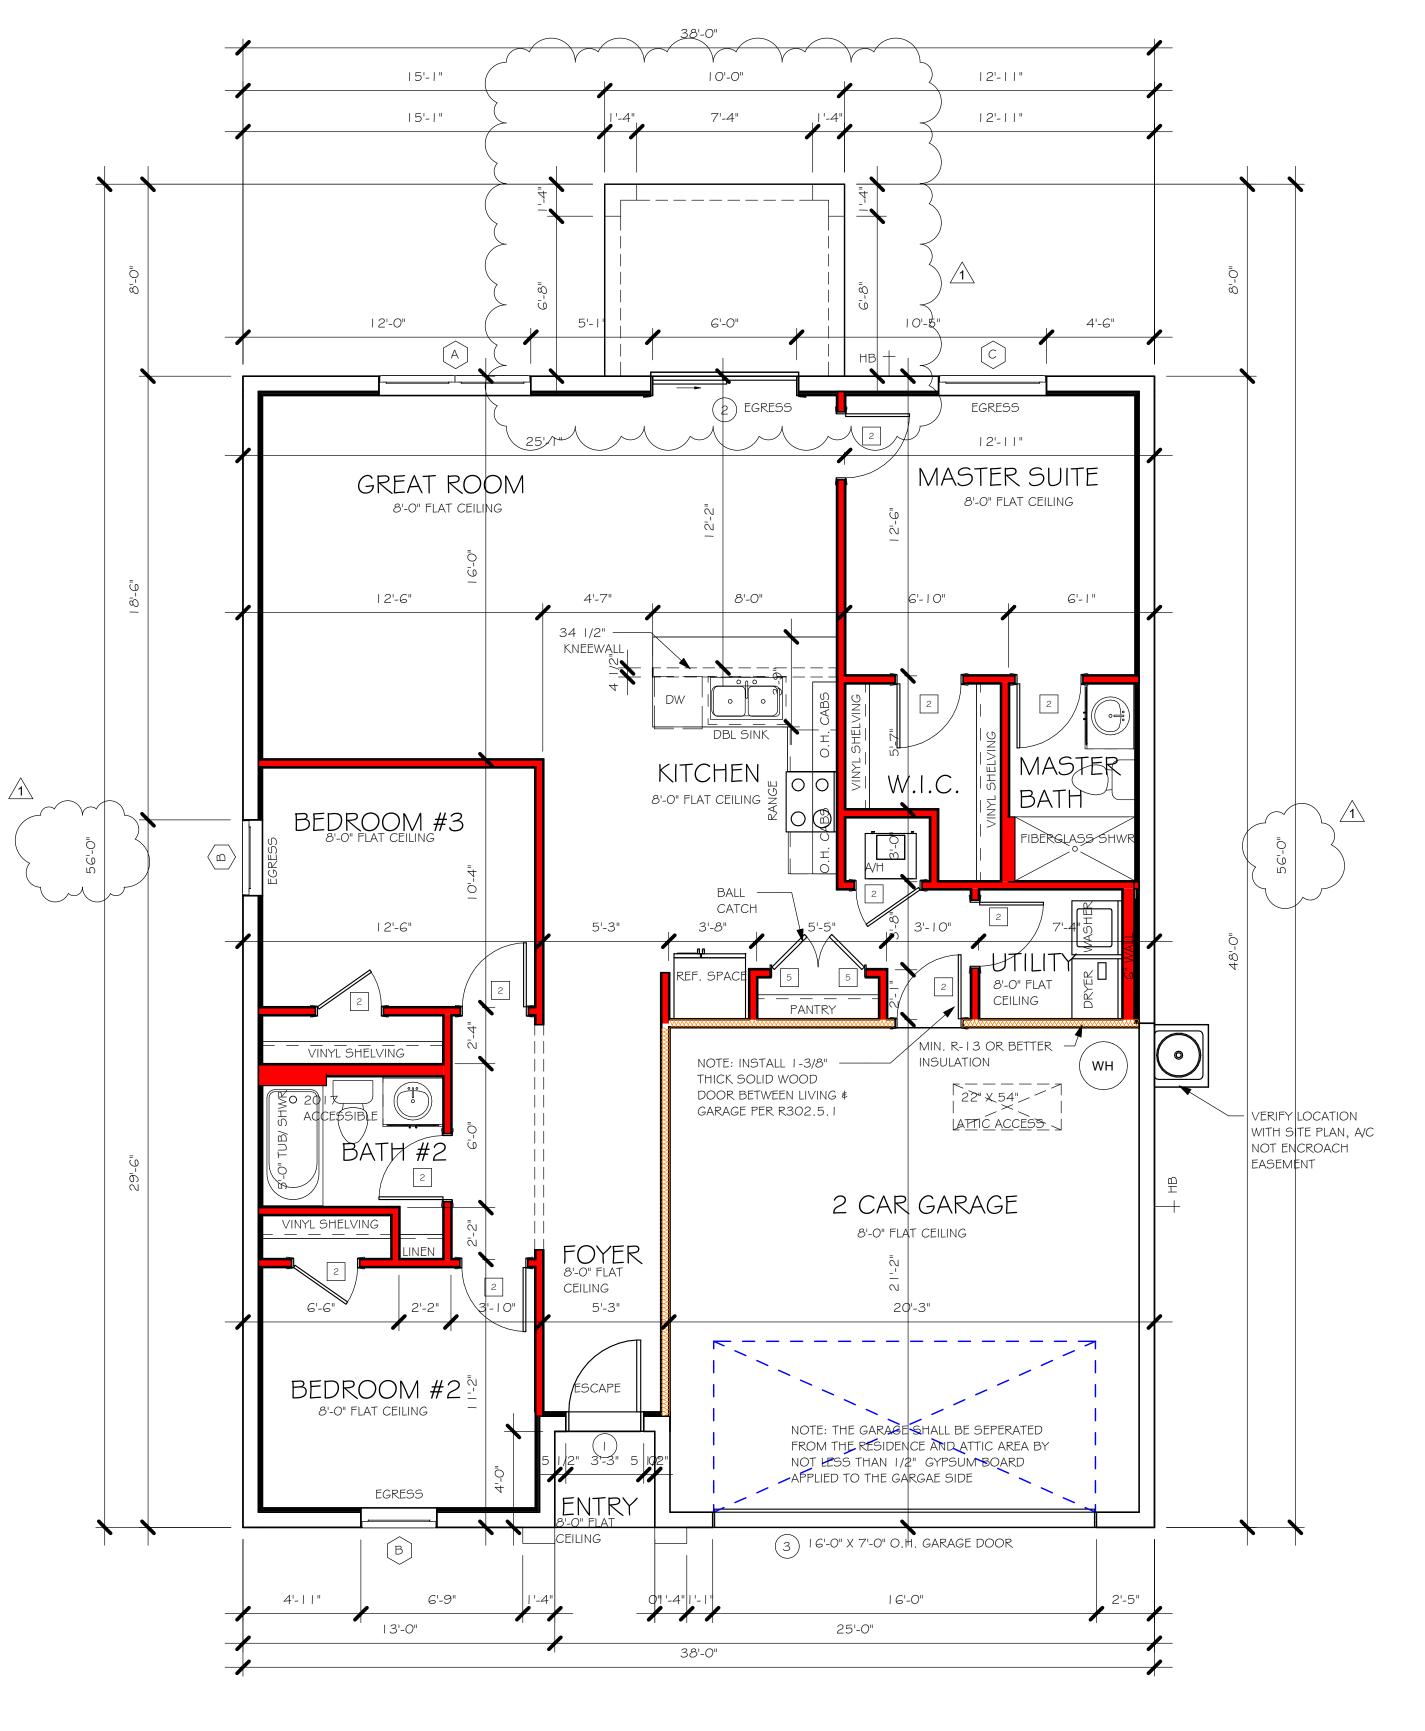

FLOOR PLAN 1/4" = 1'-0"

No.	Description	Date
1	COMPLETE MODEL CHANGE FROM 1389 BR TO A 1389 BR WITH	02/07/20
	EXT LANAI /CHANGED STRAPPING	
	FROM USP TO SIMPSON STONG	

DESIGN IN ACCORDANCE WITH THE RESIDENTIAL FLORIDA BUILDING CODE 2017 - 6TH EDITION

DATE:

DRAWN BY:

CHECKED BY:

REVISED:

PLAN:


SCALE:

10/17/19

02/07/20

FLOOR

As indicated

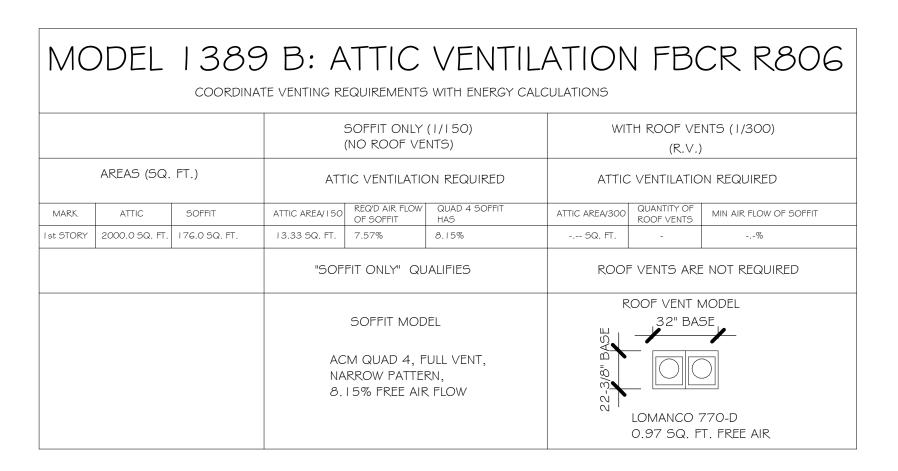

BEARING HEIGHT

= BEARING @ 8'-0"

 $\frac{\text{ROOF PLAN}}{1/4" = 1'-0"}$

FOYER

8'-0" FLAT

CEILING

BEDROOK

No.	Description	Date	
I	COMPLETE MODEL CHANGE FROM 1389 BR TO A 1389 BR WITH EXT LANAI /CHANGED STRAPPING	02/07/20	
	FROM USP TO SIMPSON STONG TIE		

2 CAR GARAGE

DESIGN IN ACCORDANCE WITH THE RESIDENTIAL FLORIDA BUILDING CODE 2017 - 6TH EDITION

	BLOCK: 5703	E SPOT LOTS	CE		
	LOT: 37-38	SUBDIVISION: GATOR CIRCLE SPOT LOTS	ADDRS: 3820 NE 10TH PLACE	D.R.H. #: 579560121	
	IAOON	<u> </u>	# - 382 カ	GCD JOB # 11283	
	DATE	<u>:</u> :	I O/ I	7/19	
	DRAI	WN BY:	JS	SL	
	CHEC	CKED B	Y: JW	′C	
	REVI:)2/07/2	0	
	PLAN		ROC)F	
	SCAI		s ındıca	ted	
٩L		А	4		

LEX RECEPTACLE AT ELEV. A.F.F. LEX RECEPTACLE - ABOVE COUNTER GLE POLE SWITCH
GLE POLE SWITCH
AY SWITCH
MER SWITCH
FION SENSOR SWITCH
OC SMOKE DETECTOR BE INTERCONNECTED RESIDENT HAVING A FOSSIL-BURNING TER OR APPLIANCE, A FIREPLACE, OR ATTACHED GARAGE SHALL HAVE AN RATIONAL CARBON MONOXIDE ALARN TALLED WITHIN 10 FEET OF EACH DM USED FOR SLEEPING PERPOSES. RULE 9B-3.04.72 (SMOKE DETECTOR) O (CARBON MONOXIDE/ SMOKE ECTOR)
PHONE OUTLET
EVISION RECEPTION OUTLET
FACE MOUNTED CEILING LIGHT
6H MOUNTED LIGHT
L MTD. BRACKET LIGHT
LEX FLOOD LIGHT
AUST FAN
CK MTD. LIGHTS
DISCONNECT
H BUTTON (PB) / DOOR BELL (DB)
RCOM
^AD
4' FLUORESCENT LIGHT
2' UNDER COUNTER LIGHT
ES: UIT-INTERRUPTERS AND TAMPER PTACLES SHALL BE INSTALLED TS PER N.E.C 210.12 AND 406.11 ECTRICAL EQUIPMENT AND APPLIANCES TO BE SET AT FLOOD ELEVATION PLUS 1'-0" FREEBOARD.
JI P TS

EXTERIOR OUTLETS TO BE GFI'S.

INSTALL PHONE AND T.V PER CONTRACT.

INSTALL ALL ELECTRICAL PER NEC 2014

ELECTRICAL LEGEND

ELECTRICAL METER

I 20 V JUNCTION BOX

SINGLE RECEPTACLE OUTLET

220 V RECEPTACLE OUTLET

4-PLEX RECEPTACLE OUTLET


DUPLEX RECEPTACLE OUTLET


1/2 SWITCHED DUPLEX OUTLET

ELECTRICAL PANEL

ELECTRICAL PLAN 1389

LLLCIRIC	AL FLAN 1309	
AMP SERVICE		
QUANTITY	PRODUCT	
(X)	(FLUSH MOUNTED LT)	
(X)	(VAPORS)	
(X)	(PENDANT LIGHT	
(10)	(10" MUSHROOMS)	
(2)	(24" 3 LT)	
(X)	(36" 4 LT)	
(X)	(NOT USED)	
(2)	(COACH LIGHTS)	
(X)	(COACH LIGHTS)	
(X)	(J BOX)	
(1)	(4' FLUORESCENT)	
(X)	(2' FLUORESCENT)	
(X)	(5LT CHANDELIER)	
(X)	(3 LT)	
(X)	(PENDANT/ NOOK)	
(X)	(X)	
(X)	(X)	
	AMP SERVICE QUANTITY (X) (X) (X) (IO) (2) (X) (X) (2) (X) (X) (1) (X) (X) (X) (X) (X) (X) (X) (X) (X) (X	QUANTITY PRODUCT (X) (FLUSH MOUNTED LT) (X) (VAPORS) (X) (PENDANT LIGHT (10) (10" MUSHROOMS) (2) (24" 3 LT) (X) (36" 4 LT) (X) (NOT USED) (2) (COACH LIGHTS) (X) (J BOX) (1) (4' FLUORESCENT) (X) (2' FLUORESCENT) (X) (5LT CHANDELIER) (X) (3 LT) (X) (PENDANT/ NOOK) (X) (X)

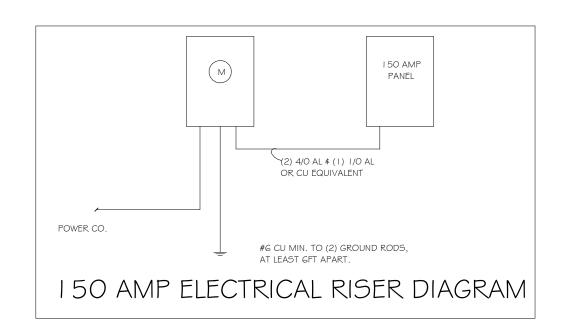

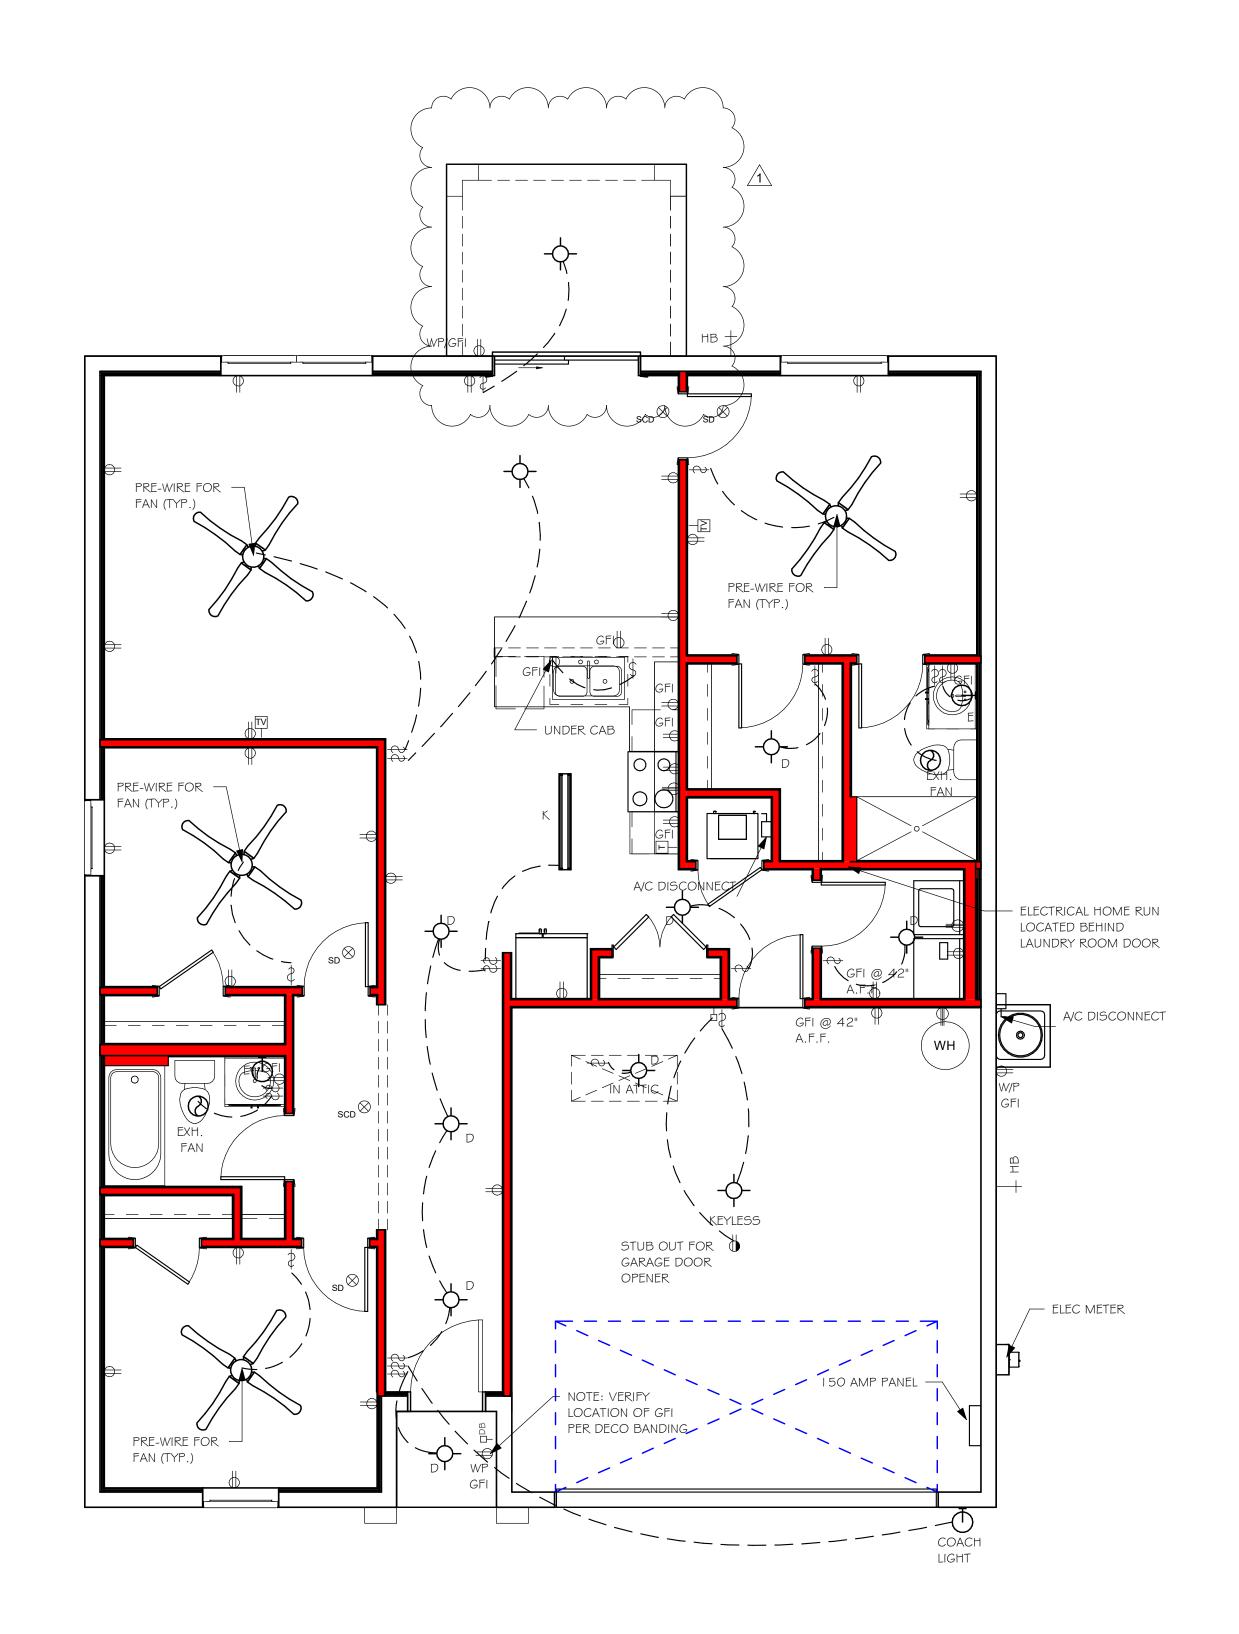

No.	Description	Date
	COMPLETE MODEL CHANGE FROM I 389 BR TO A I 389 BR WITH EXT LANAI /CHANGED STRAPPING FROM USP TO SIMPSON STONG TIE	02/07/20

DESIGN IN ACCORDANCE WITH THE RESIDENTIAL FLORIDA BUILDING CODE 2017 - 6TH EDITION

REVISED: 02/07/20 PLAN: ELECTRIC As indicated


10/17/19


SCALE:


DATE:

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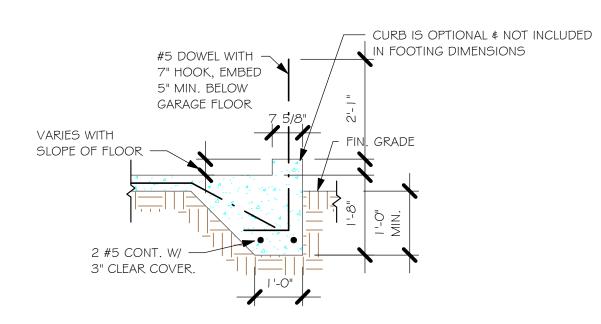
CHECKED BY:



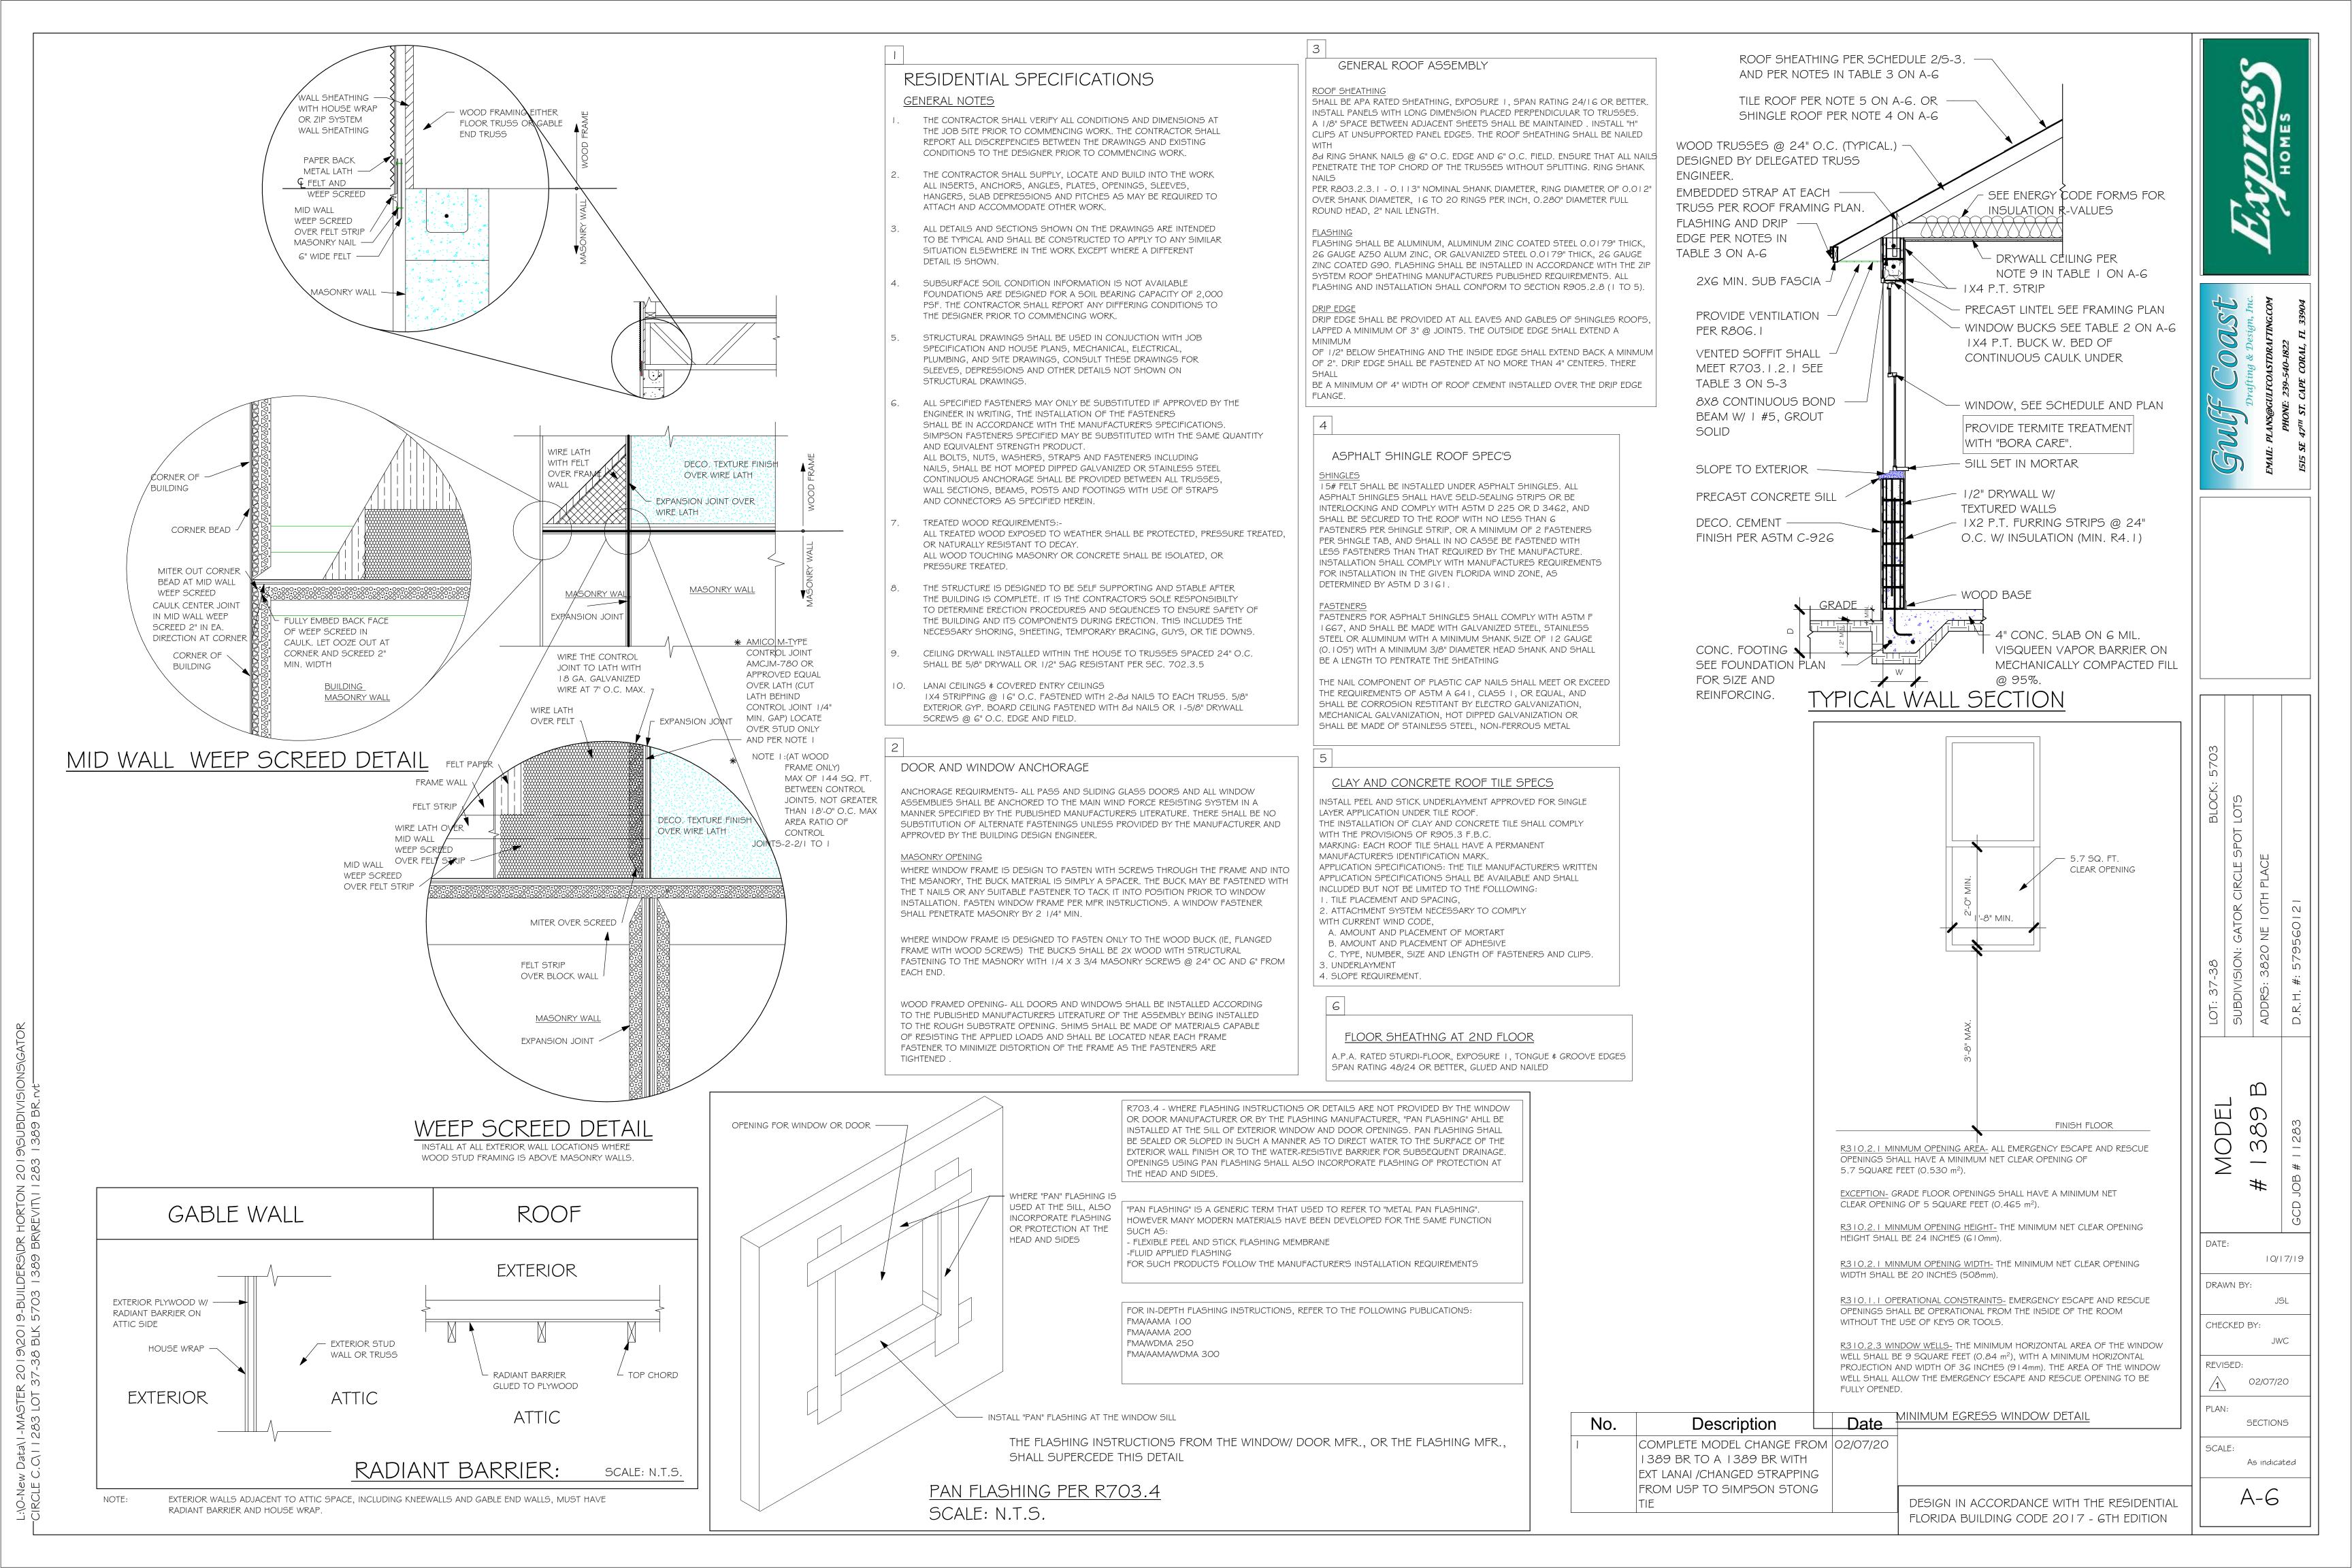


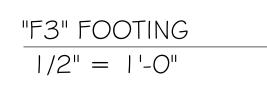

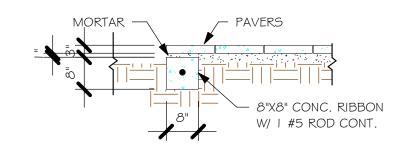
 $\frac{\text{"P" PAVERS DETAIL ENTRY/ LANAI}}{1/2" = 1'-0"}$



"F3" WITH CURB AT GARAGE 1/2" = 1'-0"

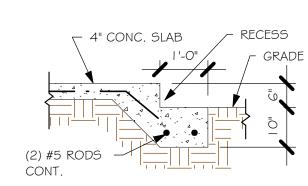

 $\frac{\text{GARAGE DOOR RECESS}}{1/2" = 1'-0"}$

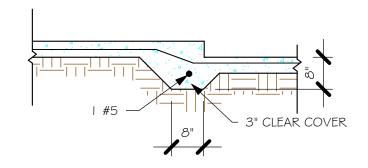

 $\frac{\text{"F6A" STEP DOWN}}{1/2\text{"} = 1\text{'-0"}}$

		E					
ڃ	!				вотт	OM REINF.	
LI CE	TYPE	LENGTH	WIDTH	DEPTH	LONG WAY	SHORT WAY	REMARKS
\rangle	$\langle \mathbf{A} \rangle$	2'-6"	2'-6"	1'-0"	3-#5	3-#5	-
	B	3'-0"	3'-0"	1'-0"	4-#5	4-#5	-
	(C)	3'-6"	3'-6"	1'-0"	4-#5	4-#5	-
	(D)	4'-0"	4'-0"	1'-2"	5-#5	5-#5	-
	(E)	5'-0"	5'-0"	1'-2"	6-#5	6-#5	-


USED	TYPE	LENGTH	WIDTH	DEPTH	BOTTOM REINFORCING	SHAPE	
	F1	CONT.	1'-4"	0'-8"	2-#5		
	F2	CONT.	1'-8"	0'-10"	2-#5		
X	F3	CONT.	1'-0"	1'-8"	2-#5	₩	GARAC DETAIL
	F4	CONT.	1'-4"	1'-8"	2-#5		ובותו
	F5	CONT.	1'-4"	1'-0"	2-#5	-	
	F6	CONT.	1'-4"	1'-0"	2-#5		
X	F6A	CONT.	0'-8"	0'-8"	1-#5		
	TE	CONT.	0'-8"	0'-8"	1-#5	Ţ	

PROVIDE CORNER BARS PER 6/S-3



SCALE: 1/4" = 1'-0"

- PLAN NOTES:
 1. TOP OF GROUND FLOOR SLAB DATUM ELEVATION 0'-0"
- "F#" DENOTES CONTINUOUS WALL FOOTING TYPE PER SCHEDULE THIS SHEET.
- PROVIDE #5 VERTICAL REINFORCING AT DOT LOCATIONS SHOWN ON PLAN FROM FOOTING TO BOND BEAM.
- ALL DIMENSIONS ARE TO OUTSIDE FACE OF MASONRY WALLS. SOME SLAB EDGES MAY EXTEND BEYOND FACE OF WALL.
 FOR DIMENSIONS OF ROUGH OPENINGS IN MASONRY WALLS, COORDINATE WITH WINDOW/
- DOOR SUPPLIER.
 6. PROVIDE PRESSURE TREATED BUCKS AT WINDOWS/ DOORS PER DETAIL 7/S-3.

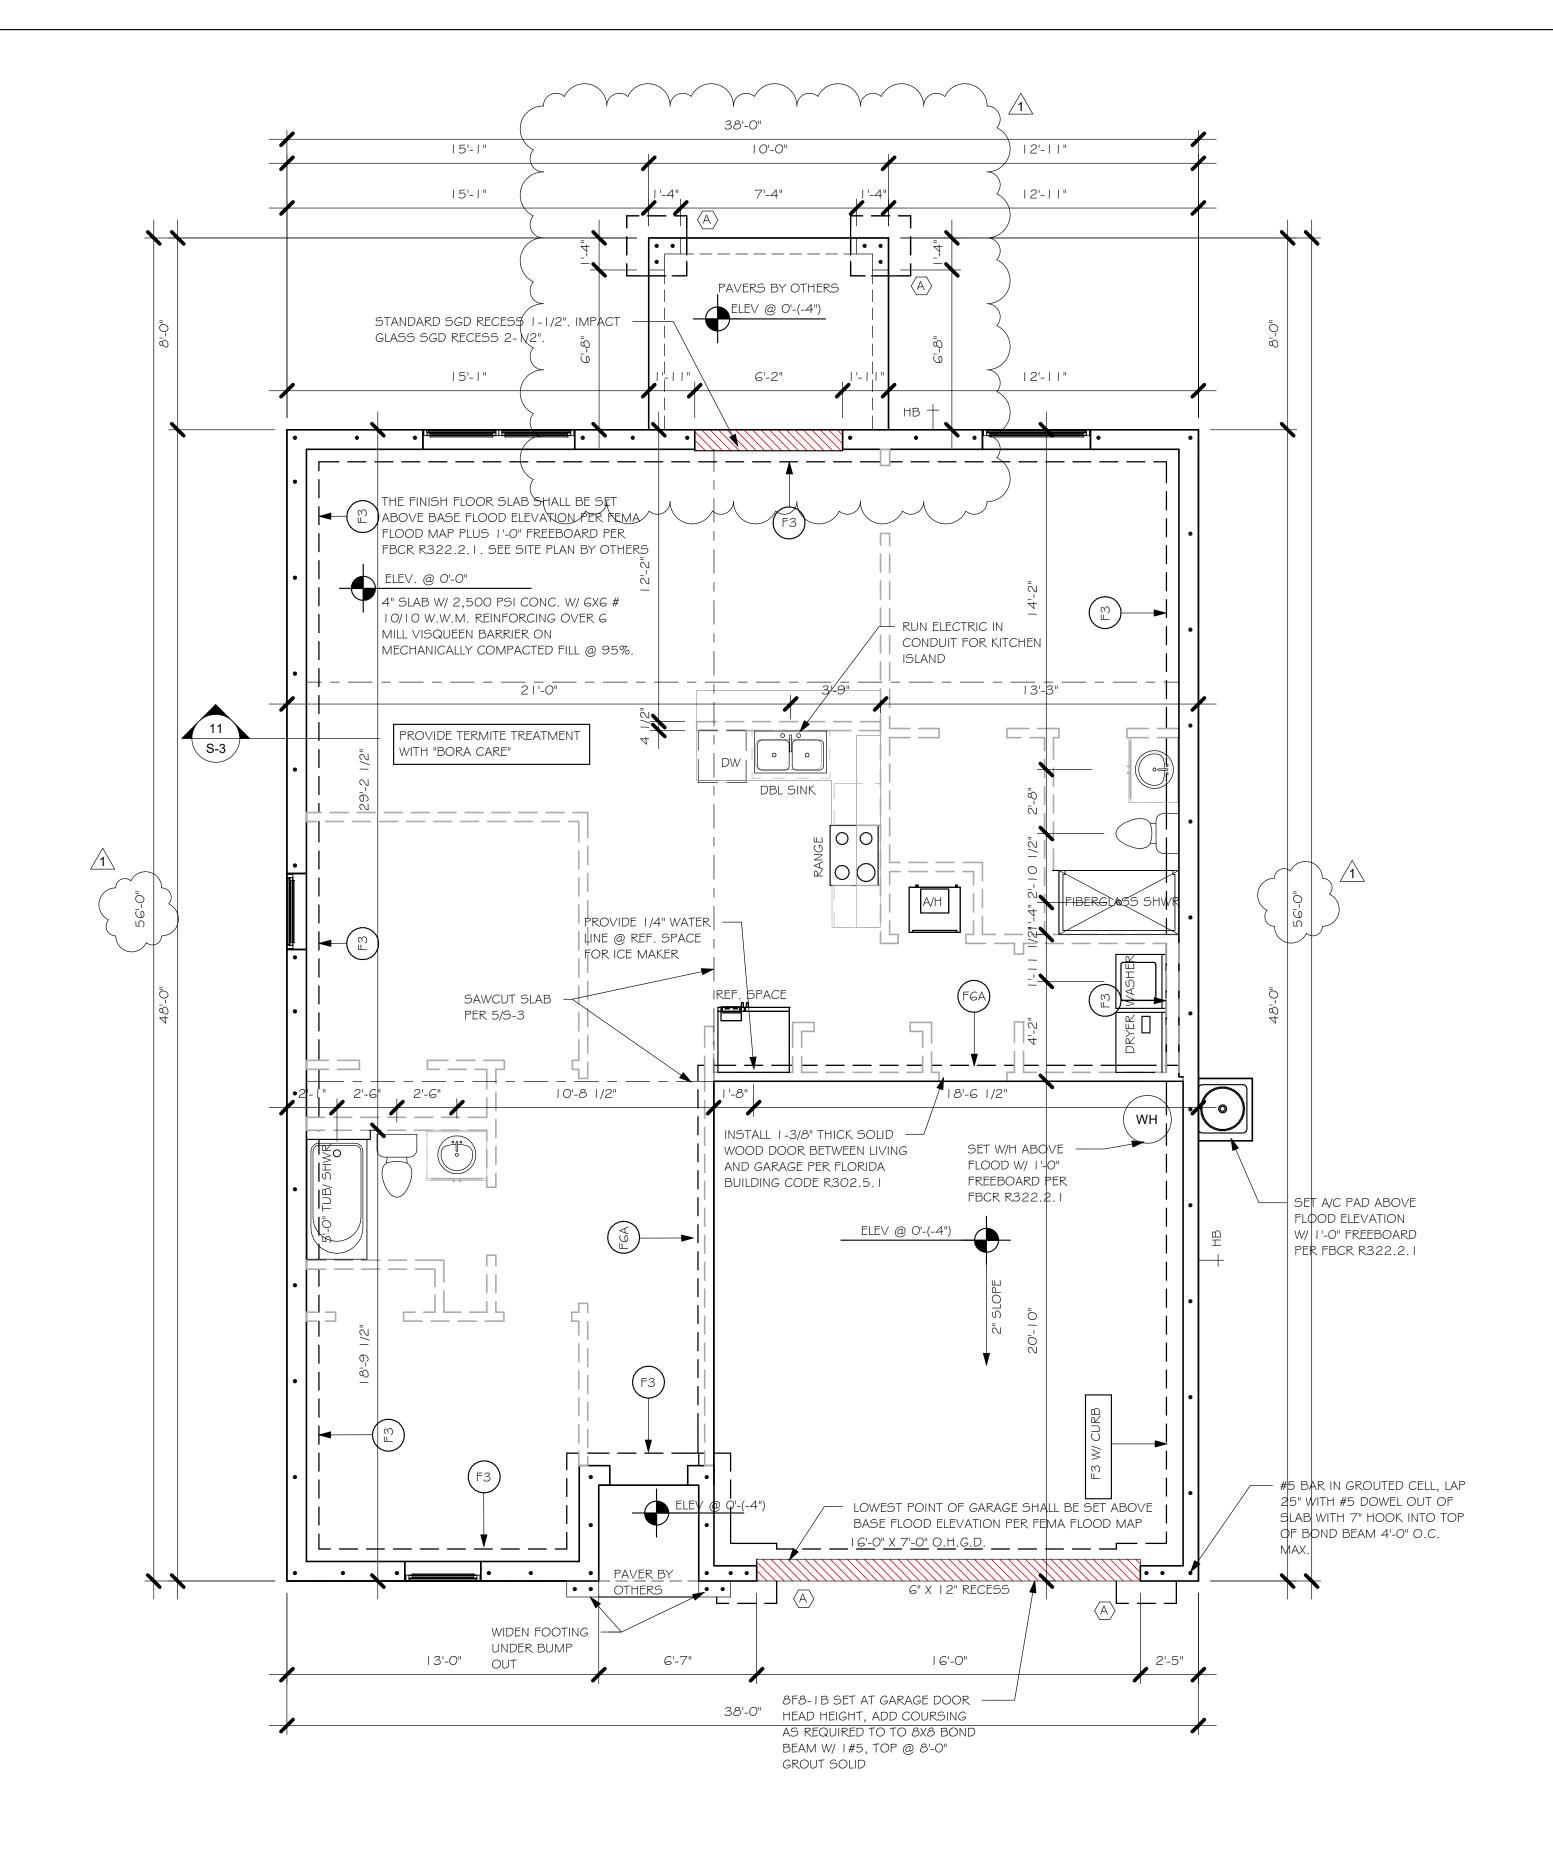

 $\frac{\text{FOUNDATION}}{1/4" = 1'-0"}$

Description	Date
COMPLETE MODEL CHANGE FROM I 389 BR TO A I 389 BR WITH EXT LANAI /CHANGED STRAPPING FROM USP TO SIMPSON STONG	02/07/20
	COMPLETE MODEL CHANGE FROM 1389 BR TO A 1389 BR WITH EXT LANAI /CHANGED STRAPPING

DESIGN IN ACCORDANCE WITH THE RESIDENTIAL FLORIDA BUILDING CODE 2017 - 6TH EDITION

DATE:

DRAWN BY:

CHECKED BY:

REVISED:

10/17/19


02/07/20

FOUNDATION PLAN

1. PROVIDE A STRAP FROM THE ABOVE LIST AT EACH ROOF TRUSS BEARING POINT, BASED ON THE TRUSS UPLIFT VALUES IN THE SIGNED AND SEALED TRUSS DESIGN PACKAGE AND

- SUITABLE FOR THE GEOMETRY. EMBED STRAP ON -C OF WALL. CONNECTORS ARE SIMPSON STRUCTURAL CONNECTORS. ALL CONNECTORS SHALL BE INSTALLED IN STRICT ACCORDANCE WITH SIMPSON PRINTED INSTUCTIONS.
- SUBSTITUTIONS MUST BE APPROVED IN WRITING BY THE ENGINEER OF RECORD. WHERE EMBEDDED STRAPS ARE MISSING, OR MIS-LOCATED, INSTALL RETROFIT STRAP PER 10/5-3.

R4-021020

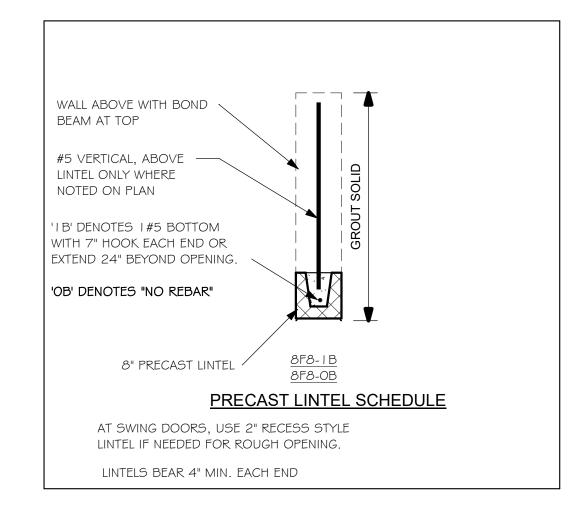


PLAN NOTES:


- ROOF TRUSS BEARING @ 8'-0".
- ROOF FRAMING SHALL BE WOOD TRUSSES DESIGNED BYA DELEGATED TRUSS ENGINEER PER DESIGN CRITERIA ON SHEET S-3.
- PROVIDE STRAPPING AT TRUSSES PER NOTES ON THIS SHEET.
- FOR NAILING OF ROOF AND FLOOR DECK, SEE | AND 2 ON S-3.
- 8F8-1B etc., DENOTES PRECAST LINTEL ABOVE
- DOORWINDOW OPENING PER SCHEDULE THIS SHEET. AT TRUSS BEARING, PROVIDE 8x8 MASONRY BOND BEAM W/ I #5 CONTINUOUS, SEE DETAIL I I/S-3.

BEARING HEIGHT

= BEARING @ 8'-0"

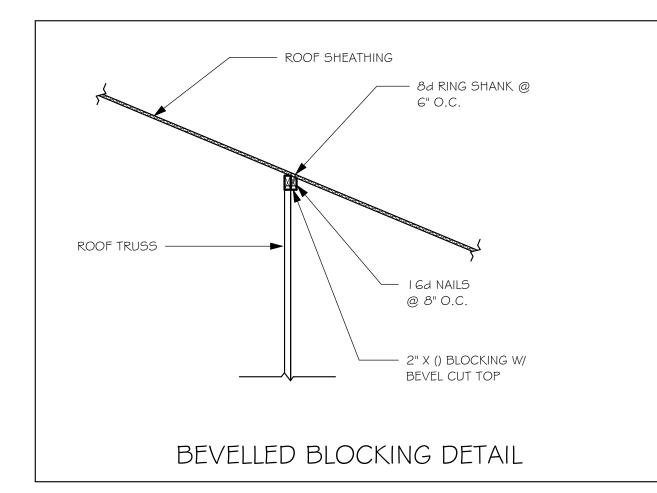

TRUSS BEARING CONDITIONS AND STRAPPING IS BASED ON TRUSS LAYOUT PREPARED BY SCOSTA JOB#: 44115BL DATED: 12/12/19 REVISED: NONE

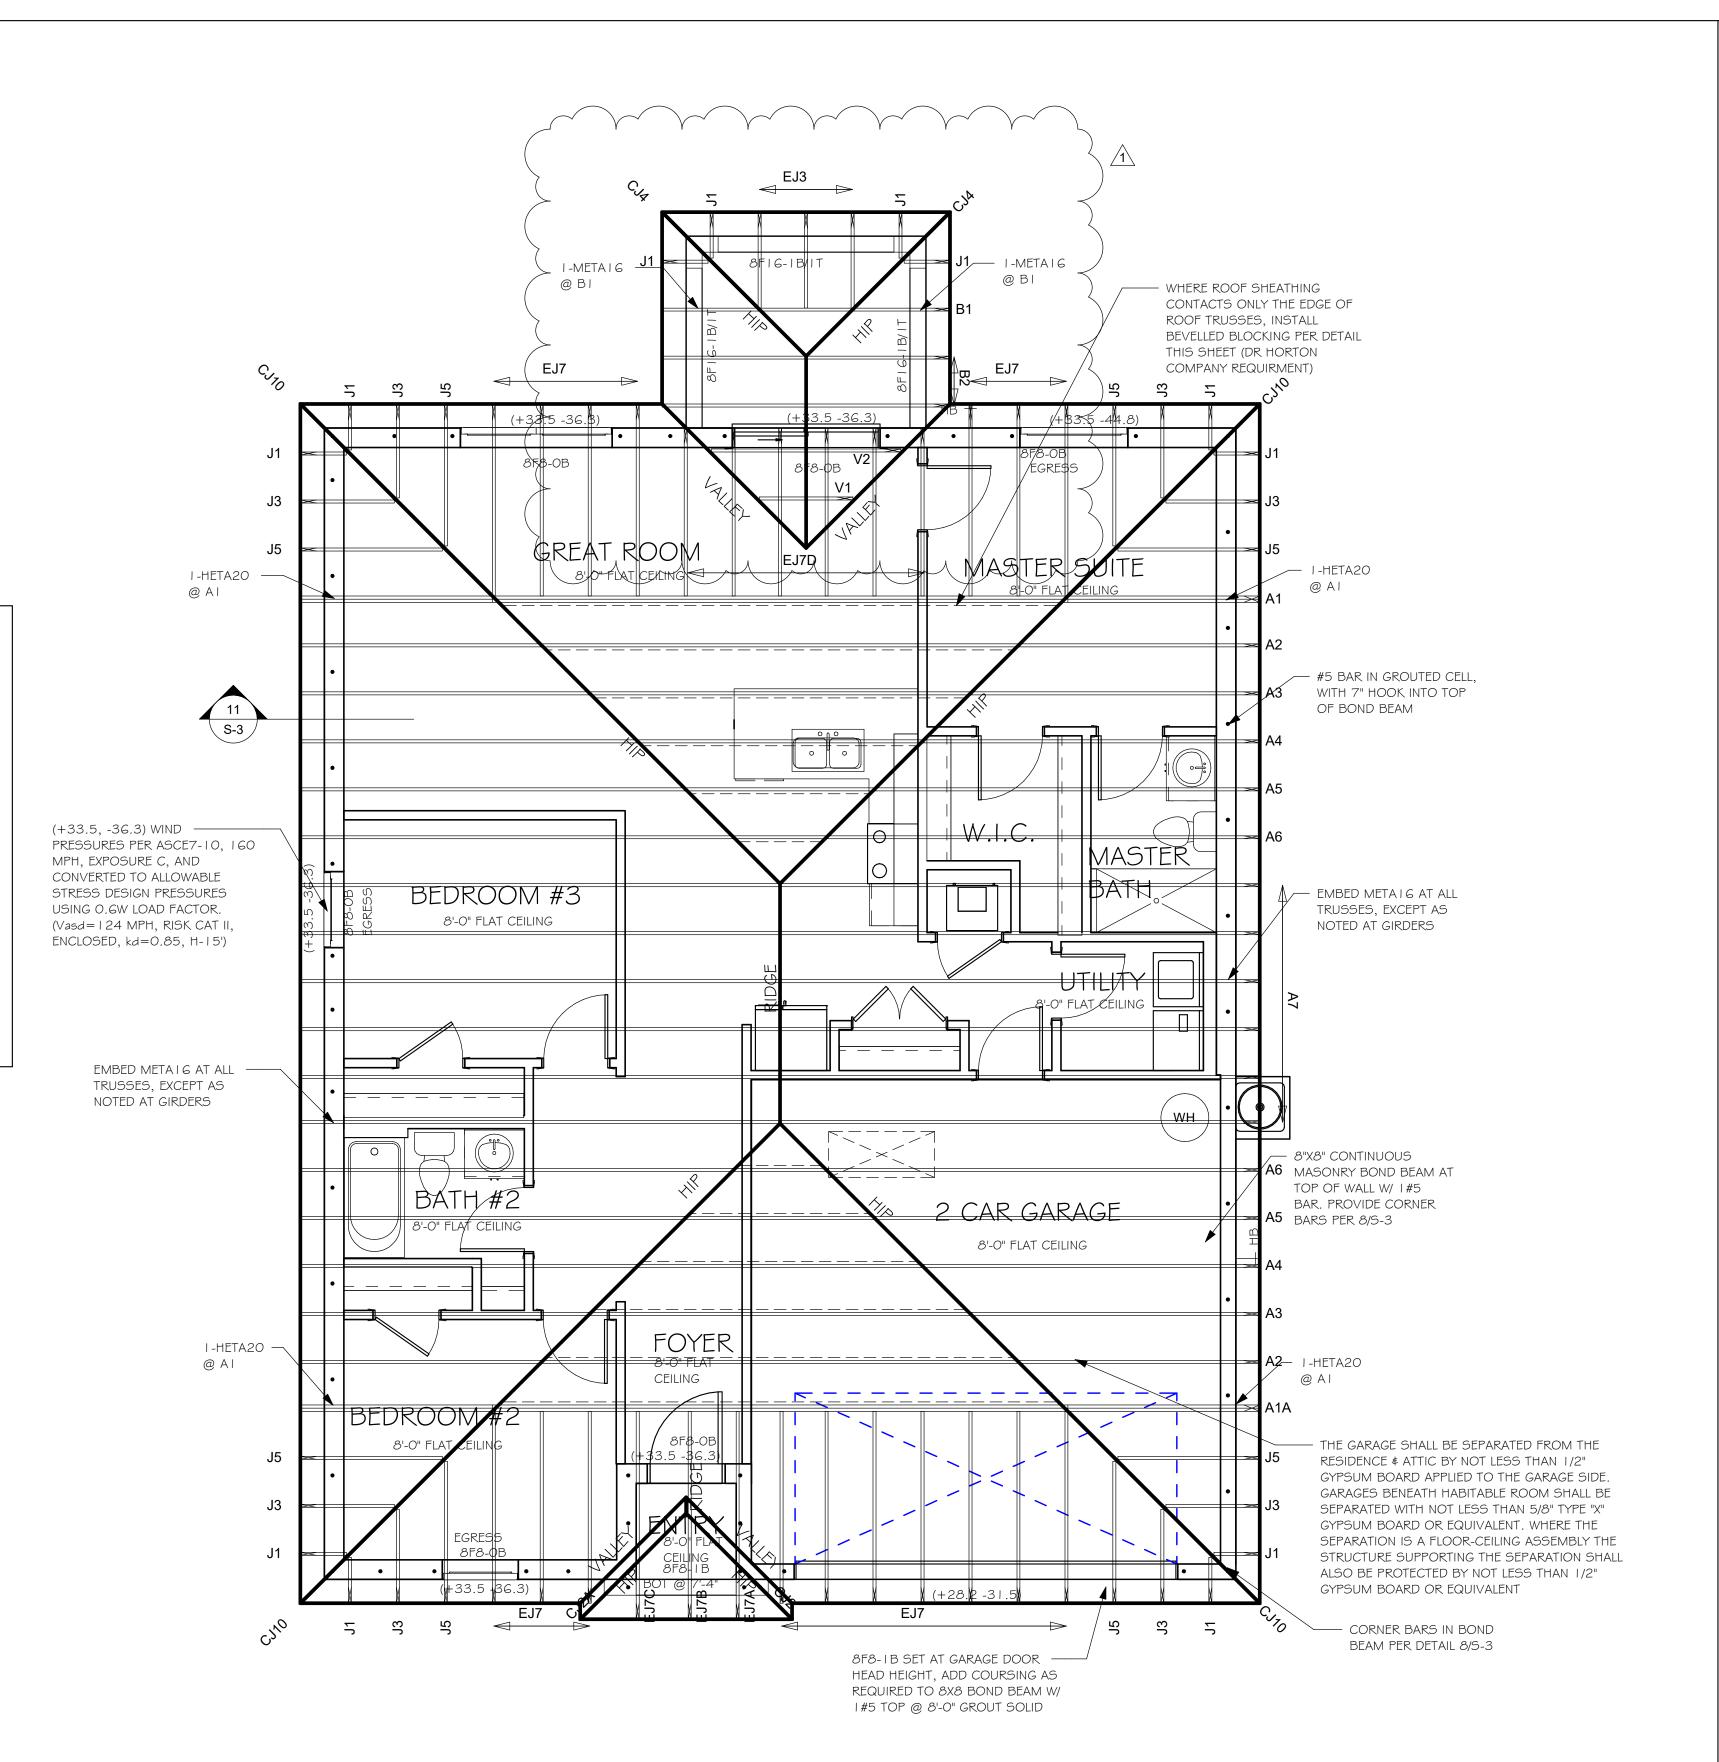

ROOF FRAMING PLAN 1/4" = 1'-0"

No.	Description	Date
	COMPLETE MODEL CHANGE FROM 1389 BR TO A 1389 BR WITH EXT LANAI /CHANGED STRAPPING	02/07/20
	FROM USP TO SIMPSON STONG TIE	

DESIGN IN ACCORDANCE WITH THE RESIDENTIAL FLORIDA BUILDING CODE 2017 - 6TH EDITION

DRAWN BY: JSL CHECKED BY: JWC REVISED: 02/07/20 ROOF FRAMING PLAN SCALE: As indicated

10/17/19

STRUCTURAL SYSTEMS OF NORTH FLORIDA 1634 SE. 47th ST SUITE #3 CAPE CIRAL, FL 33904 <239> 549-4554

/ISION: GATOR CIRCLE SF : 3820 NE IOTH PLACE

MODI

DATE:

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