

		OOR SC	HEDUL	E_E		
TYPE			COMMENT			
MARK	DESCRIPTION	MANUFACTURER	S	Width	Height	QTY
		•			•	
1	3080 ENTRY	DISTINCTION		3'-0"	8'-0"	1
2	16080 OHGD	GARAGE DOOR		16'-0"	8'-0"	1
3	8080 OHGD	GARAGE DOOR		8'-0"	8'-0"	1
4	(3)-4080 SL. GL. DR.			12'-0"	8'-0"	1
5	2880 ENTRY	DISTINCTION		2'-8"	8'-0"	1
•	•	•	•	•	•	

		WINDO	W SCH	HEDULE		
MARK	DESCRIPTION	MANUFACTURER	WIDTH	HEIGHT	COMMENTS	QTY
Α	2-35 SH		9'-0"	5'-3"		2
В	48" X 16"	FIXED GLASS	4'-2"	3'-4"		1
С	1/2 33 SH		2'-2"	3'-2"		2
D	25 SH		3'-2"	5'-3"		3
E	2-25 SH		6'-4"	5'-3"		1
F	2-26 SH		6'-4"	6'-4"		1

OPT IMPACT GLASS MAY BE INSTALLED IN LIEU OF SHUTTERS VERIFY W/ CONTRACT

DOOR HEADERS					
6'-8" BI-FOLD	HEADER HEIGHT	82" A.F.F.			
6'-8" SWING	HEADER HEIGHT	82 I/2" A.F.F.			
8'-0" SWING	HEADER HEIGHT	98 1/2" A.F.F.			

PLAN NOTES

- VERIFY ALL ROUGH OPENING DIMENSIONS FOR ALL WINDOWS AND DOORS
- PROVIDE SAFETY GLAZING WITHIN 24" FROM EXIT PER FLORIDA BUILDING CODE R 308.4.2.
- PROVIDE SAFETY GLAZING AT BATH/ SHOWER PER FLORIDA BUILDING CODE R 308.4.5.
- NON BEARING INTERIOR FRAME WALLS SHALL BE FRAMED W/ WOOD OR METAL STUDS. SPACING SHALL NOT EXCEED 24" O.C. (NON BEARING WALLS ONLY)
- PROVIDE DEAD WOOD IN ATTIC FOR OVERHEAD GARAGE DOOR HARDWARE
- G) KITCHEN KNEE WALL TO BE FRAMED W/ TOP @ 34 I/2" A.F.F.
- INSTALL SMOOTH WALLS IN KITCHEN AND ALL

RESISTANT PER SEC. 702.3.5

BATHROOM AREAS

- WHERE DRYWALL CEILING IS APPLIED TO TRUSSES @ 24" O.C. USE 5/8" DRYWALL OR 1/2" SAG
- THE GARAGE SHALL BE SEPARATED FROM THE RESIDENCE & ATTIC BY NOT LESS THEN 1/2" GYPSUM BOARD APPLIED TO THE GARAGE SIDE. GARAGES BENEATH HABITABLE ROOMS SHALL BE SEPARATED WITH NOT LESS THAN 5/8" TYPE "X" GYPSUM BOARD OR EQUIVALENT. WHERE THE SEPARATIION IS A FLOOR - CEILING ASSEMBLY, THE STRUCTURE SUPPORTING THE SEPARTION SHALL ALSO BE PROTECTED BY NOT LESS THAN 1/2" GYPSOM BOARD OR EQUIVALENT
- INSTALL I 3/8" THICK SOLID WOOD DOOR BETWEEN LIVING AND GARAGE PER FLORIDA BUILDING CODE
- 11) ALL WINDOWS INSTALLED 72" ABOVE GRADE MUST COMPLY WITH RG | 2.2 MIN 24" SILL HEIGHT OR PROVIDED WITH AN APPROVED WINDOW FALL PRVENTION DEVICE
- ALL CLOSET SHELVES TO BE 12". ALL PANTRY \$ LINEN TO BE (4)-16" SHELVES 18" O.F.F. W/ 15" INCREMENT.
- ALL MECHANICAL AND ELECTRICAL EQUIPMENT TO BE INSTALLED AT OR ABOVE FLOOD PLUS 1'-0" FREEBOARD.

CABINET BACKING					
KITCHEN	UPPER TOP @ 84"	BASE TOP @ 35"			
MASTER BATH	UPPER	BASE TOP @ 35"			
GUEST BATH	UPPER	BASE TOP @ 31"			
LAUNDRY ROOM	UPPER TOP @ 84"	BASE			


	BATHROOM NOTES
TB TOWEL BAR	ALL TUB DECKS @ 21" A.F.F
TP TOILET PAPER	ALL BLOCKING TO BE PT IN SHOWERS
10-4 10-4	TOWEL BAR TOILET PAPER ROLL TOILET PAPER ROLL


INTERIOR DOOR SCHEDULE					
MARK	DOOR WIDTH	NOTES			
	3'-0"	P.K. = POCKET DOOR			
2	2'-10"	B.F. = BI-FOLD DOOR			
3	2'-8"	D.1 DI-1 OLD DOOK			
4	2'-6"	B.P. = BI-PASS DOOR			
5	2'-4"	L.V. = LOUVERED DOOR			
6	2'-0"				
7	1'-8"				
8	1'-6"				

CABINET BACKING					
KITCHEN	UPPER TOP @ 84"	BASE TOP @ 35"			
MASTER BATH	UPPER	BASE TOP @ 35"			
GUEST BATH	UPPER	BASE TOP @ 31"			
LAUNDRY ROOM	UPPER TOP @ 84"	BASE			

SQUARE	FOOTAGE

LIVING AREA	2416 SF
LANAI AREA	211 SF
GARAGE AREA	604 SF
ENTRY AREA	98 SF
TOTAL AREA	3329 SF

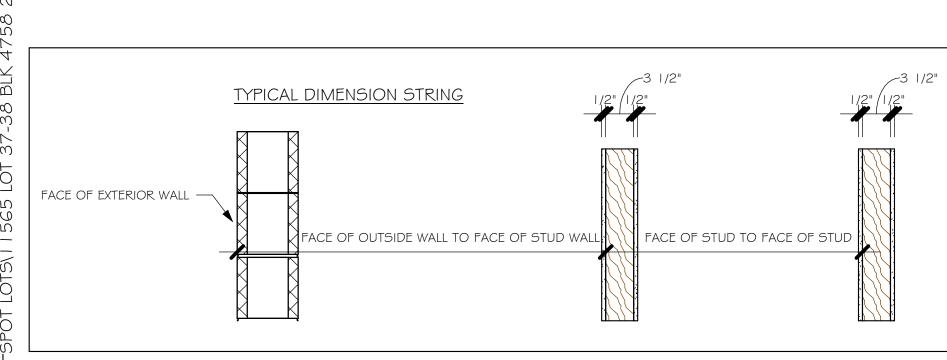

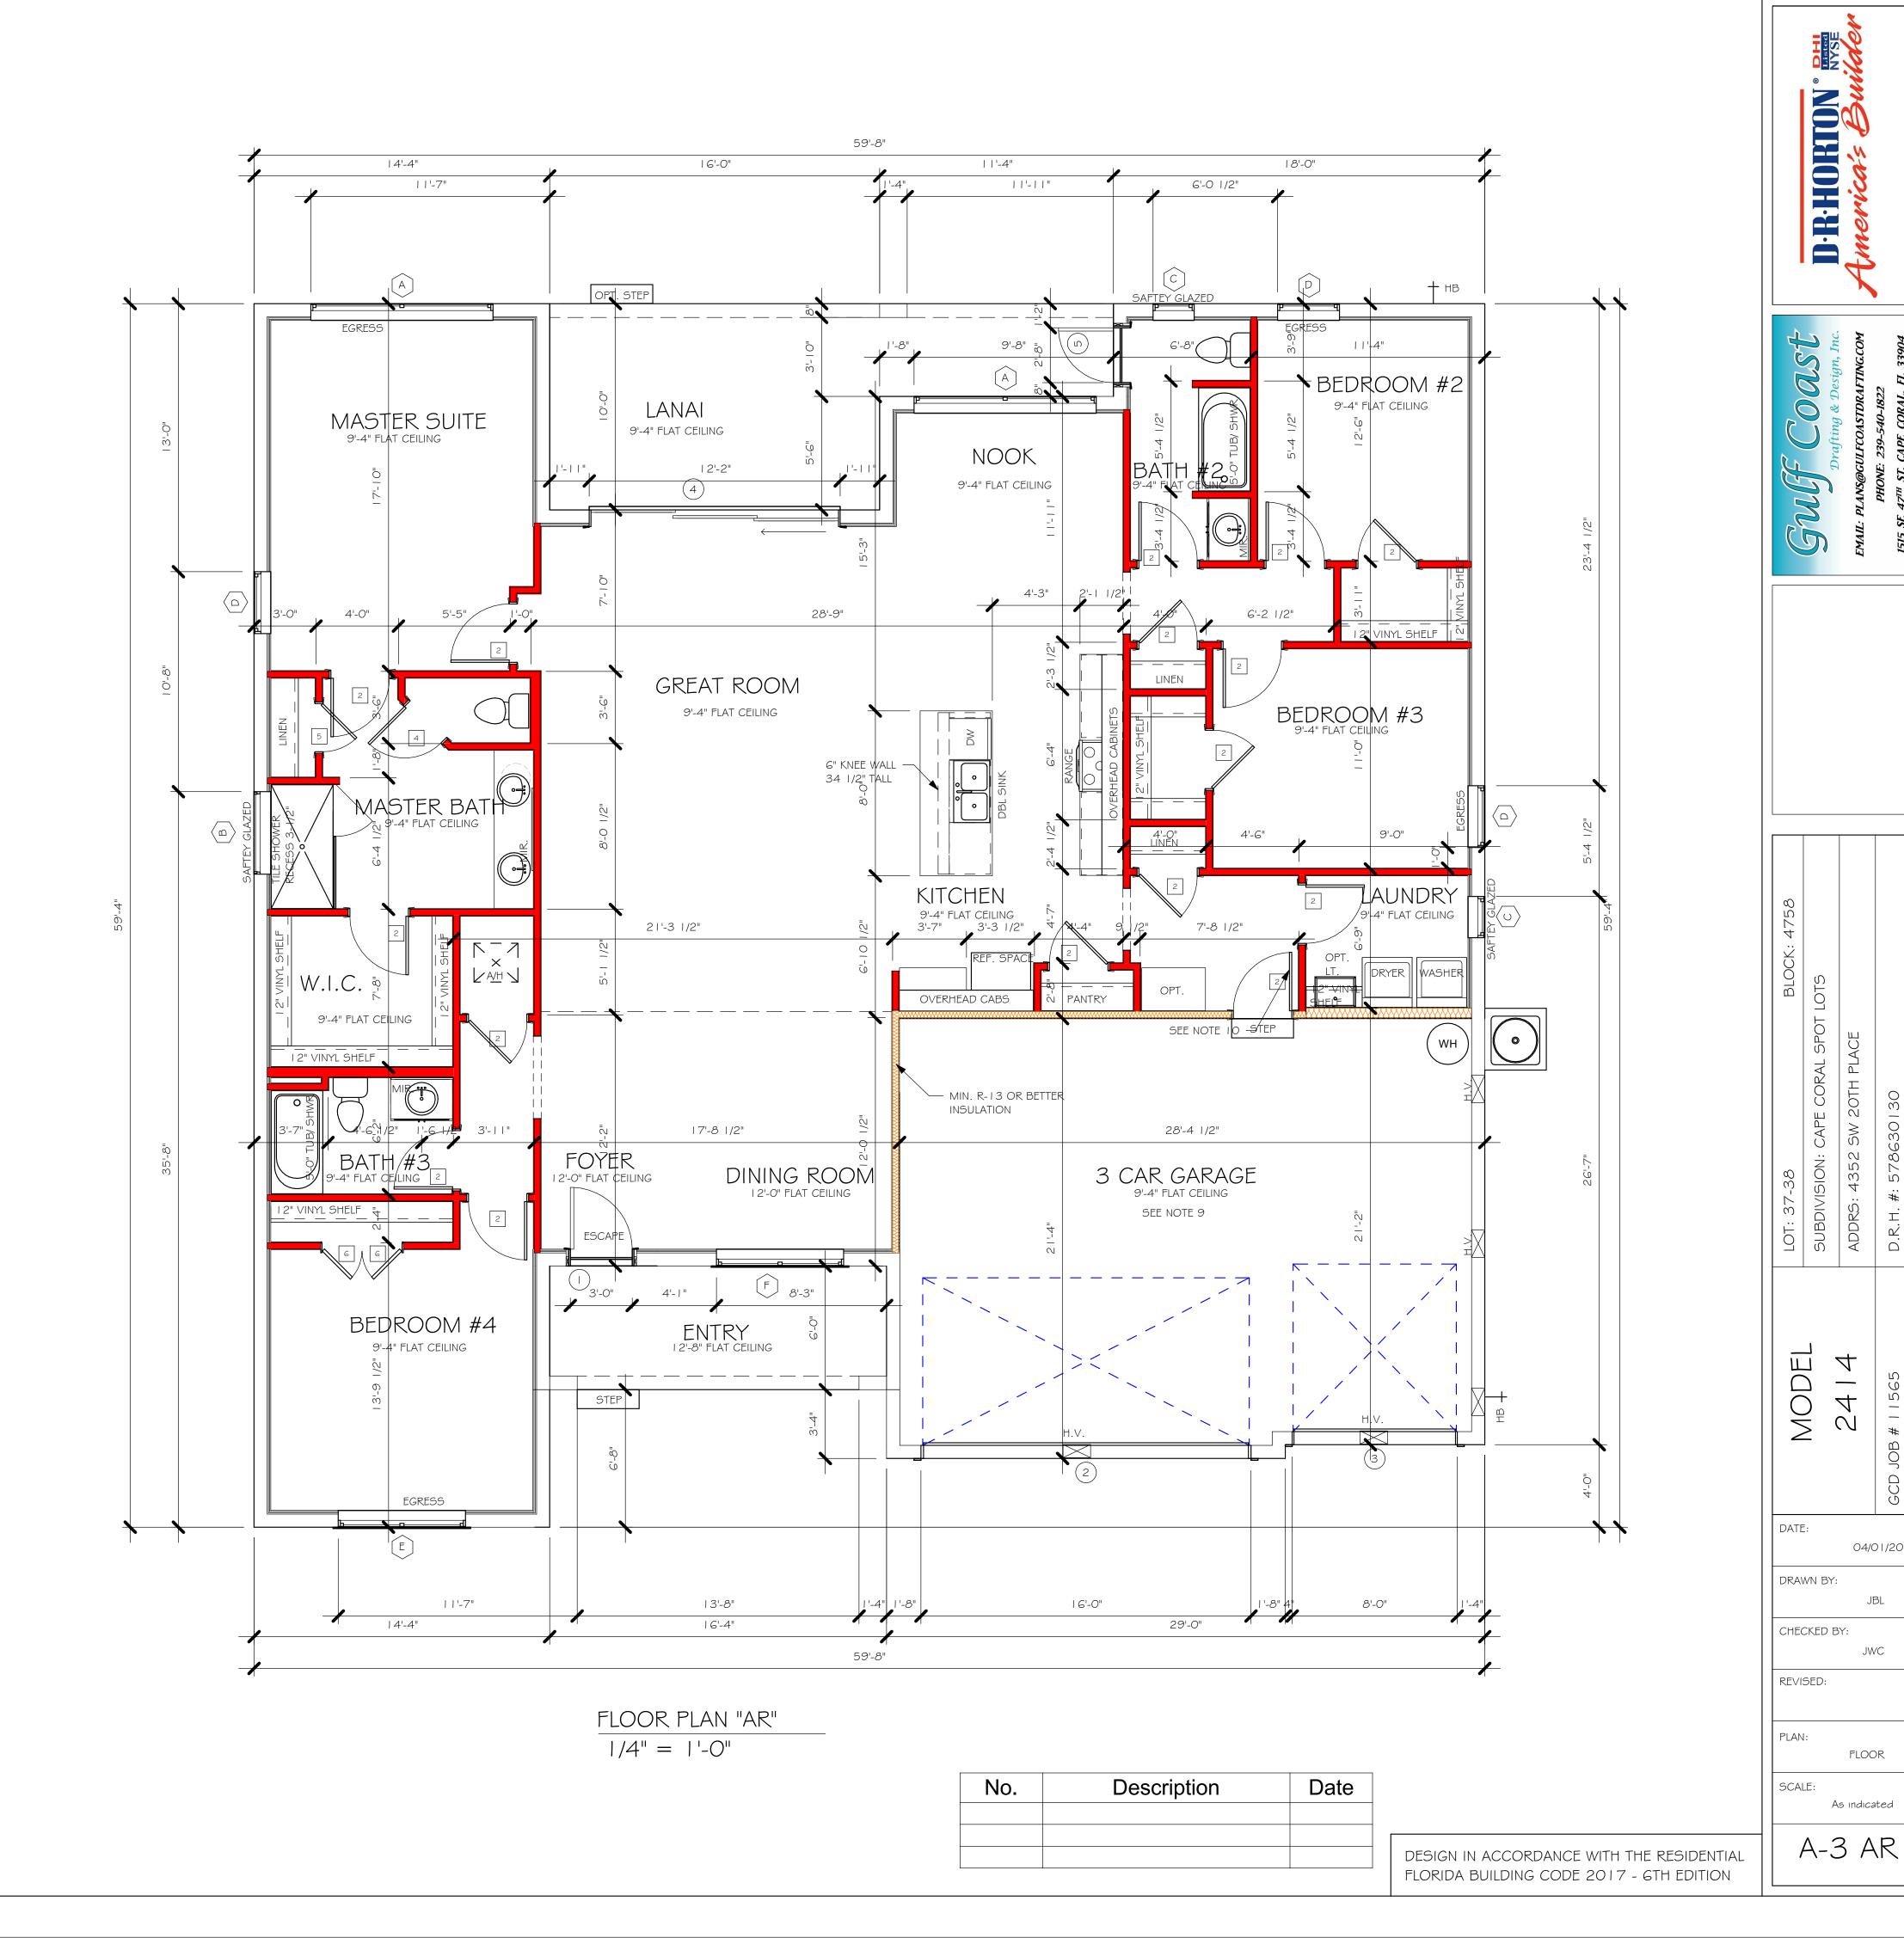

04/01/20

JWC

FLOOR

04/01/20 DRAWN BY: CHECKED BY: JWC

REVISED:

DATE:


PLAN: ROOF SCALE: As indicated

A-4 AR DESIGN IN ACCORDANCE WITH THE RESIDENTIAL FLORIDA BUILDING CODE 2017 - 6TH EDITION

MODEL 24 | 4 A: ATTIC VENTILATION FBCR R806

COORDINATE VENTING REQUIREMENTS WITH ENERGY CALCULATIONS

				SOFFIT ONLY (NO ROOF VE		WIT	TH ROOF VE (R.V.)	NTS (1/300))
	AREAS (SQ.	FT.)	ATT	IC VENTILATION	ON REQUIRED	ATTIC	C VENTILATIC	ON REQUIRED
MARK	ATTIC	SOFFIT	ATTIC AREA/150	REQ'D AIR FLOW OF SOFFIT	QUAD 4 SOFFIT HAS	ATTIC AREA/300	QUANTITY OF ROOF VENTS	MIN AIR FLOW OF SOFFIT
1st STORY	3328.2 SQ. FT.	333.3 SQ. FT.	22.19 SQ.FT.	6.66%	8.15%	SQ. FT.	-	%
			"SOF	FIT ONLY" QL	JALIFIES	ROOF	F VENTS ARE	E NOT REQUIRED
			NA	SOFFIT MOD CM QUAD 4, F IRROW PATTE I 5% FREE AIR	FULL VENT, RN,	22-3/8" BASE	LOMANCO 7	

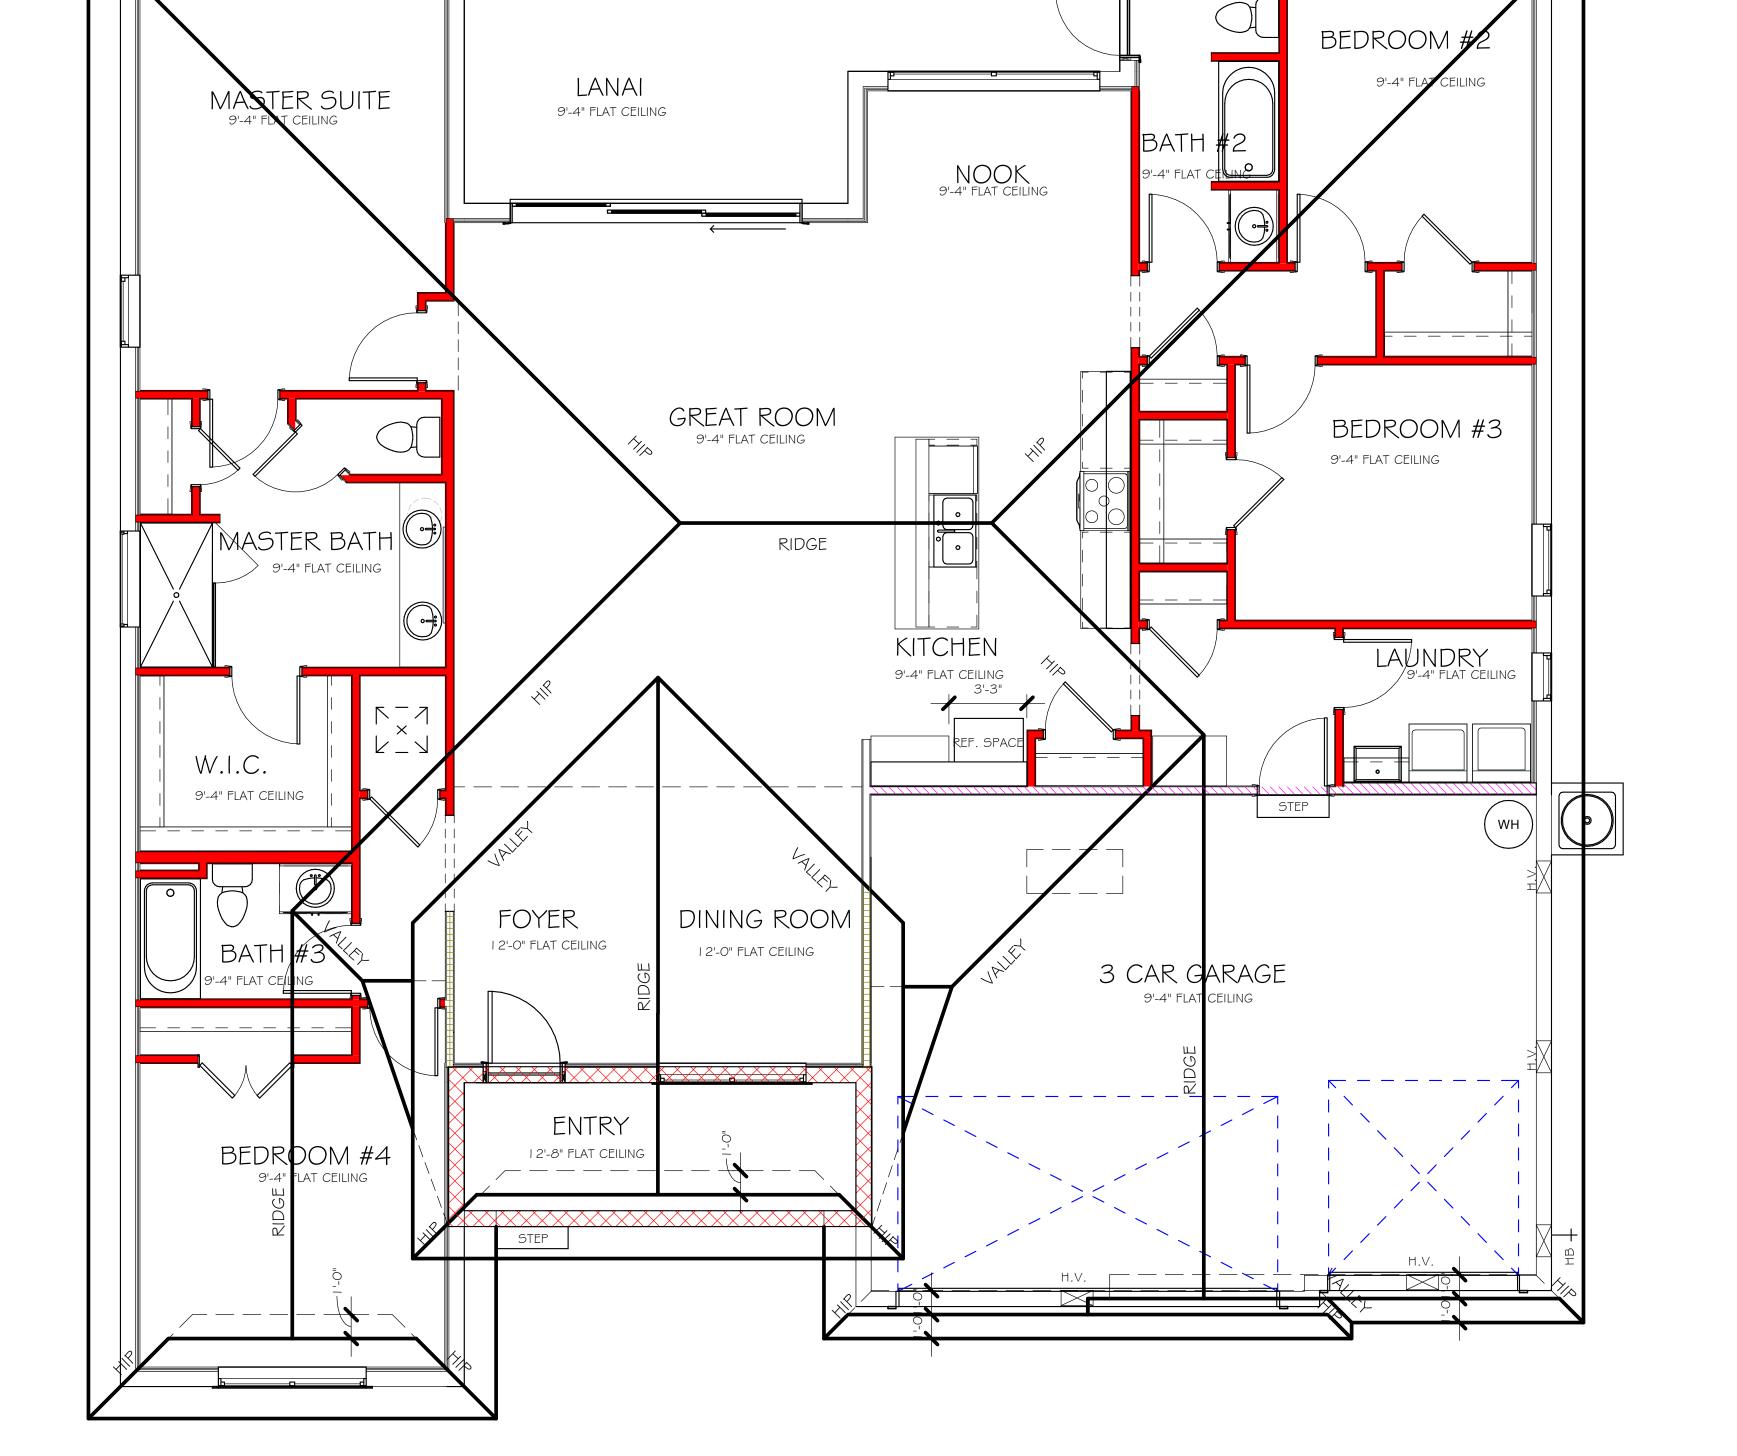


OPT. STEP

BEARING HEIGHT = BEARING @ 9'-4" = INTERIOR BEARING @ 9'-4" = BEARING @ 12'-8"

= INTERIOR BEARING @ 12'-8"

ROOF PLAN "AR" 1/4" = 1'-0"

No.	Description	Date

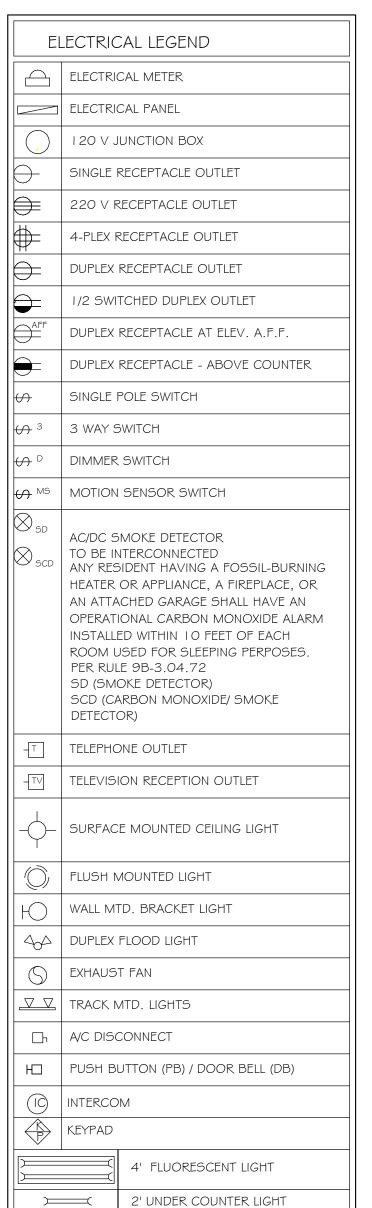

NOTE: NOT ALL SYMBOLS ARE USED FOR THIS

ARC-FAULT CIRCUIT-INTERRUPTERS AND TAMPER

IN DWELLING UNITS PER N.E.C 210.12 AND 406.11

ALL ELECTRIC, ELECTRICAL EQUIPMENT AND APPLIANCES TO BE SET AT OR ABOVE BASE FLOOD ELEVATION PLUS 1'-0" FREEBOARD.

RESISTANT RECEPTACLES SHALL BE INSTALLED


ALL OUTLETS IN WET AREAS AND ALL EXTERIOR OUTLETS TO BE GFIS.

INSTALL PHONE AND T.V PER CONTRACT.

INSTALL ALL ELECTRICAL PER NEC 2014


PROJECT.

ELECTRICAL NOTES:

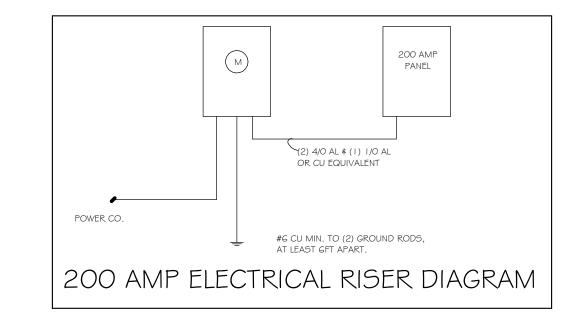

ELECTRICAL PLAN 2414

TAG	QUANTITY	PRODUCT
A	(17)	(FLUSH MOUNTED LIGHT)
В	(3)	(VAPORS)
С	(3)	(PENDANT LIGHT
D	(15)	(10" MUSHROOMS)
E	(4)	(24" 3 LT)
F	(X)	(36" 4 LT)
G	(X)	(NOT USED)
Н	(2)	(COACH LIGHTS)
1	(X)	(COACH LIGHTS)
J	(1)	(J BOX)
K	(X)	(4' FLUORESCENT)
L	(X)	(2' FLUORESCENT)
М	(X)	(5LT CHANDELIER)
Ν	(X)	(3 LT)
0	(X)	(PENDANT/ NOOK)
Р	(X)	(X)
Q	(X)	(X)

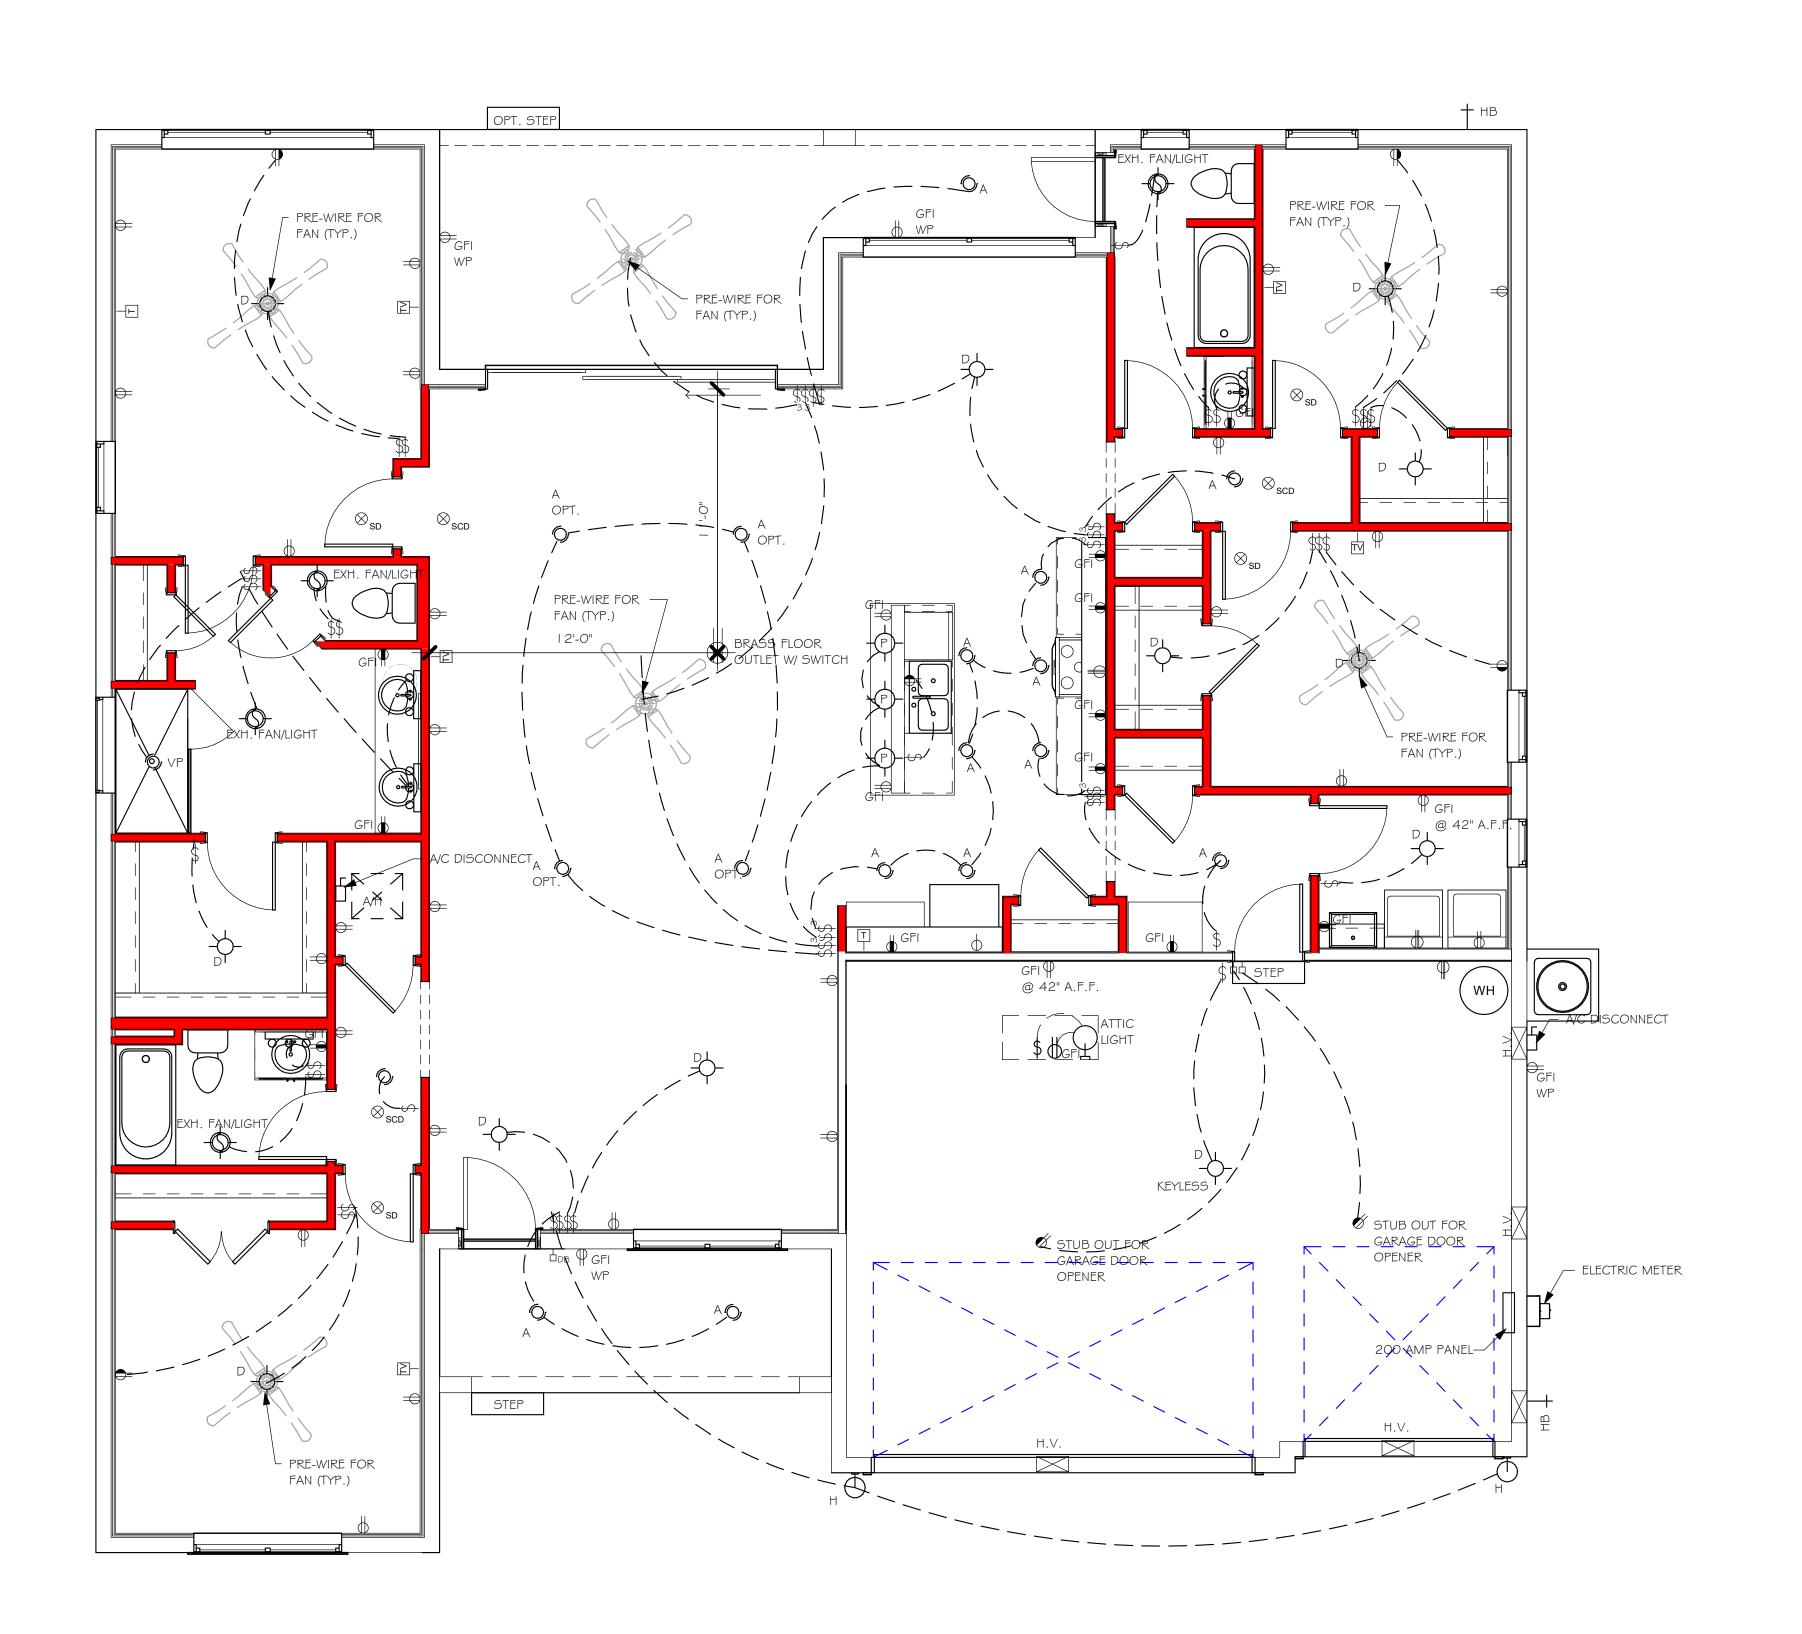

 $\frac{\text{ELECTRICAL PLAN "AR"}}{1/4" = 1'-0"}$

No.	Description	Date	

DESIGN IN ACCORDANCE WITH THE RESIDENTIAL FLORIDA BUILDING CODE 2017 - 6TH EDITION

DRAWN BY:

JBL

CHECKED BY:

JWC

REVISED:

PLAN:

ELECTRICAL

SCALE:


As indicated

A-5 AR

04/01/20

MODEL

DATE:

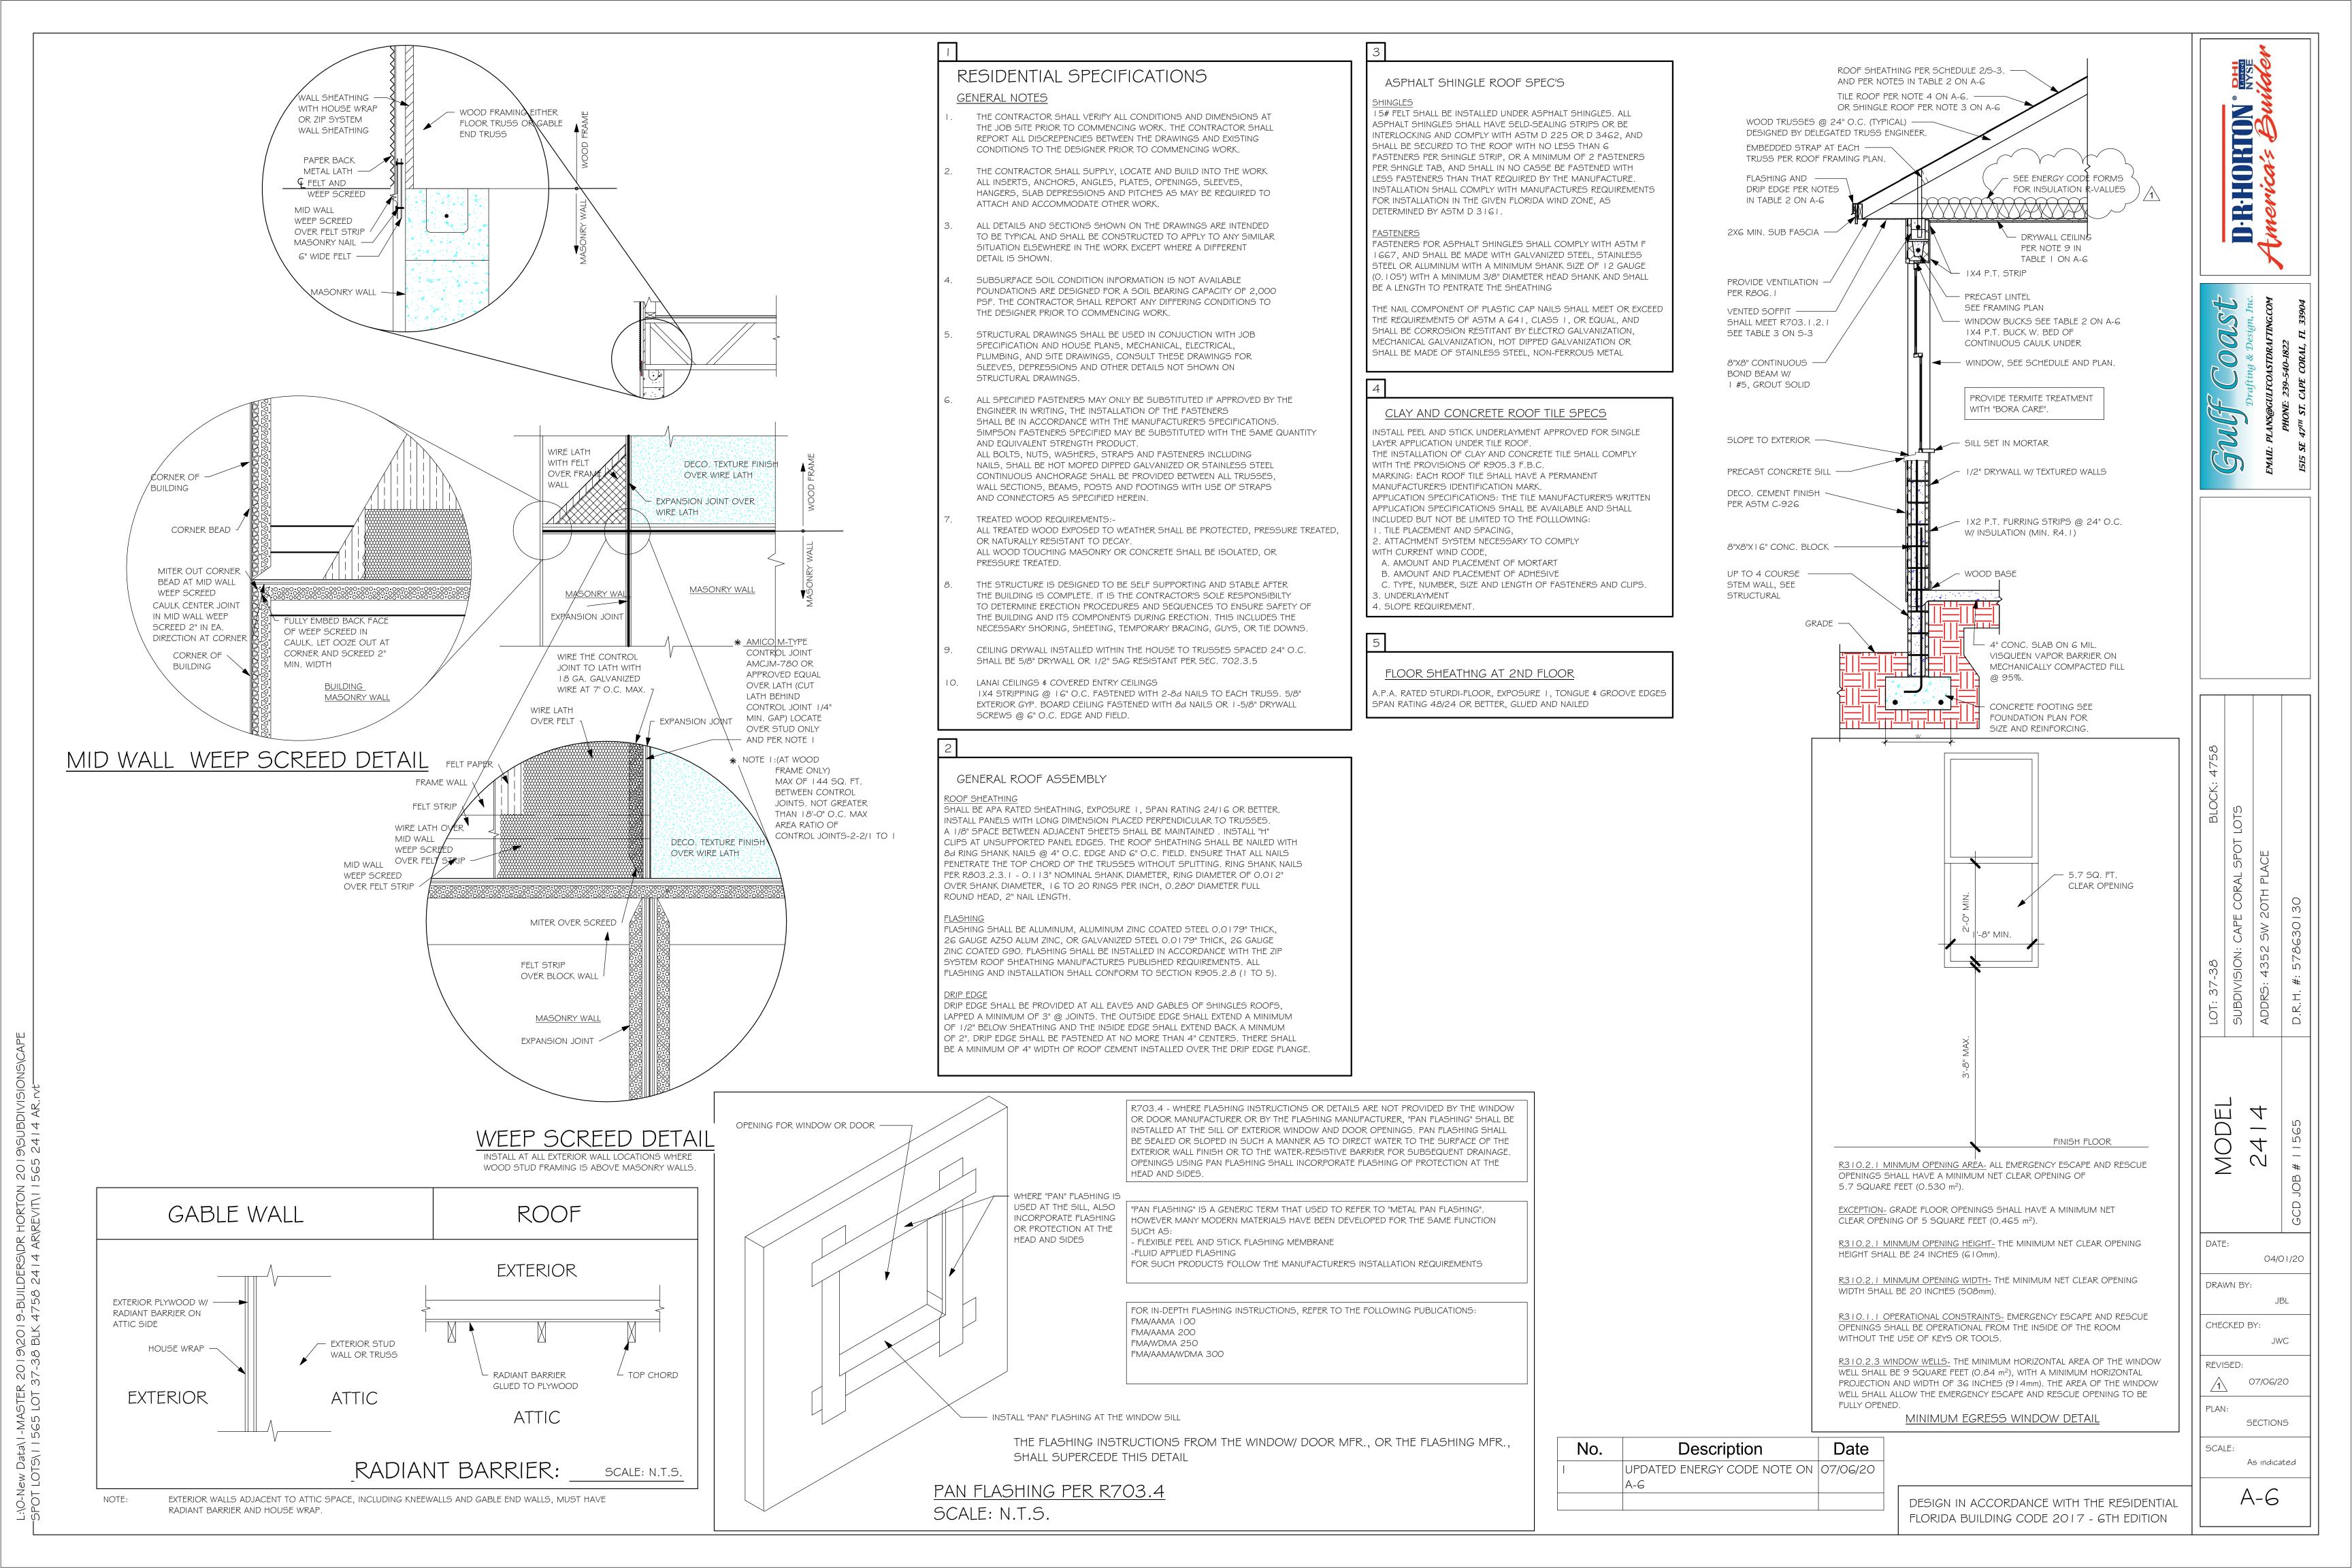





 $\sum_{i=1}^{n}$

DATE: 04/01/20

DRAWN BY: CHECKED BY: JWC

REVISED:

FOUNDATION PLAN SCALE: As indicated

FLORIDA BUILDING CODE 2017 - 6TH EDITION



FOOTING F2 IS ADEQUATE FOR THE POINT LOAD FROM GIRDER A I ABOVE. THE PRESENCE OF THE WINDOW DISTRIBUTES THE LOAD.

14'-4"

11'-2 1/2"


WALL FOOTING SCHEDULE

USED	TYPE	LENGTH	WIDTH	DEPTH	BOTTOM REINFORCING	SHAPE	
	F1	CONT.	1'-4"	0'-8"	2-#5		
X	F2	CONT.	1'-8"	0'-10"	2-#5		400 000
	F3	CONT.	1'-0"	1'-8"	2-#5	₩	ADD CURE GARAGE, S DETAIL
	F4	CONT.	1'-4"	1'-8"	2-#5	\vdash	
X	F5	CONT.	1'-4"	1'-0"	2-#5	-	
	F6	CONT.	1'-4"	1'-0"	2-#5	F	
	F6A	CONT.	0'-8"	0'-8"	1-#5		
	TE	CONT.	0'-8"	0'-8"	1-#5	F	


PROVIDE CORNER BARS IN FOOTING PER 6/S-3

	_		
		TVDE	
	S	TYPE	LEN
	\vdash		

	PAD FOOTING SCHEDULE						
ED	TYPE LENGTH V		MIDTI		BOTTOM REINF.		DEMARKO
USED	IYPE	LENGIH	WIDIH	DEPTH	LONG WAY	SHORT WAY	REMARKS
X	$\langle \mathbf{A} \rangle$	2'-6"	2'-6"	1'-0"	3-#5	3-#5	-
X	B	3'-0"	3'-0"	1'-0"	4-#5	4-#5	-
X	(C)	3'-6"	3'-6"	1'-0"	4-#5	4-#5	-
	(D)	4'-0"	4'-0"	1'-2"	5-#5	5-#5	-
	(E)	5'-0"	5'-0"	1'-2"	6-#5	6-#5	-

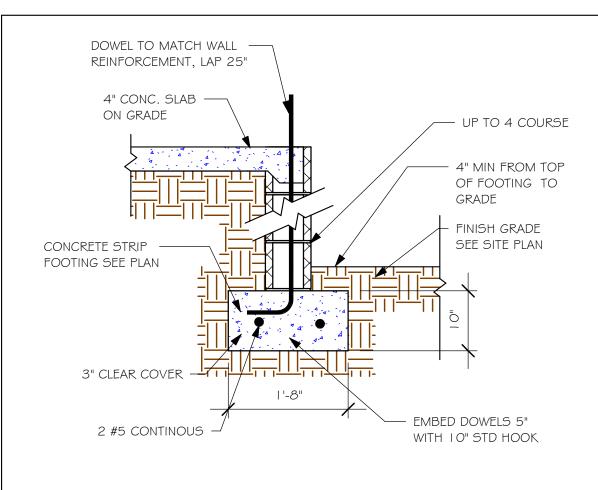

NOTE: REINFORCING IN FOOTINGS SHALL BE CONTINUOUS AT CORNERS AND INTERSECTIONS. ADD CORNER BAR 25" X 25" AT EACH LONGITUDINAL BAR.

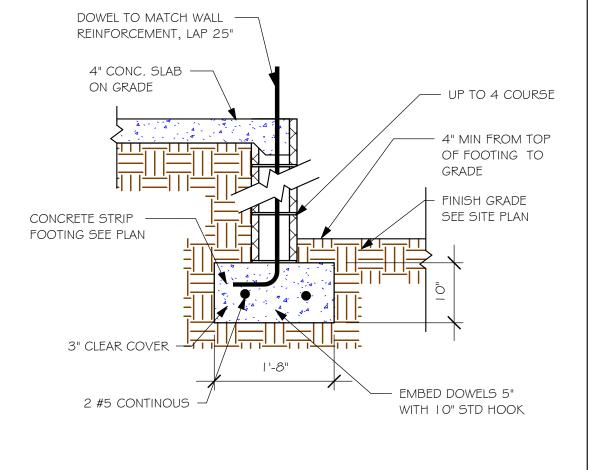

FOUNDATION PLAN

SCALE: 1/4" = 1'-0"

- ALL DIMENSIONS ARE TO OUTSIDE FACE OF MASONRY WALLS. SOME SLAB EDGES MAY

PLAN NOTES: TOP OF GROUND FLOOR SLAB DATUM ELEVATION 0'-0"

- "F#" DENOTES CONTINUOUS WALL FOOTING TYPE PER SCHEDULE THIS SHEET. PROVIDE #5 VERTICAL REINFORCING AT DOT LOCATIONS SHOWN ON PLAN FROM FOOTING
- FOR DIMENSIONS OF ROUGH OPENINGS IN MASONRY WALLS, COORDINATE WITH WINDOW/
- PROVIDE PRESSURE TREATED BUCKS AT WINDOWS/ DOORS PER DETAIL 7/S-3.

4" SLAB W/ 2,500 PSI CONC. W/ 6X6 # 10/10 W.W.M. REINFORCING OVER 6 MILL VISQUEEN BARRIER ON - PROVIDE 1/4" WATER MECHANICALLY COMPACTED FILL @ 95%. LINE @ REF. SPACE FOR ICE MAKER PROVIDE TERMITE TREATMENT - SET A/C PAD ABOVE WITH "BORA CARE" FLOOD W/ 1'-0" FREEBOARD PER SAWCUT SLAB FBCR R322.2.1 PER DETAIL 5/S-3 NOTE: INSTALL 1-3/8" THICK SOLID WOOD DOOR BETWEEN LIVING & GARAGE PER R302.5.1 SET WH ABOVE FLOOD W/ 1'-0" -FREEBOARD PER FBCR R322.2.1 5'-5" 17'-9" 4'-11" 16'-2 1/2" 5'-2" ELEV. @ - 1'-3" 12'-1 1/2" HYDROSTATIC VENT REQUIRED 'HV' SERVICES 128 SQ.FT. PER VENT. ELEV. @ -0'-4" 604 SQ.FT./128 SQ.FT.= 4.72 SQ.FT. USE 5 VENTS, BOTTOM OF VENTS 12" MAX ABOVE FLOOR. PAVERS BY OTHERS INDICATES (|) #5 VERTICAL BARS IN GROUTED CELL, LAP 25" W/ #5 DOWEL OUT OF SLAB W/ 7" HOOK INTO TOP OF OF BOND BEAM @ 48" O.C. MAX 6" X | 2" RECESS 6" X 12" RECESS 8'-0" X 8'-0" O.H. GARAGE DOOR 16'-0" X 8'-0" O.H. GARAGE DOOR 8F8-1B SET AT GARAGE DOOR HEAD HEIGHT, ADD COUSRING AS, REQUIRED TO 8X8 BOND BEAM W/ I# 5, TOP @ 9'-4" GROUT SOLID 16'-0" 8'-4" 13'-8" 16'-4" 14'-4" 29'-0"

59'-8"

- STANDARD SGO RECESS 1-1/2". IMPACT GLASS SGD RECESS RECESS 2- 1/2'.

RUN CONDUIT FOR —

ELECTRIC AT ISLAND

FOUNDATION PLAN "AR"

1/4" = 1'-0"

BRASS FLOOR
OUTLET W/ SWITCH

10'-0"

16'-8 1/2"

46'-1 1/2"

18'-0"

| | | | | |-4"

16'-0"

PAVERS BY OTHERS

ELEV. @ -0'-4"

12'-0"

THE FINISH FLOOR SLAB SHALL BE SET ABOVE BASE FLOOD ELEVATION PER FEMA FLOOD MAP PLUS 1'-O" FREEBOARD PER

FBCR R322.2.1. SEE SITE PLAN BY OTHERS

12'-2"


EXTEND BEYOND FACE OF WALL.

DESIGN IN ACCORDANCE WITH THE RESIDENTIAL

3" CLEAR COVER

"F5" FOOTING

1/2" = 1'-0"

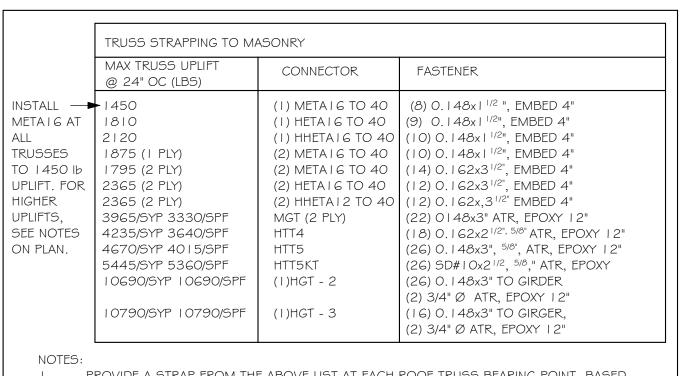

PROVIDE A STRAP FROM THE ABOVE LIST AT EACH ROOF TRUSS BEARING POINT, BASED ON THE TRUSS UPLIFT VALUES IN THE SIGNED AND SEALED TRUSS DESIGN PACKAGE AND SUITABLE FOR THE GEOMETRY. EMBED STRAP ON -C OF WALL.


- CONNECTORS ARE SIMPSON STRUCTURAL CONNECTORS. ALL CONNECTORS SHALL BE INSTALLED IN STRICT ACCORDANCE WITH SIMPSON PRINTED INSTUCTIONS. SUBSTITUTIONS MUST BE APPROVED IN WRITING BY THE ENGINEER OF RECORD.
- WHERE EMBEDDED STRAPS ARE MISSING, OR MIS-LOCATED, INSTALL RETROFIT STRAP PER

R4-021020


INSTALL AT ALL	TRUSS STRAPPING TO STUDWALL/ WOOD BEAM					
TRUSSES TO 840 lb UPLIFT.	MAX TRUSS UPLIFT @ 24" OC (LBS)	CONNECTOR	FASTENER			
FOR HIGHER UPLIFTS, SEE NOTES ON PLAN.	850 1700 2550 1125 2250 3375 4500	(1)MT516 TO 20 (2) MT516 TO 20 (3) MT516 TO 20 (1) HT520 TO 30 (2) HT520 TO 30 (3) HT520 TO 30 (4) HT520 TO 30	(14) Odx - /2" (14) Odx - /2" (14) Odx - /2" (24) Odx - /2" (24) Odx - /2" (24) Odx - /2" (24) Odx - /2"			
NOTES:						

I. PROVIDE A STRAP FROM THE ABOVE LIST AT EACH ROOF TRUSS BEARING POINT, BASED ON THE TRUSS UPLIFT VALUES IN THE SIGNED AND SEALED TRUSS DESIGN PACKAGE

CONNECTORS ARE SIMPSON SRTONG TIE. ALL CONNECTORS SHALL BE INSTALLED IN STRICT ACCORDANCE WITH SIMPSON PRINTED INSTUCTIONS.

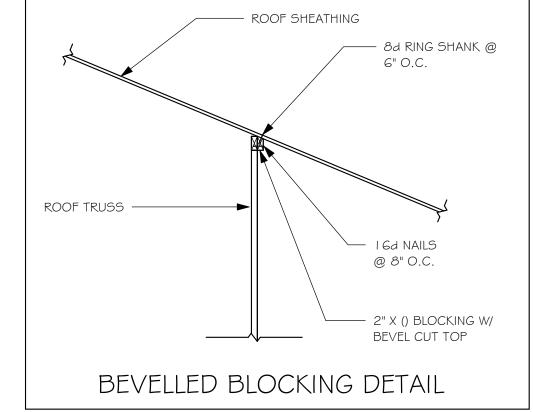

WHERE ROOF SHEATHING CONTACTS ONLY THE -EDGE OF ROOF TRUSSES, INSTALL BEVELLED BLOCKING PER DETAIL THIS SHEET (DR HORTON COMPANY REQUIRMENT)

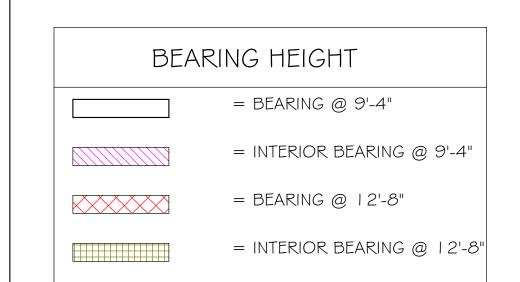

WALL ABOVE WITH BOND BEAM AT TOP #5 VERTICAL, ABOVE LINTEL ONLY WHERE ┌ I#5 TOP NOTED ON PLAN IB' DENOTES 1#5 BOTTOM WITH 7" HOOK EACH END OR EXTEND 24" BEYOND OPENING. OB' DENOTES "NO REBAR" L 1#5 BOTTOM <u>8F16-1B/1T</u> 8" PRECAST LINTEL / PRECAST LINTEL SCHEDULE AT SWING DOORS, USE 2" RECESS STYLE

LINTEL IF NEEDED FOR ROUGH OPENING.


LINTELS BEAR 4" MIN. EACH END

PLAN NOTES:


ROOF TRUSS BEARING ELEVATION VARIES, SEE LEGEND. ROOF FRAMING SHALL BE WOOD TRUSSES DESIGNED BYA DELEGATED TRUSS ENGINEER PER DESIGN CRITERIA ON SHEET S-3. PROVIDE STRAPPING AT TRUSSES PER NOTES ON THIS

SHEET. FOR NAILING OF ROOF DECK, SEE | AND 2 ON S-3. 8F8-1B etc., DENOTES PRECAST LINTEL ABOVE DOOR/WINDOW OPENING PER SCHEDULE THIS SHEET. AT TRUSS BEARING, PROVIDE 8x8 MASONRY BOND

BEAM W/ I #5 CONTINUOUS, SEE DETAIL I I/S-3.

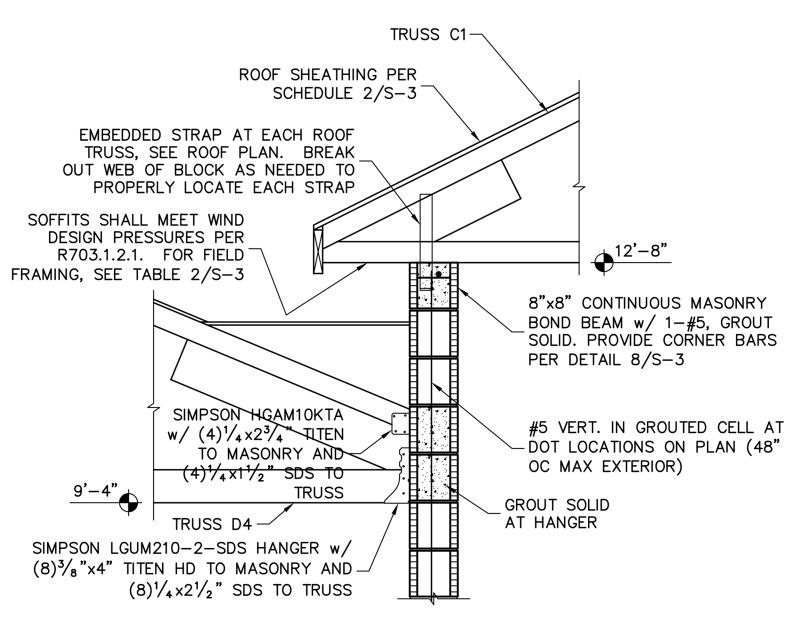

STRAPPING AT TRUSS D4
SCALE: 3/4" = 1'-0"

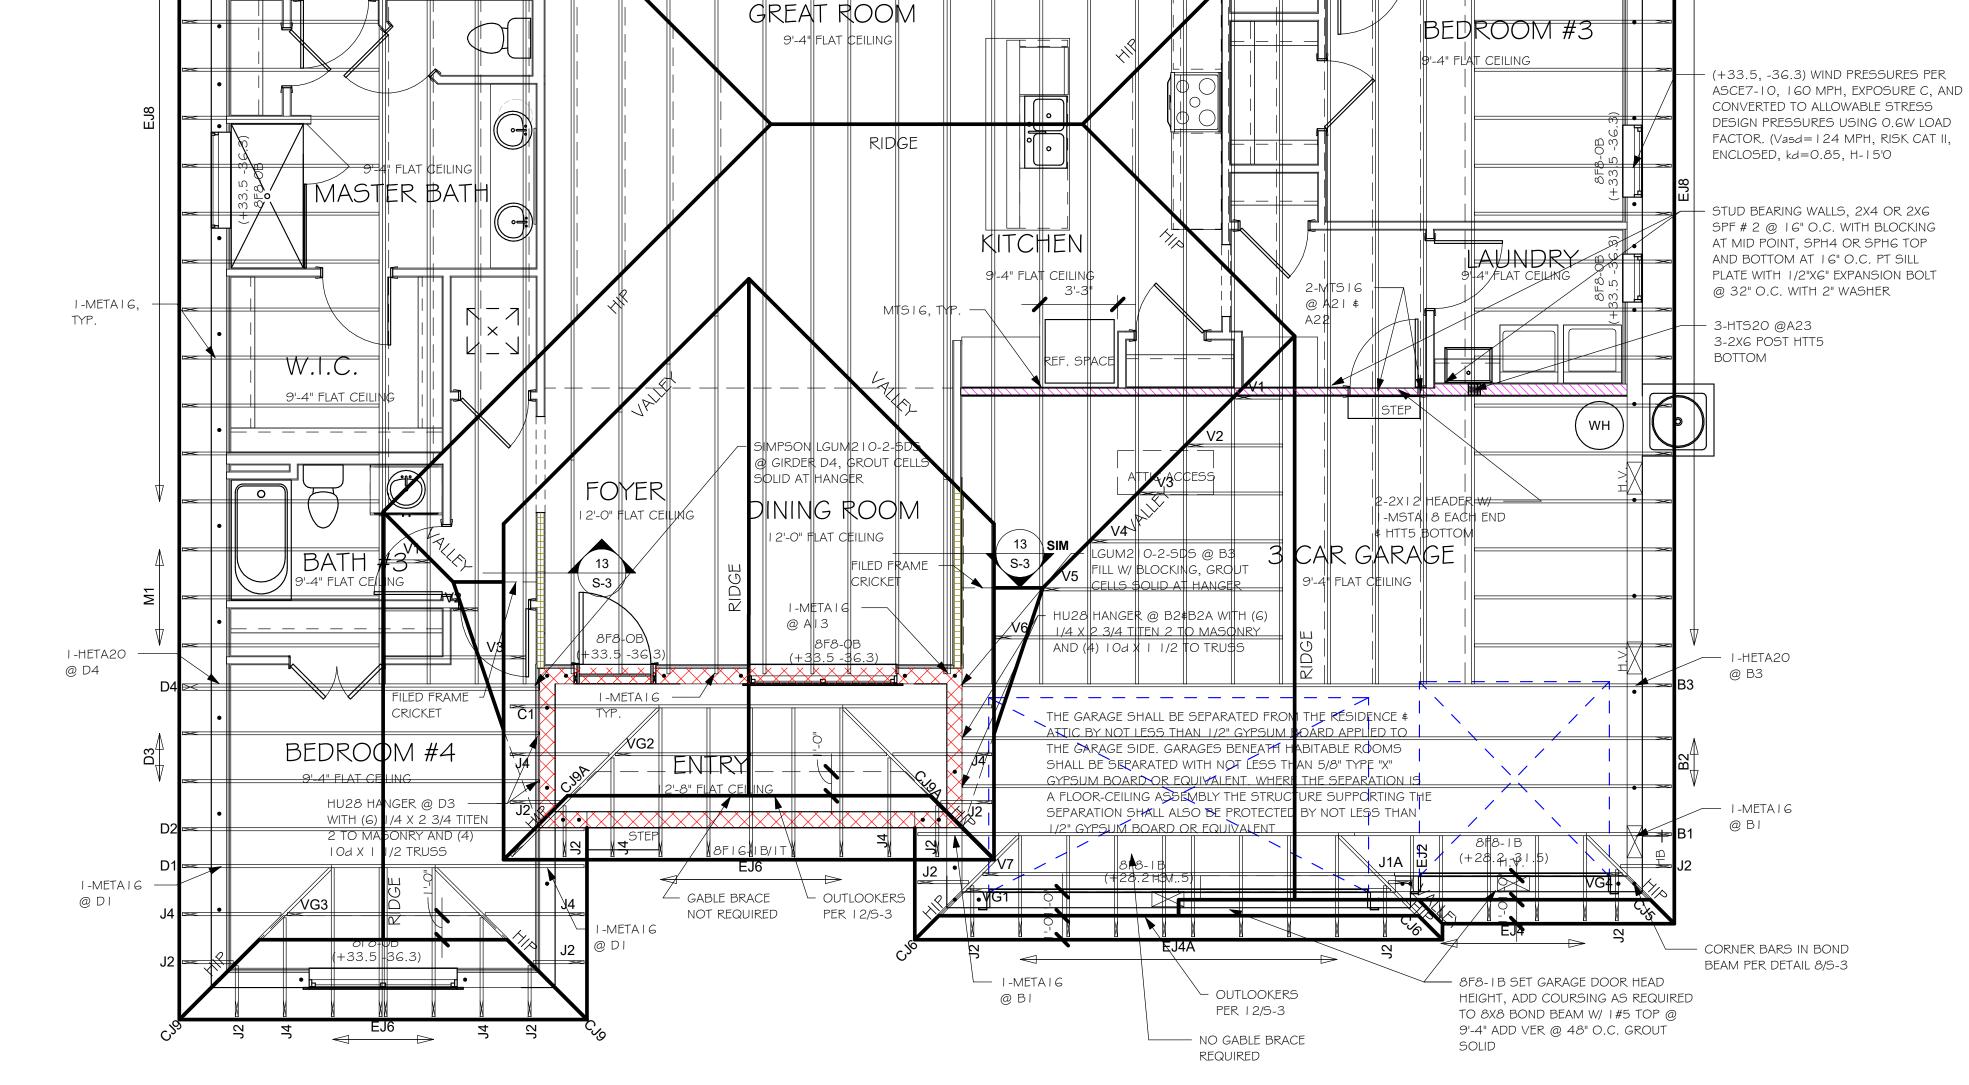

EXTERIOR CEILING PER / I-META 16

I-METALIG

@ A13

8F16-1B/1T

-META I

(+33.5 -36.3)

8F8-1B

94" FLAT CEILIN

SCHEDULE 2/S-3

ROOF FRAMING PLAN "AR" 1/4" = 1'-0"

SEE DETAIL 9/S-3 WHERE

INSTERSECTS MAIN WALL,

LINTEL AS LANAI /ENTRY

8F16H1B/1T

LANAI

9'-4" FLAT CEILING

8F8-1B

@ A I

TRUSS BEARING CONDITIONS AND STRAPPING IS BASED ON TRUSS LAYOUT PREPARED BY SCOSTA JOB # 44142 DATED: 08/15/18 REVISED: 01/14/2020

> DESIGN IN ACCORDANCE WITH THE RESIDENTIAL FLORIDA BUILDING CODE 2017 - 6TH EDITION

___ I-META 16

BEDROOM

BATH #2

#5 CORNER BAR IN

— I-META16,

8X8 CONTINUOUS MASONRY BOND

STRUCTURAL SYSTEMS OF NORTH FLORIDA 1634 SE. 47th ST SUITE #3 CAPE CIRAL, FL 33904 <239> 549-4554

4352

H

 $\overline{\bigcirc}$

DATE:

DRAWN BY:

CHECKED BY:

REVISED:

SCALE:

04/01/20

JWC

BEAM AT TOP OF WALL W/ 1#5


BAR.PROVIDE CORNER BARS PER

BOND BEAM PER 8/S-3

As indicated

5-2 AR

ROOF FRAMING PLAN

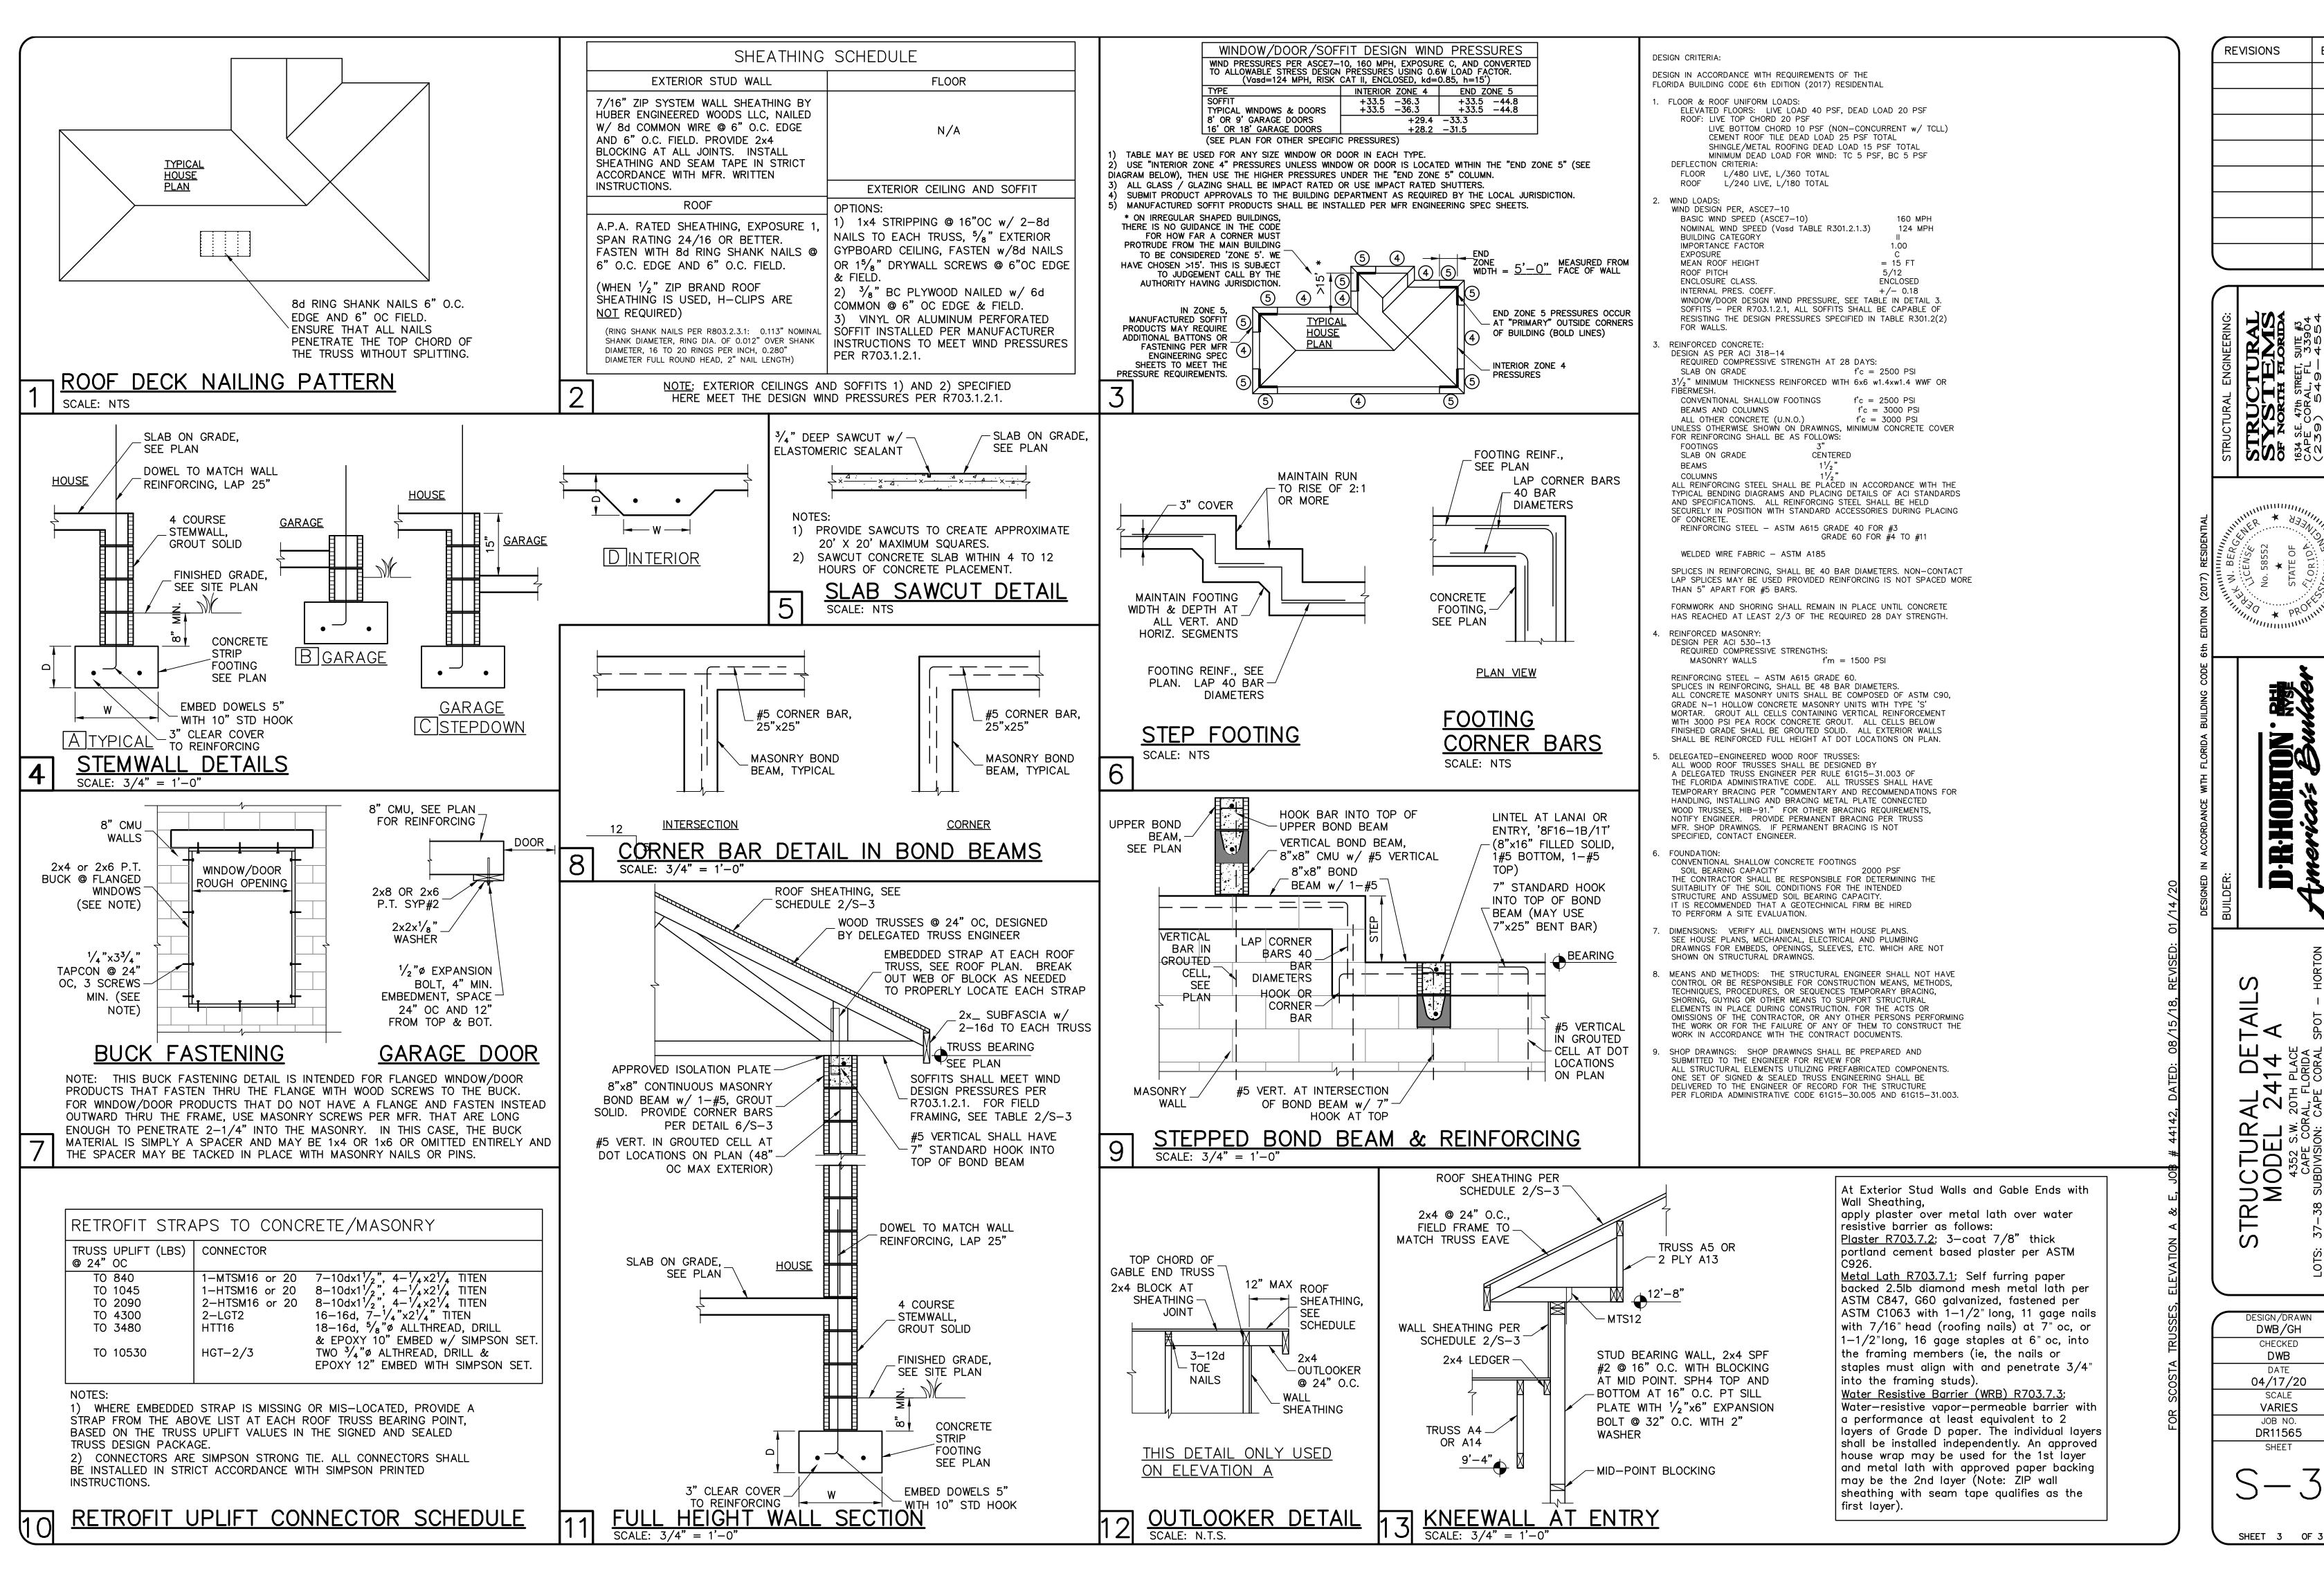

REVISIONS

STRUCTURAL SYSTEDMS of North Florida 1634 S.E. 47th STREET, SUITE #3 CAPE CORAL, FL 33904 (239)

OKTON D-R-H

DE 14 PLACE ORIDA CORAL **4** [±] ± ± = 0 DEL 352 S.V. OO 4 $\supset \Sigma$

DWB/GH CHECKED DWB 04/17/20 SCALE **VARIES** JOB NO. DR11565