

September 21, 2020

DR Horton 10541 Six Mile Cypress Parkway Fort Myers, FL 33966

**RE:** AUTHORIZATION LETTER FOR MASTER PERMIT B20-06944

Model 1499 A Left

Subdivision: Gator Circle Spot Lots, Lots 43-44, Block 5690 821 NE 43rd Lane, Cape Coral, Florida

This letter is to authorize DR Horton to obtain a building permit for the above referenced address

based on Master Permit plans B20-06944.

If you need any more information, please call me at 239-549-4554.

Sincerely,

Structural Engineer of Record Derek Bergener, PE 58552


This item has been digitally signed by Derek Bergener on the date adjacent to the seal. Printed copies of this document are not considered signed and sealed and the signature must be verified on any electronic copies.




## Product Approvals Code Version 2017

FL#	Manufacturer	Category	Exp.
FL20468.1	Therma-Tru	Ext. Door	5/31/2021
FL20468.4	8'		0/01/2021
	SH Series 185 and		
	SGD Series 420		
FL12019.1	American Const.	Soffits 12"	3/2/2030
FL17676.1	MI Window	SH Fin Frame	04/12/22
	3540 SH	Non-Impact	0 1/ 12/ 22
FL17676.8	MI Window	SH Flange	04/12/22
	3540 SH	Non-Impact	
FL15332.2	MI -420 series	Slider -2 panel	12/31/20
		non-impact	
FL15332.8	MI -420 series	Slider -3 panel	12/31/20
		non-impact	
FL18644.1	MI Window	Fixed Glass Fin	04/30/21
	3540 PW	Non-Impact	
FL18644.2	MI Window	Fixed Glass Flange	11/18/22
	3540 PW	Non-Impact	
FL21639.6	MI Window	Fixed Glass	08/15/2021
	1620 PW	Impact	=
FL21637.5	MI Window	SH Impact	12/27/21
	1620 Series		
FL22401.3	MI - 120 series	Slider Impact	11/29/21
FL15550-R5	IKO Industries, LTD	Shingle	12/31/20
FL11964.1	Eastern Metal Supply	Shutters	12/31/20
FL15279-R5	Clopay Building	Garage Door	
	Products Company		5/21/2028

10541 Six Mile Cypress Fort Myers, FI 33966 (239) 225-2600 Phone (239) 225-2601 Fax 3/5/20208:47:18 AM

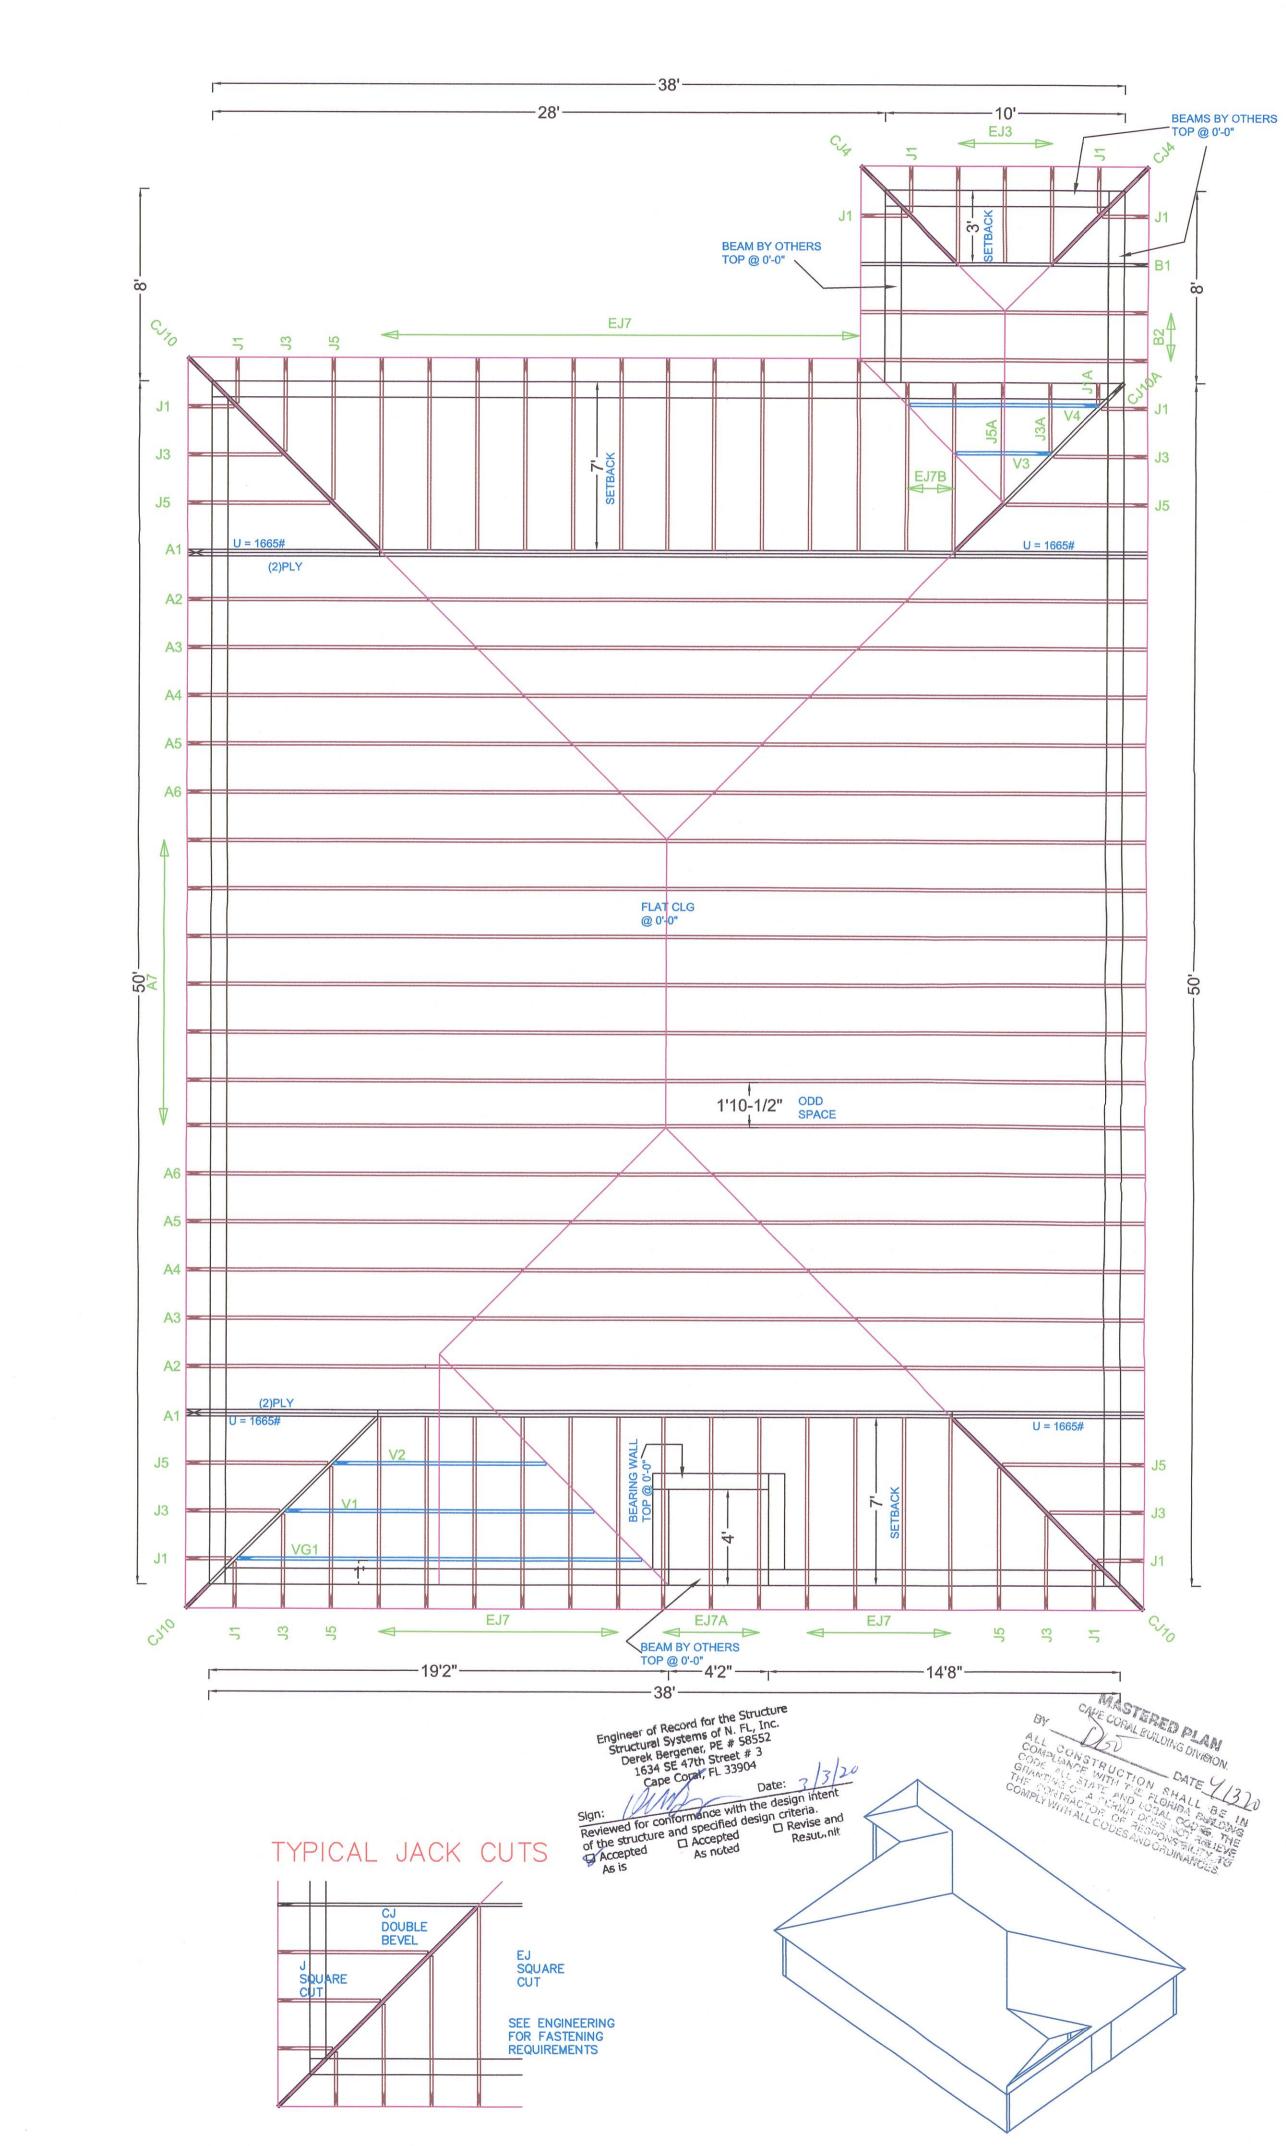

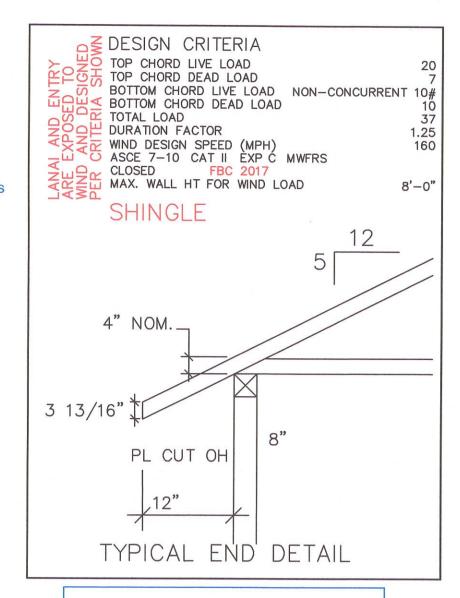

\*\*UNLESS NOTED\*\*

REACTION VALUES ARE UNDER 5000#

UPLIFT VALUES ARE UNDER 1000#

## ALL TRUSSES 24"o.c. UNLESS NOTED OTHERWISE \*\*\*\*\*\*\*CAUTION\*\*\*\*\*

DO NOT ATTEMPT TO ERECT TRUSSES WITH-OUT REFERRING TO THE ENGINEERING DWGS.

IT IS NECESSARY TO REFER TO THE ENGINEERING DRAWINGS FOR NUMBER OF MEMBERS, BEARING LOCATION, ORIENTATION AND WEB BRACING

REFER TO WTCA/TPI BSCI-B1 SUMMARY SHEET FOR HANDLING METHODS & TEMPORARY BRACING, WHICH IS ALWAYS REQUIRED

### BEARING HEIGHTS BASED ON PLANS PROVIDED TO SCOSTA CORP. "+/-" BEARING DIFFERENCES SHOWN ARE CRITICAL. IF ANY HEIGHTS DEVIATE - INFORM SCOSTA CORP.

BEARING WALL & BEAM HEIGHTS

	0'-0"	ELEV.
7//////		ELEV.
		ELEV.
		ELEV.
HERMANAMA		ELEV.
		ELEV.
**************************************		ELEV.

## TYPICAL HANGER SCHEDULE

C SIMPSON HUS 26 M SIMPSON HGUS 28-3

F SIMPSON HUS 28 N SIMPSON HHUS 48 H SIMPSON HGUS 28 P SIMPSON LUS 24

I SIMPSON HGUS 28-2 B SIMPSON THA 422

W SIMPSON THJA26 X


HANGER VALUES HAVE BEEN BASED ON 16D COMMON NAILS EXCEPT THE FOLLOWING LUS24 - 10D COMMON THJA26 - 10D x 1-1/2

## \*\*\*\*\*\*ATTENTION\*\*\*\*\*

APPROVAL OF THIS TRUSS LAYOUT IS NECESSARY BEFORE FABRICATION CAN BEGIN. VERIFY DIMENSIONS, PITCHES, OVERHANGS, ELEVATIONS, CEILING & BEARING CONDITIONS. SCOSTA CORPORATION IS RESPONSIBLE FOR ACCURACY IN ACCORDANCE WITH PLANS AND/OR INFORMATION PROVIDED BY CUSTOMER, WITH ANY DEVIATIONS NOTED HEREIN. CUSTOMER IS RESPONSIBLE TO VERIFY ACCURACY OF INFORMATION AND PLANS PROVIDED TO SCOSTA CORPORATION, AND TO VERIFY CONFORMANCE TO FIELD CONDITIONS, AND/OR OWNER CHANGES. TRUSSES WILL BE BUILT IN ACCORDANCE WITH THE APPROVED LAYOUT.

APPROVED BY: \_\_\_\_\_ DATE: \_\_\_\_\_ REQUESTED DELIVERY DATE: \_


JOBSITE CONTACT NAME: \_

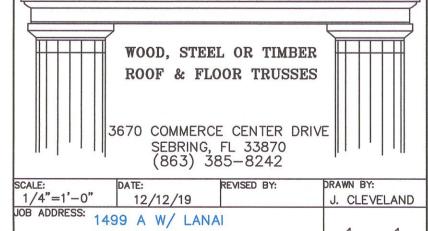

1 of 1 GARAGE LEFT LEE CUSTOMER:

D.R. HORTON

44116L

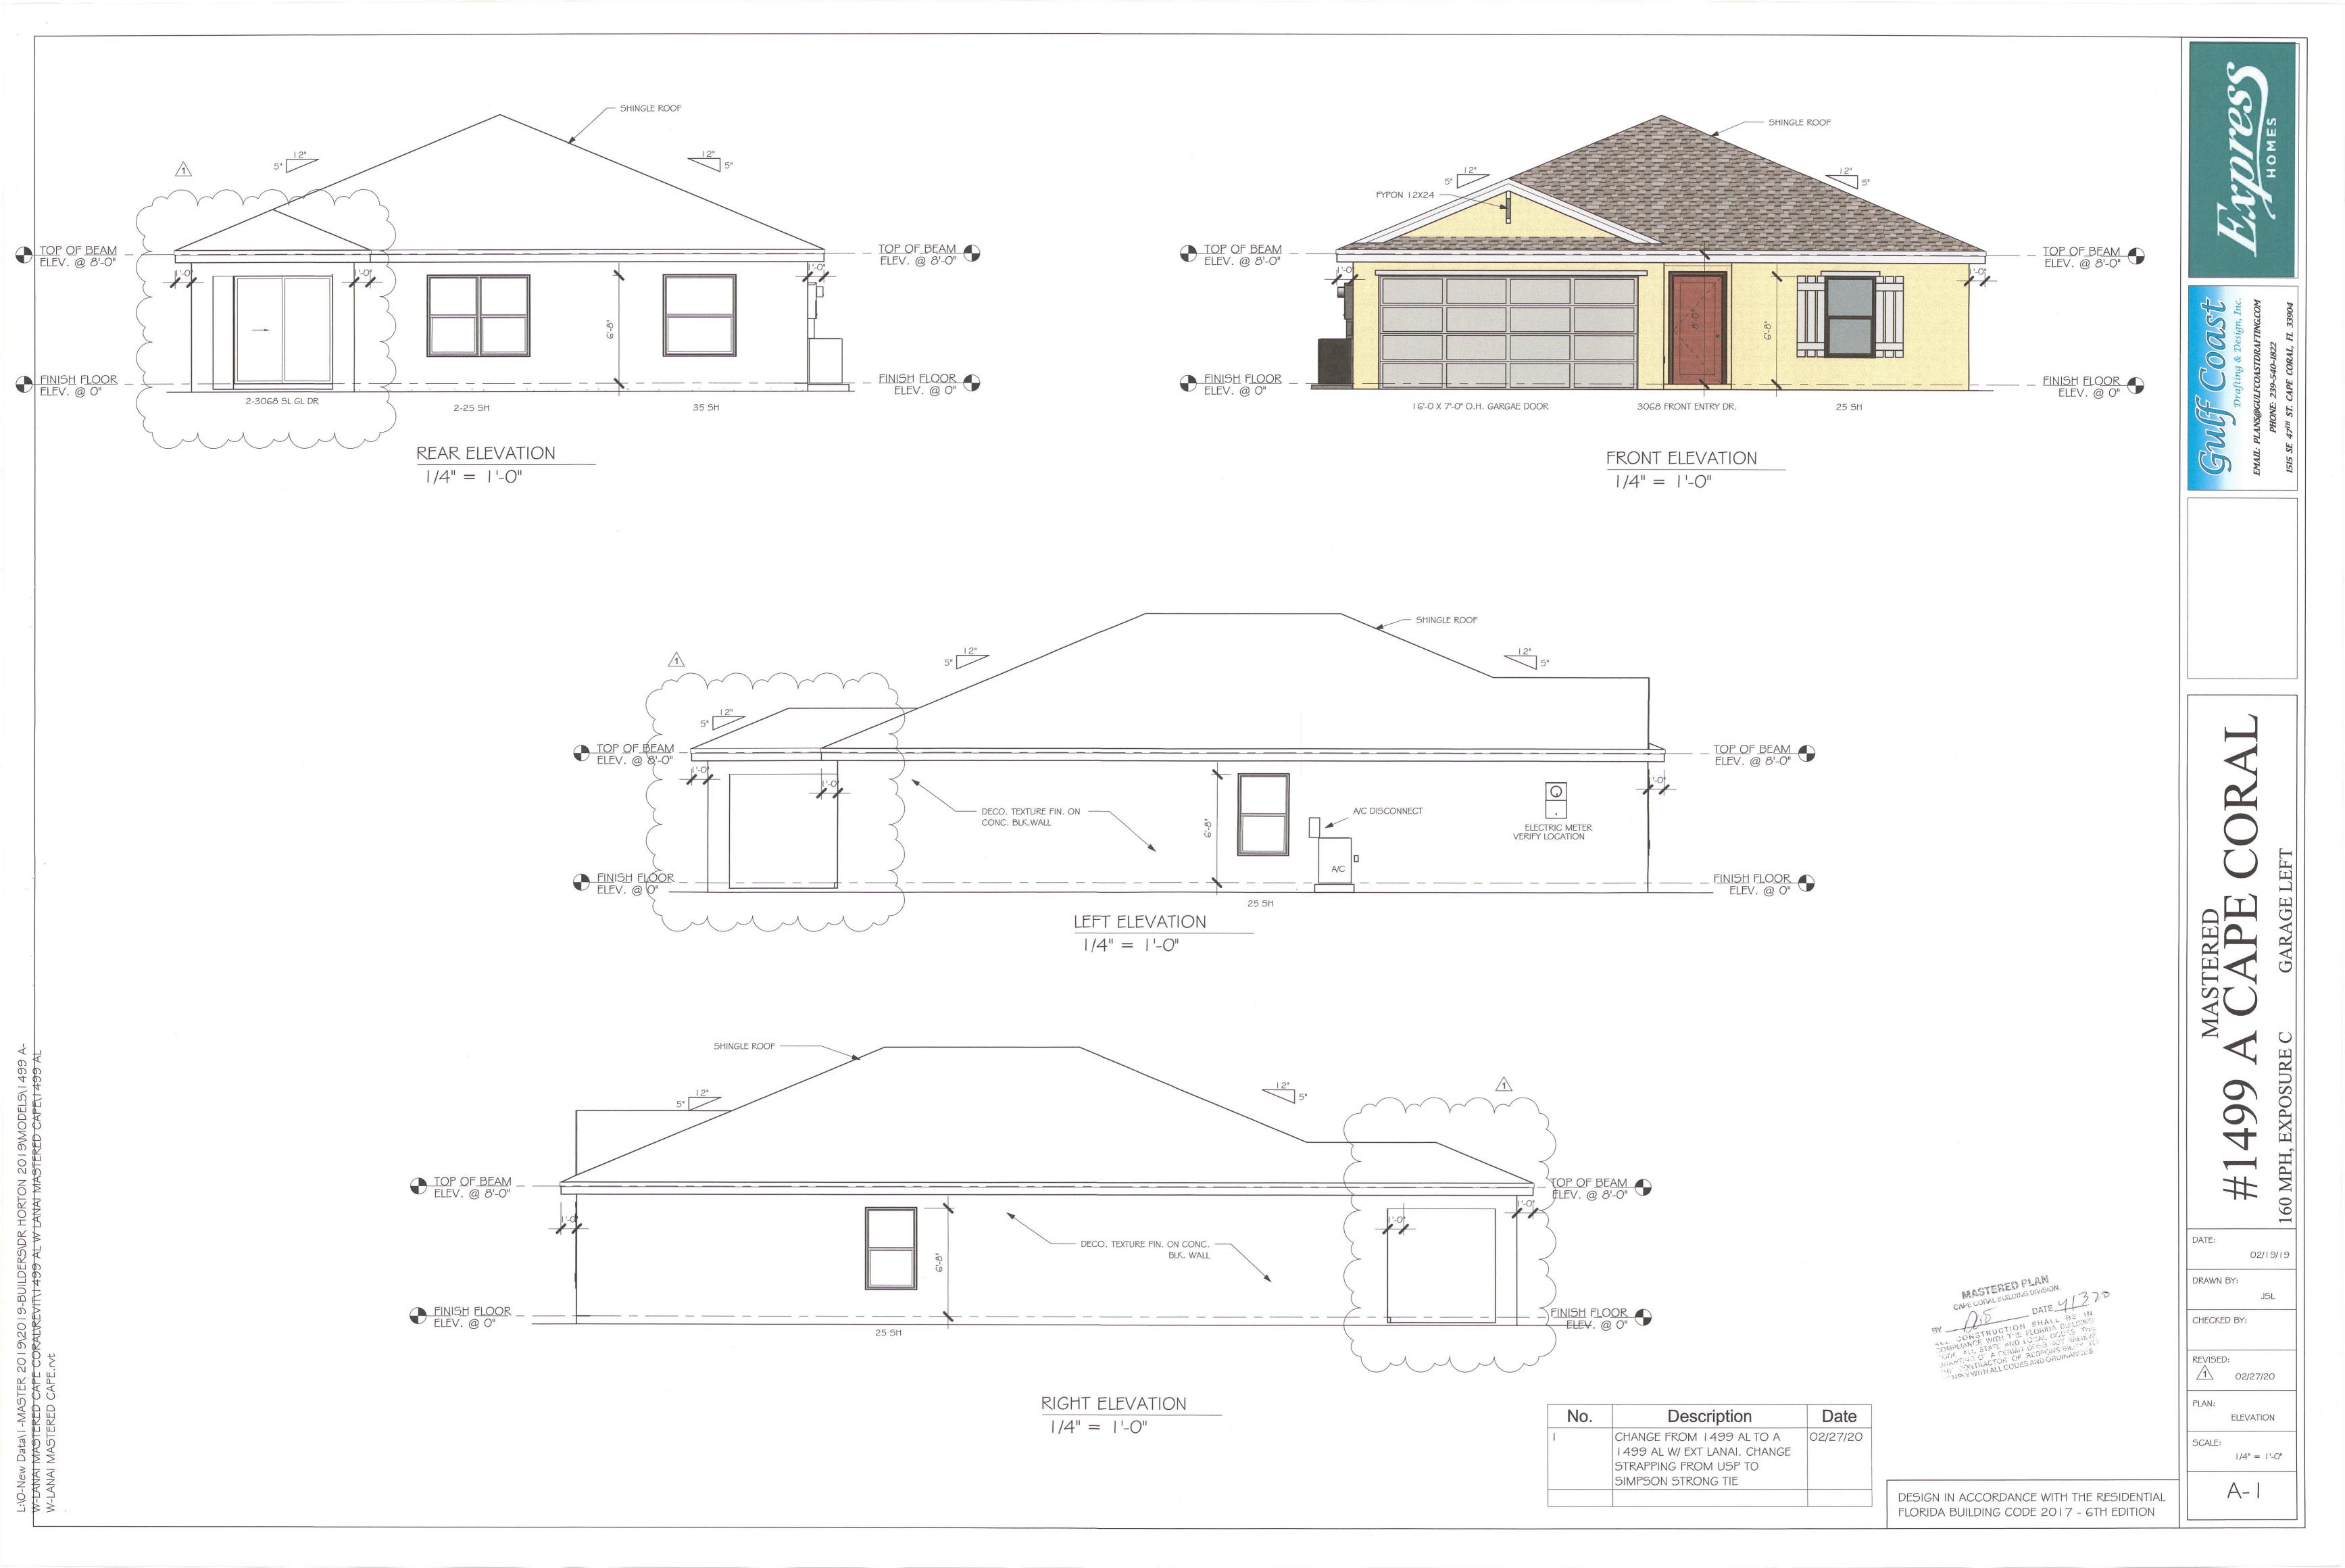

**VARIES** MIRROR -MIRROR - FAUCET FAUCET -21" MIN. TO FIXTURES, WALLS KICK PLATE -VARIES FRONT ELEVATION SIDE ELEVATION VANITY SINK CLEARANCE DETAIL

WATER CLOSET CLEARANCE DETAIL


FRONT ELEVATION

36" MAX.

SIDE ELEVATION

21" MIN. TO

FIXTURES, WALLS

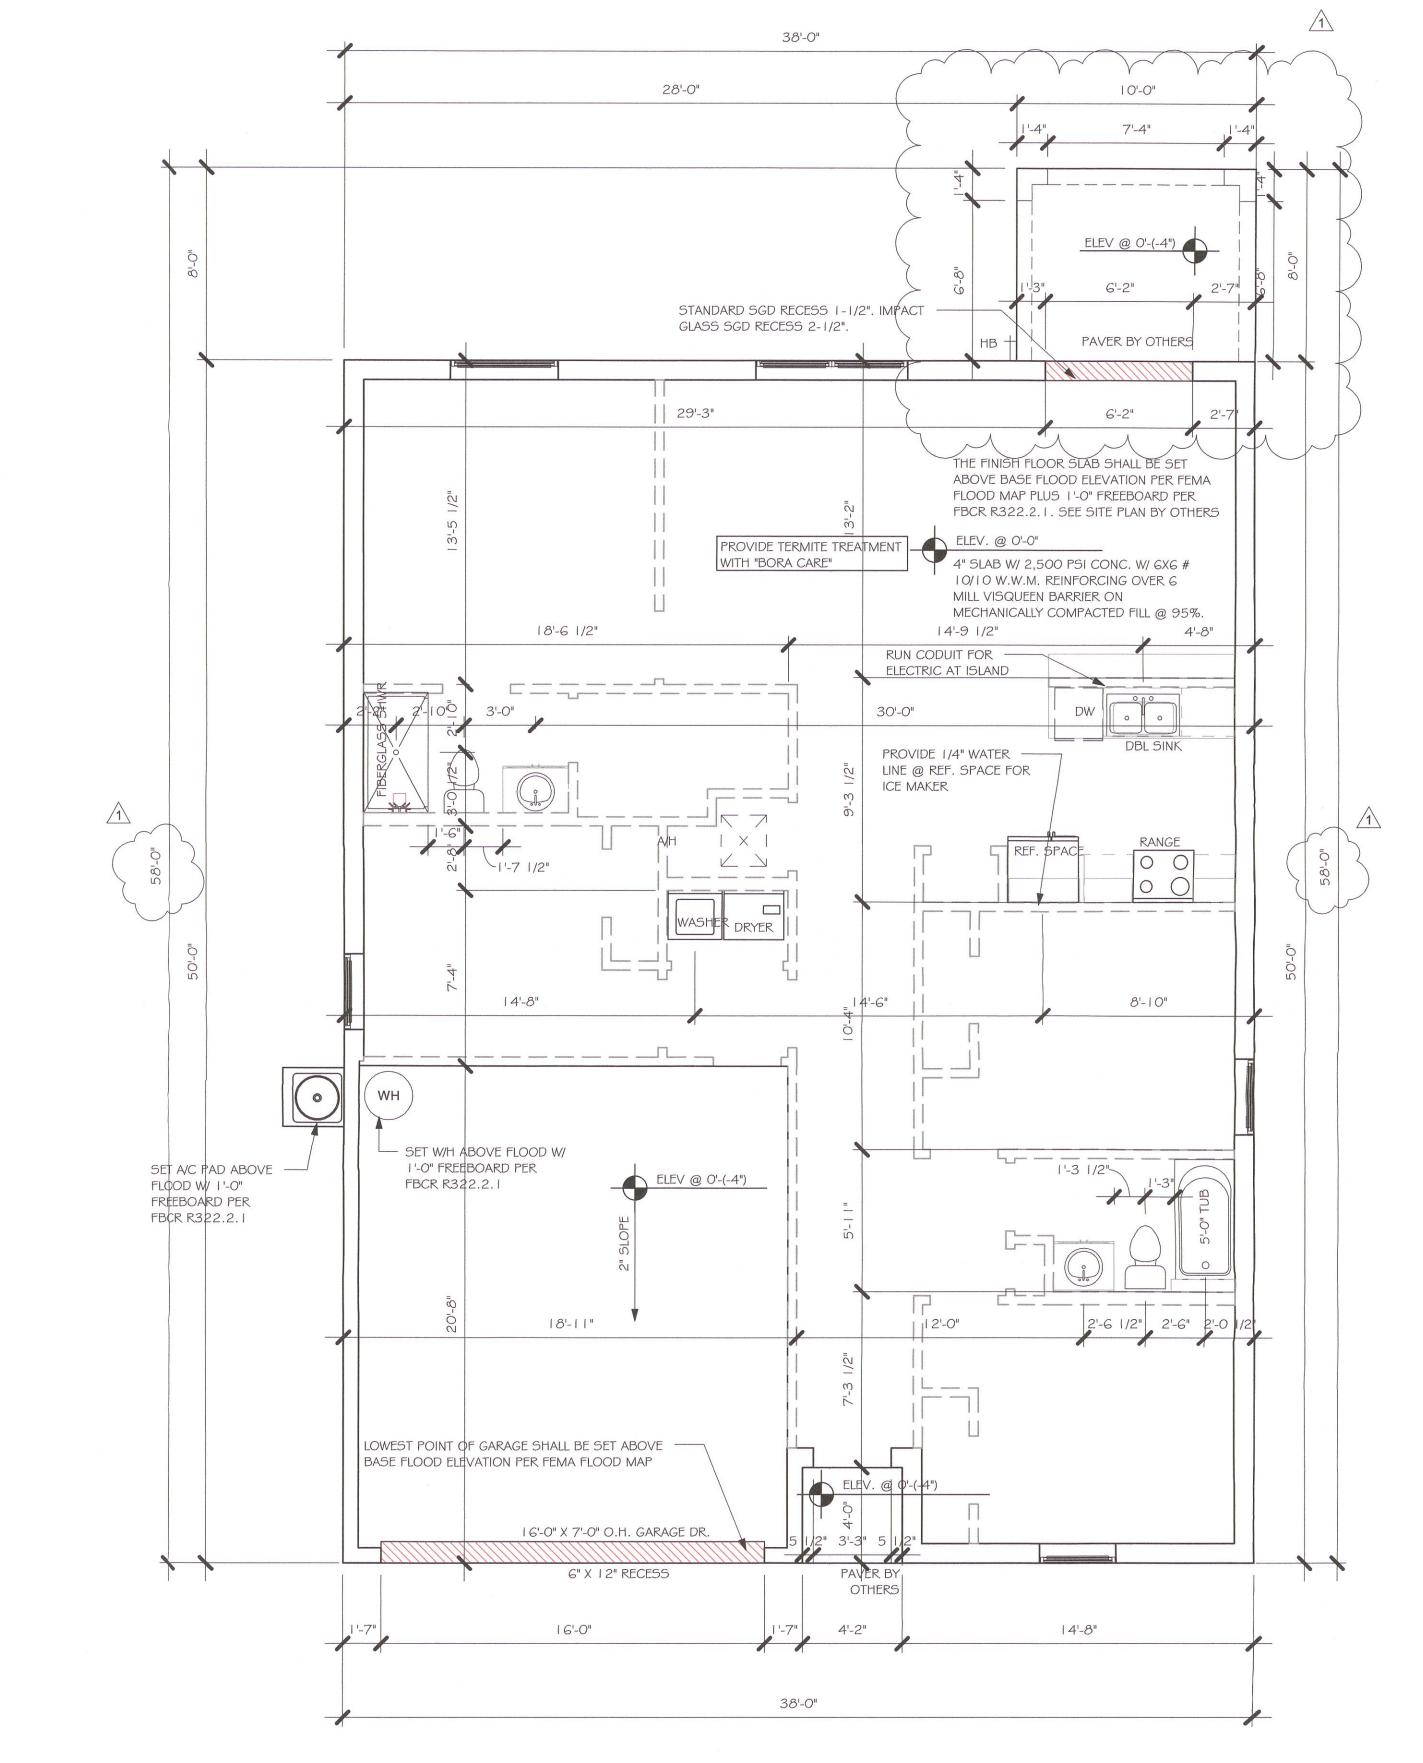

SLAB PLUMBING 1/4" = 1'-0"

> Description Date 02/27/20 CHANGE FROM 1499 ALTO A 1499 AL W/ EXT LANAI. CHANGE STRAPPING FROM USP TO SIMPSON STRONG TIE

DESIGN IN ACCORDANCE WITH THE RESIDENTIAL FLORIDA BUILDING CODE 2017 - 6TH EDITION

As indicated A-2

02/19/19

DRAWN BY:

CHECKED BY:

02/27/20

SLAB & PLUMBING

REVISED:

SCALE:

	DOC	OR SCHE	DULE		
TYPE MARK	DESCRIPTION	MANUFACTURER	HEIGHT	WIDTH	COUNT
1	3068 ENTRY	DISTINCTION	6'-8"	3'-0"	1
2	2-3068 SL. GL. DR.	DISTINCTION	6'-8"	6'-0"	1

7'-0"

16'-0"

GARAGE

	WINDO	N SCH	<b>IEDUL</b>	E
MARK	DESCRIPTION	HEIGHT	WIDTH	COUNT

Α	2-25 SH	5'-3"	6'-4"	1	
В	25 SH	5'-3"	3'-2"	3	
С	35 SH	5'-3"	4'-6"	1	

	OOR HEAD	ERS
6'-8" BI-FOLD	HEADER HEIGHT	82" A.F.F.
6'-8" SWING	HEADER HEIGHT	82 1/2" A.F.F.
8'-0" SWING	HEADER HEIGHT	98 1/2" A.F.F.

16080 OHGD

## PLAN NOTES


- VERIFY ALL ROUGH OPENING DIMENSIONS FOR ALL WINDOWS AND DOORS
- 2) PROVIDE SAFETY GLAZING WITHIN 24" FROM EXIT PER FLORIDA BUILDING CODE R 308.4.2.
- PROVIDE SAFETY GLAZING AT BATH/ SHOWER PER FLORIDA BUILDING CODE R 308.4.5.
- NON BEARING INTERIOR FRAME WALLS SHALL BE FRAMED W/ WOOD OR METAL STUDS. SPACING SHALL NOT EXCEED 24" O.C. (NON BEARING WALLS ONLY)
- PROVIDE DEAD WOOD IN ATTIC FOR OVERHEAD GARAGE DOOR HARDWARE
- KITCHEN KNEE WALL TO BE FRAMED W/ TOP @ 34 1/2" A.F.F.
- INSTALL SMOOTH WALLS IN KITCHEN AND ALL BATHROOM AREAS
- WHERE DRYWALL CEILING IS APPLIED TO TRUSSES @ 24" O.C. USE 5/8" DRYWALL OR 1/2" SAG RESISTANT PER SEC. 702.3.5
- THE GARAGE SHALL BE SEPARATED FROM THE RESIDENCE # ATTIC BY NOT LESS THEN 1/2" GYPSUM BOARD APPLIED TO THE GARAGE SIDE. GARAGES BENEATH HABITABLE ROOMS SHALL BE SEPARATED WITH NOT LESS THAN 5/8" TYPE "X" GYPSUM BOARD OR EQUIVALENT. WHERE THE SEPARATIION IS A FLOOR - CEILING ASSEMBLY, THE STRUCTURE SUPPORTING THE SEPARTION SHALL ALSO BE PROTECTED BY NOT LESS THAN 1/2" GYPSOM BOARD OR EQUIVALENT
- INSTALL I 3/8" THICK SOLID WOOD DOOR BETWEEN LIVING AND GARAGE PER FLORIDA BUILDING CODE R302.1.5.
- 11) ALL WINDOWS INSTALLED 72" ABOVE GRADE MUST COMPLY WITH R612.2 MIN 24" SILL HEIGHT OR PROVIDED WITH AN APPROVED WINDOW FALL PRVENTION DEVICE
- 12) ALL CLOSET SHELVES TO BE 12". ALL PANTRY \$ LINEN TO BE (4)-16" SHELVES 18" O.F.F. W/ 15" INCREMENT.
- 13) ALL MECHANICAL AND ELECTRICAL EQUIPMENT TO BE INSTALLED AT OR ABOVE FLOOD PLUS 1'-0" FREEBOARD.


IN	TERIOR DO	OR SCHEDULE
MARK	DOOR WIDTH	NOTES
	3'-0"	P.K. = POCKET DOOR
2	2'-8"	B.F. = BI-FOLD DOOR
3	2'-6"	B.I. = BI-I OLD DOOR
4	2'-4"	B.P. = BI-PASS DOOR
5	2'-0"	L.V. = LOUVERED DOOR
6	1'-8"	E.V. ECOVERED DOOR
7	1'-6"	
8	2'-11"	

SQUARE FOO	TAGE
LIVING AREA	1499
GARAGE AREA	385
LANAI AREA	80
FRONT PORCH/ ENTRY AREA	16
TOTAL SQUARE FOOTAGE	1,980


	BATHROOM NOTES
TB TOWEL BAR	ALL TUB DECKS @ 21" A.F.F
TP TOILET PAPER	ALL BLOCKING TO BE PT IN SHOWERS
	TOWEL BAR
.O.'4	TOILET PAPER ROLL  14' 4"   MINMIN.

CA	ABINET BACK	<b>SING</b>
KITCHEN	UPPER TOP @ 84"	BASE TOP @ 35"
MASTER BATH	UPPER	BASE TOP @ 35"
GUEST BATH	UPPER	BASE TOP @ 31"
LAUNDRY ROOM	UPPER TOP @ 84"	BASE

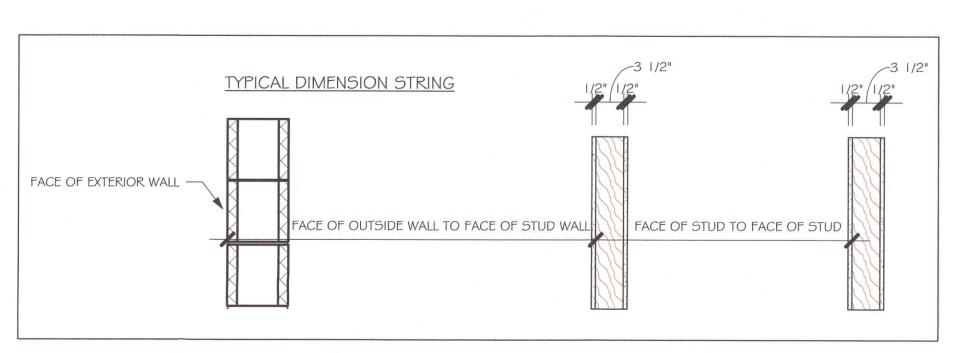

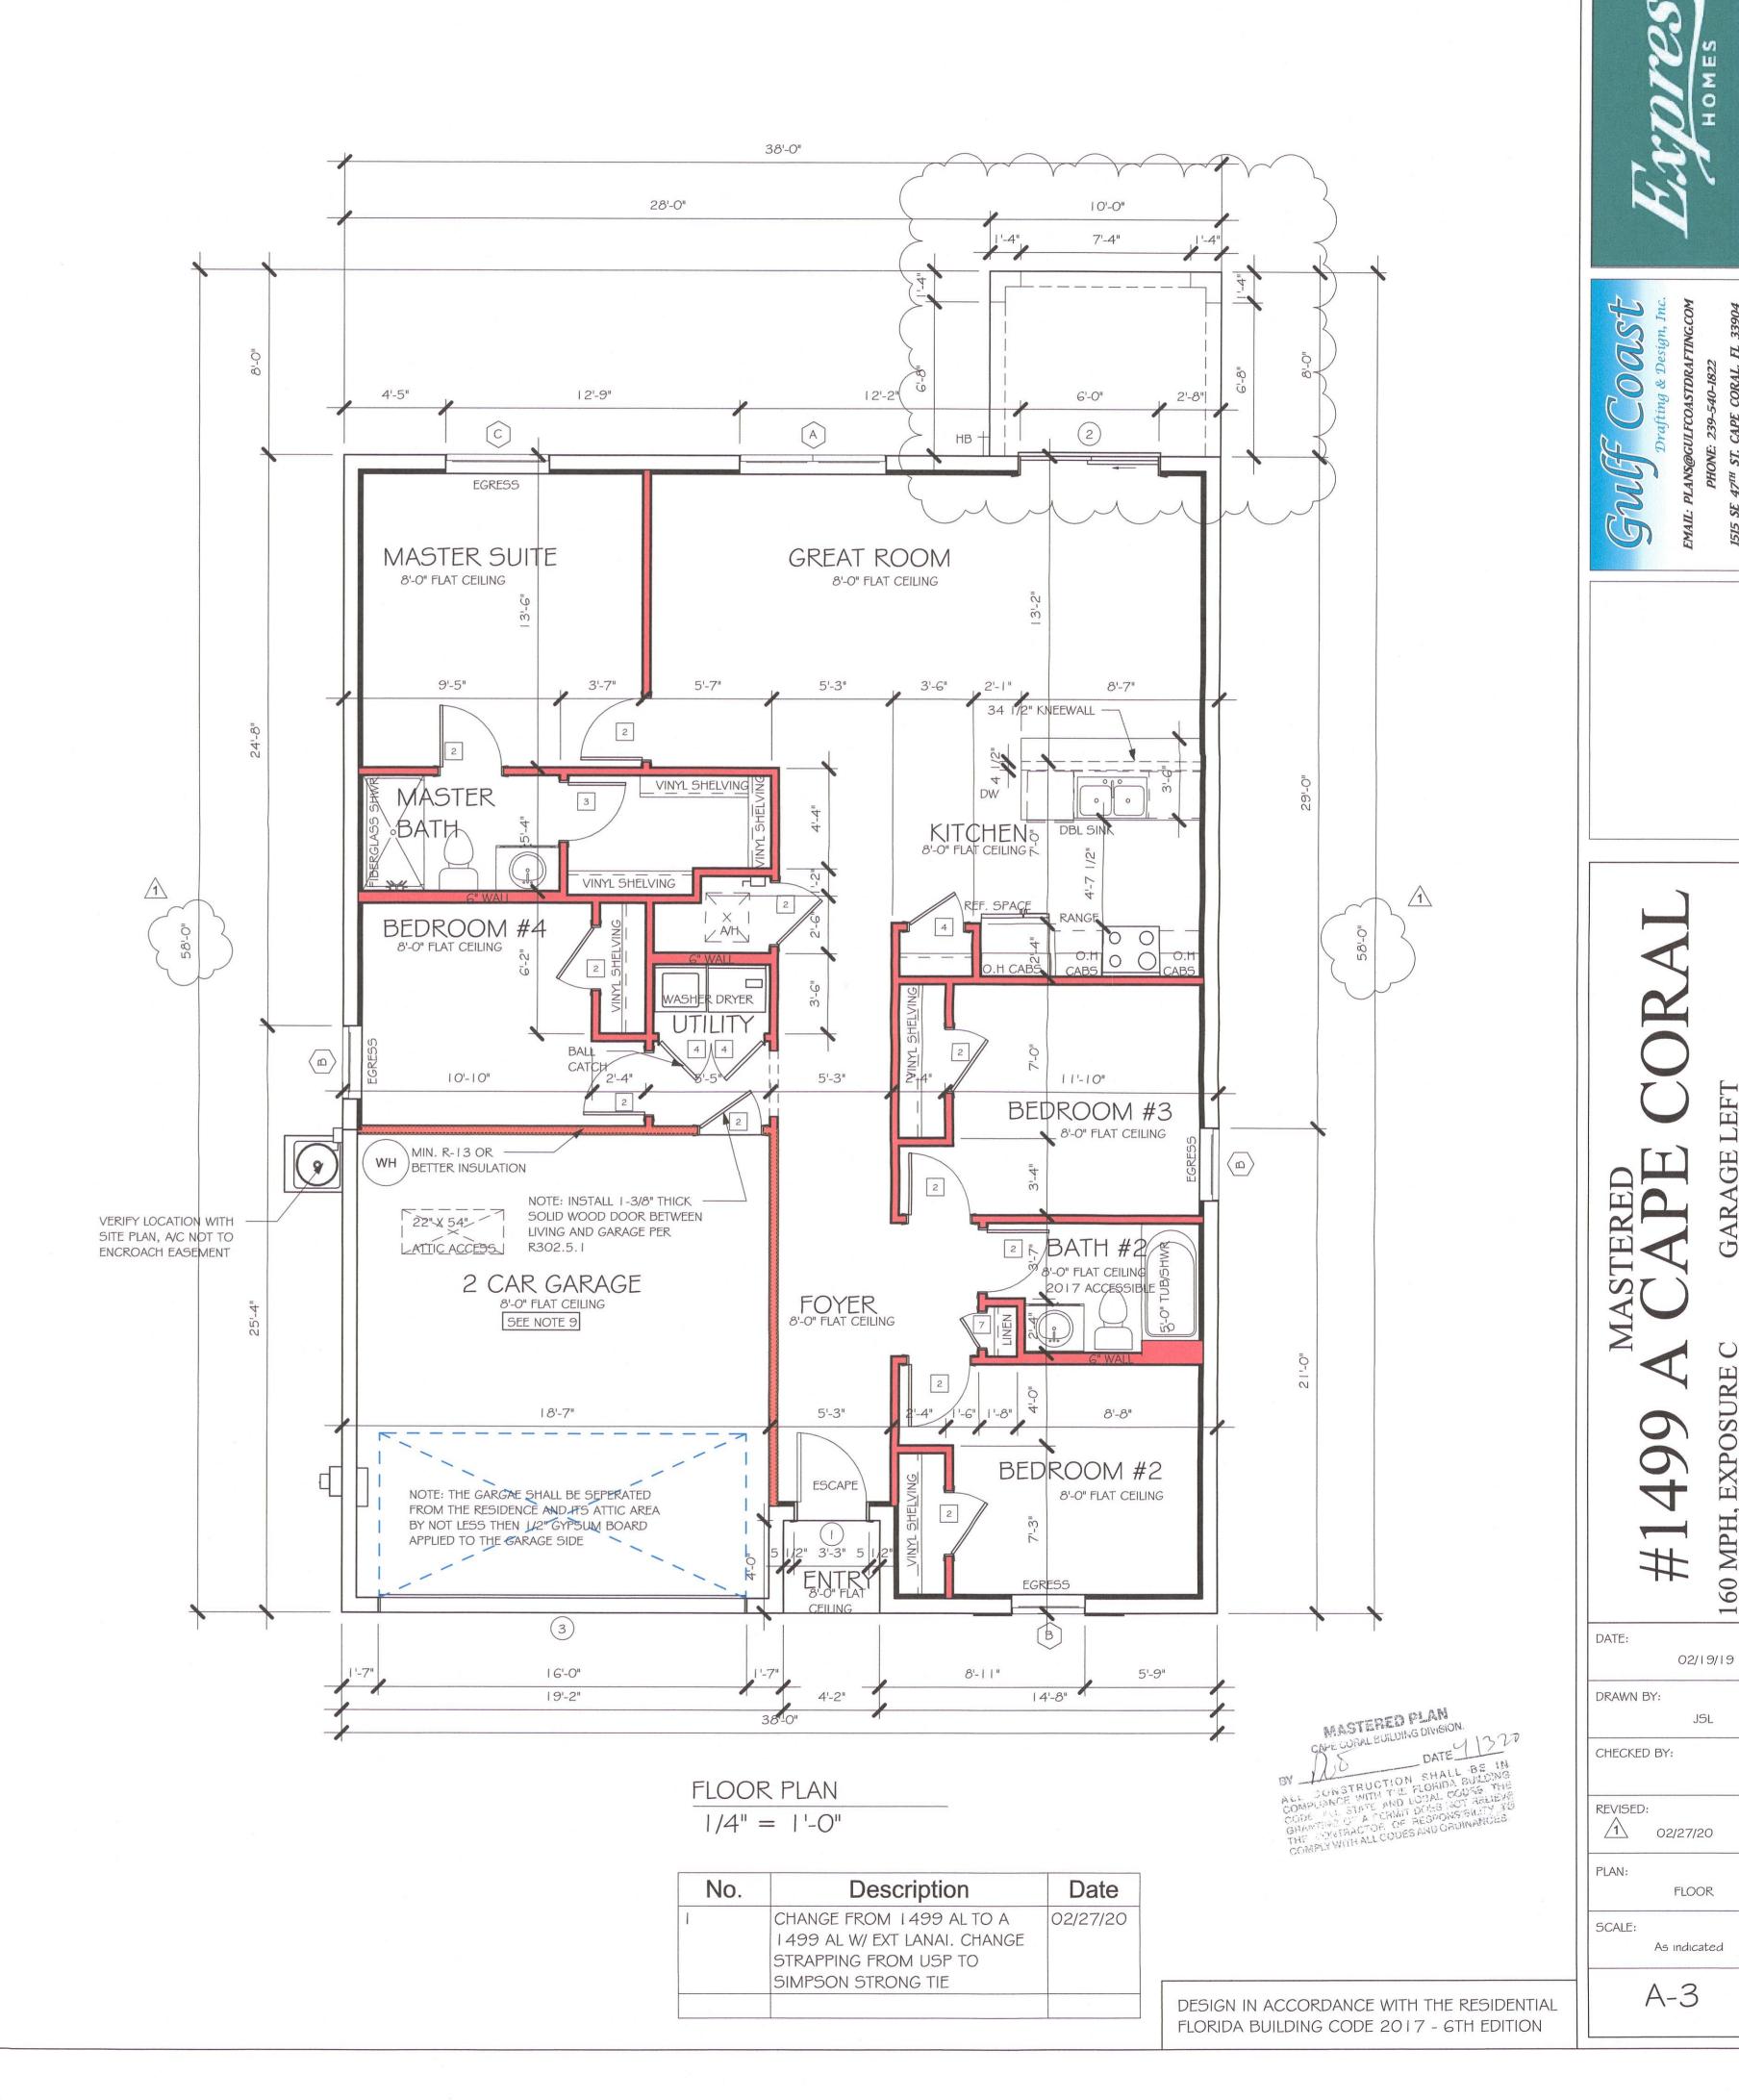


JSL

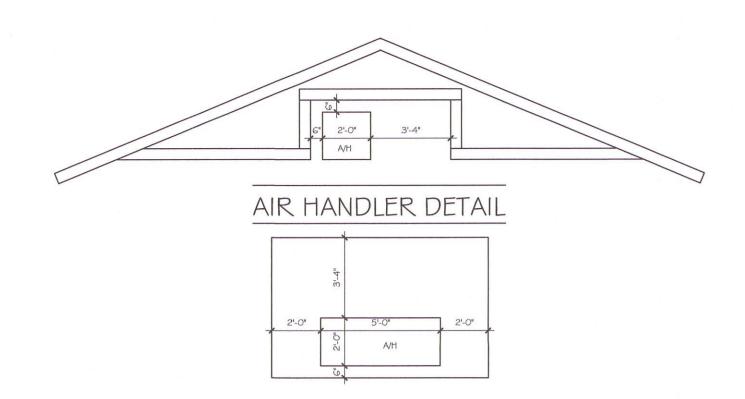

# MODEL 1499 A: ATTIC VENTILATION FBCR R806


	2			SOFFIT ONLY NO ROOF VE		WIT	TH ROOF VE (R.V.)	NTS (1/300)
	AREAS (SQ.	FT.)	ATT	IC VENTILATIO	ON REQUIRED	ATTIC	VENTILATIO	N REQUIRED
MARK	ATTIC	SOFFIT	ATTIC AREA/150	REQ'D AIR FLOW OF SOFFIT	QUAD 4 SOFFIT HAS	ATTIC AREA/300	QUANTITY OF ROOF VENTS	MIN AIR FLOW OF SOFFIT
st STORY	2080.0 SQ. FT.	180.0 SQ. FT.	13.87 SQ.FT.	7.71%	8.15%	SQ. FT.	-	%
			"SOFI	FIT ONLY" QL	JALIFIES	ROOF	VENTS ARE	NOT REQUIRED
			NA	SOFFIT MOD M QUAD 4, F RROW PATTEI I 5% FREE AIR	FULL VENT, RN,	22-3/8" BASE	LOMANCO 7	770-D

BEARING HEIGHT = BEARING @ 8'-0"

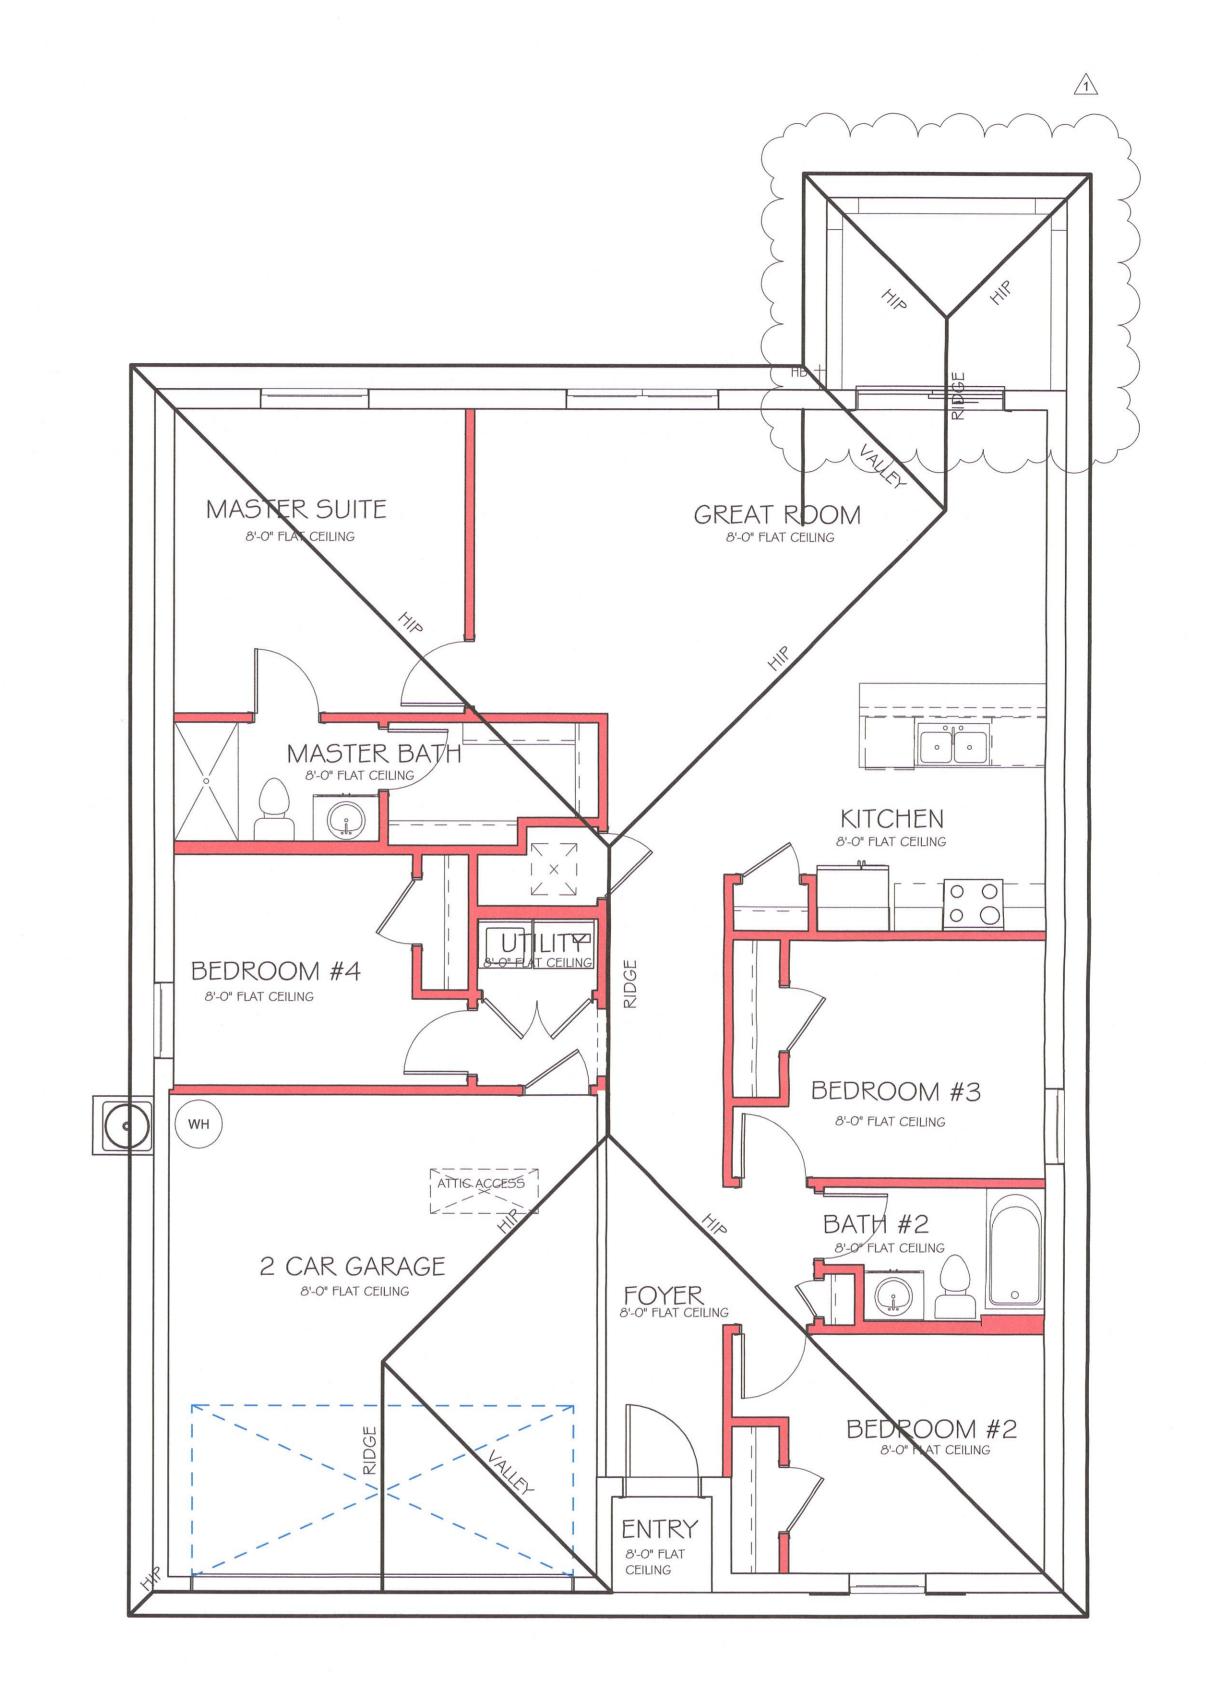

ROOF PLAN 1/4" = 1'-0"

No.	Description	Date
1	CHANGE FROM 1499 AL TO A 1499 AL W/ EXT LANAI. CHANGE	02/27/20
	STRAPPING FROM USP TO SIMPSON STRONG TIE	

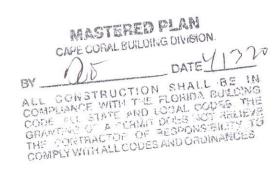

DESIGN IN ACCORDANCE WITH THE RESIDENTIAL FLORIDA BUILDING CODE 2017 - 6TH EDITION

02/27/20 PLAN: ROOF SCALE: As indicated A-4

499

#1

02/19/19

DATE:

DRAWN BY:

CHECKED BY:


REVISED:


LANAI MASTERED CAPE CORALIREVITI I 499 AL W LANAI MASTERED CAP	LANAI MASTERED CAPE.rvt
	MASTERED CAPE CORALIREVITI 1499 AL W LANAI MASTE

	ELECTRICAL METER				
	ELECTRICAL PANEL				
J	I 20 V JUNCTION BOX				
<b>—</b>	SINGLE RECEPTACLE OUTLET				
	220 V RECEPTACLE OUTLET				
	4-PLEX RECEPTACLE OUTLET				
	DUPLEX RECEPTACLE OUTLET				
	1/2 SWITCHED DUPLEX OUTLET				
AFF	DUPLEX RECEPTACLE AT ELEV. A.F.F.				
=	DUPLEX RECEPTACLE - ABOVE COUNTER				
6	SINGLE POLE SWITCH				
<b>↔</b> 3	3 WAY SWITCH				
<b>↔</b> <sup>D</sup>	DIMMER SWITCH				
← M5	MOTION SENSOR SWITCH				
Sp scp	AC/DC SMOKE DETECTOR TO BE INTERCONNECTED ANY RESIDENT HAVING A FOSSIL-BURNING HEATER OR APPLIANCE, A FIREPLACE, OR AN ATTACHED GARAGE SHALL HAVE AN OPERATIONAL CARBON MONOXIDE ALARM INSTALLED WITHIN 10 FEET OF EACH ROOM USED FOR SLEEPING PERPOSES. PER RULE 9B-3.04.72 SD (SMOKE DETECTOR) SCD (CARBON MONOXIDE/ SMOKE DETECTOR)				
	TELEPHONE OUTLET				
-TV	TELEVISION RECEPTION OUTLET				
	SURFACE MOUNTED CEILING LIGHT				
0	FLUSH MOUNTED LIGHT				
Ю	WALL MTD. BRACKET LIGHT				
404	DUPLEX FLOOD LIGHT				
	EXHAUST FAN				
	TRACK MTD. LIGHTS				
D <sub>1</sub>	A/C DISCONNECT				
Ю	PUSH BUTTON (PB) / DOOR BELL (DB)				
(10)	INTERCOM				
	KEYPAD				
	4' FLUORESCENT LIGHT				
)=	2' UNDER COUNTER LIGHT				
PROJECT	OTE: NOT ALL SYMBOLS ARE USED FOR THIS ROJECT. LECTRICAL NOTES:				
ARC-FAU RESISTAI IN DWELL	ARC-FAULT CIRCUIT-INTERRUPTERS AND TAMPER RESISTANT RECEPTACLES SHALL BE INSTALLED N DWELLING UNITS PER N.E.C 210.12 AND 406.11 ALL ELECTRIC, ELECTRICAL EQUIPMENT AND APPLIANCES TO BE SET AT				
ALL OUTL	OR ABOVE BASE FLOOD ELEVATIONS PLUS 1'-0" FREEBOARD.  ALL OUTLETS IN WET AREAS AND ALL  EXTERIOR OUTLETS TO BE GFI'S.				
INSTALL	INSTALL PHONE AND T.V PER CONTRACT.				


INSTALL ALL ELECTRICAL PER NEC 2014


ELECTRICAL LEGEND

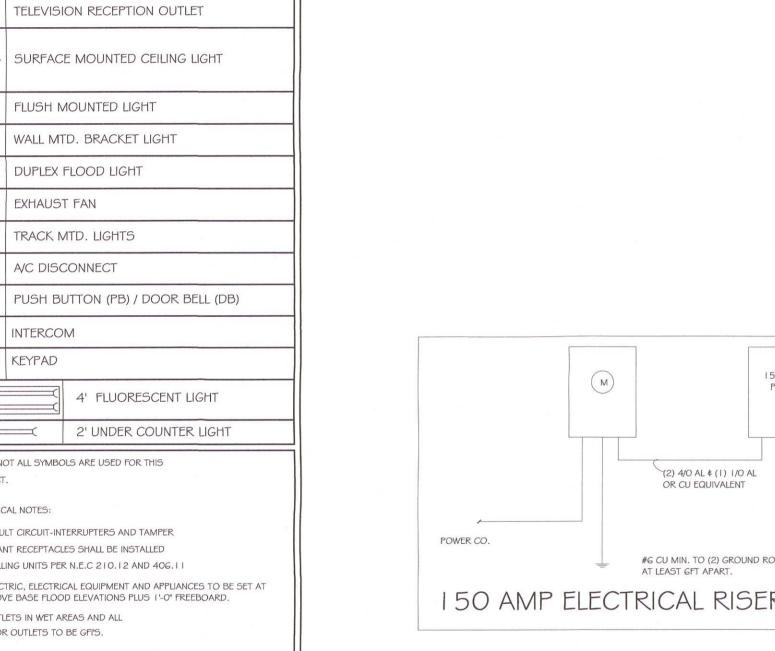

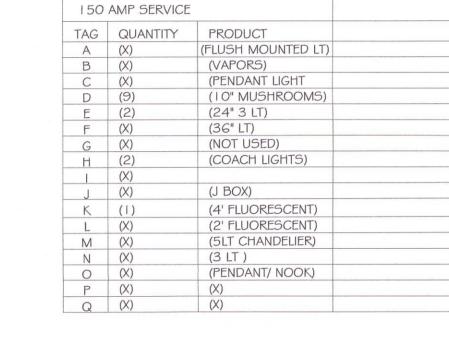

ELECTRICAL PLAN

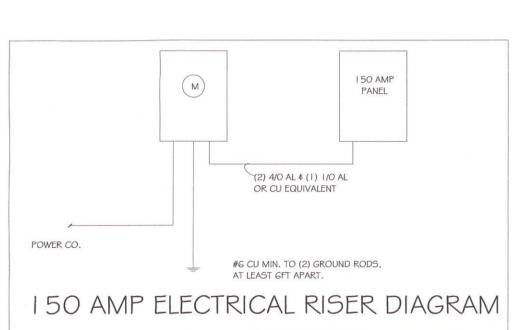

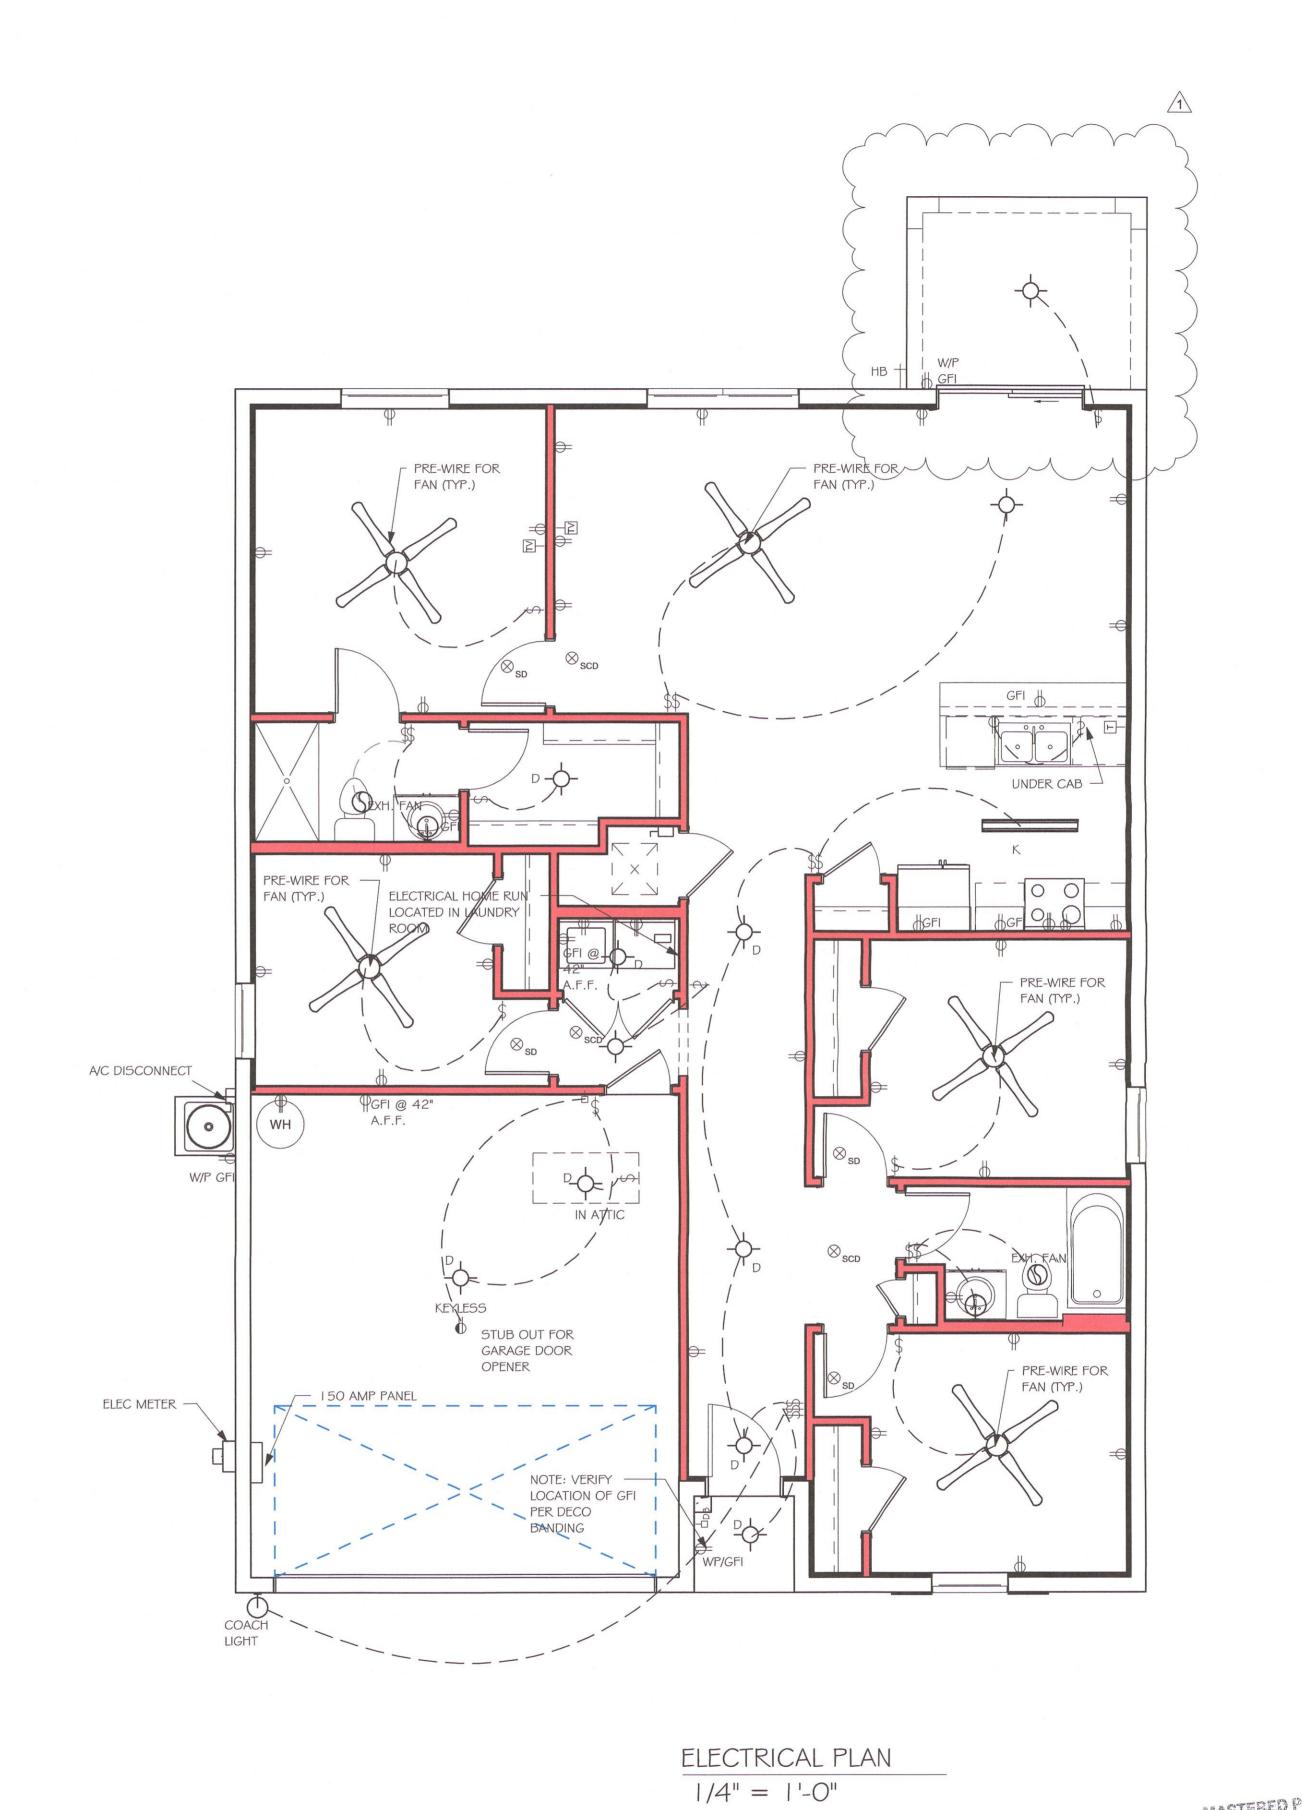

Date Description CHANGE FROM 1499 ALTO A 02/27/20 1499 AL W/ EXT LANAI. CHANGE STRAPPING FROM USP TO SIMPSON STRONG TIE

DESIGN IN ACCORDANCE WITH THE RESIDENTIAL FLORIDA BUILDING CODE 2017 - 6TH EDITION

02/27/20 PLAN: ELECTRICAL SCALE: As indicated

DATE:


DRAWN BY:

CHECKED BY:


REVISED:

02/19/19


A-5

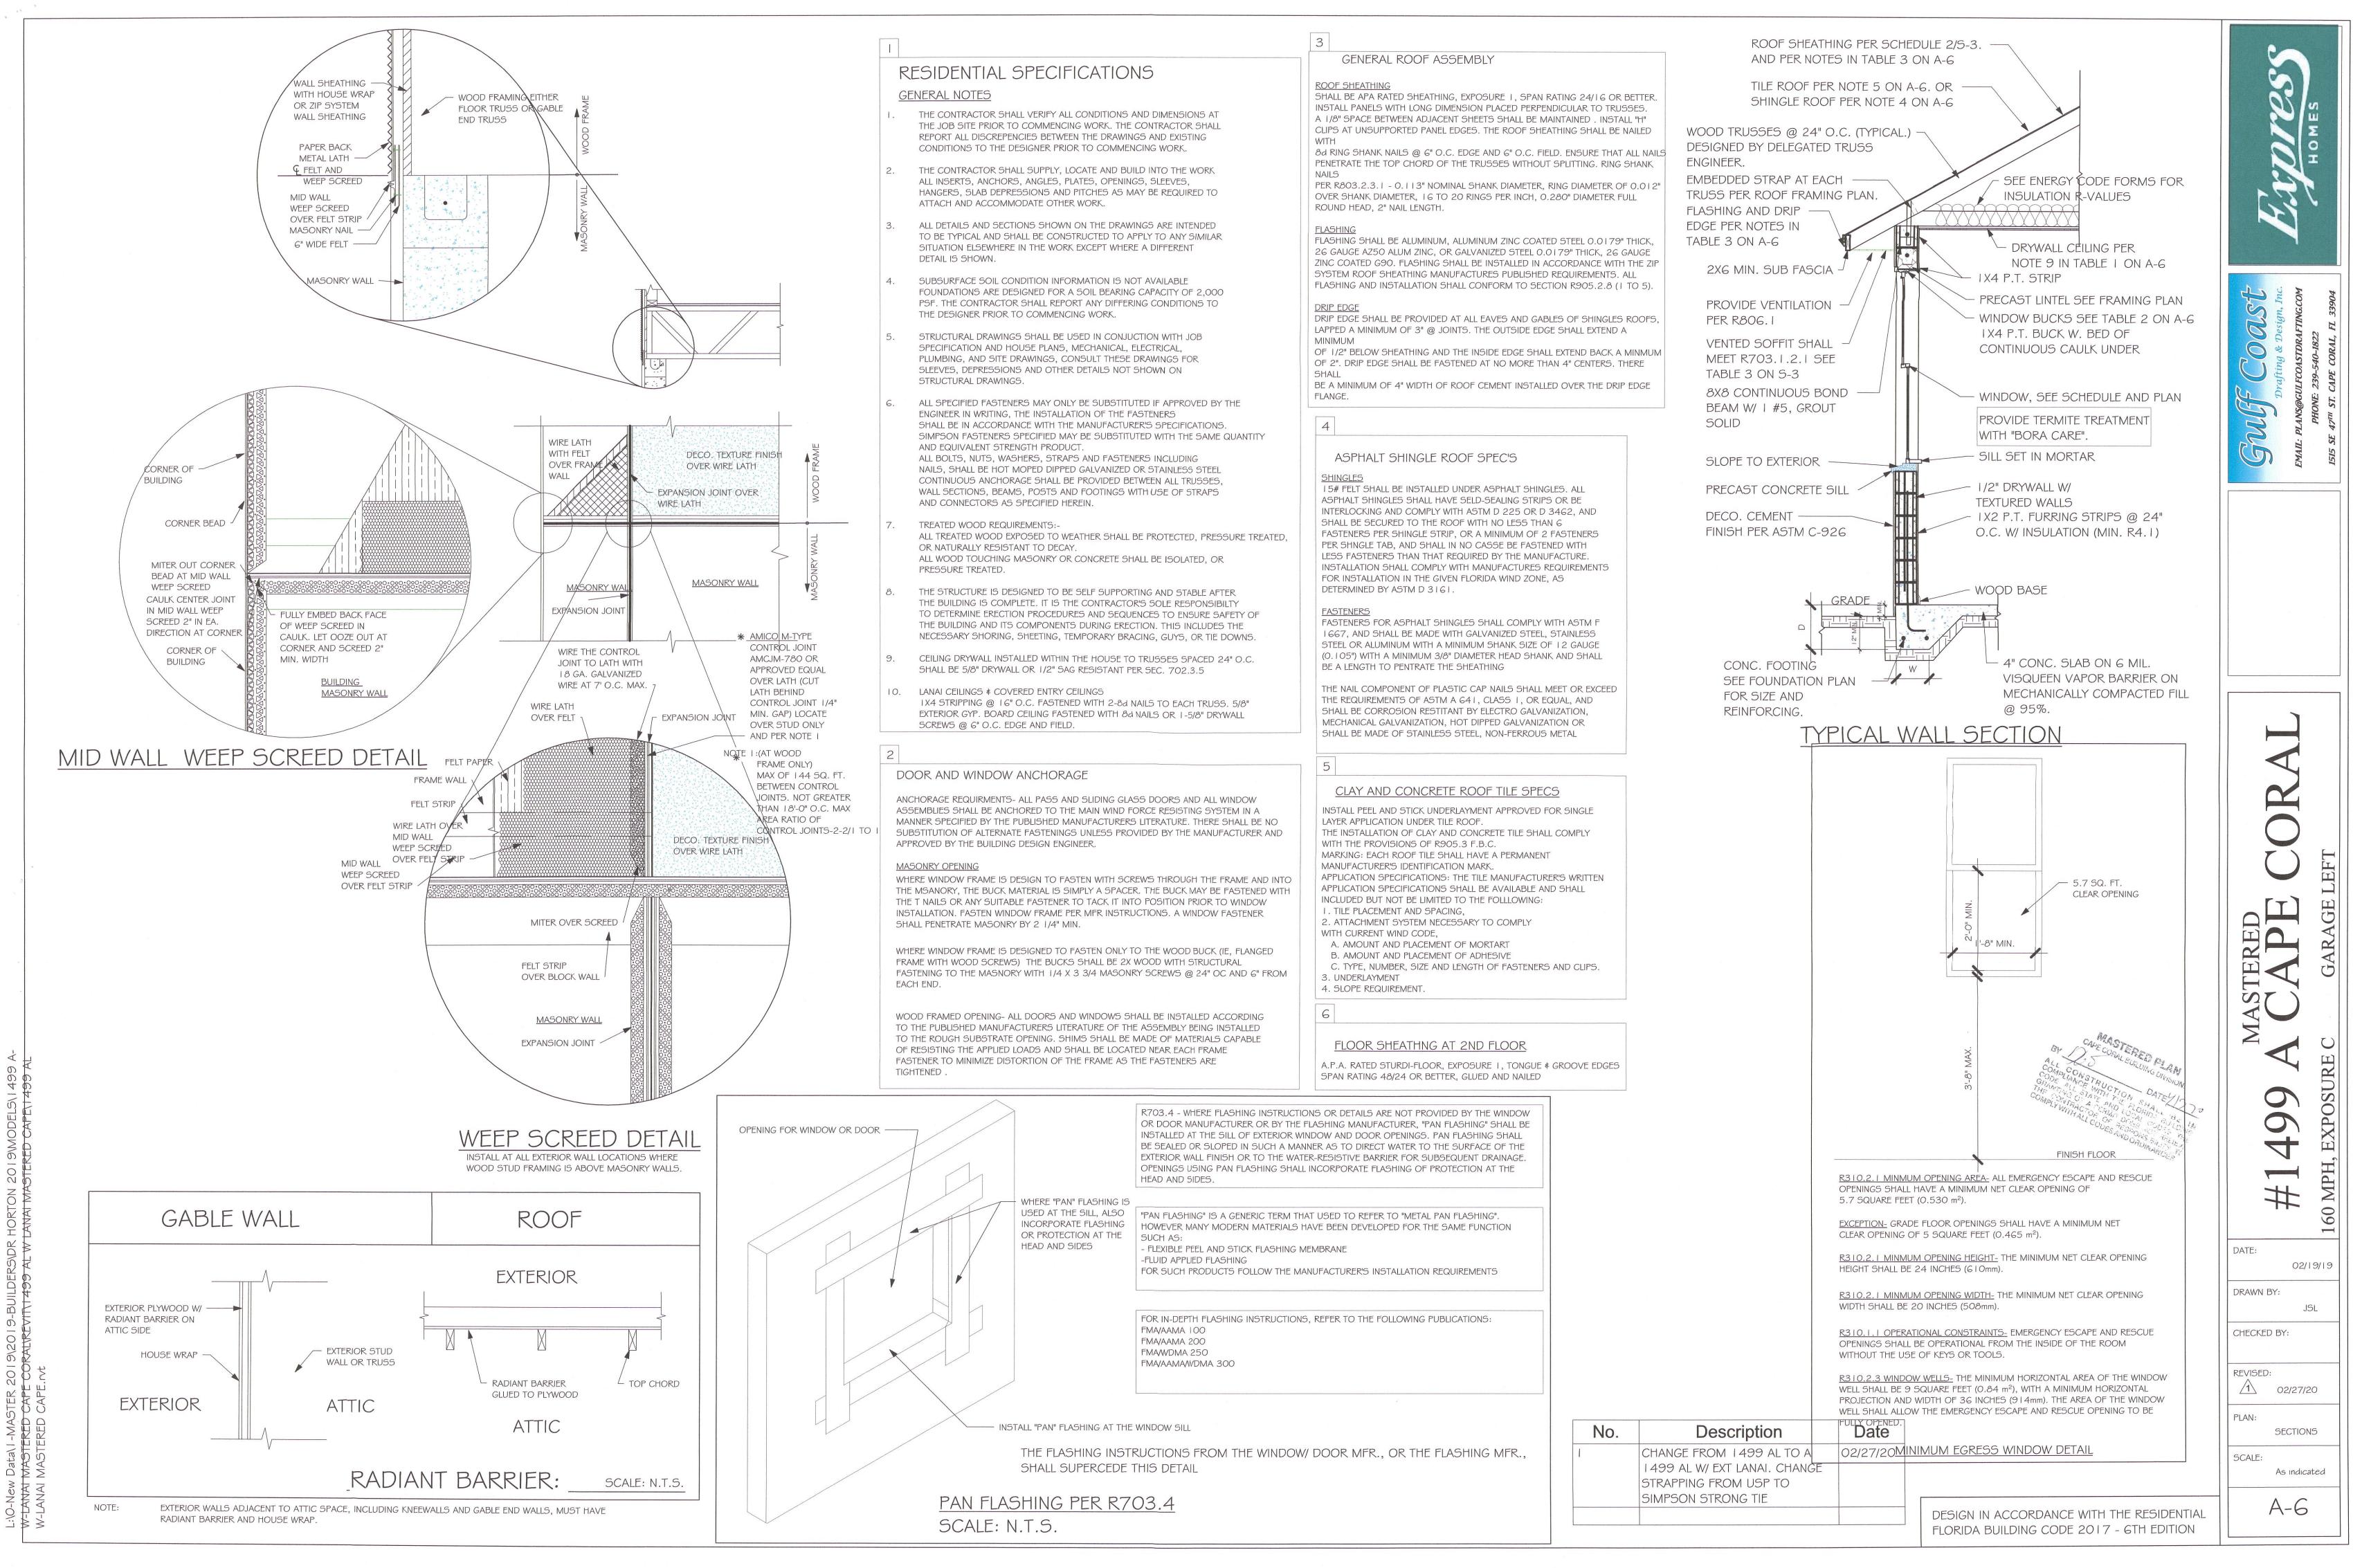




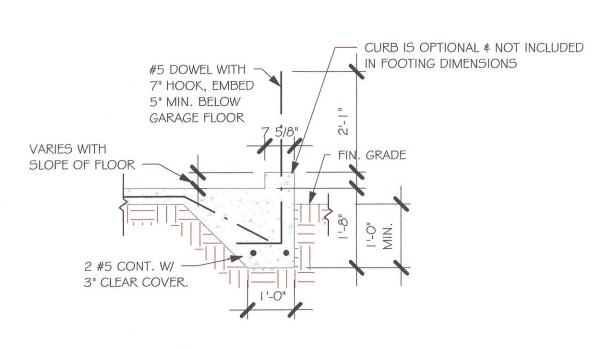


"F3" WITH CURB AT GARAGE 1/2" = 1'-0"

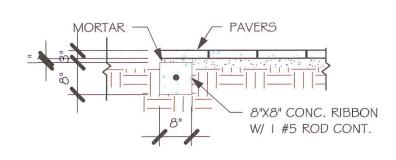

"P" PAVERS DETAIL ENTRY/ LANAI I 1/2" = 1'-0"

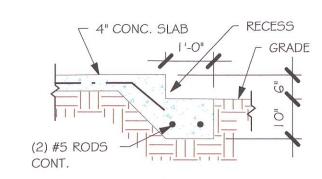

GARAGE DOOR RECESS 1/2" = 1'-0"

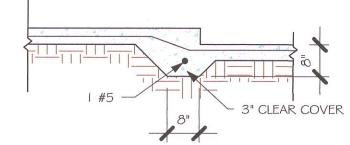


 $\frac{\text{"F6A" STEP DOWN}}{1/2\text{"} = 1\text{'-0"}}$ 



	PAD FOOTING SCHEDULE						
USED	TYPE L	LENGTH	LENGTH WIDTH	DEPTH	BOTTOM REINF.		DEMARKO
ns		LENGTH			LONG WAY	SHORT WAY	REMARKS
X	$\langle \mathbf{A} \rangle$	2'-6"	2'-6"	1'-0"	3-#5	3-#5	-
	B	3'-0"	3'-0"	1'-0"	4-#5	4-#5	-
	<b>(c)</b>	3'-6"	3'-6"	1'-0"	4-#5	4-#5	-
	D	4'-0"	4'-0"	1'-2"	5-#5	5-#5	-
	(E)	5'-0"	5'-0"	1'-2"	6-#5	6-#5	-

	WA	LL FO	OTING	SCH	HEDULE		
USED	TYPE	LENGTH	WIDTH	DEPTH	BOTTOM REINFORCING	SHAPE	
	F1	CONT.	1'-4"	0'-8"	2-#5		
	F2	CONT.	1'-8"	0'-10"	2-#5		
X	F3	CONT.	1'-0"	1'-8"	2-#5		ADD CURB TO GARAGE, SEE DETAIL
	F4	CONT.	1'-4"	1'-8"	2-#5		DETAIL
	F5	CONT.	1'-4"	1'-0"	2-#5	<b>F</b>	
	F6	CONT.	1'-4"	1'-0"	2-#5		
X	F6A	CONT.	0'-8"	0'-8"	1-#5		
	-						

FC	DUNDATION PLAN
SCAL	_E: 3/16" = 1'-0"
PLAN	NOTES:
1.	TOP OF GROUND FLOOR SLAB DATUM ELEVATION 0'-0"
2.	"F#" DENOTES CONTINUOUS WALL FOOTING TYPE PER SCHEDULE THIS SHEET.
3.	(#) DENOTES PAD FOOTING AT CONCENTRATED LOADS PER SCHEDULE THIS SHEET.
4.	PROVIDE #5 VERTICAL REINFORCING AT DOT LOCATIONS SHOWN ON PLAN FROM FOOTIN
	TO BOND BEAM.
5.	ALL DIMENSIONS ARE TO OUTSIDE FACE OF MASONRY WALLS. SOME SLAB EDGES MAY
	EXTEND BEYOND FACE OF WALL.
6.	FOR DIMENSIONS OF ROUGH OPENINGS IN MASONRY WALLS, COORDINATE WITH WINDON

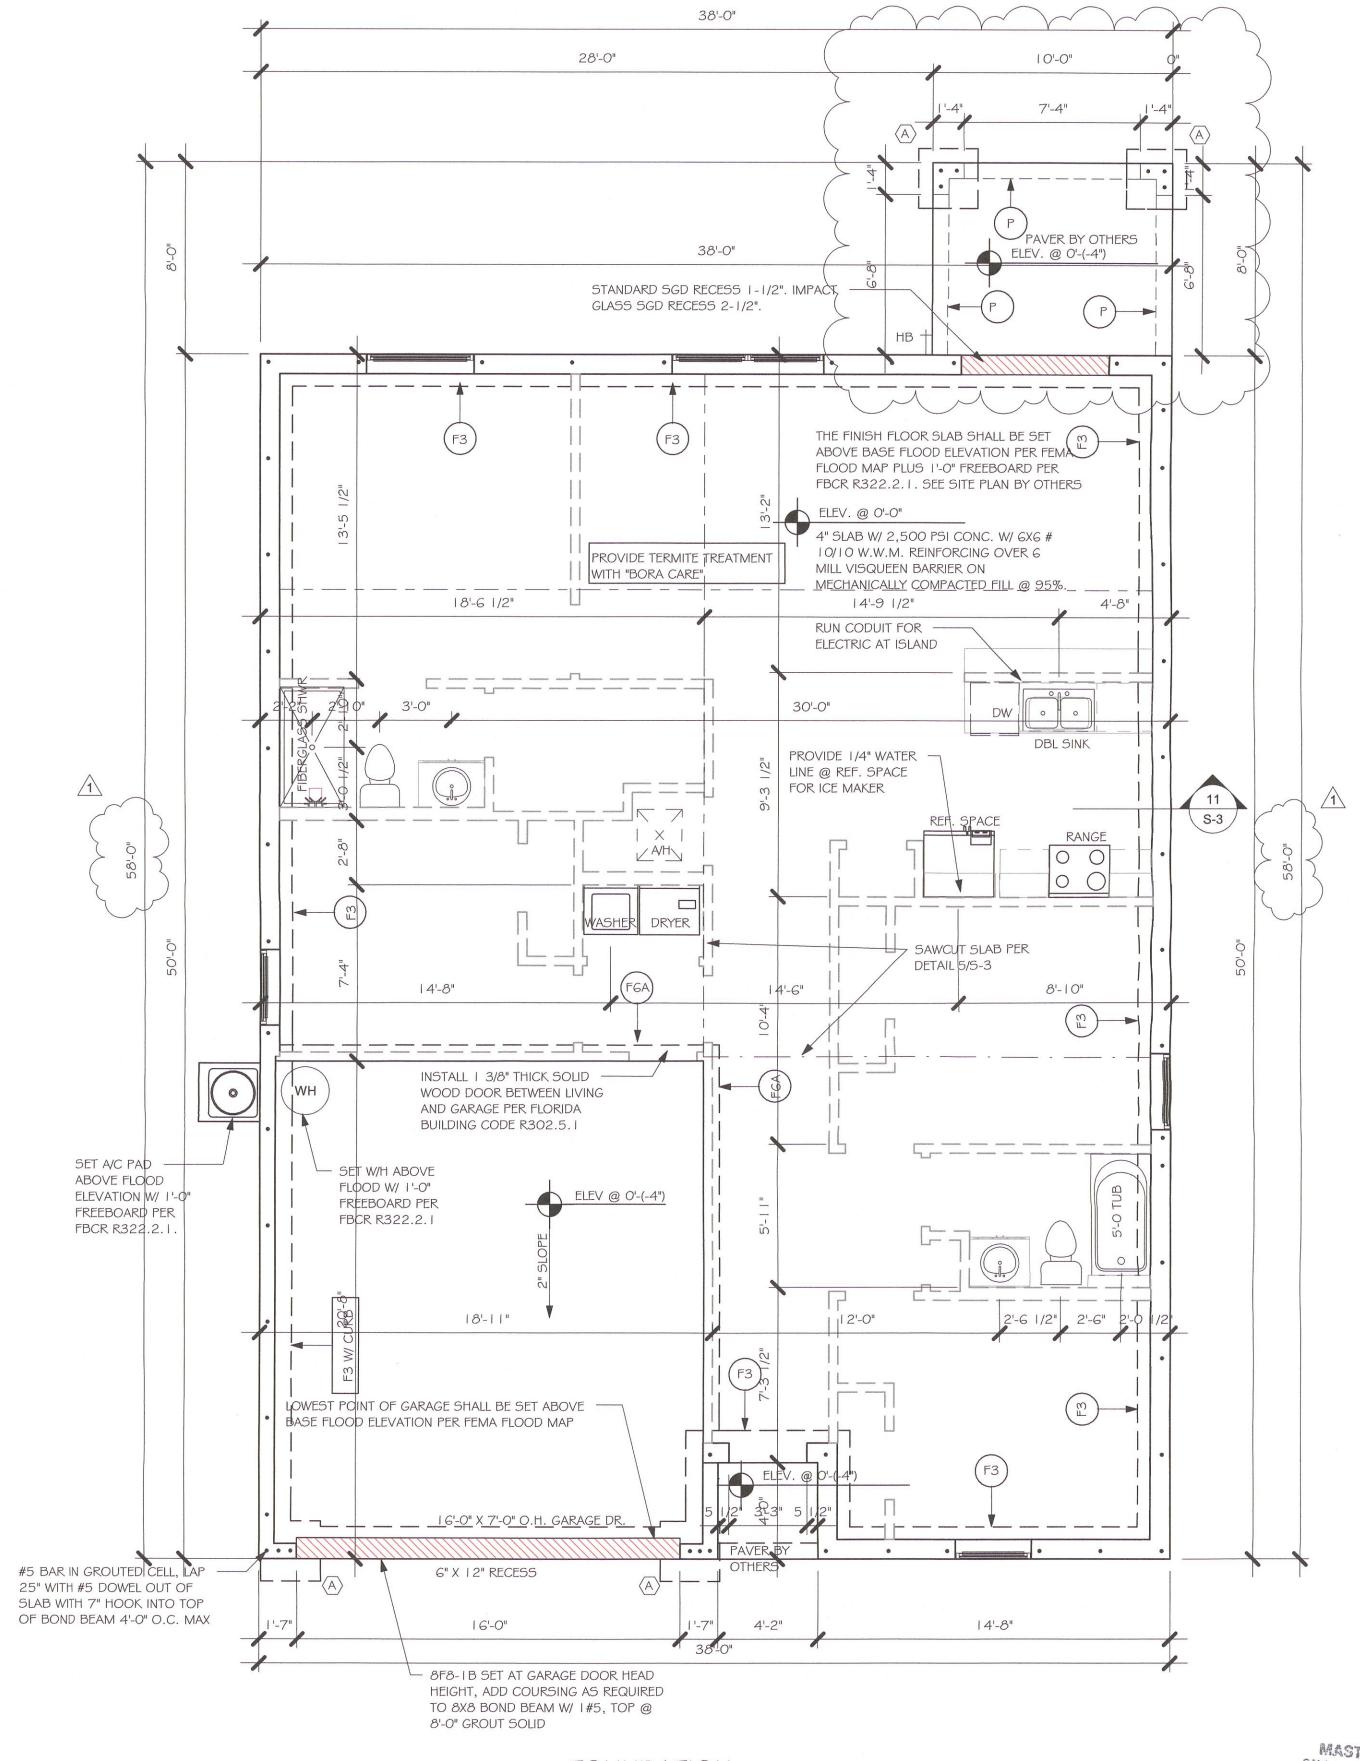

Date Description 02/27/20 CHANGE FROM 1499 ALTO A 1499 AL W/ EXT LANAI. CHANGE STRAPPING FROM USP TO SIMPSON STRONG TIE

MASTERED PLAN CAME CORAL BUILDING DIVISION. ALL CONSTRUCTION SHALL BE IN COMPLIANCE WITH THE FLORIDA BUILDING GRANTING OF A FERMIT DOLES BOY RELIES OF STRUCTURE COMERACION OF BERRONS BUILDING OF BERRONS BUILDING OF BERRONS BUILDING

DESIGN IN ACCORDANCE WITH THE RESIDENTIAL FLORIDA BUILDING CODE 2017 - 6TH EDITION

FOUNDATION 1/4" = 1'-0" DOOR SUPPLIER. PROVIDE PRESSURE TREATED BUCKS AT WINDOWS/ DOORS PER DETAIL 7/S-3. TE CONT. 0'-8" 0'-8" 1-#5 🖂 PROVIDE CORNER BARS PER 6/S-3

02/19/19 JSL

DRAWN BY: CHECKED BY:


REVISED: 02/27/20 PLAN:

FOUNDATION PLAN SCALE: As indicated

NOTES:

- I. PROVIDE A STRAP FROM THE ABOVE LIST AT EACH ROOF TRUSS BEARING POINT, BASED ON THE TRUSS UPLIFT VALUES IN THE SIGNED AND SEALED TRUSS DESIGN PACKAGE AND SUITABLE FOR THE GEOMETRY. EMBED STRAP ON -C OF WALL.
- CONNECTORS ARE SIMPSON STRUCTURAL CONNECTORS. ALL CONNECTORS SHALL BE INSTALLED IN STRICT ACCORDANCE WITH SIMPSON PRINTED INSTUCTIONS. SUBSTITUTIONS MUST BE APPROVED IN WRITING BY THE ENGINEER OF RECORD.
- WHERE EMBEDDED STRAPS ARE MISSING, OR MIS-LOCATED, INSTALL RETROFIT STRAP PER

R4-021020

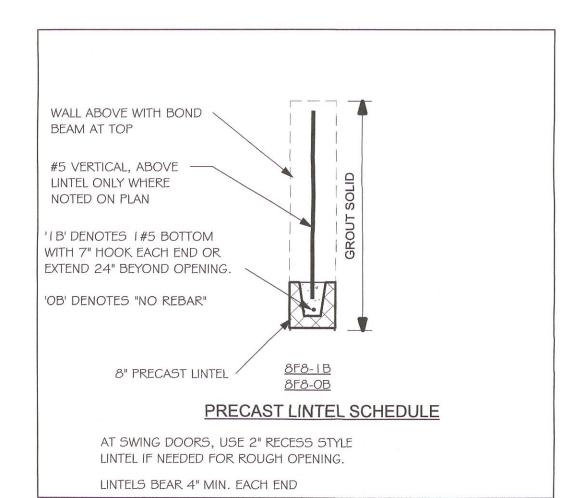


## PLAN NOTES:


- ROOF TRUSS BEARING 8'-0", SEE LEGEND. ROOF FRAMING SHALL BE WOOD TRUSSES DESIGNED BYA DELEGATED TRUSS ENGINEER PER DESIGN CRITERIA ON SHEET S-3.
- PROVIDE STRAPPING AT TRUSSES PER NOTES ON THIS
- FOR NAILING OF ROOF AND FLOOR DECK, SEE I AND 2
- 8F8-1B etc., DENOTES PRECAST LINTEL ABOVE DOORWINDOW OPENING PER SCHEDULE THIS SHEET.
- AT TRUSS BEARING, PROVIDE 8x8 MASONRY BOND BEAM W/ I #5 CONTINUOUS, SEE DETAIL I I/S-3.

BEARING HEIGHT

= BEARING @ 8'-0"

TRUSS BEARING CONDITIONS AND STRAPPING IS BASED ON TRUSS LAYOUT PREPARED BY SCOSTA JOB# 44116L DATED: 12/12/19 REVISED: NONE

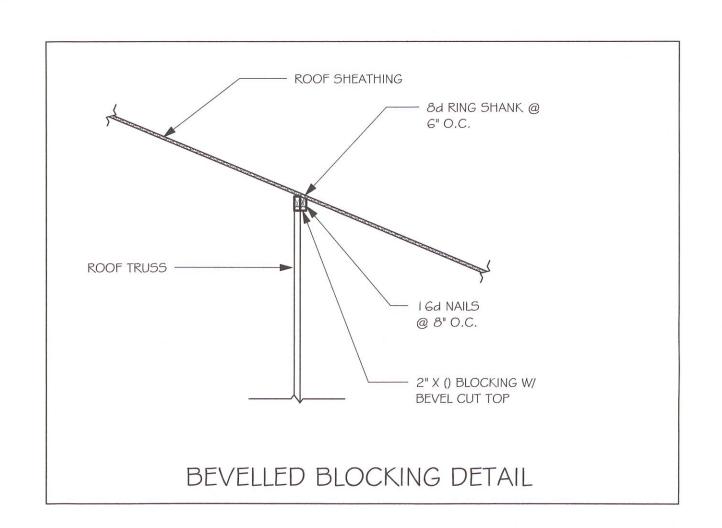

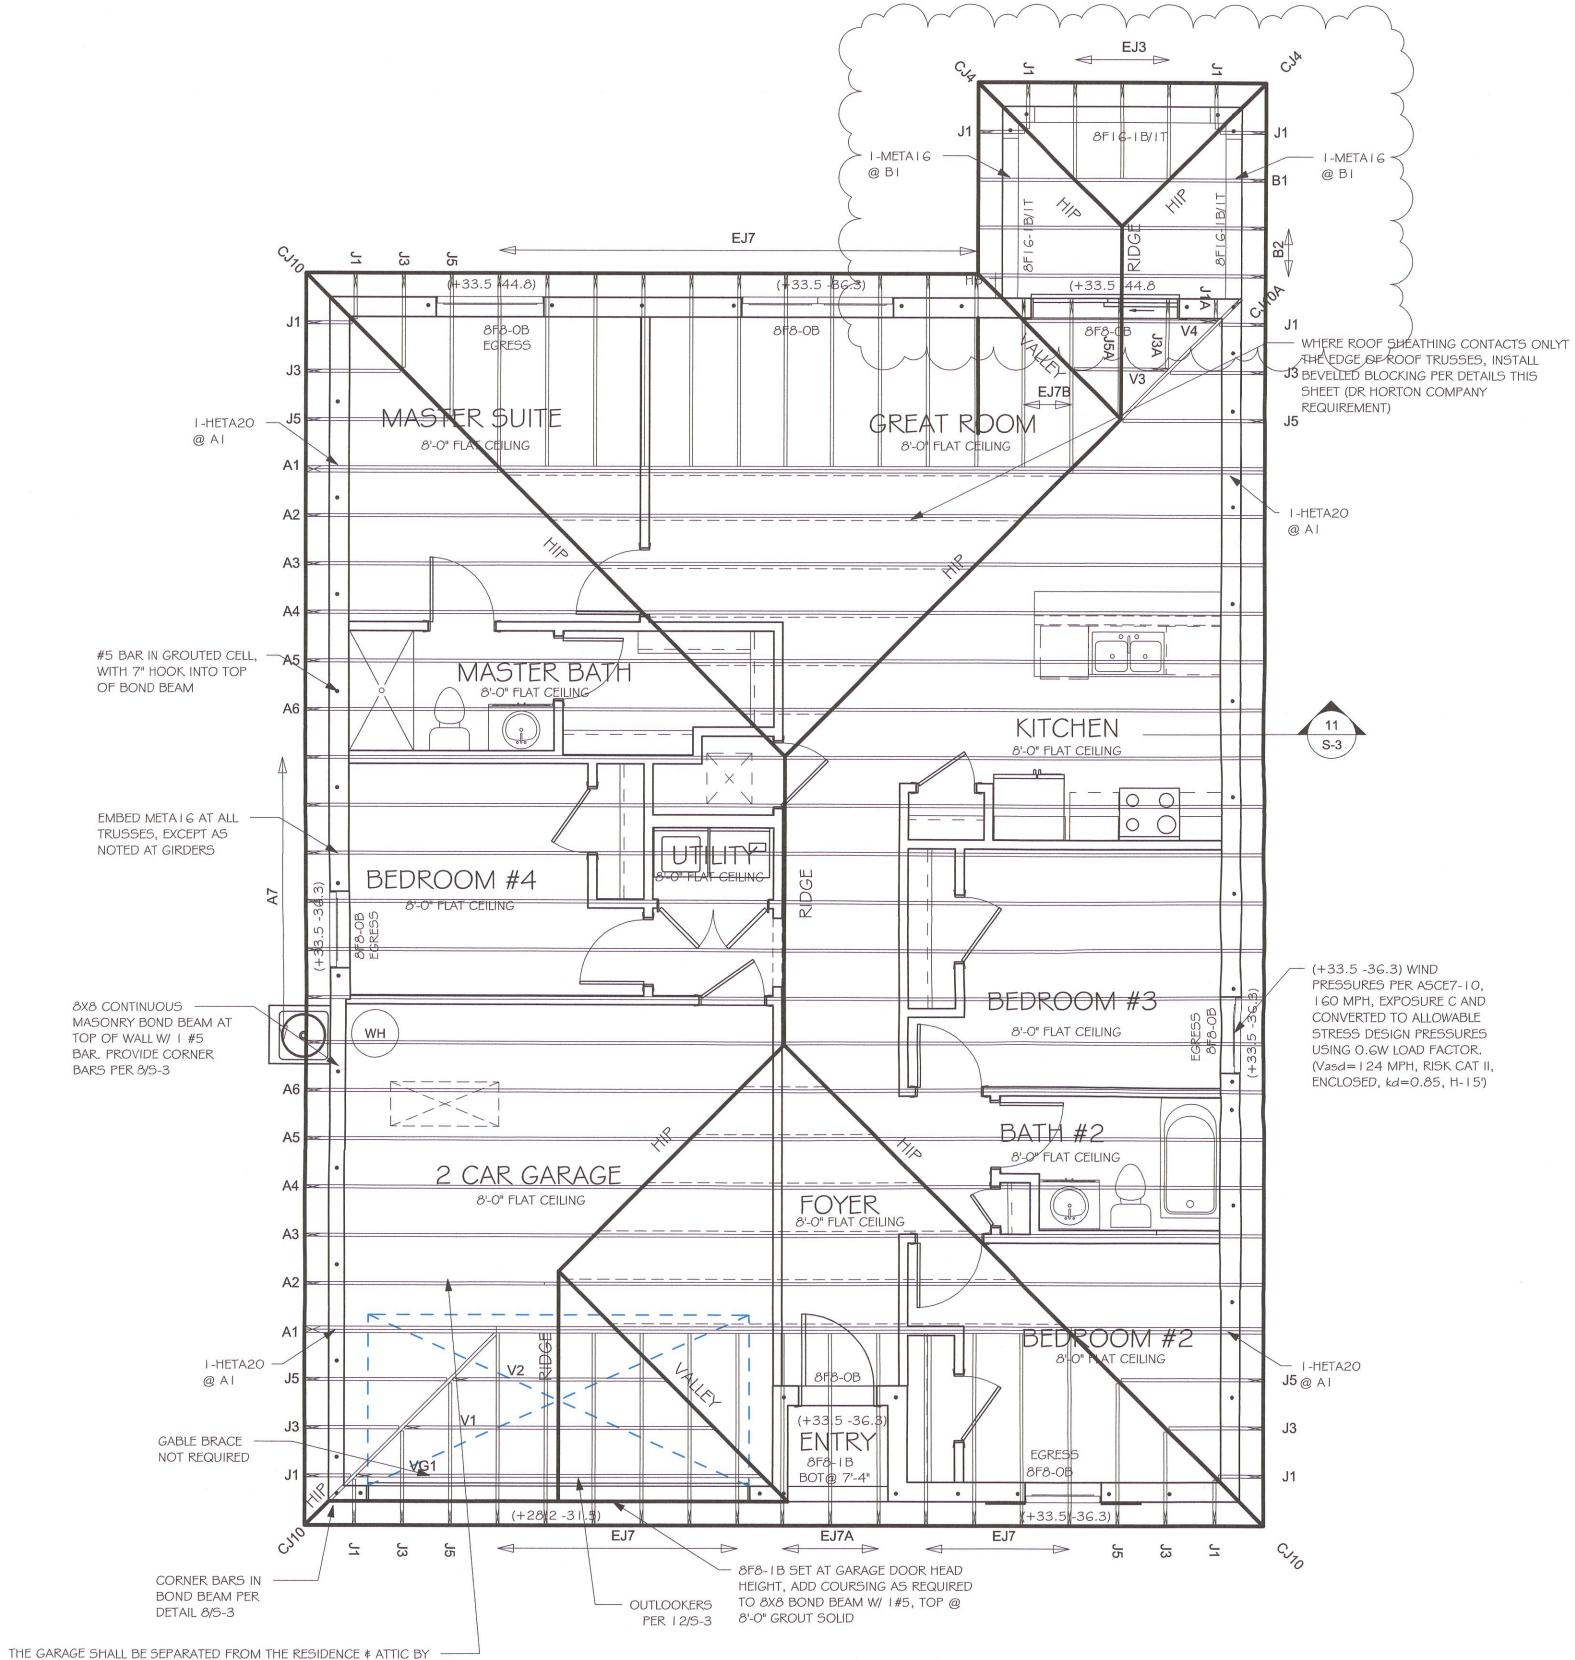

NOT LESS THEN 1/2" GYPSUM BOARD APPLIED TO THE GARAGE SIDE. GARAGES BENATH HABITABLE ROOM SHALL BE SEPARATED WITH NOT LESS THAN 5/8" TYPE "X" GYPSUM BOARD OR EQUIVALENT. WHERE THE SEPARATION IS A FLOOR- CEILING ASSEMBLY THE STRUCTURE SUPPORTING THE SEPARATION SHALL ALSO BE PROTECTED BY NOT LESS THAN 1/2" GYPSUM BOARD OR EQUIVALENT

ROOF FRAMING PLAN 1/4" = 1'-0"

> No. Date Description CHANGE FROM 1499 AL TO A 02/27/20 1499 AL W/ EXT LANAI. CHANGE STRAPPING FROM USP TO

Mastered Plan

SIMPSON STRONG TIE

DESIGN IN ACCORDANCE WITH THE RESIDENTIAL FLORIDA BUILDING CODE 2017 - 6TH EDITION

As indicated

#

02/19/19

JSL

DATE:

DRAWN BY:


CHECKED BY:

1 02/27/20

ROOF FRAMING PLAN

REVISED:

SCALE:

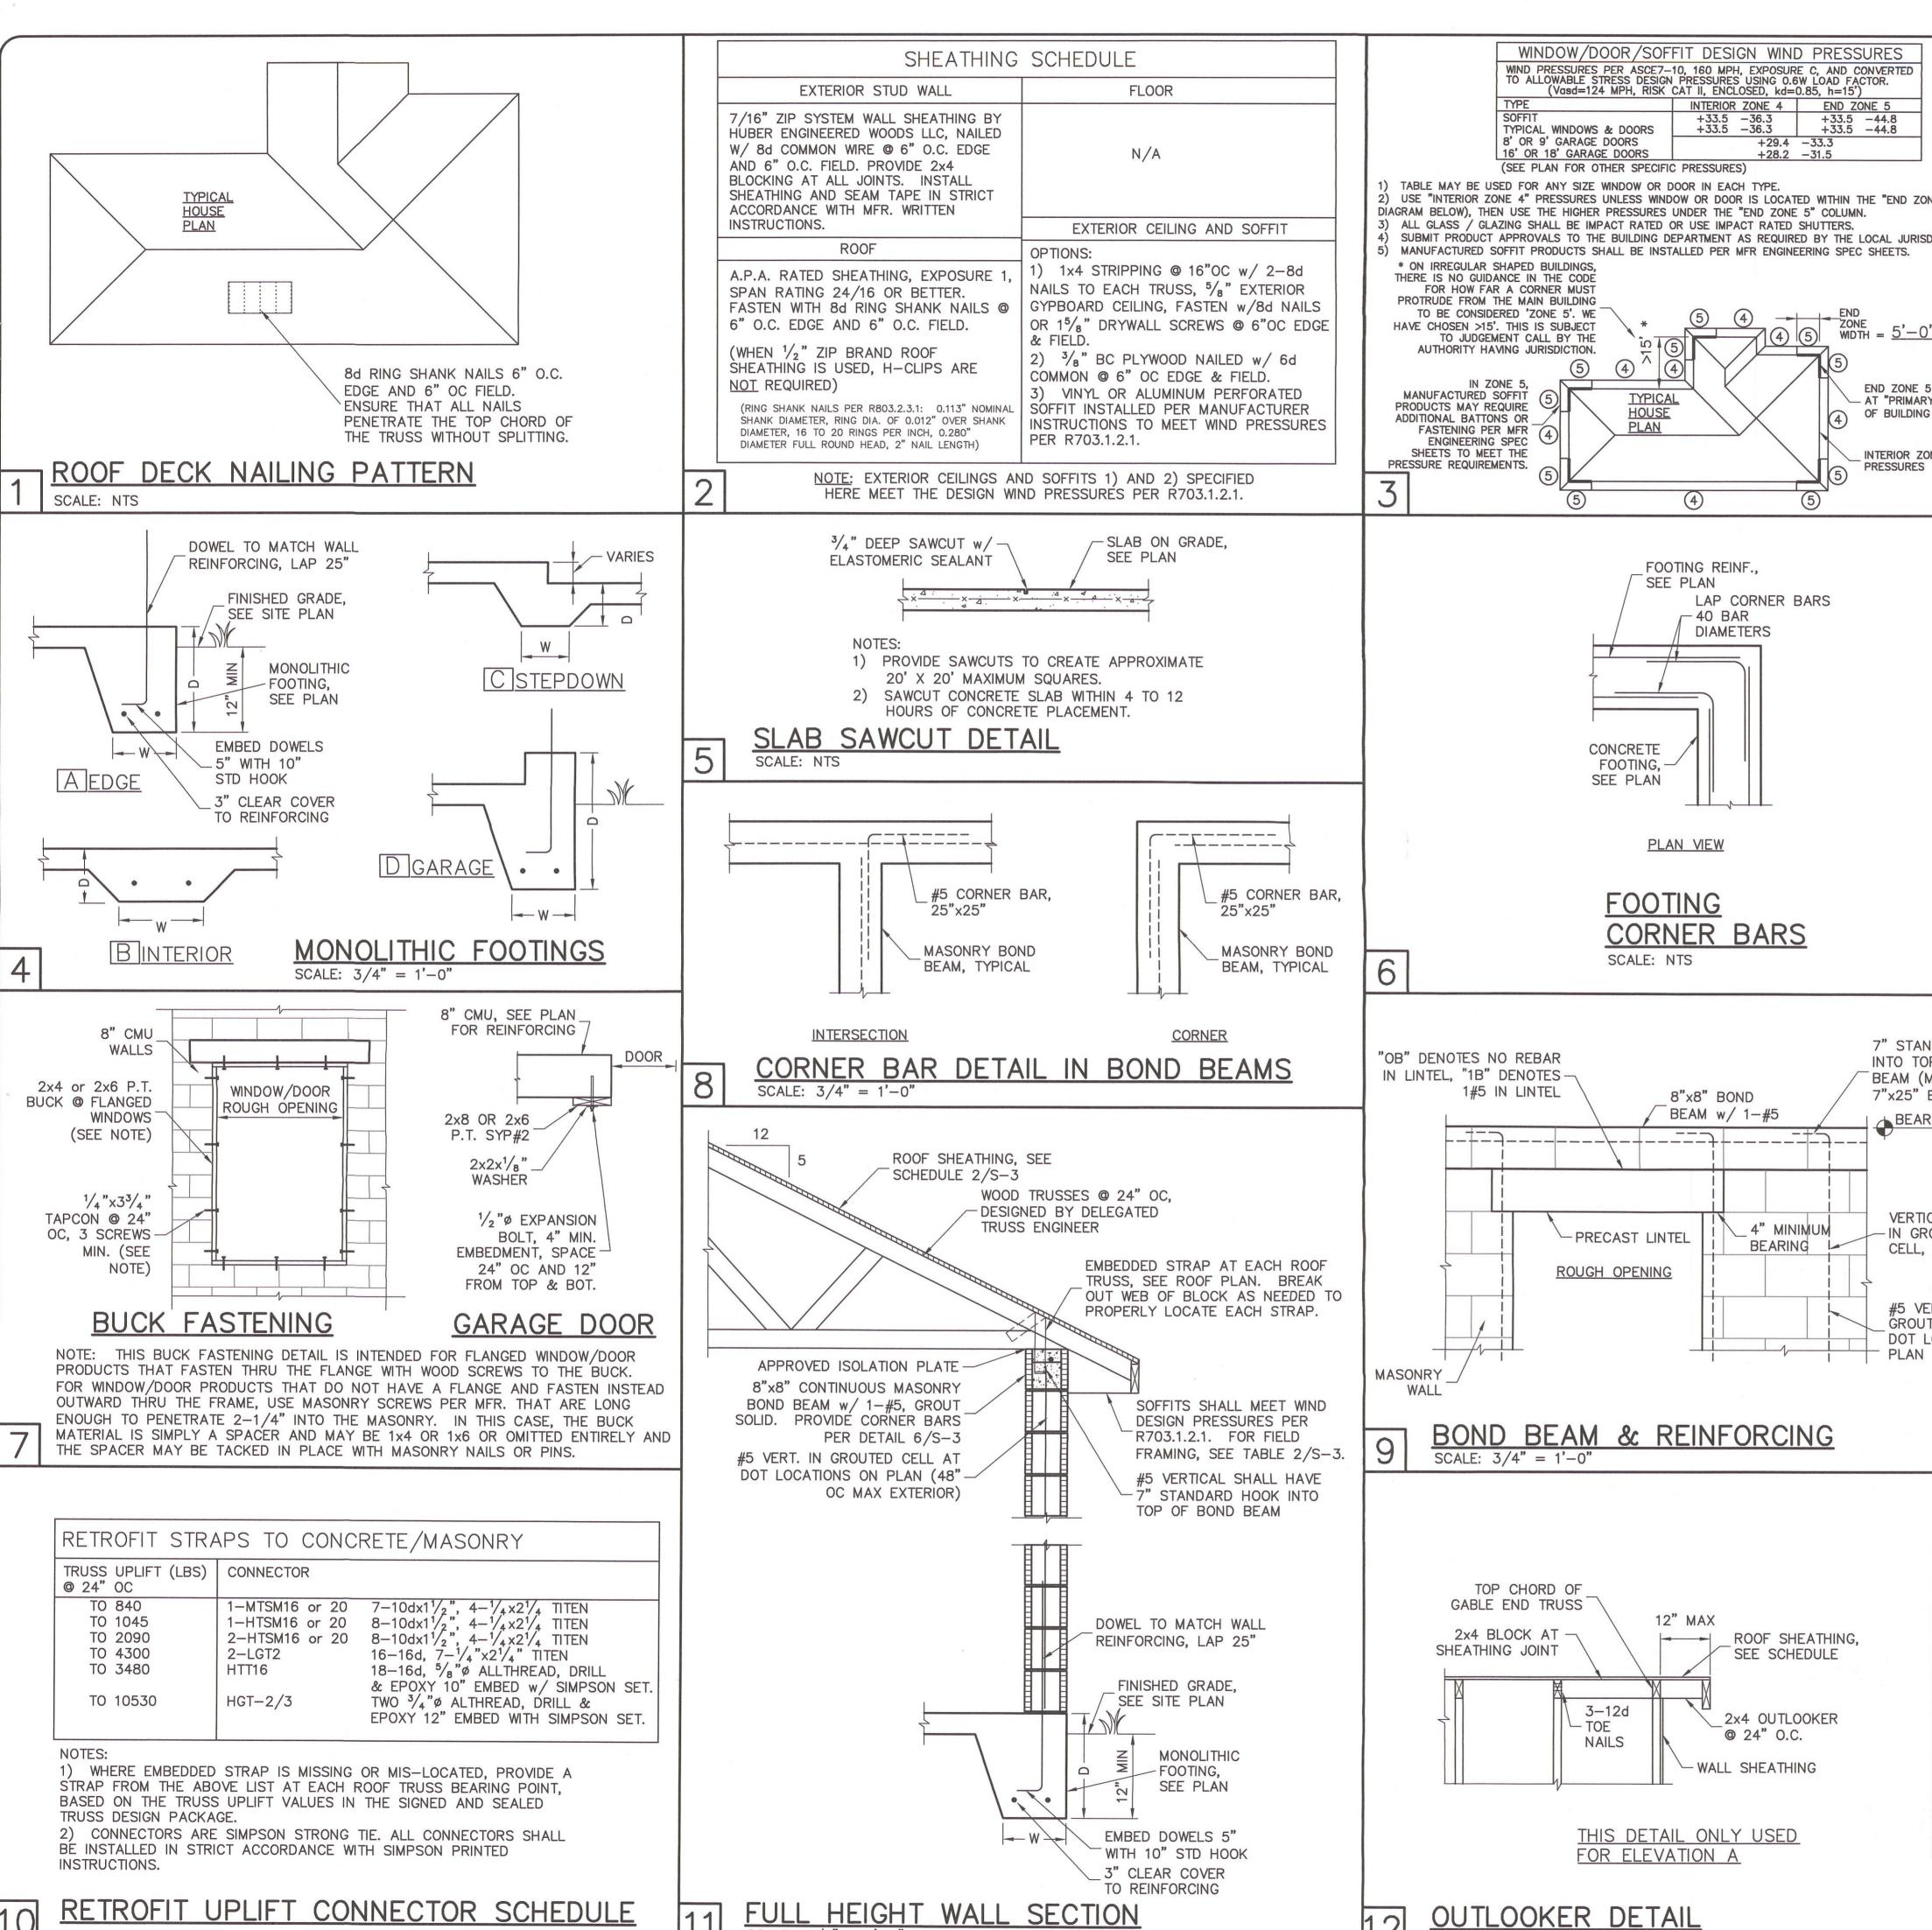

) USE "INTERIOR ZONE 4" PRESSURES UNLESS WINDOW OR DOOR IS LOCATED WITHIN THE "END ZONE 5" (SEE SUBMIT PRODUCT APPROVALS TO THE BUILDING DEPARTMENT AS REQUIRED BY THE LOCAL JURISDICTION. ZONE WDTH = 5'-0" MEASURED FROM FACE OF WALL END ZONE 5 PRESSURES OCCUR AT "PRIMARY" OUTSIDE CORNERS OF BUILDING (BOLD LINES) INTERIOR ZONE 4

7" STANDARD HOOK INTO TOP OF BOND BEAM (MAY USE 7"x25" BENT BAR) BEARING VERTICAL BAR - IN GROUTED CELL, SEE PLAN #5 VERTICAL IN GROUTED CELL AT DOT LOCATIONS ON

> At Exterior Stud Walls and Gable Ends with Wall Sheathing, apply plaster over metal lath over water resistive barrier as

DESIGN CRITERIA:

DESIGN IN ACCORDANCE WITH REQUIREMENTS OF THE

FLOOR & ROOF UNIFORM LOADS:

WIND DESIGN PER. ASCE7-10

BUILDING CATEGORY

MEAN ROOF HEIGHT

FNCLOSURE CLASS.

REINFORCED CONCRETE:

SLAB ON GRADE

**FOOTINGS** SLAB ON GRADE

BEAMS

COLUMNS

OF CONCRETE

INTERNAL PRES. COEFF.

DESIGN AS PER ACI 318-14

BEAMS AND COLUMNS

CONVENTIONAL SHALLOW FOOTINGS

FOR REINFORCING SHALL BE AS FOLLOWS:

WELDED WIRE FABRIC - ASTM A185

REQUIRED COMPRESSIVE STRENGTHS:

REINFORCING STEEL - ASTM A615 GRADE 60.

DELEGATED-ENGINEERED WOOD ROOF TRUSSES:

CONVENTIONAL SHALLOW CONCRETE FOOTINGS

ALL WOOD ROOF TRUSSES SHALL BE DESIGNED BY

SPLICES IN REINFORCING, SHALL BE 48 BAR DIAMETERS.

THAN 5" APART FOR #5 BARS.

REINFORCED MASONRY:

DESIGN PER ACI 530-13

MASONRY WALLS

SPECIFIED, CONTACT ENGINEER.

SOIL BEARING CAPACITY

TO PERFORM A SITE EVALUATION.

SHOWN ON STRUCTURAL DRAWINGS.

FOUNDATION:

ALL OTHER CONCRETE (U.N.O.)

IMPORTANCE FACTOR

BASIC WIND SPEED (ASCE7-10)

DEFLECTION CRITERIA:

WIND LOADS:

**EXPOSURE** 

ROOF PITCH

ROOF: LIVE TOP CHORD 20 PSF

ROOF L/240 LIVE, L/180 TOTAL

NOMINAL WIND SPEED (Vasd TABLE R301.2.1.3)

REQUIRED COMPRESSIVE STRENGTH AT 28 DAYS

FLORIDA BUILDING CODE 6th EDITION (2017) RESIDENTIAL

LIVE BOTTOM CHORD 10 PSF (NON-CONCURRENT w/ TCLL)

124 MPH

1.00

= 15 FT

FNCLOSED

+/-0.18

5/12

f'c = 2500 PSI

f'c = 2500 PSI

GRADE 60 FOR #4 TO #11

f'c = 3000 PSI

f'c = 3000 PSI

SHINGLE/METAL ROOFING DEAD LOAD 15 PSF TOTAL MINIMUM DEAD LOAD FOR WIND: TC 5 PSF, BC 5 PSF

WINDOW/DOOR DESIGN WIND PRESSURE, SEE TABLE IN DETAIL 3

SOFFITS - PER R703.1.2.1, ALL SOFFITS SHALL BE CAPABLE OF

31/2" MINIMUM THICKNESS REINFORCED WITH 6x6 w1.4xw1.4 WWF OR

UNLESS OTHERWISE SHOWN ON DRAWINGS, MINIMUM CONCRETE COVER

ALL REINFORCING STEEL SHALL BE PLACED IN ACCORDANCE WITH THE

SECURELY IN POSITION WITH STANDARD ACCESSORIES DURING PLACING

SPLICES IN REINFORCING, SHALL BE 40 BAR DIAMETERS. NON-CONTACT

FORMWORK AND SHORING SHALL REMAIN IN PLACE UNTIL CONCRETE

HAS REACHED AT LEAST 2/3 OF THE REQUIRED 28 DAY STRENGTH.

ALL CONCRETE MASONRY UNITS SHALL BE COMPOSED OF ASTM C90

MORTAR. GROUT ALL CELLS CONTAINING VERTICAL REINFORCEMENT WITH 3000 PSI PEA ROCK CONCRETE GROUT. ALL CELLS BELOW FINISHED GRADE SHALL BE GROUTED SOLID. ALL EXTERIOR WALLS

SHALL BE REINFORCED FULL HEIGHT AT DOT LOCATIONS ON PLAN.

THE FLORIDA ADMINISTRATIVE CODE. ALL TRUSSES SHALL HAVE

HANDLING, INSTALLING AND BRACING METAL PLATE CONNECTED WOOD TRUSSES, HIB-91." FOR OTHER BRACING REQUIREMENTS, NOTIFY ENGINEER. PROVIDE PERMANENT BRACING PER TRUSS MFR. SHOP DRAWINGS. IF PERMANENT BRACING IS NOT

THE CONTRACTOR SHALL BE RESPONSIBLE FOR DETERMINING THE

DRAWINGS FOR EMBEDS, OPENINGS, SLEEVES, ETC. WHICH ARE NOT

MEANS AND METHODS: THE STRUCTURAL ENGINEER SHALL NOT HAVE

ECHNIQUES, PROCEDURES, OR SEQUENCES TEMPORARY BRACING,

SHORING, GUYING OR OTHER MEANS TO SUPPORT STRUCTURAL

ELEMENTS IN PLACE DURING CONSTRUCTION, FOR THE ACTS OR

WORK IN ACCORDANCE WITH THE CONTRACT DOCUMENTS.

SUBMITTED TO THE ENGINEER FOR REVIEW FOR

SHOP DRAWINGS: SHOP DRAWINGS SHALL BE PREPARED AND

ONE SET OF SIGNED & SEALED TRUSS ENGINEERING SHALL BE DELIVERED TO THE ENGINEER OF RECORD FOR THE STRUCTURE

CONTROL OR BE RESPONSIBLE FOR CONSTRUCTION MEANS. METHODS.

OMISSIONS OF THE CONTRACTOR, OR ANY OTHER PERSONS PERFORMING

ALL STRUCTURAL ELEMENTS UTILIZING PREFABRICATED COMPONENTS.

PER FLORIDA ADMINISTRATIVE CODE 61G15-30.005 AND 61G15-31.003.

THE WORK OR FOR THE FAILURE OF ANY OF THEM TO CONSTRUCT THE

SUITABILITY OF THE SOIL CONDITIONS FOR THE INTENDED

DIMENSIONS: VERIFY ALL DIMENSIONS WITH HOUSE PLANS. SEE HOUSE PLANS, MECHANICAL, ELECTRICAL AND PLUMBING

T IS RECOMMENDED THAT A GEOTECHNICAL FIRM BE HIRED

STRUCTURE AND ASSUMED SOIL BEARING CAPACITY.

TEMPORARY BRACING PER "COMMENTARY AND RECOMMENDATIONS FOR

A DELEGATED TRUSS ENGINEER PER RULE 61G15-31,003 OF

GRADE N-1 HOLLOW CONCRETE MASONRY UNITS WITH TYPE 'S'

LAP SPLICES MAY BE USED PROVIDED REINFORCING IS NOT SPACED MORE

REINFORCING STEEL - ASTM A615 GRADE 40 FOR #3

TYPICAL BENDING DIAGRAMS AND PLACING DETAILS OF ACI STANDARDS AND SPECIFICATIONS. ALL REINFORCING STEEL SHALL BE HELD

CENTERED

RESISTING THE DESIGN PRESSURES SPECIFIED IN TABLE R301.2(2)

Plaster R703.7.2: 3-coat 7/8" thick portland cement based plaster per ASTM C926.

Metal Lath R703.7.1; Self furring paper backed 2.5lb diamond mesh metal lath per ASTM C847, G60 galvanized, fastened per ASTM C1063 with 1-1/2" long, 11 gage nails with 7/16" head (roofing nails) at 7" oc, or 1-1/2" long, 16 gage staples at 6" oc, into the framing members (ie, the nails or staples must align with and penetrate 3/4" into the framing studs). Water Resistive Barrier (WRB) R703.7.3: Water-resistive

vapor-permeable barrier with a performance at least equivalent to 2 layers of Grade D paper. The individual layers shall be installed independently. An approved house wrap may be used for the 1st layer and metal lath with approved paper backing may be the 2nd layer (Note: ZIP wall sheathing with seam tape qualifies as the first layer).

mastered plan CAPE CORAL BUILDING DIVISION. -DATE 413-70 COMPLIANCE WITH THE FLORIDA BY COMPLIANCE WITH THE FLORIDA BY CODE BY L. STATE AND LOCAL CODE OF A LERWIT DOLS SOFTHE CONTRACTOR OF RESPONSES THE CONTRACTOR OF RESPONSES

REV 1 - REVISED MASTER PERMIT TO ADD LANAI AND CHANGED FROM USP STRAPPING TO SIMPSON STRONG TIE STRAPPING

**REVISIONS** 1 02/27/20 DWE

DIETON

D-R-H V

DET W ERMI YAG X  $Roc_{\Pi}$ 五 4 5 5 6 7 7 7 UC. 14 AST 区口 FO 9 SO

> DESIGN/DRAWN DWB/DWB CHECKED DWB DATE 02/07/19 SCALE **VARIES** JOB NO. DR10703

SHEET

SHEET 3 OF 3

OUTLOOKER DETAIL SCALE: N.T.S.