

UNLESS NOTED

REACTION VALUES ARE UNDER 5000# UPLIFT VALUES ARE UNDER 1000#

ALL TRUSSES 24"o.c. UNLESS NOTED OTHERWISE *******CAUTION*****

DO NOT ATTEMPT TO ERECT TRUSSES WITH-OUT REFERRING TO THE ENGINEERING DWGS.

IT IS NECESSARY TO REFER TO THE ENGINEERING DRAWINGS FOR NUMBER OF MEMBERS, BEARING LOCATION, ORIENTATION AND WEB BRACING

REFER TO WTCA/TPI BSCI-B1 SUMMARY SHEET FOR HANDLING METHODS & TEMPORARY BRACING, WHICH IS ALWAYS REQUIRED

BEARING HEIGHTS BASED ON PLANS PROVIDED TO SCOSTA CORP. "+/-" BEARING DIFFERENCES SHOWN ARE CRITICAL. IF ANY HEIGHTS DEVIATE — INFORM SCOSTA CORP.

BEARING WALL & BEAM HEIGHTS

	0'-0"	ELEV.
7//////		ELEV.
		ELEV. ELEV.

TYPICAL HANGER SCHEDULE

- C SIMPSON HUS 26 M SIMPSON HGUS 28-3
- F SIMPSON HUS 28 N SIMPSON HHUS 48 H SIMPSON HGUS 28 P SIMPSON LUS 24
- I SIMPSON HGUS 28-2 B SIMPSON THA 422
- W SIMPSON THJA26 X

HANGER VALUES HAVE BEEN BASED ON 16D COMMON NAILS EXCEPT THE FOLLOWING LUS24 - 10D COMMON THJA26 - 10D x 1-1/2

*****ATTENTION*****


APPROVAL OF THIS TRUSS LAYOUT IS NECESSARY BEFORE FABRICATION CAN BEGIN. VERIFY DIMENSIONS, PITCHES, OVERHANGS, ELEVATIONS, CEILING & BEARING CONDITIONS. SCOSTA CORPORATION IS RESPONSIBLE FOR ACCURACY IN ACCORDANCE WITH PLANS AND/OR INFORMATION PROVIDED BY CUSTOMER, WITH ANY DEVIATIONS NOTED HEREIN. CUSTOMER IS RESPONSIBLE TO VERIFY ACCURACY OF INFORMATION AND PLANS PROVIDED TO SCOSTA CORPORATION, AND TO VERIFY CONFORMANCE TO FIELD CONDITIONS, AND/OR OWNER CHANGES. TRUSSES WILL BE BUILT IN ACCORDANCE WITH THE APPROVED LAYOUT.

APPROVED BY: _____


JOBSITE CONTACT NAME: _____


DATE: _____ REQUESTED DELIVERY DATE: _____

PHONE #:_

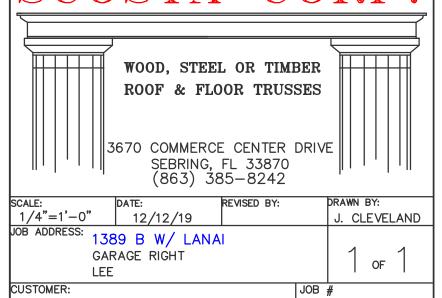


E-MAIL:	
SCOSTA C	ORP.
WOOD, STEEL OR TIME ROOF & FLOOR TRUS 3670 COMMERCE CENTER SEBRING, FL 33870 (863) 385-8242	SES
E: DATE: REVISED BY: 12/12/19	DRAWN BY: J. CLEVELAND
ADDRESS: 1389 B W/ LANAI GARAGE RIGHT LEE	1 of 1
TOMER:	JOB #
.R. HORTON	44115BL

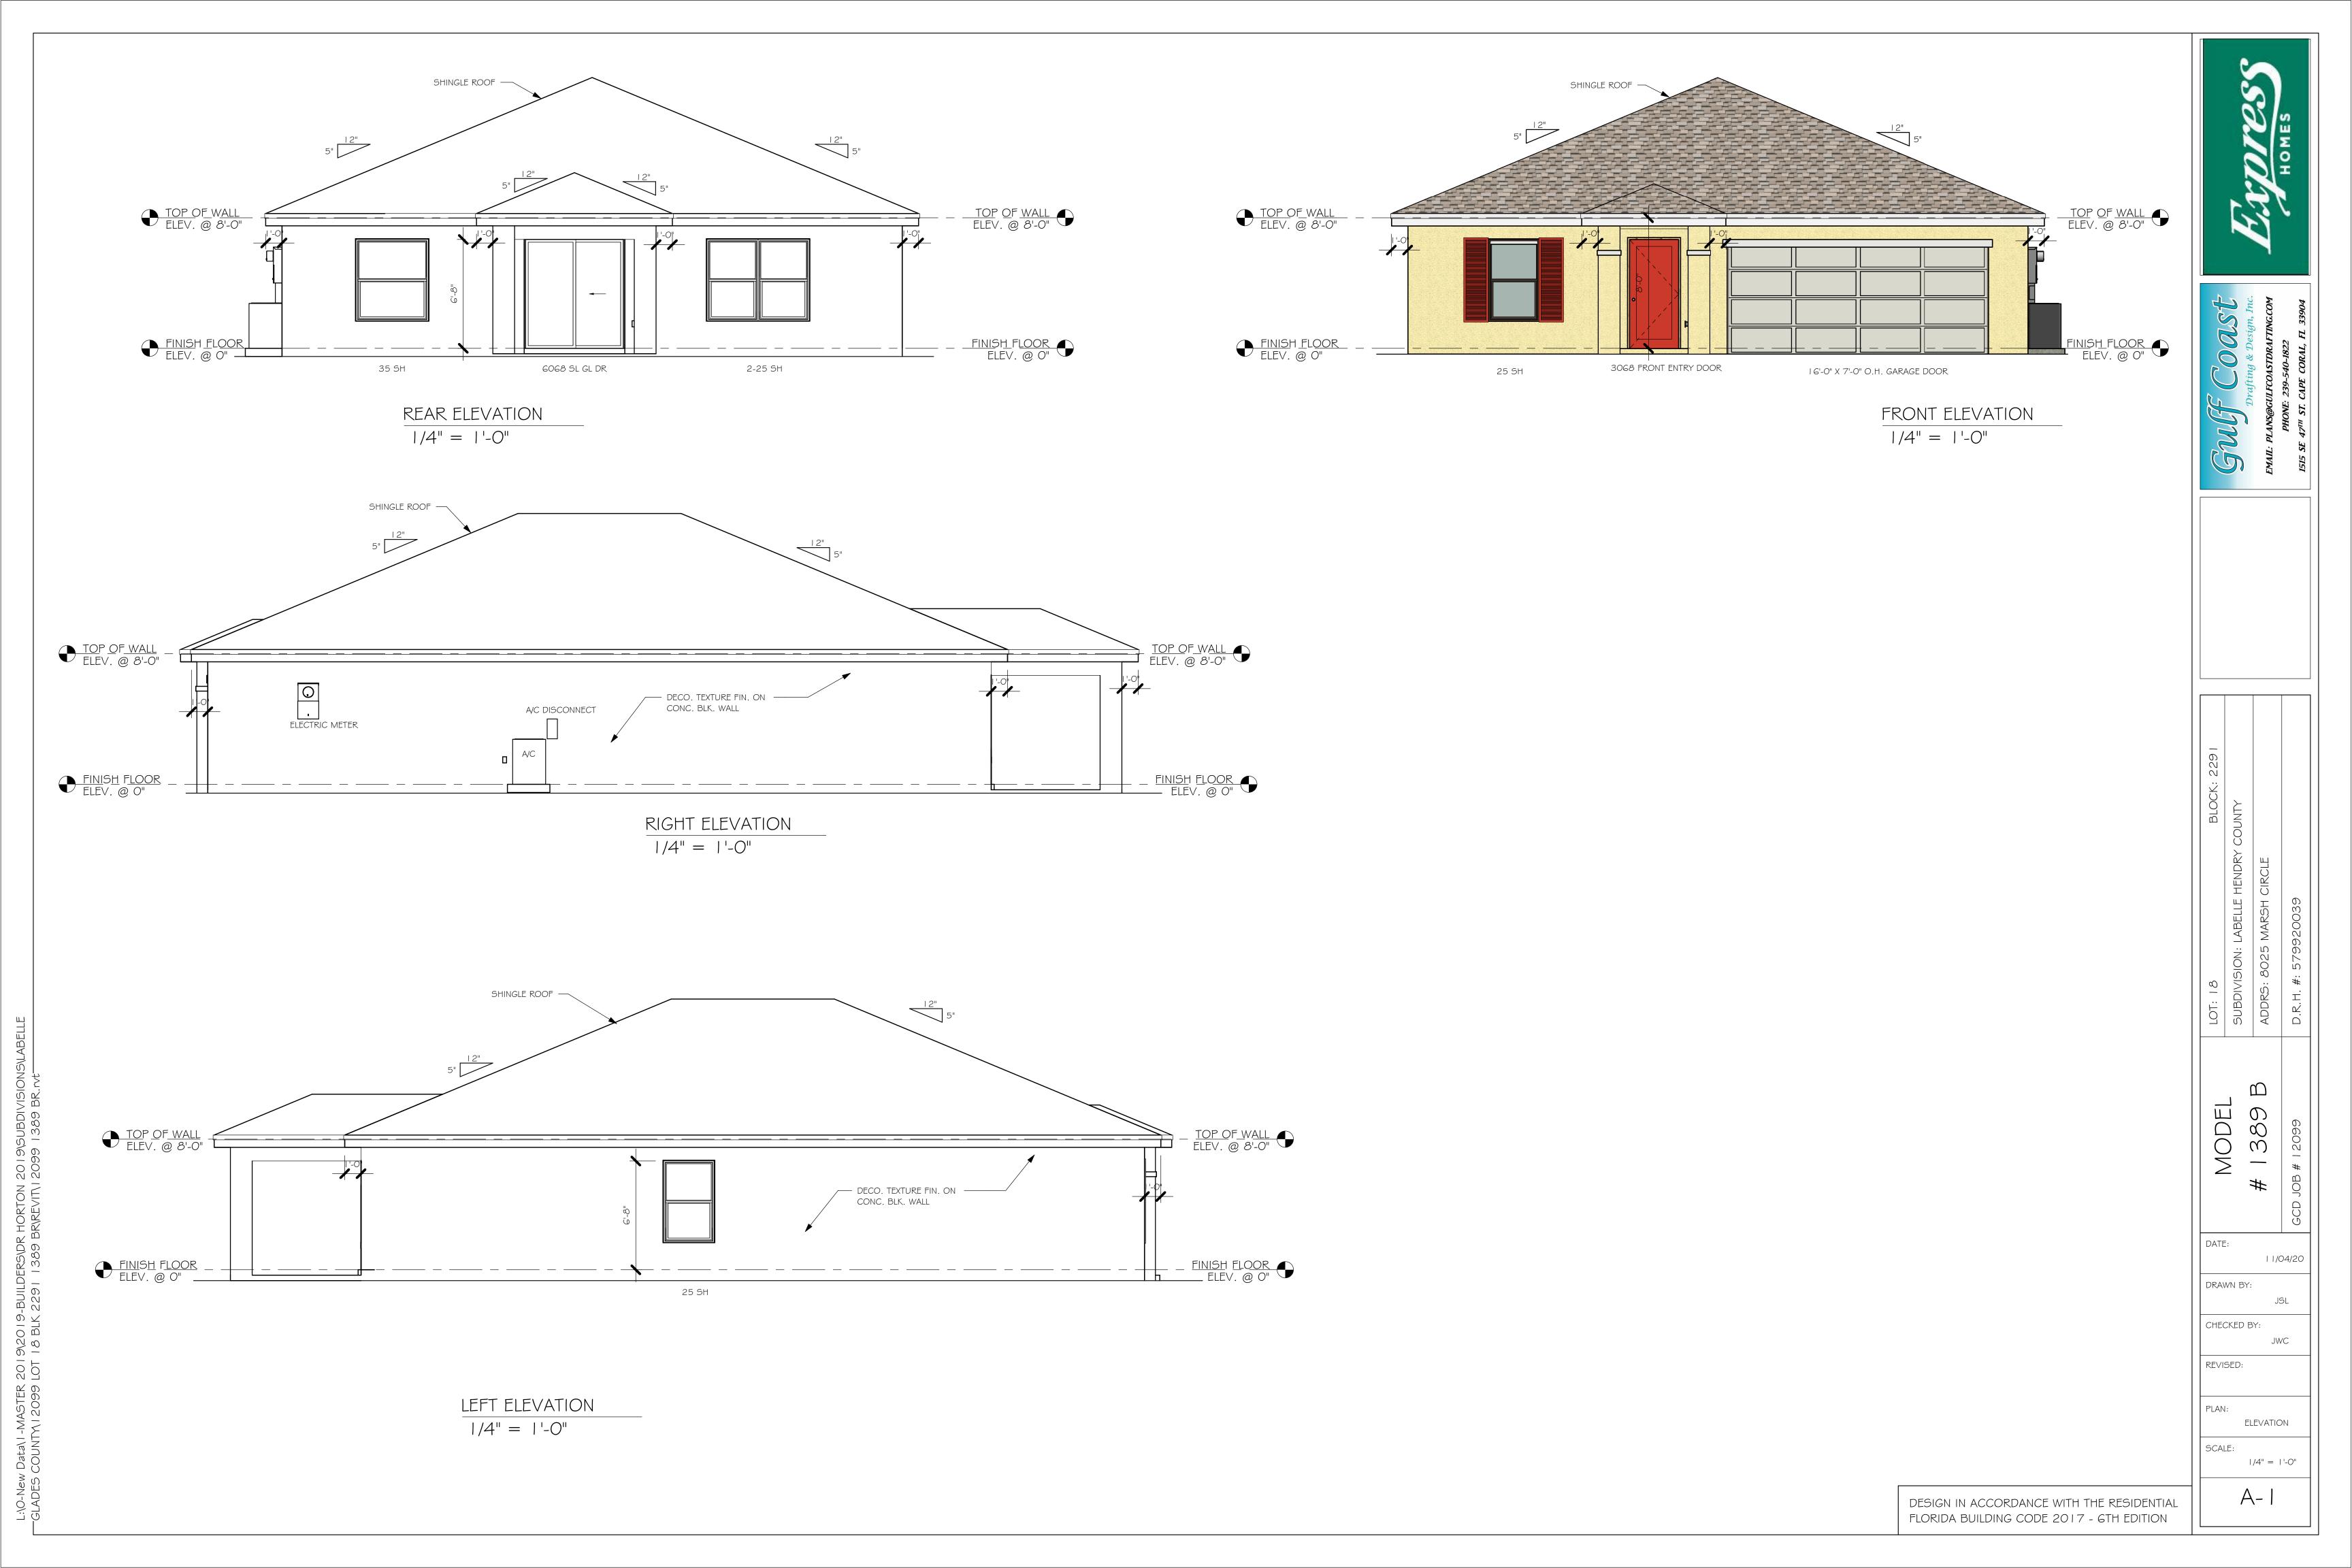

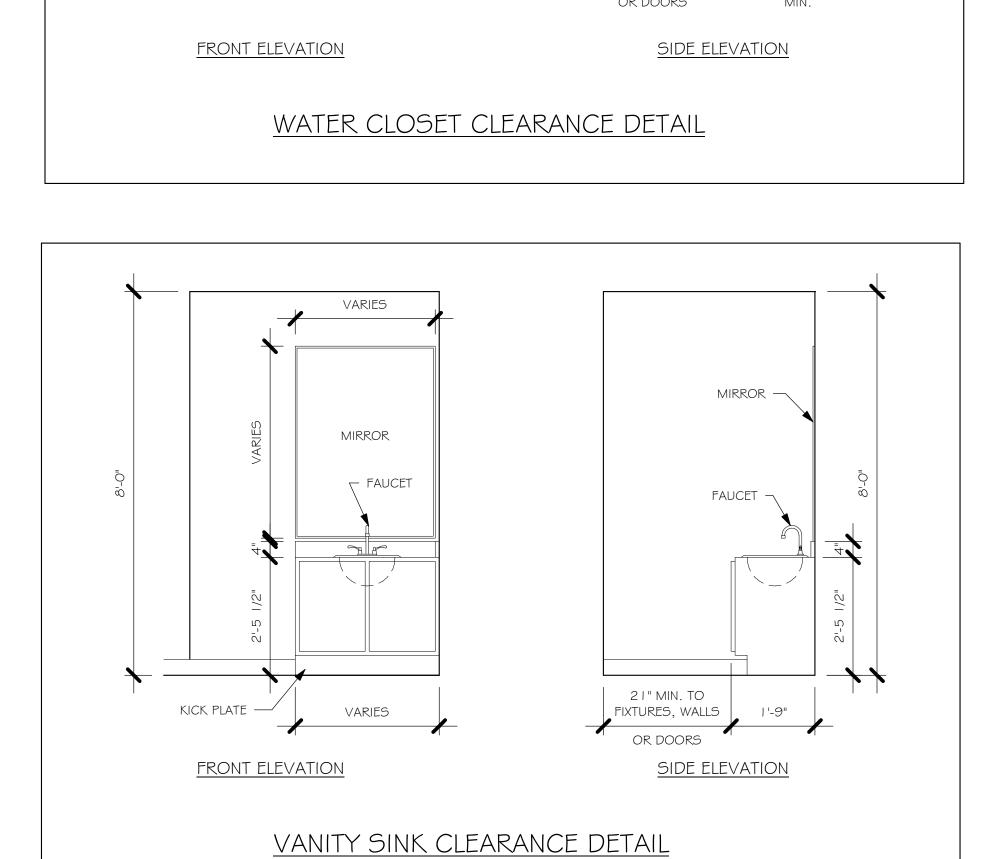


36" MAX.

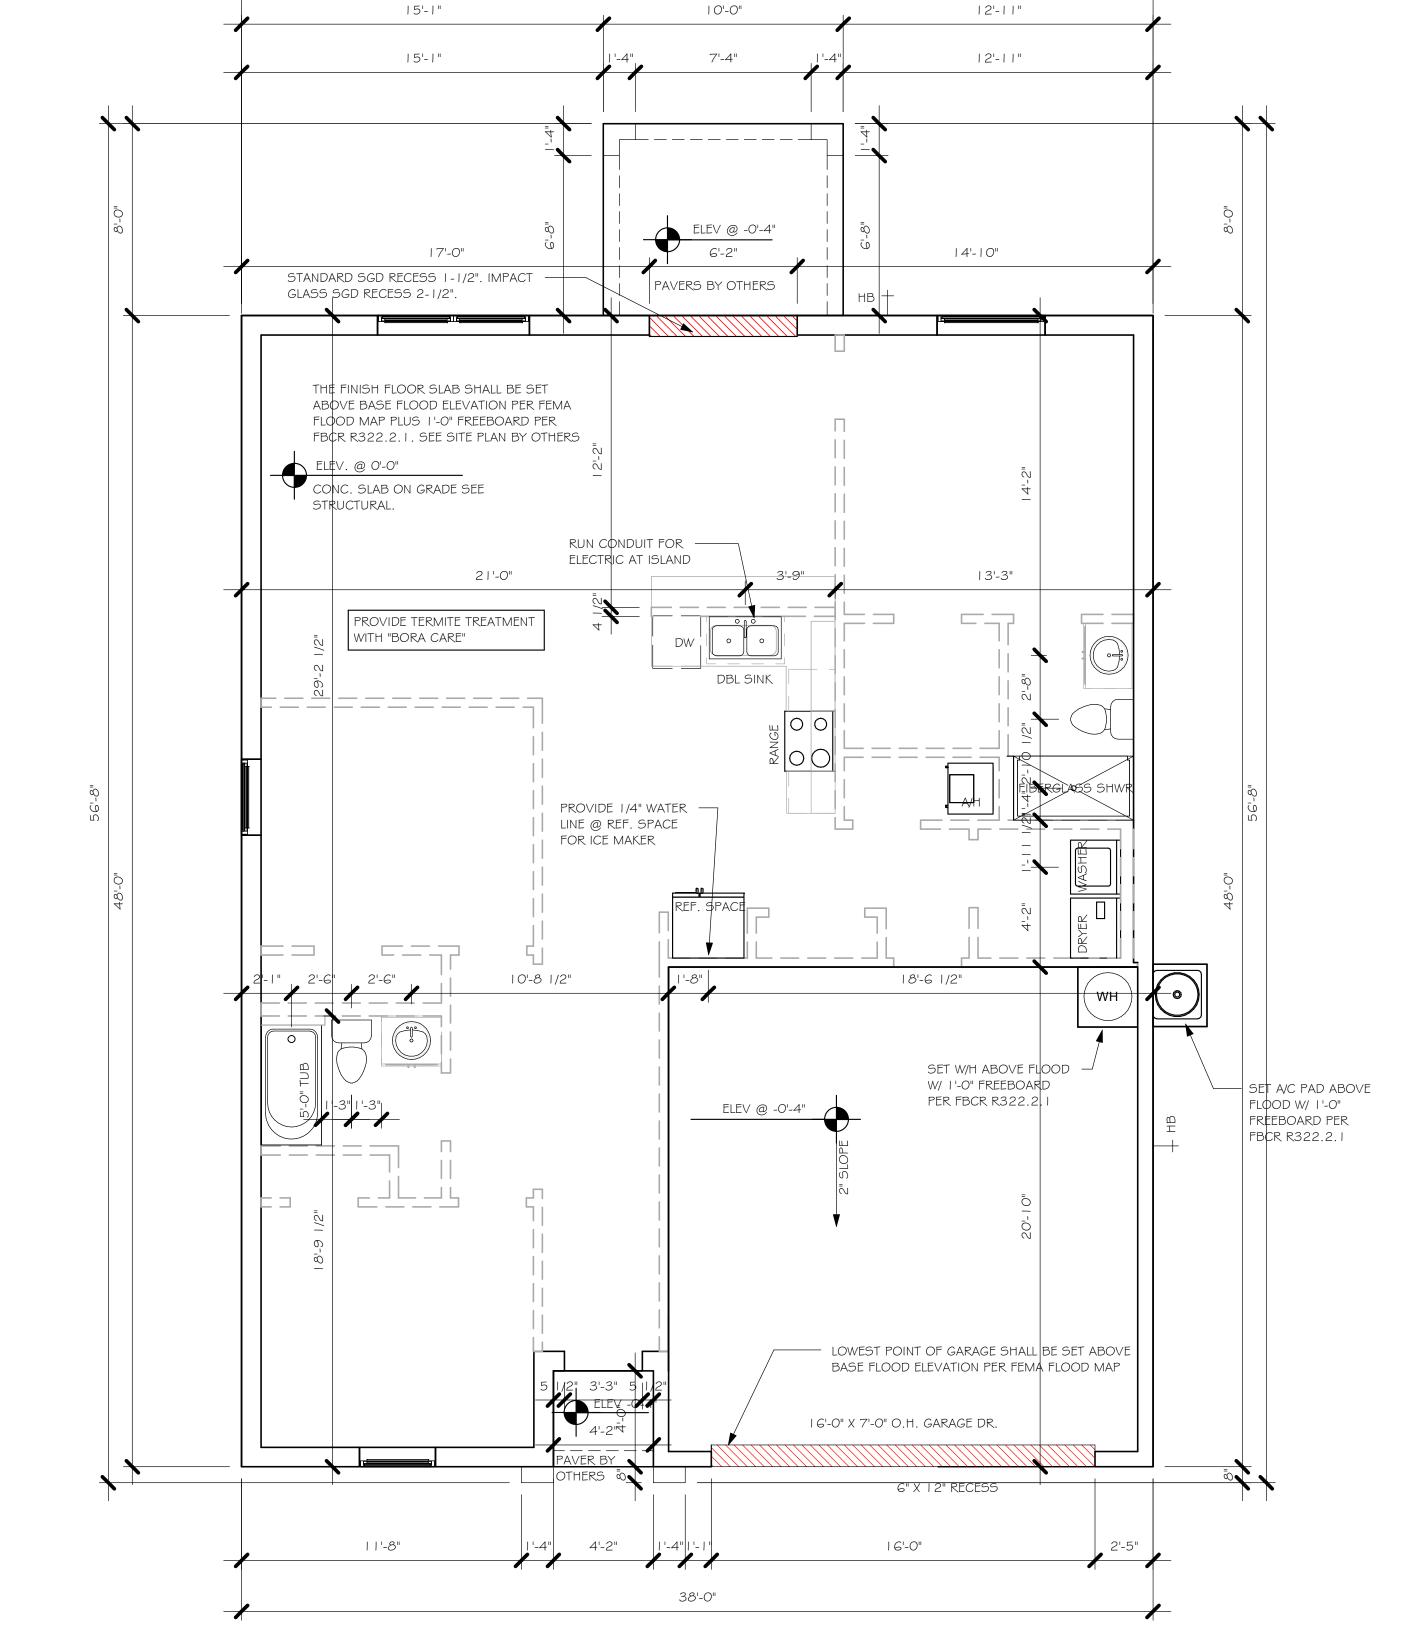

38'-0"

SLAB & PLUMBING 1/4" = 1'-0"

MODEL DATE: 11/04/20 DRAWN BY: CHECKED BY: JWC REVISED: SLAB & PLUMBING SCALE: As indicated A-2 DESIGN IN ACCORDANCE WITH THE RESIDENTIAL FLORIDA BUILDING CODE 2017 - 6TH EDITION

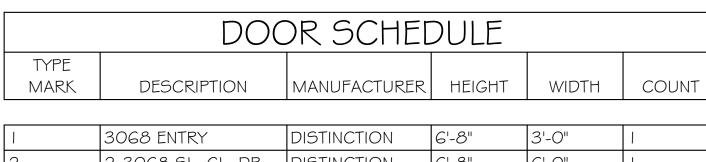

1	3068 ENTRY	DISTINCTION	6'-8"	3'-0"	1
2	2-3068 SL. GL. DR.	DISTINCTION	6'-8"	6'-0"	1
3	16070 OHGD	GARAGE DOOR	7'-0"	16'-0"	1

5'-3"

5'-3"

3'-2"

4'-6"

WINDOW SCHEDULE						
MARK	DESCRIPTION	MANUFACTURER	COUNT	HEIGHT	WIDTH	
Α	2-25 SH			5'-3"	6'-4"	

DOOR HEADERS					
6'-8" BI-FOLD	HEADER HEIGHT	82" A.F.F.			
6'-8" SWING	HEADER HEIGHT	82 I/2" A.F.F.			
8'-0" SWING	HEADER HEIGHT	98 I/2" A.F.F.			

PLAN NOTES

VERIFY ALL ROUGH OPENING DIMENSIONS FOR ALL WINDOWS AND DOORS

25 SH

35 SH

- PROVIDE SAFETY GLAZING WITHIN 24" FROM EXIT PER FLORIDA BUILDING CODE R 308.4.2.
- PROVIDE SAFETY GLAZING AT BATH/ SHOWER PER FLORIDA BUILDING CODE R 308.4.5.
- NON BEARING INTERIOR FRAME WALLS SHALL BE FRAMED W/ WOOD OR METAL STUDS. SPACING SHALL NOT EXCEED 24" O.C. (NON BEARING WALLS ONLY)
- PROVIDE DEAD WOOD IN ATTIC FOR OVERHEAD GARAGE DOOR HARDWARE
- KITCHEN KNEE WALL TO BE FRAMED W/ TOP @
- 34 I/2" A.F.F. INSTALL SMOOTH WALLS IN KITCHEN AND ALL
- BATHROOM AREAS WHERE DRYWALL CEILING IS APPLIED TO TRUSSES @ 24" O.C. USE 5/8" DRYWALL OR 1/2" SAG
- RESISTANT PER SEC. 702.3.5 THE GARAGE SHALL BE SEPARATED FROM THE RESIDENCE & ATTIC BY NOT LESS THEN 1/2" GYPSUM BOARD APPLIED TO THE GARAGE SIDE. GARAGES BENEATH HABITABLE ROOMS SHALL BE SEPARATED WITH NOT LESS THAN 5/8" TYPE "X" GYPSUM BOARD OR EQUIVALENT. WHERE THE SEPARATIION IS A FLOOR - CEILING ASSEMBLY, THE STRUCTURE SUPPORTING THE SEPARTION SHALL ALSO BE
- 10) INSTALL 1 3/8" THICK SOLID WOOD DOOR BETWEEN LIVING AND GARAGE PER FLORIDA BUILDING CODE

OR EQUIVALENT

R302.1.5,

FACE OF EXTERIOR WALL —

PROTECTED BY NOT LESS THAN 1/2" GYPSOM BOARD

- II) ALL WINDOWS INSTALLED 72" ABOVE GRADE MUST COMPLY WITH RG | 2.2 MIN 24" SILL HEIGHT OR PROVIDED WITH AN APPROVED WINDOW FALL PRVENTION DEVICE
- 12) ALL CLOSET SHELVES TO BE 12". ALL PANTRY \$ LINEN TO BE (4)-16" SHELVES 18" O.F.F. W/ 15" INCREMENT.
- 13) ALL MECHANICAL AND ELECTRICAL EQIUPMENT TO BE INSTALLED AT OR ABOVE FLOOD PLUS 1'-O" FREEBOARD.

IN.	INTERIOR DOOR SCHEDULE						
MARK	DOOR WIDTH	NOTES					
	3'-0"	P.K. = POCKET DOOR					
2	2'-8"	BF = BI-FOLD DOOR					
3	2'-6"	D.1 DI-1 OLD DOOK					
4	2'-4"	B.P. = BI-PASS DOOR					
5	2'-0"	L.V. = LOUVERED DOO					
6	1'-8"						
7	1'-6"						
8	2'-11"						


SQUARE FOOTAGE				
LIVING AREA	1,389			
GARAGE AREA	419			
LANAI AREA	80			
FRONT PORCH/ ENTRY AREA	16			
TOTAL SQUARE FOOTAGE	1,904			


CABINET BACKING						
KITCHEN	UPPER TOP @ 84"	BASE TOP @ 35"				
MASTER BATH	UPPER	BASE TOP @ 35"				
GUEST BATH	UPPER	BASE TOP @ 31"				
LAUNDRY ROOM	UPPER TOP @ 84"	BASE				

TYPICAL DIMENSION STRING

FACE OF OUTSIDE WALL TO FACE OF STUD WALL FACE OF STUD TO FACE OF STUD

	TP	TOILET PAPER	ALL BLOCKING TO BE PT IN SHOWERS
	1	†	3'-2"
2"			TOWEL BAR
		"O-1-4	TOILET PAPER ROLL

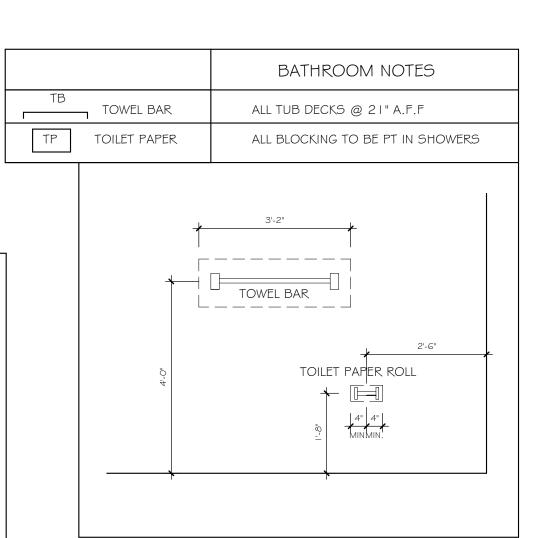

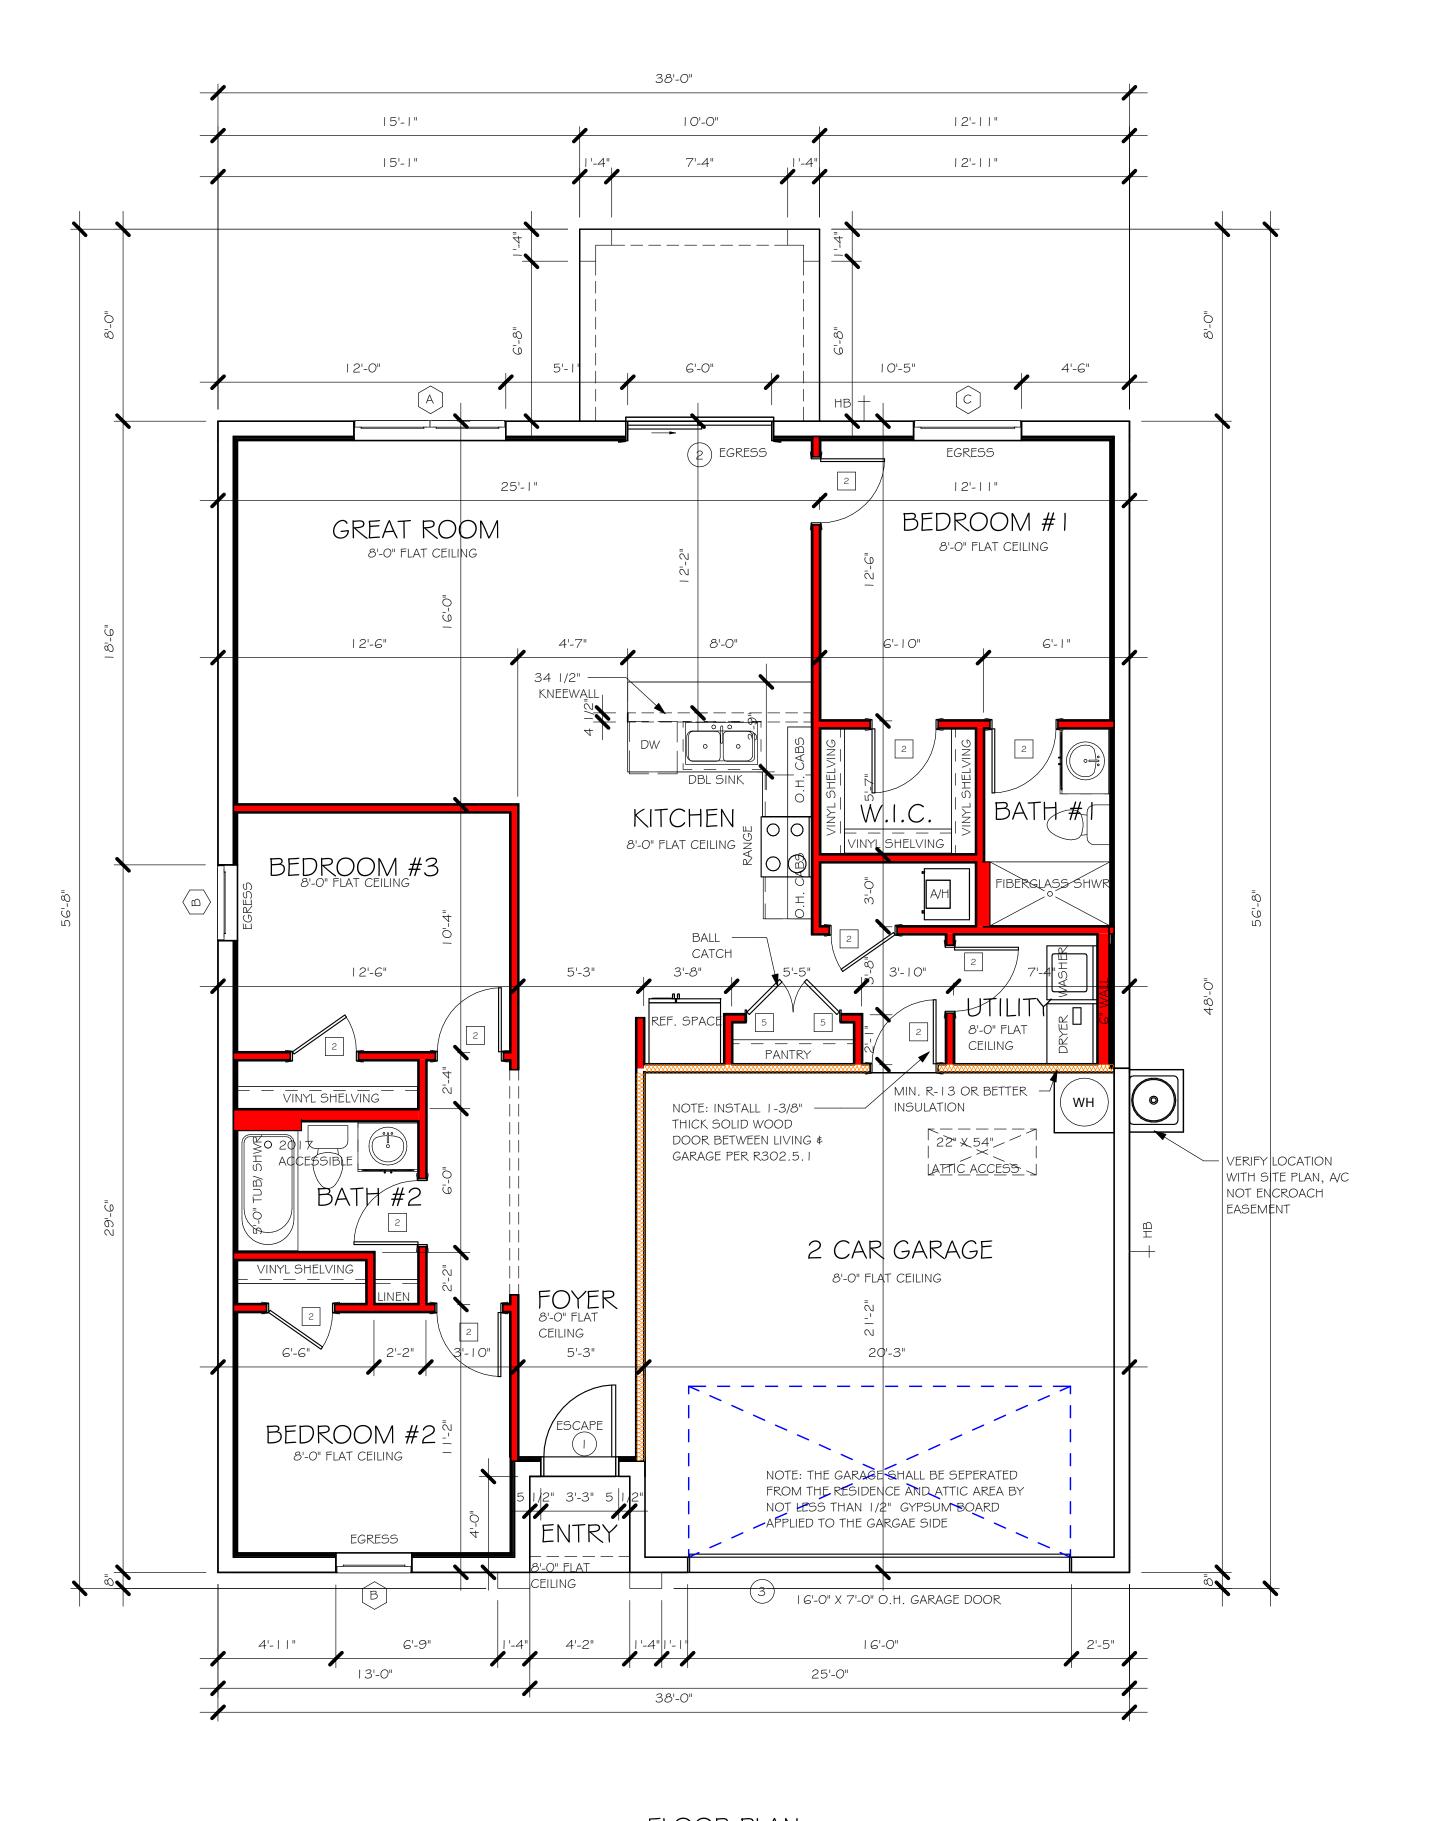

FLOOR PLAN 1/4" = 1'-0"

> DESIGN IN ACCORDANCE WITH THE RESIDENTIAL FLORIDA BUILDING CODE 2017 - 6TH EDITION

DATE:

DRAWN BY:

CHECKED BY:

REVISED:

SCALE:

11/04/20

JWC

FLOOR

As indicated

DATE: 11/04/20 DRAWN BY: CHECKED BY: JWC

REVISED: PLAN: ROOF SCALE: As indicated

A-4

DESIGN IN ACCORDANCE WITH THE RESIDENTIAL FLORIDA BUILDING CODE 2017 - 6TH EDITION

MC	DEL				VENTILA S WITH ENERGY CALC		N FB(CR R806
SOFFIT ONLY (1/150) (NO ROOF VENTS)		WITH ROOF VENTS (1/300) (R.V.)		, , ,				
AREAS (SQ. FT.) ATTIC VENTILATION		ON REQUIRED	ATTIC	ATTIC VENTILATION REQUIRED				
MARK	ATTIC	SOFFIT	ATTIC AREA/150	REQ'D AIR FLOW OF SOFFIT	QUAD 4 SOFFIT HAS	ATTIC AREA/300	QUANTITY OF ROOF VENTS	MIN AIR FLOW OF SOFFIT
1st STORY	2000.0 SQ. FT.	176.0 SQ. FT.	13.33 SQ. FT.	7.57%	8.15%	SQ. FT.	-	%
"SOFFIT ONLY" QUALIFIES		JALIFIES	ROOF VENTS ARE NOT REQUIRED					
			SOFFIT MODEL ACM QUAD 4, FULL VENT, NARROW PATTERN, 8.15% FREE AIR FLOW		22-3/8" BASE	COOF VENT N 32" BAS 2" BAS 1000 COMANCO 7	770-D	

WALL HEIGHT = WALL @ 8'-0"

BEDROOM GREAT ROOM 8'-0" FLAT CEILING BEDROOM #3 8'-0" FLAT CEILING 2 CAR GARAGE 8'-0" FLAT CEILING FOYER 8'-0" FLAT CEILING BEDROOK

> ROOF PLAN 1/4" = 1'-0"

lacksquare	DOI LLA RECLI TACLE - ADOVE COUNTER
Θ	SINGLE POLE SWITCH
() 3	3 WAY SWITCH
⇔ [□]	DIMMER SWITCH
√ MS	MOTION SENSOR SWITCH
S _{SCD}	AC/DC SMOKE DETECTOR TO BE INTERCONNECTED ANY RESIDENT HAVING A FOSSIL-BURNING HEATER OR APPLIANCE, A FIREPLACE, OR AN ATTACHED GARAGE SHALL HAVE AN OPERATIONAL CARBON MONOXIDE ALARM INSTALLED WITHIN 10 FEET OF EACH ROOM USED FOR SLEEPING PERPOSES. PER RULE 9B-3.04.72 SD (SMOKE DETECTOR) SCD (CARBON MONOXIDE/ SMOKE DETECTOR)
-T	TELEPHONE OUTLET
-TV	TELEVISION RECEPTION OUTLET
<u></u>	SURFACE MOUNTED CEILING LIGHT
	FLUSH MOUNTED LIGHT
Ю	WALL MTD. BRACKET LIGHT
464	DUPLEX FLOOD LIGHT
	EXHAUST FAN
	TRACK MTD. LIGHTS
	A/C DISCONNECT
Ю	PUSH BUTTON (PB) / DOOR BELL (DB)
(10)	INTERCOM
	KEYPAD
)	4' FLUORESCENT LIGHT
\Box	2' UNDER COUNTER LIGHT
NOTE: NO	OT ALL SYMBOLS ARE USED FOR THIS
ARC-FAUI RESISTAN IN DWELLI ALL ELECT	AL NOTES: LT CIRCUIT-INTERRUPTERS AND TAMPER IT RECEPTACLES SHALL BE INSTALLED ING UNITS PER N.E.C 210.12 AND 40G.11 FRIC, ELECTRICAL EQUIPMENT AND APPLIANCES TO BE SET AT IE BASE FLOOD ELEVATION PLUS 1'-0" FREEBOARD.

ALL OUTLETS IN WET AREAS AND ALL EXTERIOR OUTLETS TO BE GFI'S.

INSTALL PHONE AND T.V PER CONTRACT.

INSTALL ALL ELECTRICAL PER NEC 2014

ELECTRICAL LEGEND

ELECTRICAL METER

I 20 V JUNCTION BOX

SINGLE RECEPTACLE OUTLET

220 V RECEPTACLE OUTLET

4-PLEX RECEPTACLE OUTLET

DUPLEX RECEPTACLE OUTLET

1/2 SWITCHED DUPLEX OUTLET


DUPLEX RECEPTACLE AT ELEV. A.F.F.


DUPLEX RECEPTACLE - ABOVE COUNTER

ELECTRICAL PANEL

ELECTRICAL PLAN 1389

	ELECTRIC		
200 AMP SERVICE			
ΓAG	QUANTITY	PRODUCT	
Α	(X)	(FLUSH MOUNTED LT)	
В	(X)	(VAPORS)	
С	(X)	(PENDANT LIGHT	
D	(10)	(10" MUSHROOMS)	
Ε	(2)	(24" 3 LT)	
F	(X)	(36" 4 LT)	
G	(X)	(NOT USED)	
Н	(2)	(COACH LIGHTS)	
1	(X)	(COACH LIGHTS)	
J	(X)	(J BOX)	
Κ	(1)	(4' FLUORESCENT)	
L	(X)	(2' FLUORESCENT)	
М	(X)	(5LT CHANDELIER)	
Ν	(X)	(3 LT)	
0	(X)	(PENDANT/ NOOK)	
Р	(X)	(X)	<u> </u>
Q	(X)	(X)	

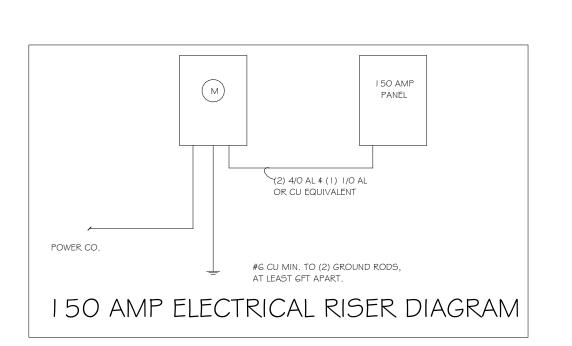

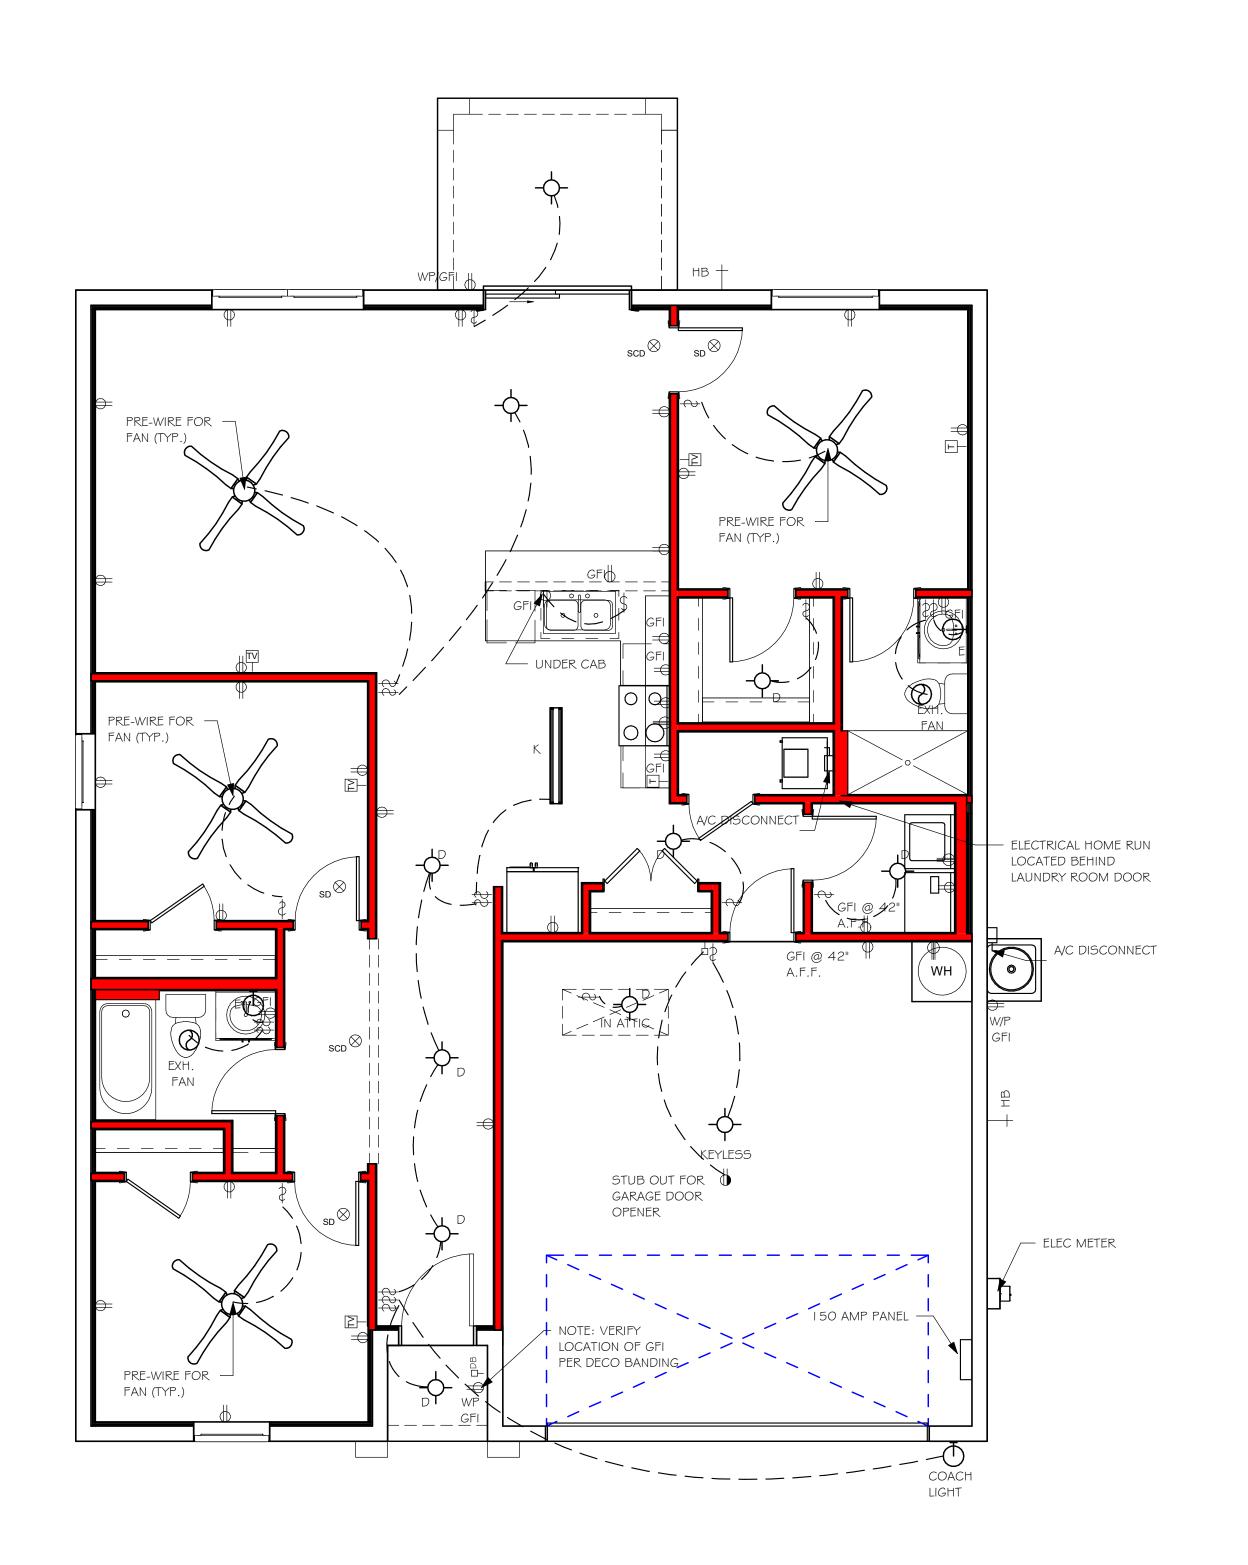

GMUST COOCST Drafting & Design, Inc.

EMAIL: PLANS@GUIFCOASTDRAFTING.COM
PHONE: 239-540-1822

1515 SE 47TH ST. CAPE CORAL, FL 33904

DATE:

DRAWN BY:

CHECKED BY:

REVISED:

PLAN:


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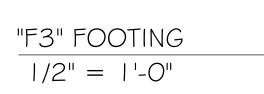
11/04/20


ELECTRIC

As indicated


DESIGN IN ACCORDANCE WITH THE RESIDENTIAL FLORIDA BUILDING CODE 2017 - 6TH EDITION



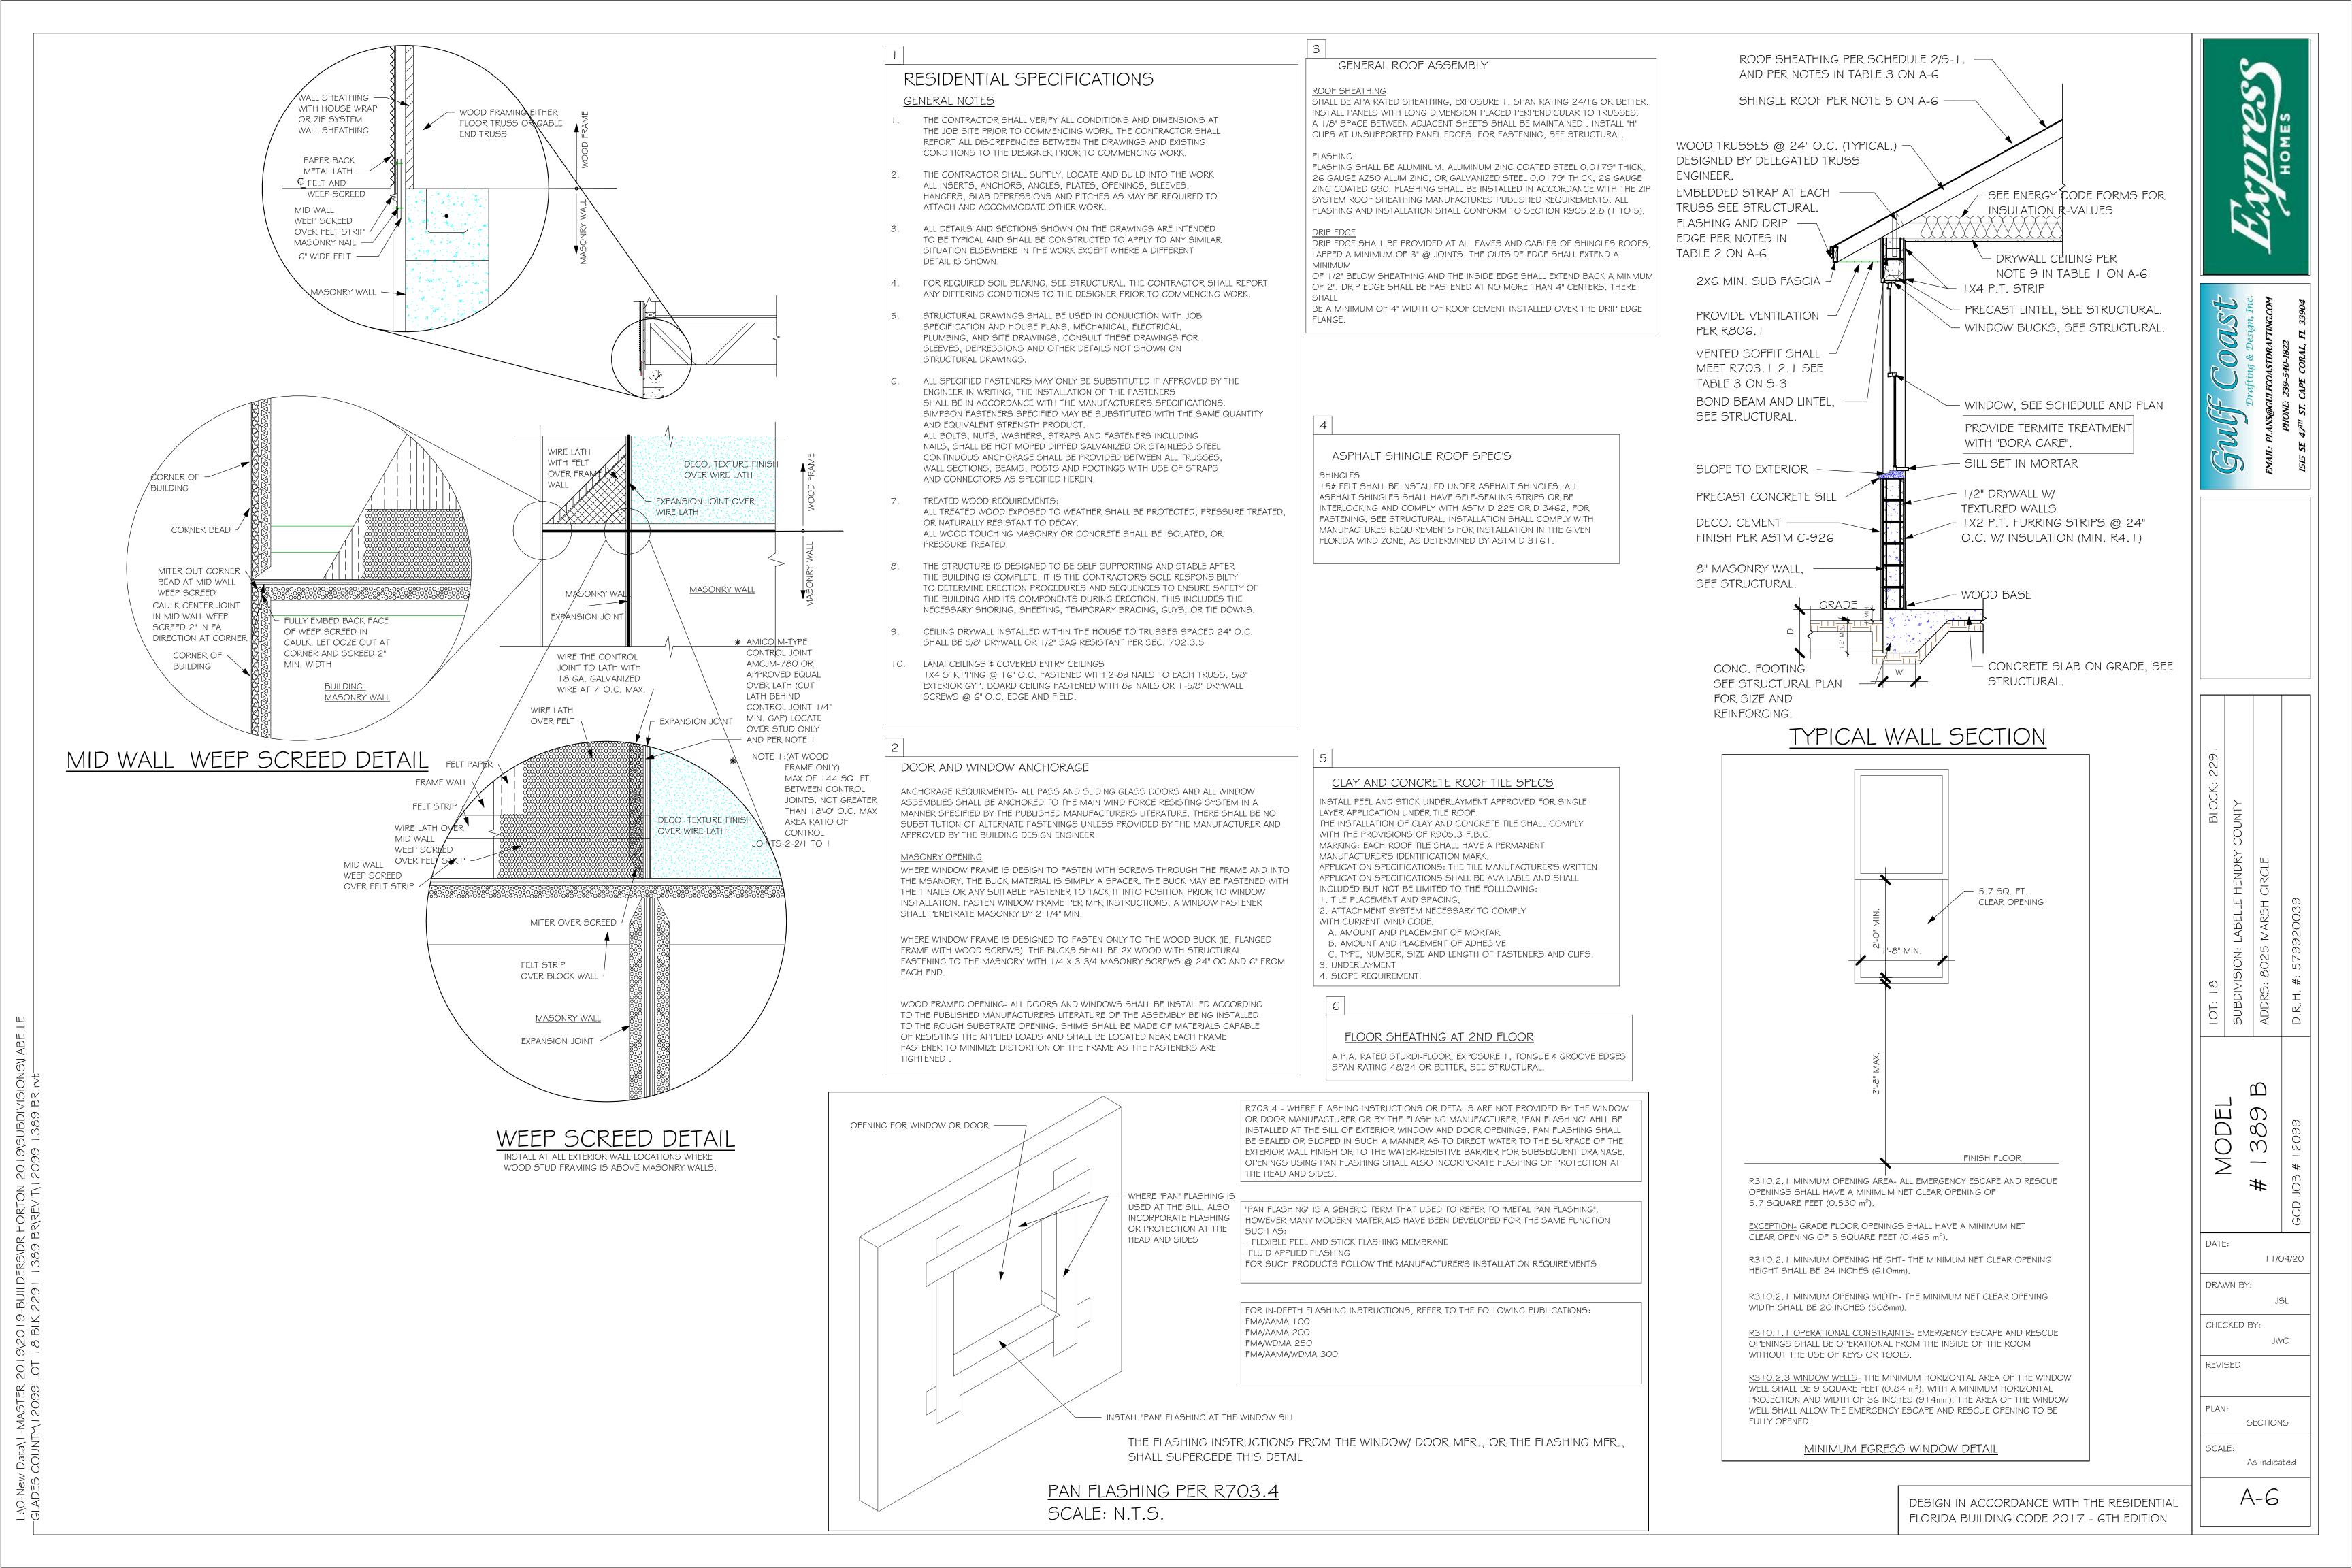


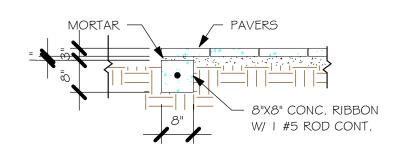


"P" PAVERS DETAIL ENTRY/ LANAI 1/2" = 1'-0"

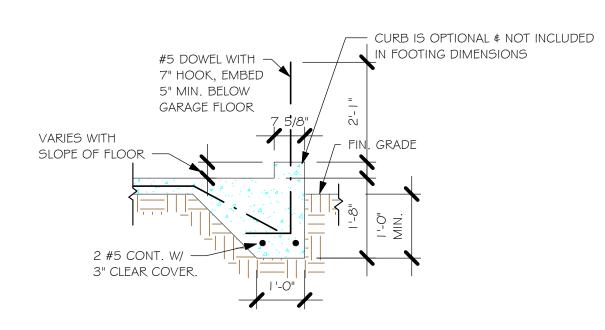

"F3" WITH CURB AT GARAGE 1/2" = 1'-0"

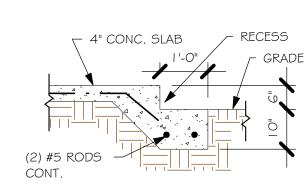

GARAGE DOOR RECESS 1/2" = 1'-0"

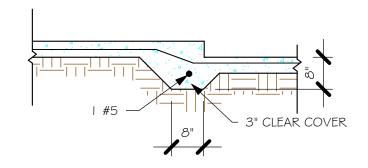

 $\frac{\text{"F6A" STEP DOWN}}{1/2\text{"} = 1\text{'-0"}}$

		PAD FOOTING SCHEDULE											
٥	!	LENGTH	WIDTH	DEPTH	BOTTOM REINF.								
USED	TYPE				LONG WAY	SHORT WAY	REMARKS						
\rangle	$\langle \mathbf{A} \rangle$	2'-6"	2'-6"	1'-0"	3-#5	3-#5	-						
	B	3'-0"	3'-0"	1'-0"	4-#5	4-#5	-						
	(C)	3'-6"	3'-6"	1'-0"	4-#5	4-#5	-						
	(D)	4'-0"	4'-0"	1'-2"	5-#5	5-#5	-						
	(E)	5'-0"	5'-0"	1'-2"	6-#5	6-#5	-						


SED	TYPE	LENGTH	WIDTH	DEPTH	BOTTOM REINFORCING	SHAPE	-
_	F1	CONT.	1'-4"	0'-8"	2-#5		
	F2	CONT.	1'-8"	0'-10"	2-#5		
X	F3	CONT.	1'-0"	1'-8"	2-#5	₩	ADD CURE GARAGE, S DETAIL
	F4	CONT.	1'-4"	1'-8"	2-#5	_	DETAIL
	F5	CONT.	1'-4"	1'-0"	2-#5		
	F6	CONT.	1'-4"	1'-0"	2-#5		
X	F6A	CONT.	0'-8"	0'-8"	1-#5		
	TE	CONT.	0'-8"	0'-8"	1-#5	F	1

PROVIDE CORNER BARS PER 6/S-3



SCALE: 1/4" = 1'-0"

- **PLAN NOTES:** TOP OF GROUND FLOOR SLAB DATUM ELEVATION 0'-0"
- "F#" DENOTES CONTINUOUS WALL FOOTING TYPE PER SCHEDULE THIS SHEET.
- PROVIDE #5 VERTICAL REINFORCING AT DOT LOCATIONS SHOWN ON PLAN FROM FOOTING ALL DIMENSIONS ARE TO OUTSIDE FACE OF MASONRY WALLS. SOME SLAB EDGES MAY
- EXTEND BEYOND FACE OF WALL. FOR DIMENSIONS OF ROUGH OPENINGS IN MASONRY WALLS, COORDINATE WITH WINDOW/
- PROVIDE PRESSURE TREATED BUCKS AT WINDOWS/ DOORS PER DETAIL 7/S-3.

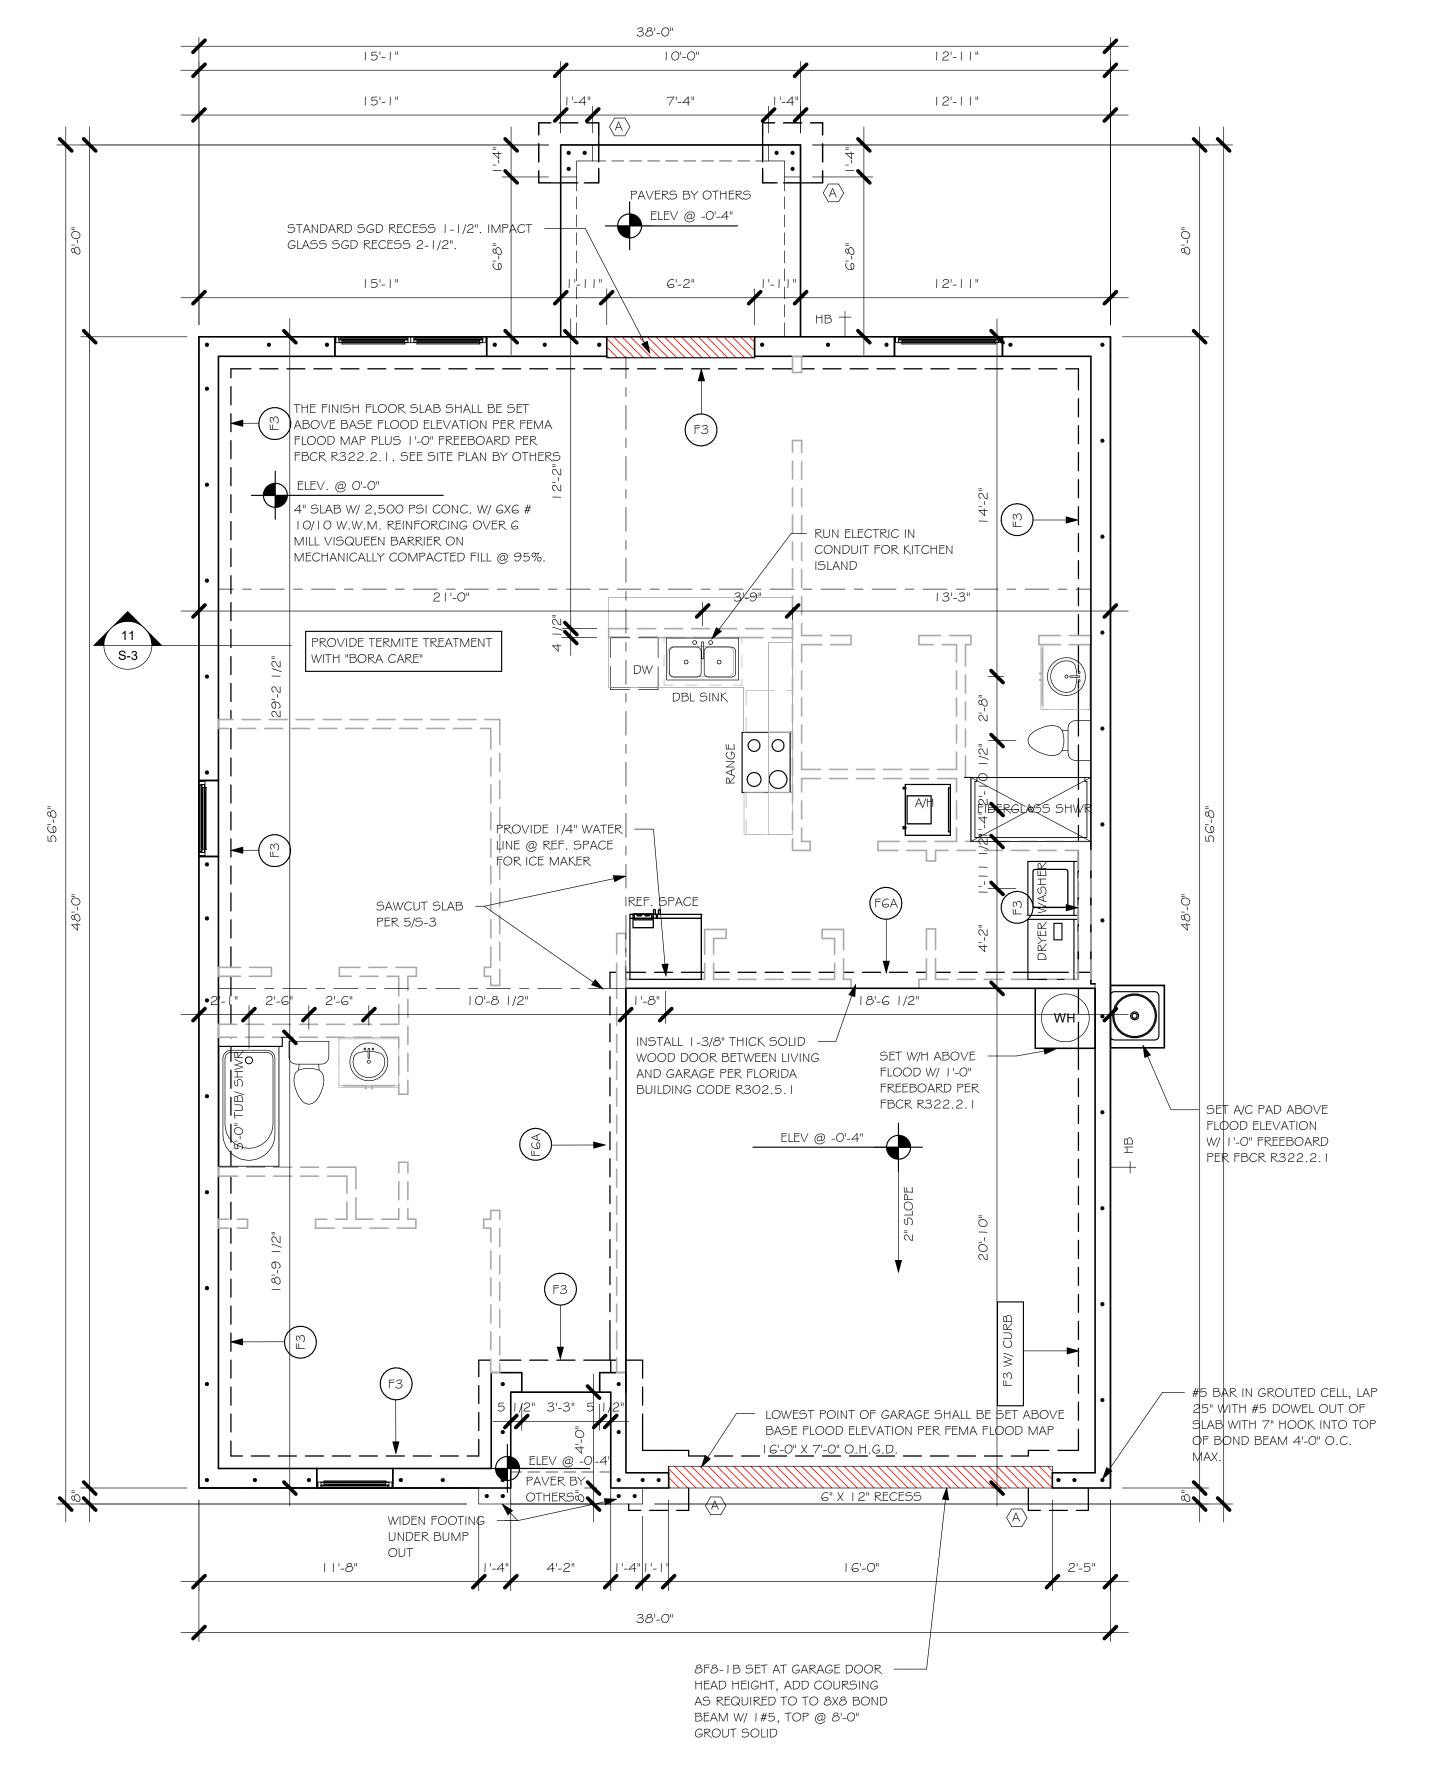

FOUNDATION 1/4" = 1'-0"

DESIGN IN ACCORDANCE WITH THE RESIDENTIAL

FLORIDA BUILDING CODE 2017 - 6TH EDITION

DATE:

DRAWN BY:

CHECKED BY:

FOUNDATION PLAN

As indicated

REVISED:


11/04/20

I. PROVIDE A STRAP FROM THE ABOVE LIST AT EACH ROOF TRUSS BEARING POINT, BASED ON THE TRUSS UPLIFT VALUES IN THE SIGNED AND SEALED TRUSS DESIGN PACKAGE AND

SUITABLE FOR THE GEOMETRY. EMBED STRAP ON -C OF WALL. CONNECTORS ARE SIMPSON STRUCTURAL CONNECTORS. ALL CONNECTORS SHALL BE INSTALLED IN STRICT ACCORDANCE WITH SIMPSON PRINTED INSTUCTIONS.


SUBSTITUTIONS MUST BE APPROVED IN WRITING BY THE ENGINEER OF RECORD. WHERE EMBEDDED STRAPS ARE MISSING, OR MIS-LOCATED, INSTALL RETROFIT STRAP PER 10/5-3.

SIMPSON CATALOG C-C- 2019

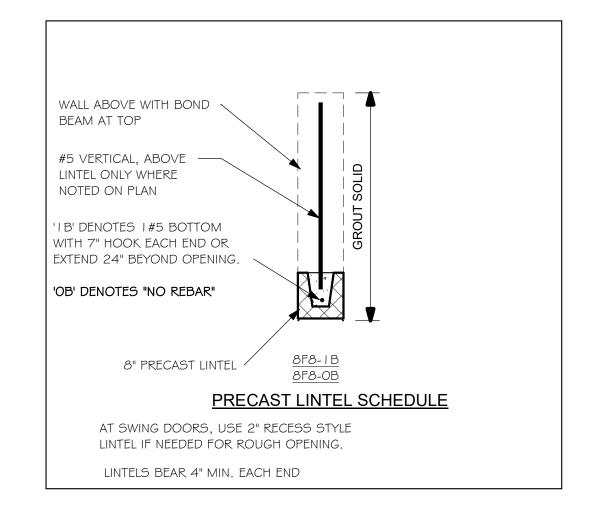

PLAN NOTES:


- ROOF TRUSS BEARING @ 8'-0".
- ROOF FRAMING SHALL BE WOOD TRUSSES DESIGNED BYA DELEGATED TRUSS ENGINEER PER DESIGN CRITERIA ON SHEET S-3.
- PROVIDE STRAPPING AT TRUSSES PER NOTES ON THIS
- SHEET. FOR NAILING OF ROOF AND FLOOR DECK, SEE | AND 2
- ON S-3. 8F8-1B etc., DENOTES PRECAST LINTEL ABOVE
- DOORWINDOW OPENING PER SCHEDULE THIS SHEET. AT TRUSS BEARING, PROVIDE 8x8 MASONRY BOND BEAM W/ I #5 CONTINUOUS, SEE DETAIL I I/S-3.

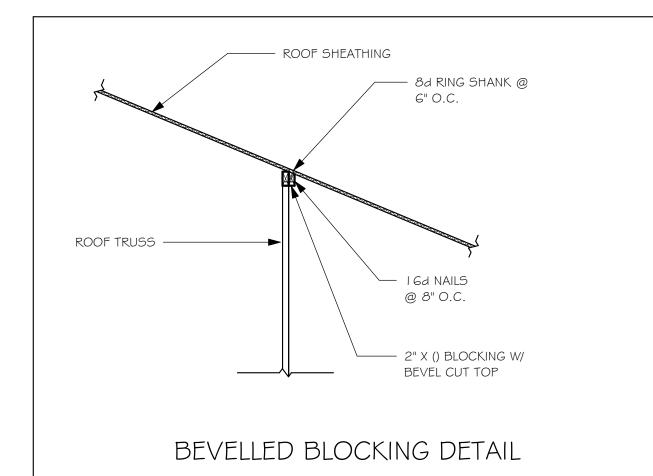

TRUSS BEARING CONDITIONS AND STRAPPING IS BASED ON TRUSS LAYOUT PREPARED BY SCOSTA JOB#: 44115BL DATED: 12/12/19 REVISED: NONE

BEARING HEIGHT

= BEARING @ 8'-0"

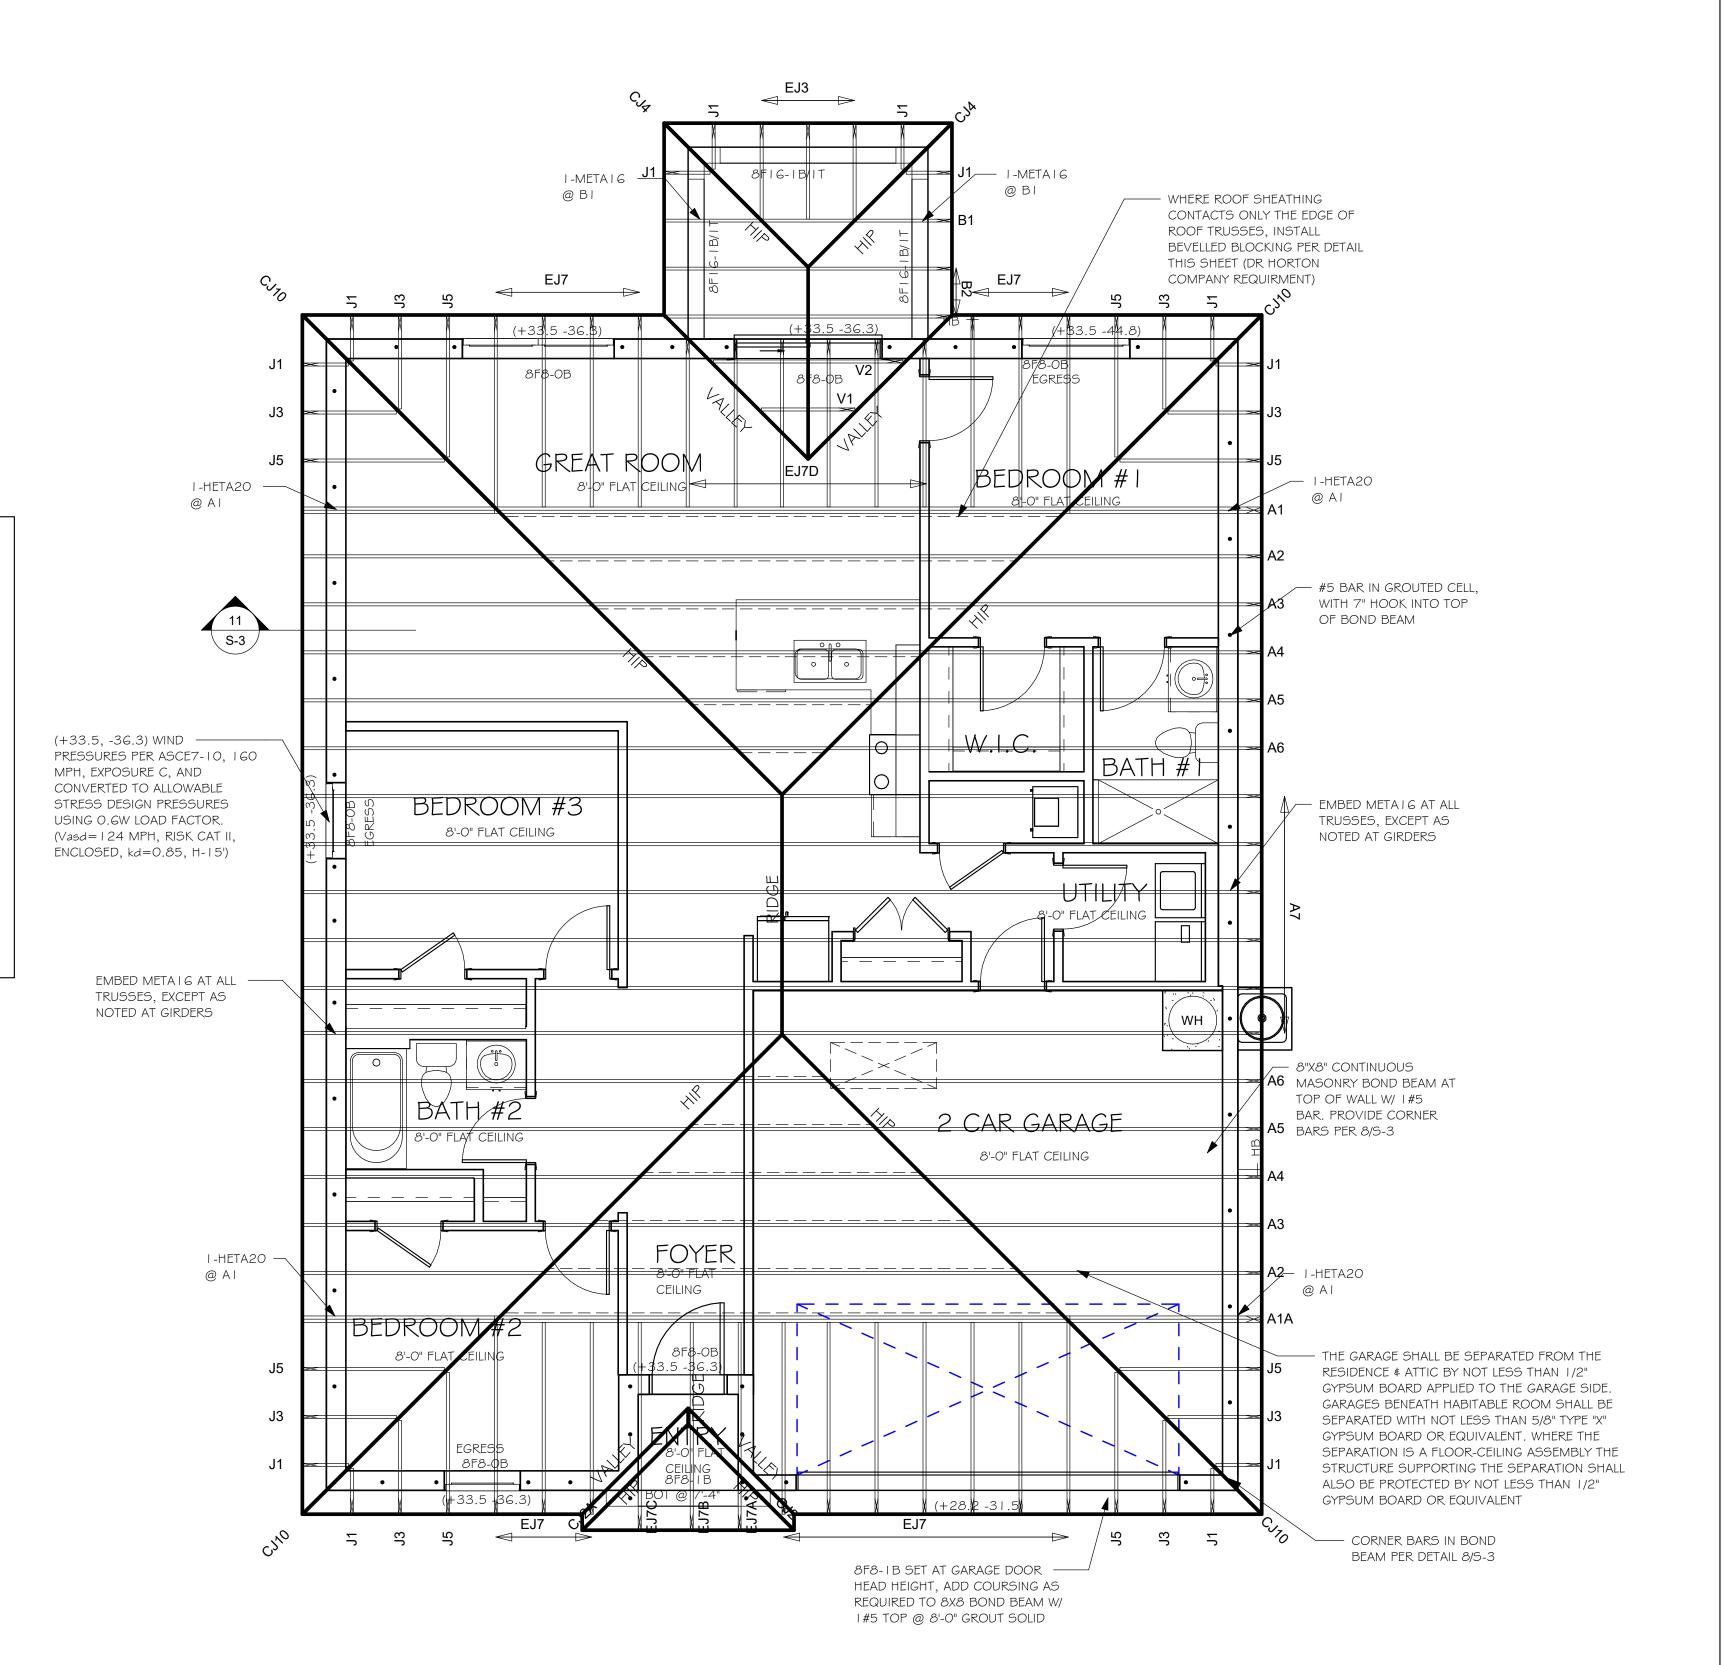

ROOF FRAMING PLAN 1/4" = 1'-0"

> DESIGN IN ACCORDANCE WITH THE RESIDENTIAL FLORIDA BUILDING CODE 2017 - 6TH EDITION

REVISED: ROOF FRAMING PLAN

 $\sum_{i=1}^{n}$

DATE:

DRAWN BY:

CHECKED BY:

 \mathcal{O}

 \mathcal{C}

11/04/20


JSL

JWC

STRUCTURAL SYSTEMS OF NORTH FLORUM 1634 SE, 47th ST SUITE #3 CAPE CIRAL, FL 33904 (239) 549-4554

As indicated

SCALE:

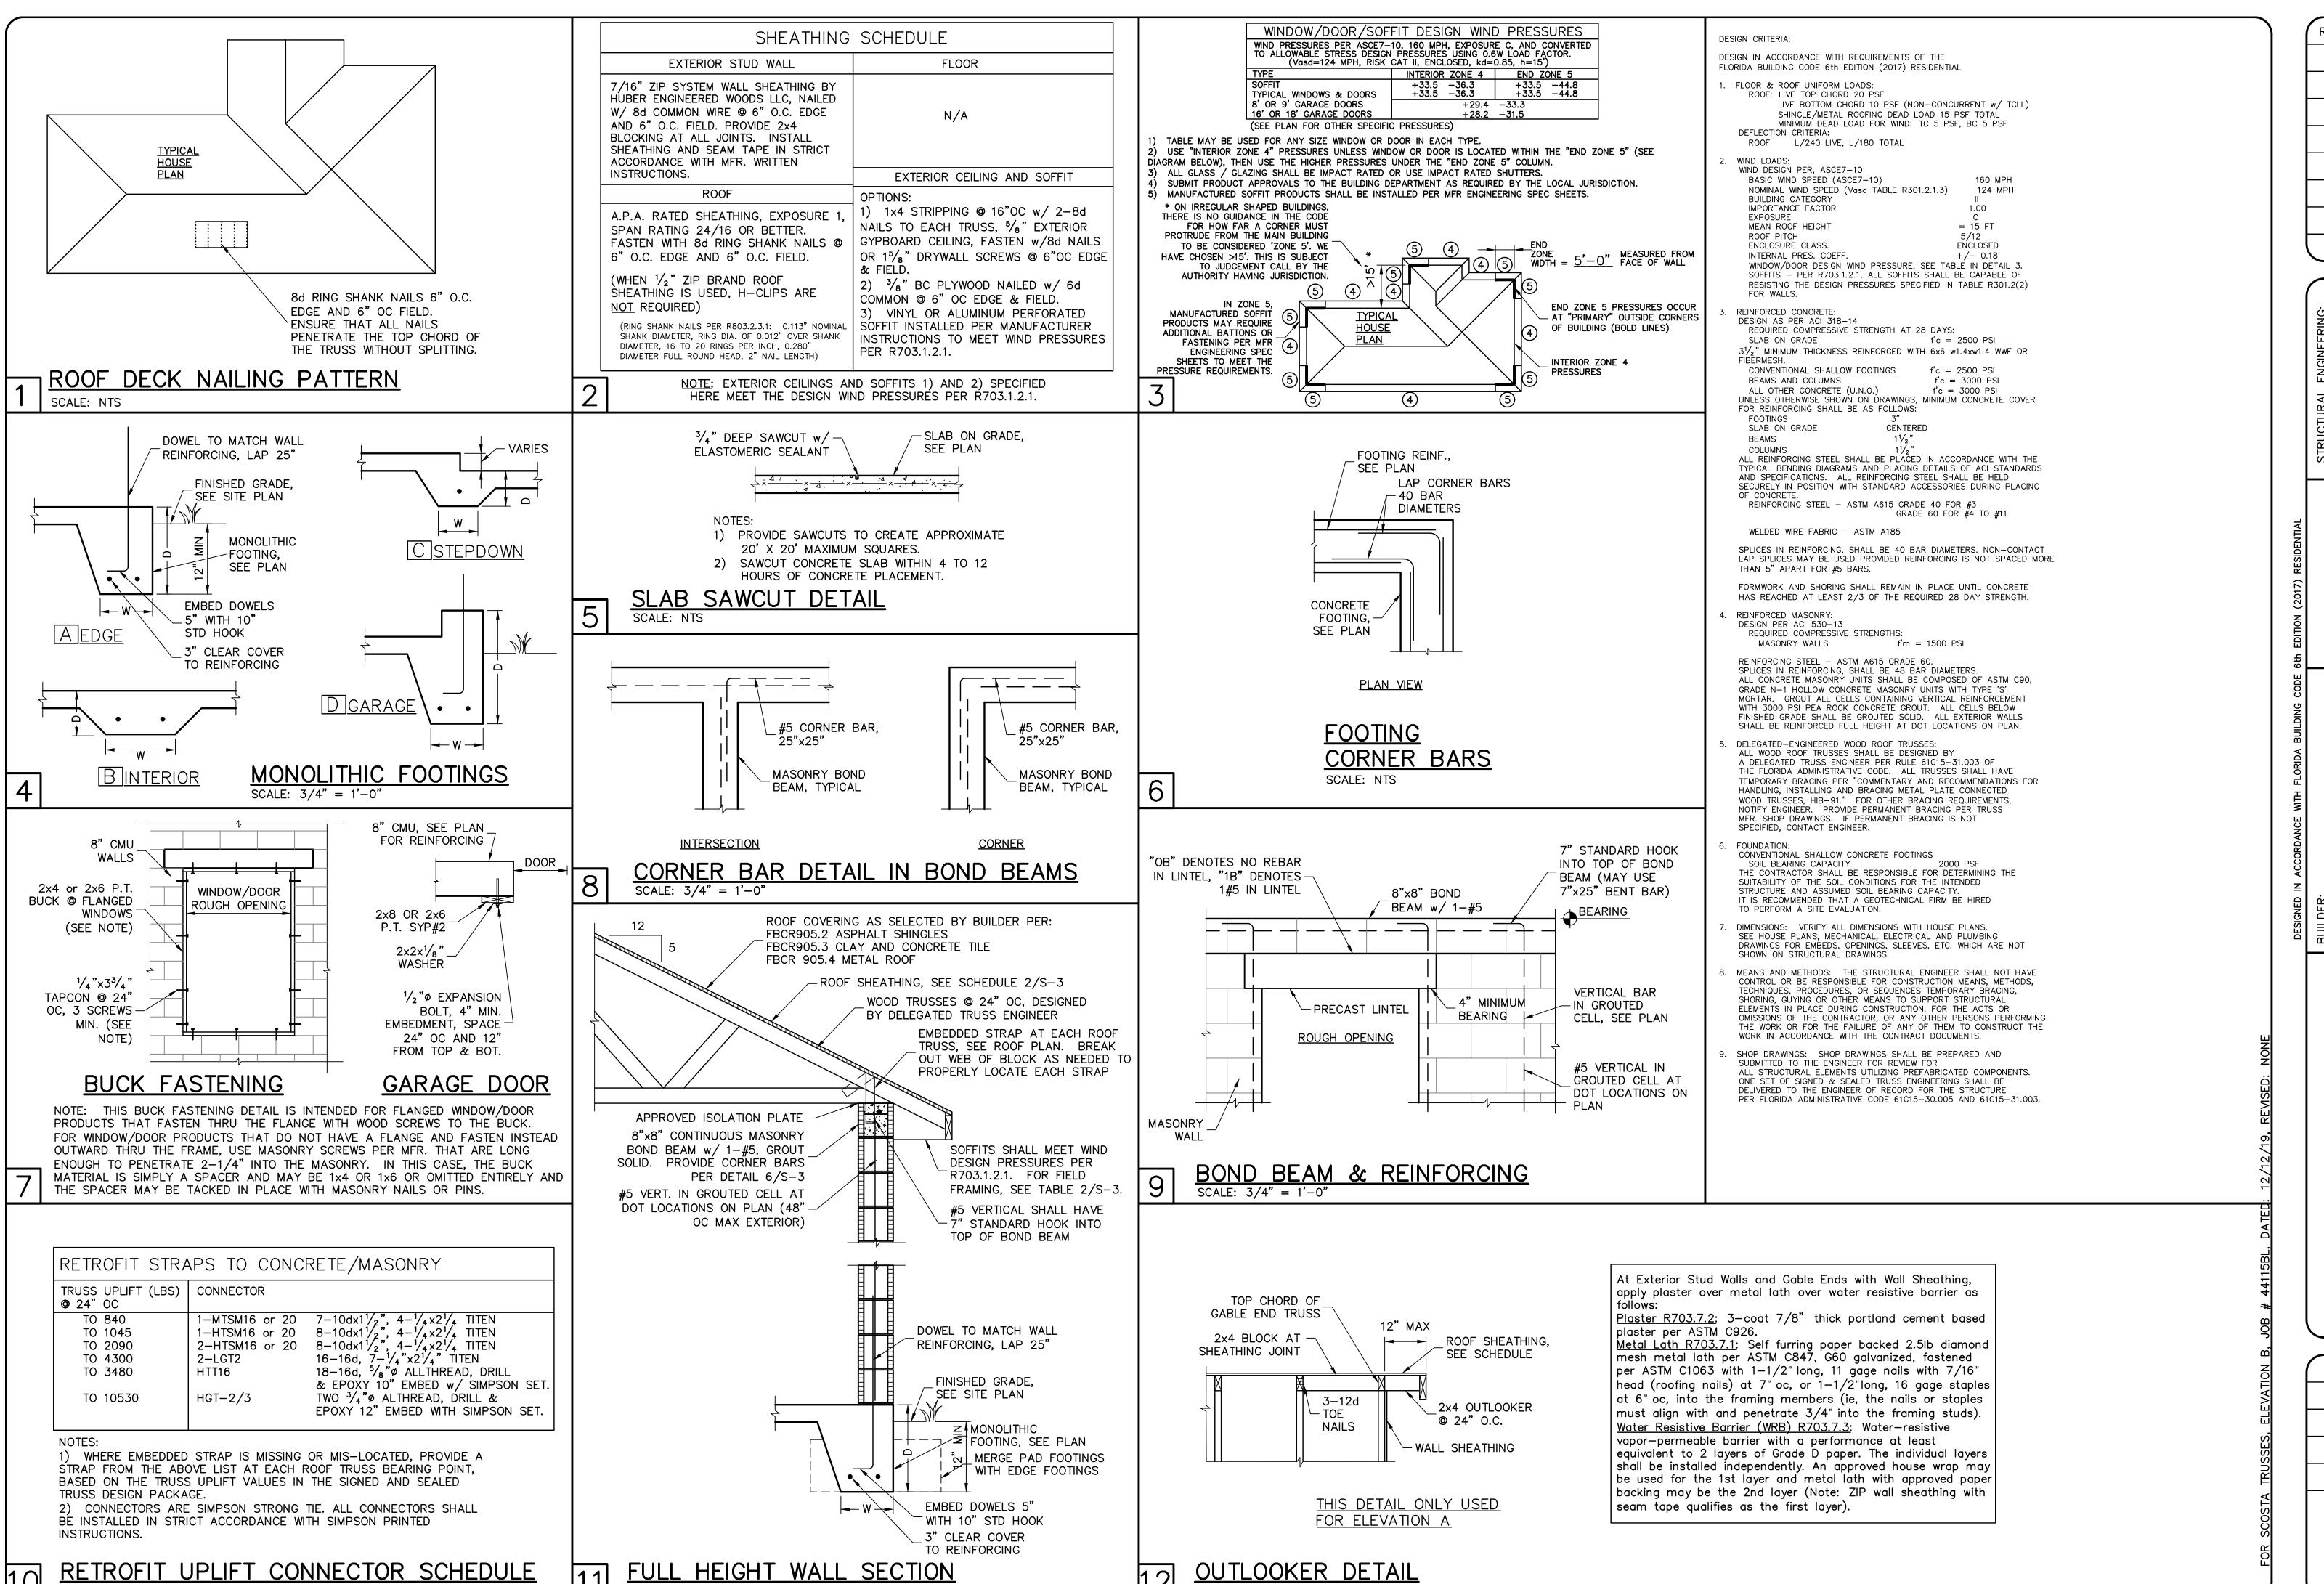

REVISIONS

OKTON 104 Bu D-R-H

JURAL 389 E 325 MARSH ABELLE, FLO T: 18 BLOCK STRU

DESIGN/DRAWN DWB/DWB CHECKED DWB 11/4/20 SCALE **VARIES** JOB NO. DR 12099

SHEET

SHEET 3 OF 3