




Engineer of Record for the Structure Structural Systems of N. Fl, Inc. Raul Reyes, PE 88925 1634 SE 47th Street #3 Cape Coral, FL 33904


This document has been reviewed for conformance with the design intent of the structure and specified design criteria.


Accepted	Accepted	Revise and
As-Is	As Noted	☐ Resubmit

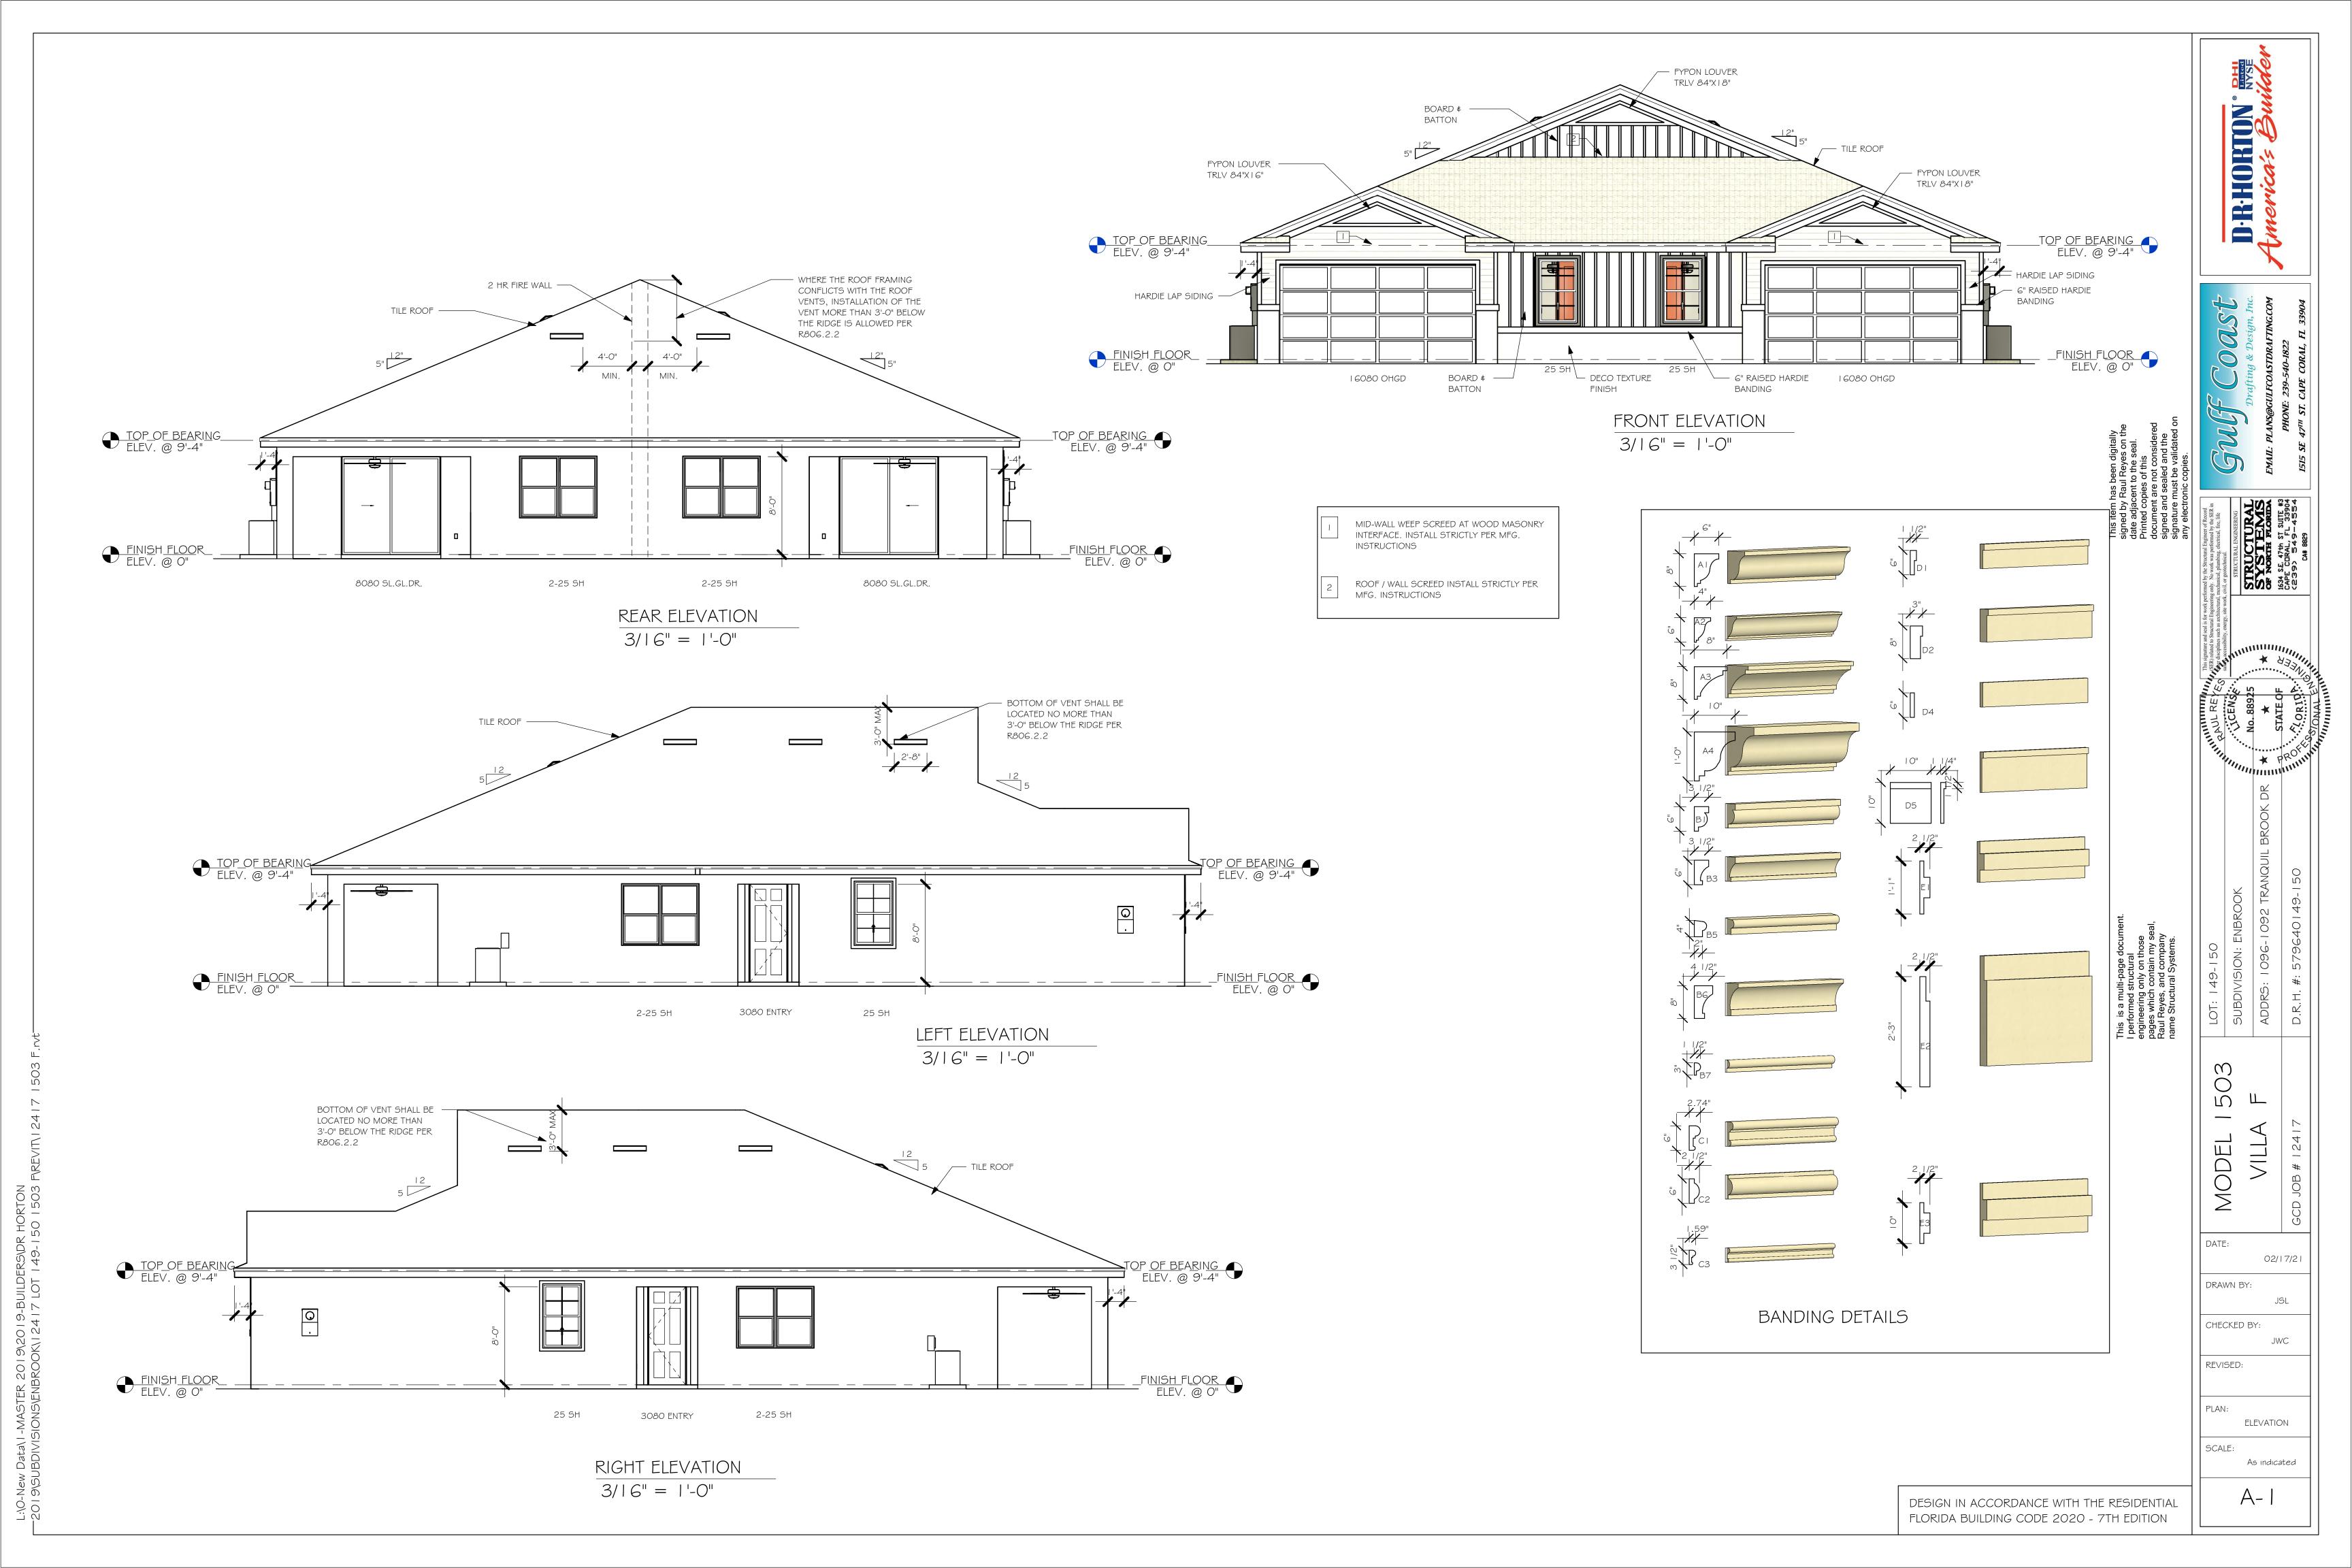


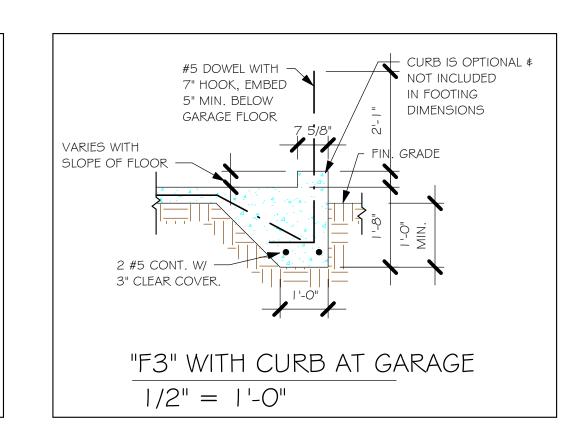


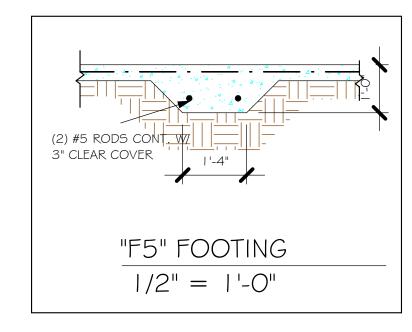


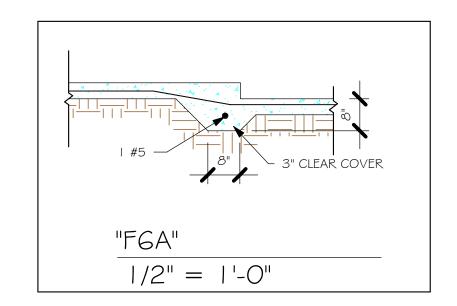

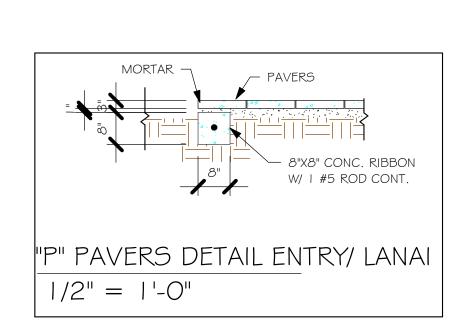

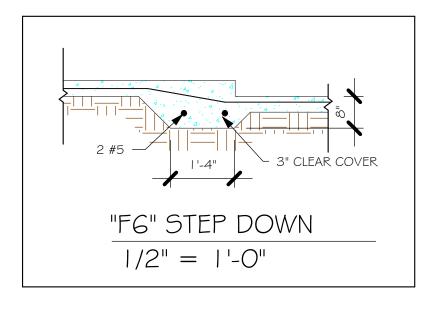

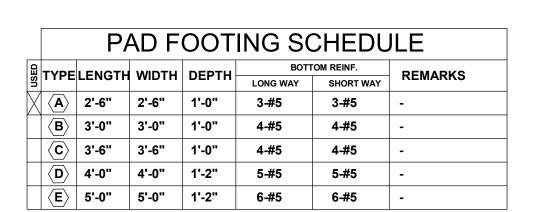

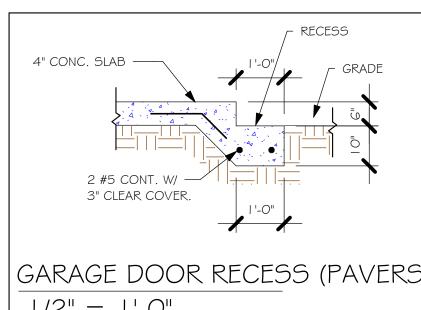

WALL FOOTING SCHEDULE

USED	TYPE	LENGTH	WIDTH	DEPTH	BOTTOM REINFORCING	SHAPE	
	F1	CONT.	1'-4"	0'-8"	2-#5		
	F2	CONT.	1'-8"	0'-10"	2-#5		
X	F3	CONT.	1'-0"	1'-8"	2-#5	₩	ADD CURE GARAGE, S DETAIL
	F4	CONT.	1'-4"	1'-8"	2-#5	\vdash	
X	F5	CONT.	1'-4"	1'-0"	2-#5	—	
X	F6	CONT.	1'-4"	1'-0"	2-#5		
X	F6A	CONT.	0'-8"	0'-8"	1-#5		
	TE	CONT.	0'-8"	0'-8"	1-#5		


12 33H1: 0-3 0-3 1-#3 PROVIDE CORNER BARS IN FOOTING PER DETAIL 6/S-I


FOUNDATION PLAN

SCALE: 3/16" = 1'-0" **PLAN NOTES:**

TOP OF GROUND FLOOR SLAB DATUM ELEVATION 0'-0"

- "F#" DENOTES CONTINUOUS WALL FOOTING TYPE PER SCHEDULE THIS SHEET. /#\ DENOTES PAD FOOTING AT CONCENTRATED LOADS PER SCHEDULE THIS SHEET.
- PROVIDE #5 VERTICAL REINFORCING AT DOT LOCATIONS SHOWN ON PLAN FROM FOOTING TO BOND BEAM. ALL DIMENSIONS ARE TO OUTSIDE FACE OF MASONRY WALLS. SOME SLAB EDGES MAY EXTEND BEYOND FACE OF WALL.
- FOR DIMENSIONS OF ROUGH OPENINGS IN MASONRY WALLS, COORDINATE WITH WINDOW/ PROVIDE PRESSURE TREATED BUCKS AT WINDOWS/ DOORS PER DETAIL 7/S-1.

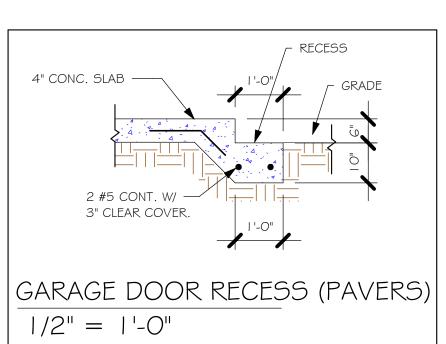

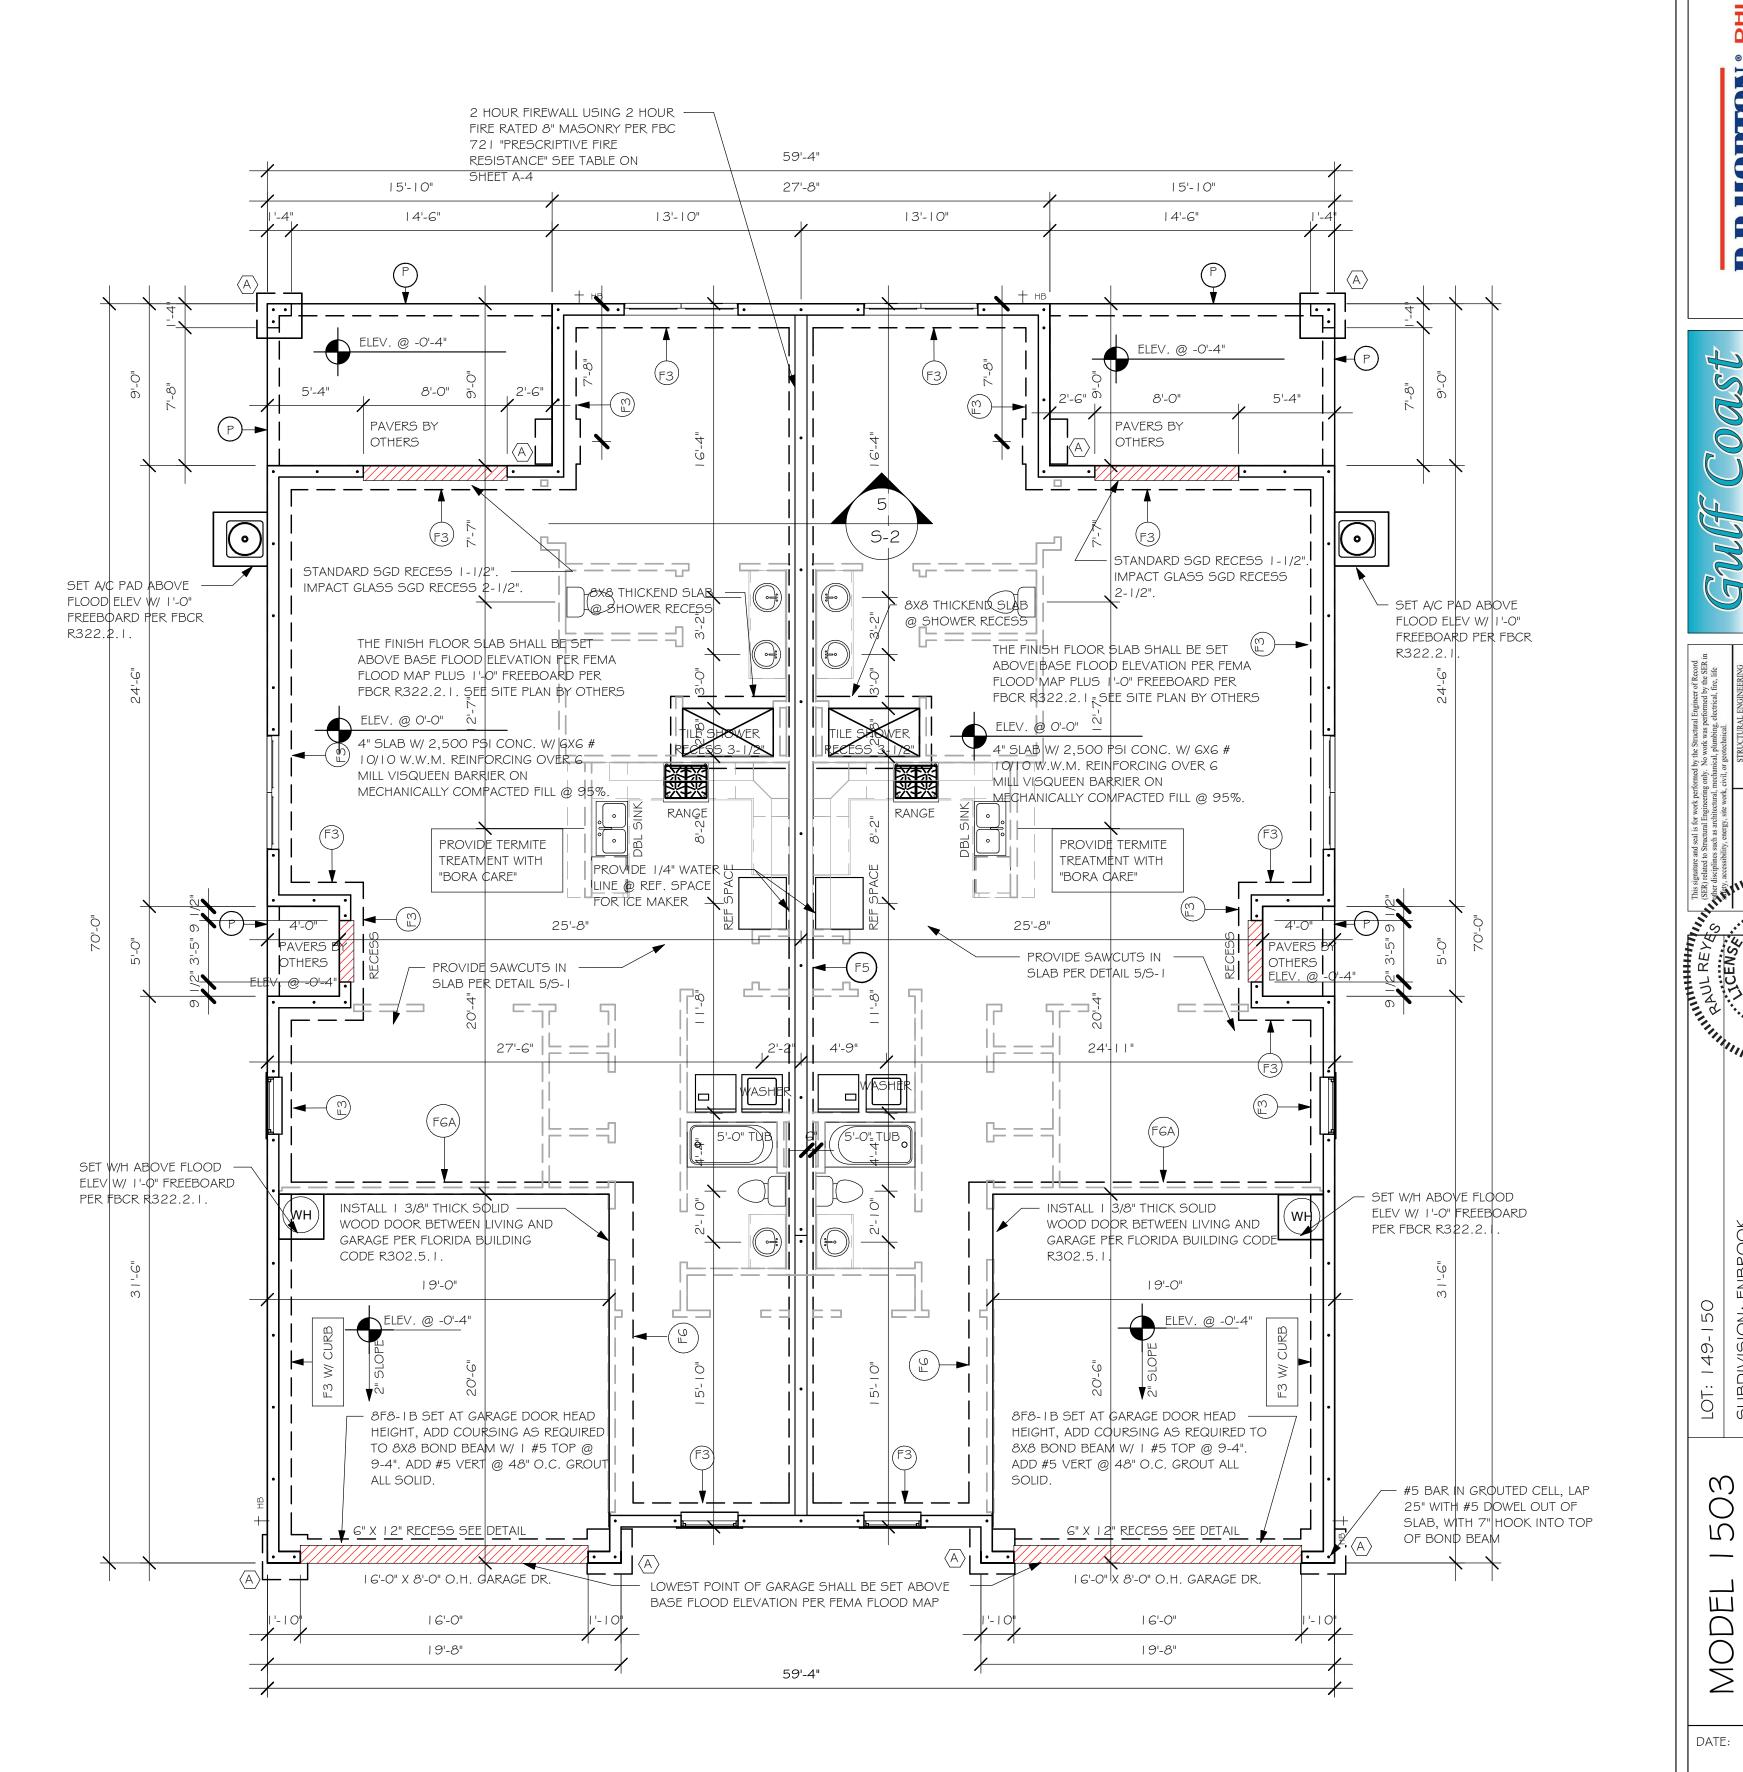

FOUNDATION PLAN 3/16" = 1'-0"

> DESIGN IN ACCORDANCE WITH THE RESIDENTIAL FLORIDA BUILDING CODE 2020 - 7TH EDITION

STRUCTURAL SYSTEMS OF NORTH FLORIDA 1634 S.E. 47th ST SUITE #3 CAPE CIRAL, FL 33904 (239) 549-4554

02/17/21

JWC

FOUNDATION

As indicated

DRAWN BY:

CHECKED BY:

REVISED:

SCALE:

	DOOR SCHEDULE							
					ULL			
TYPE								
MARK	DESCRIPTION	COMMENTS	HEIGHT	WIDTH	ZONE 4	ZONE 5	QTY	
1	16080 OHGD	GARAGE DOOR	8'-0"	16'-0"	+21.6/-24.1	+21.6/-24.1	2	
2	2-4080 SL. GL. DR.	IMPACT	8'-0"	8'-0"	+22.6/-25.6	+22.6/-25.6	2	
3	3080 ENTRY	DISTINCTION	8'-0"	3'-0"	+25.6/-27.7	+25.6/-34.3	2	

	WINDOW SCHEDULE						
MARK	DESCRIPTION	COMMENTS	HEIGHT	WIDTH	ZONE 4	ZONE 5	QTY
А	25 SH	IMPACT	5'-5"	3'-4"	+25.6/-27.7	+25.6/-34.3	4
В	2-25 SH	IMPACT	5'-3"	6'-4"	+25.6/-27.7	+25.6/-34.3	4

WIIND PRESSURES PER ASCE7-16 170 MPH, EXPOSURE B AND CONVERTED TO ALLOWABLE STRESS DESIGN PRESSURES USING O.GW LOAD FACTOR. Vasd= 132 MPH

DOOR HEADERS						
6'-8" BI-FOLD HEADER HEIGHT 82" A.F.F.						
6'-8" SWING	HEADER HEIGHT	82 I/2" A.F.F.				
8'-0" SWING	8'-O" SWING HEADER HEIGHT 98 1/2" A.F.F.					

PLAN NOTES

- VERIFY ALL ROUGH OPENING DIMENSIONS FOR ALL WINDOWS AND DOORS
- 2) PROVIDE SAFETY GLAZING WITHIN 24" FROM EXIT

PER FLORIDA BUILDING CODE R 308.4.2.

- 3) PROVIDE SAFETY GLAZING AT BATH/ SHOWER PER FLORIDA BUILDING CODE R 308.4.5.
- 4) NON BEARING INTERIOR FRAME WALLS SHALL BE FRAMED W/ WOOD OR METAL STUDS. SPACING SHALL NOT EXCEED 24" O.C. (NON BEARING WALLS ONLY)
- 5) PROVIDE DEAD WOOD IN ATTIC FOR OVERHEAD GARAGE DOOR HARDWARE
- 6) KITCHEN KNEE WALL TO BE FRAMED W/ TOP @ 34 1/2" A.F.F.
- 7) INSTALL SMOOTH WALLS IN KITCHEN AND ALL BATHROOM AREAS
- 8) WHERE DRYWALL CEILING IS APPLIED TO TRUSSES @ 24" O.C. USE 5/8" DRYWALL OR 1/2" SAG
- 9) THE GARAGE SHALL BE SEPARATED FROM THE RESIDENCE & ATTIC BY NOT LESS THEN 1/2" GYPSUM BOARD APPLIED TO THE GARAGE SIDE. GARAGES BENEATH HABITABLE ROOMS SHALL BE SEPARATED WITH NOT LESS THAN 5/8" TYPE "X" GYPSUM BOARD OR EQUIVALENT. WHERE THE SEPARATION IS A FLOOR CEILING ASSEMBLY, THE STRUCTURE SUPPORTING THE SEPARATION SHALL ALSO BE PROTECTED BY NOT LESS THAN 1/2" GYPSOM BOARD
- 10) INSTALL I 3/8" THICK SOLID WOOD DOOR BETWEEN LIVING AND GARAGE PER FLORIDA BUILDING CODE R302.5.1.

OR EQUIVALENT


- 11) ALL WINDOWS INSTALLED 72" ABOVE GRADE MUST COMPLY WITH R312.2 MIN 24" SILL HEIGHT OR PROVIDED WITH AN APPROVED WINDOW FALL PREVENTION DEVICE
- 12) ALL CLOSET SHELVES TO BE 12". ALL PANTRY \$
 LINEN TO BE (4)-16" SHELVES 18" O.F.F. W/ 15"
 INCREMENT.
- 13) ALL MECHANICAL AND ELECTRICAL EQUIPMENT TO BE INSTALLED AT OR ABOVE FLOOD PLUS 1'-O" FREEBOARD.

IN	INTERIOR DOOR SCHEDULE						
MARK	DOOR WIDTH	NOTES					
	3'-0"	P.K. = POCKET DOOR					
2	2'-8"	B.F. = BI-FOLD DOOR					
3	2'-6"	D.1 . — DI-1 OLD DOOK					
4	2'-4"	B.P. = BI-PASS DOOR					
5	2'-0"	L.V. = LOUVERED DOOR					
6	1'-8"						
7	1'-6"						
8	2'-11"						


SQUARE FOOTAGE L	JNIT #1
LIVING AREA	1,503
GARAGE AREA	391
LANAI AREA	143
FRONT PORCH/ ENTRY AREA	20
TOTAL SQUARE FOOTAGE	2,057


CABINET BACKING					
KITCHEN	UPPER TOP @ 84"	BASE TOP @ 35"			
MASTER BATH	UPPER	BASE TOP @ 35"			
GUEST BATH	UPPER	BASE TOP @ 31"			
LAUNDRY ROOM	UPPER TOP @ 84"	BASE			

SQUARE FOOTAGE U	NIT #2
LIVING AREA	1,503
GARAGE AREA	391
LANAI AREA	143
FRONT PORCH/ ENTRY AREA	20
TOTAL SQUARE FOOTAGE	2,057

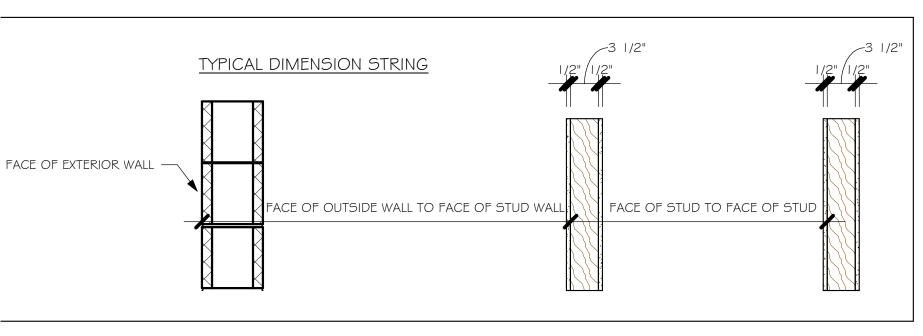

	BATHROOM NOTES
TB TOWEL BAR	ALL TUB DECKS @ 21" A.F.F
TP TOILET PAPER	ALL BLOCKING TO BE PT IN SHOWERS

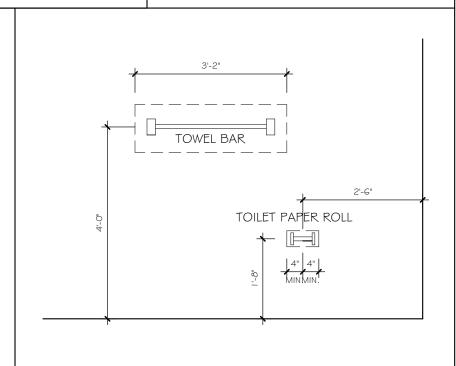

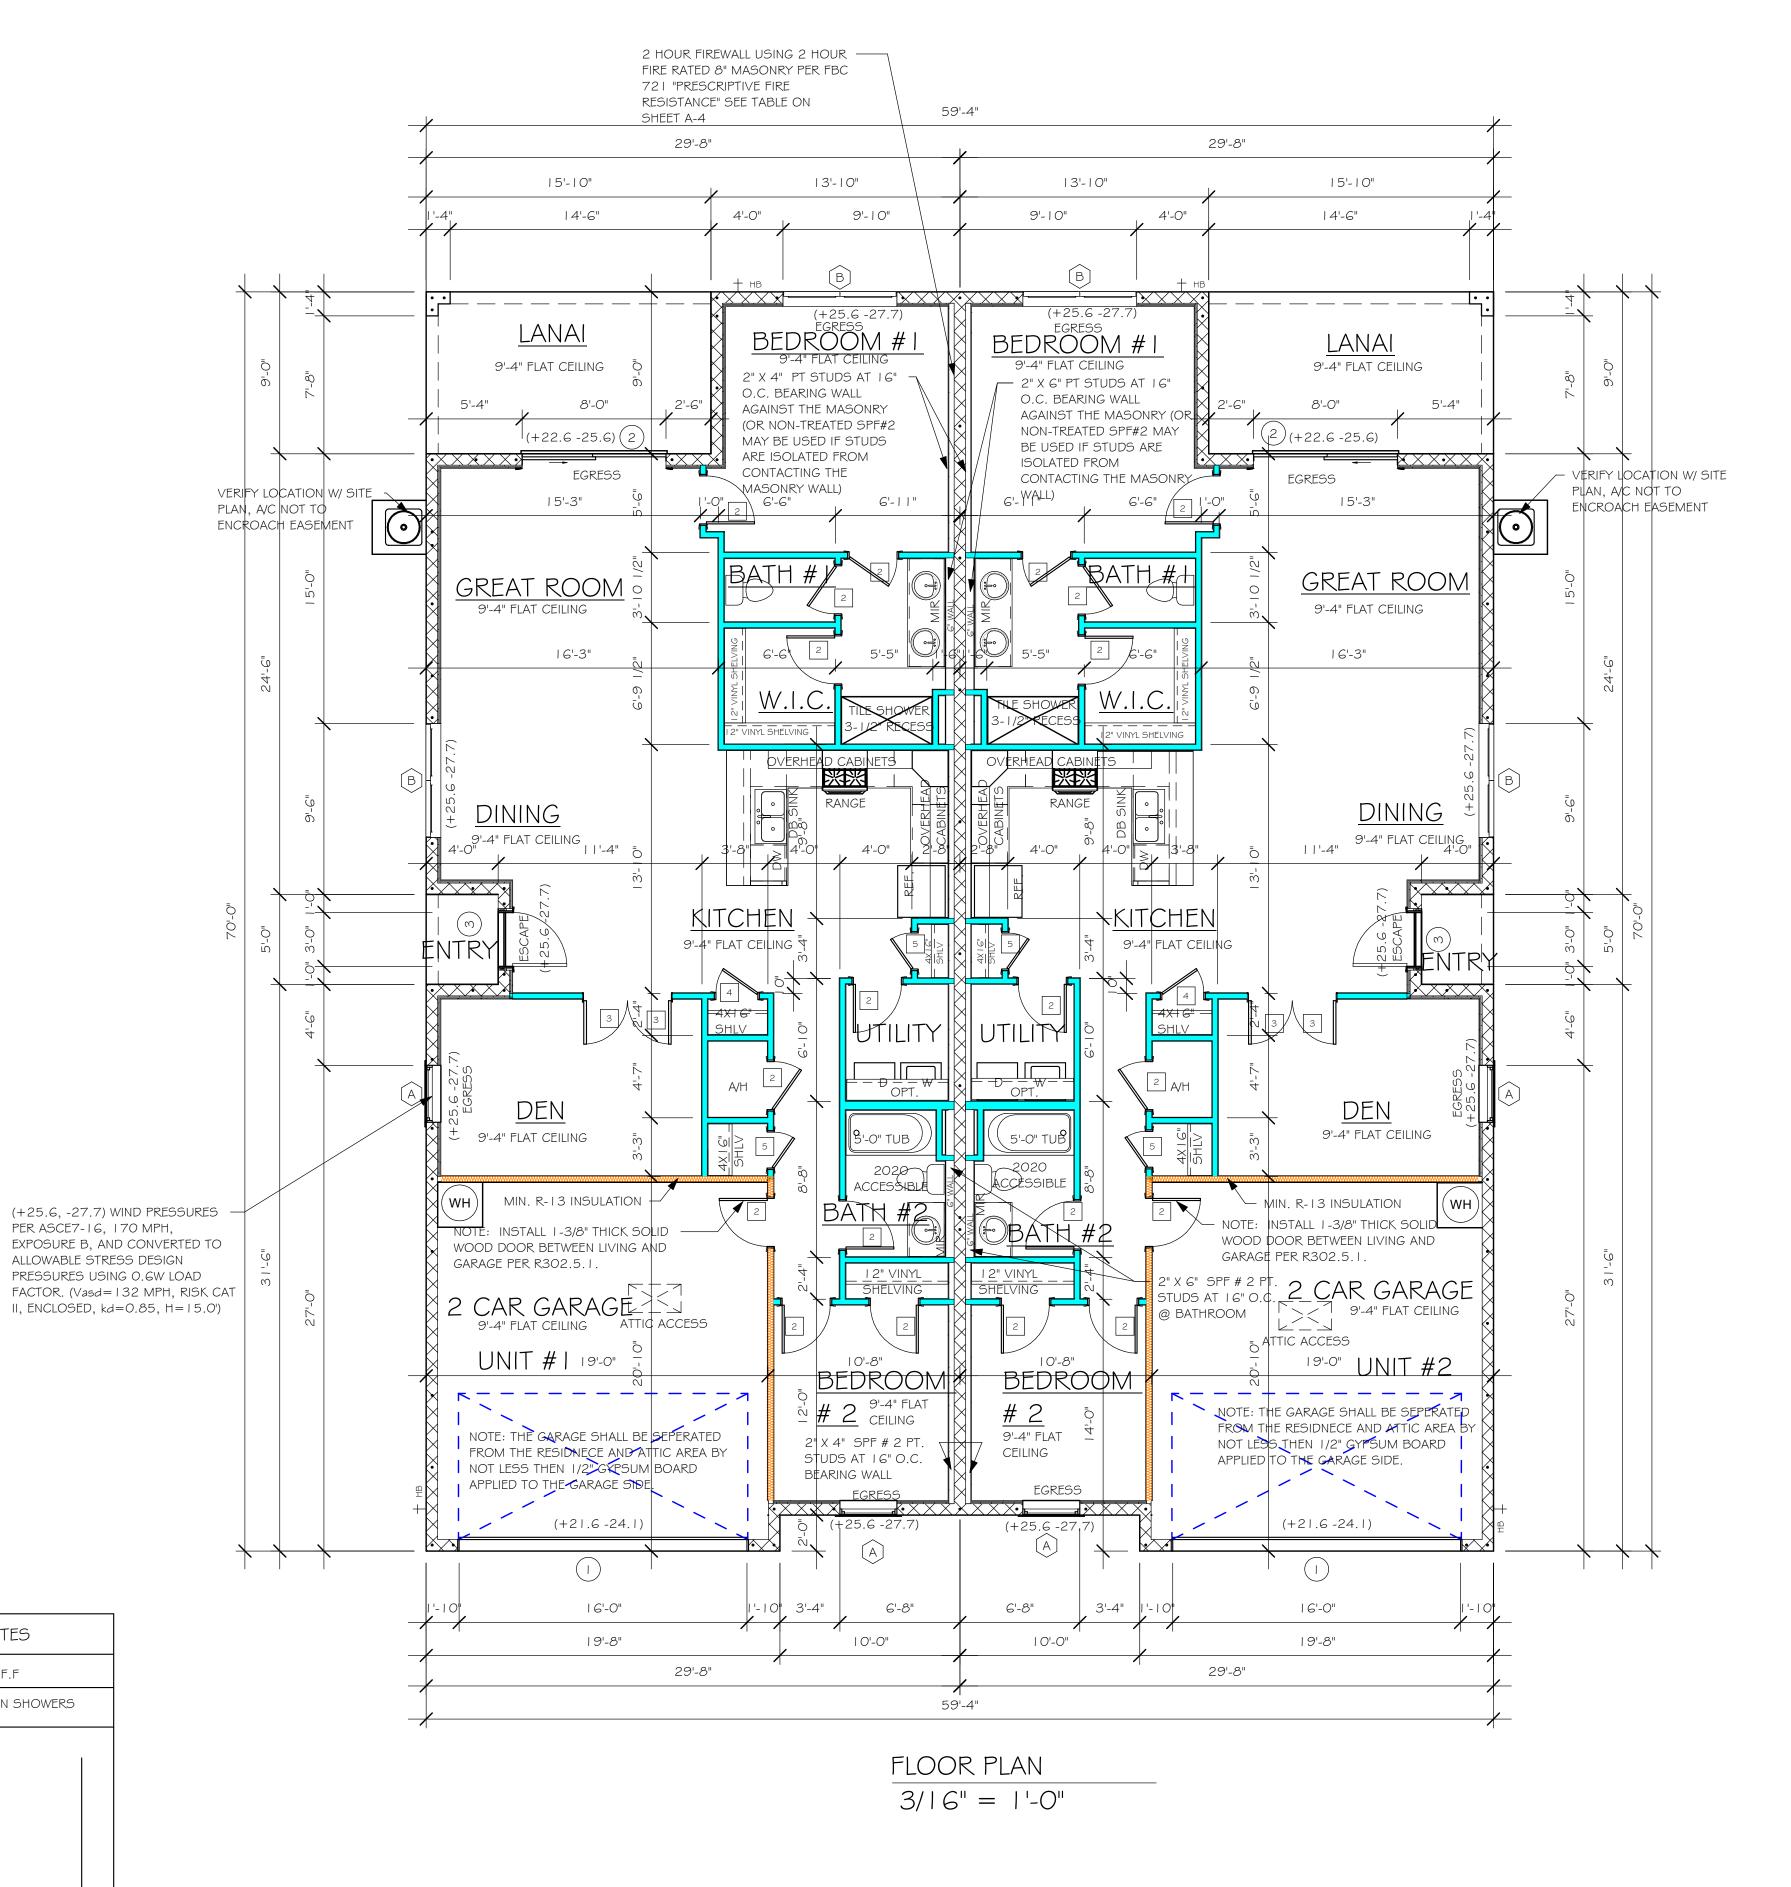

 \Box

DATE:

DRAWN BY:

CHECKED BY:

REVISED:

SCALE:

DESIGN IN ACCORDANCE WITH THE RESIDENTIAL FLORIDA BUILDING CODE 2020 - 7TH EDITION

02/17/21

JWC

FLOOR

As indicated

//ASTER_2019/2019-BUILDERS/DR_HORTON DNS\ENBROOK\12417 LOT_149-150_1503_F\REVIT\12417_1

	TRUSS STRAPPING TO MASONRY				
	MAX TRUSS UPLIFT @ 24" OC (LBS)	CONNECTOR	FASTENER		
INSTALL — META I G AT ALL TRUSSES TO I 450 Ib UPLIFT. FOR HIGHER UPLIFTS, SEE NOTES ON PLAN.	1450 1810 2120 1875 (1 PLY) 1795 (2 PLY) 2365 (2 PLY) 2365 (2 PLY) 3965/SYP 3330/SPF 4235/SYP 3640/SPF 4670/SYP 4015/SPF 5445/SYP 5360/SPF 10690/SYP 10690/SPF	(1) META 1 G TO 40 (1) HETA 1 G TO 40 (1) HHETA 1 G TO 40 (2) META 1 G TO 40 (2) META 1 G TO 40 (2) HETA 1 G TO 40 (2) HHETA 1 2 TO 40 MGT (2 PLY) HTT4 HTT5 HTT5KT (1) HGT - 2	(8) 0.148x1 ^{1/2} ", EMBED 4" (9) 0.148x1 ^{1/2} ", EMBED 4" (10) 0.148x1 ^{1/2} ", EMBED 4" (10) 0.148x1 ^{1/2} ", EMBED 4" (14) 0.162x3 ^{1/2} ", EMBED 4" (12) 0.162x3 ^{1/2} ", EMBED 4" (12) 0.162x3 ^{1/2} " EMBED 4" (22) 0148x3" ATR, EPOXY 12" (18) 0.162x2 ^{1/2} ", ^{5/8} " ATR, EPOXY 12" (26) 0.148x3", ^{5/8} ", ATR, EPOXY 12" (26) 5D#10x2 ^{1/2} , ^{5/8} , "ATR, EPOXY (26) 0.148x3" TO GIRDER (2) 3/4" Ø ATR, EPOXY 12" (16) 0.148x3" TO GIRGER, (2) 3/4" Ø ATR, EPOXY 12"		

PROVIDE A STRAP FROM THE ABOVE LIST AT EACH ROOF TRUSS BEARING POINT, BASED ON THE TRUSS UPLIFT VALUES IN THE SIGNED AND SEALED TRUSS DESIGN PACKAGE AND SUITABLE FOR THE GEOMETRY. EMBED STRAP ON -C OF WALL.

CONNECTORS ARE SIMPSON STRUCTURAL CONNECTORS. ALL CONNECTORS SHALL BE INSTALLED IN STRICT ACCORDANCE WITH SIMPSON PRINTED INSTUCTIONS. SUBSTITUTIONS MUST BE APPROVED IN WRITING BY THE ENGINEER OF RECORD.

WHERE EMBEDDED STRAPS ARE MISSING, OR MIS-LOCATED, INSTALL RETROFIT STRAP PER


SIMPSON CATALOG C-C- 2019

INSTALL AT ALL	TRUSS STRAPPING TO) STUDWALL/ WOOD BE	AM
TRUSSES TO 840 Ib UPLIFT.	MAX TRUSS UPLIFT @ 24" OC (LBS)	CONNECTOR	FASTENER
FOR HIGHER UPLIFTS, SEE NOTES ON PLAN.	850 1700 2550 1125 2250 3375 4500	(1)MT516 TO 20 (2) MT516 TO 20 (3) MT516 TO 20 (1) HT520 TO 30 (2) HT520 TO 30 (3) HT520 TO 30 (4) HT520 TO 30	(14) Odx - /2" (14) Odx - /2" (14) Odx - /2" (24) Odx - /2" (24) Odx - /2" (24) Odx - /2"

PROVIDE A STRAP FROM THE ABOVE LIST AT EACH ROOF TRUSS BEARING POINT, BASED ON THE TRUSS UPLIFT VALUES IN THE SIGNED AND SEALED TRUSS DESIGN PACKAGE.

CONNECTORS ARE SIMPSON SRTONG TIE. ALL CONNECTORS SHALL BE INSTALLED IN STRICT ACCORDANCE WITH SIMPSON PRINTED INSTUCTIONS.

SIMPSON CATALOG C-C- 2019

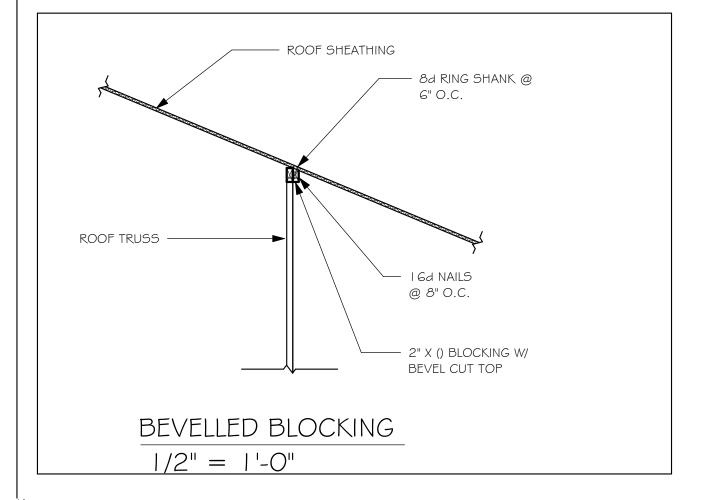

PLAN NOTES:

- ROOF TRUSS BEARING ELEVATION VARIES, SEE
- ROOF FRAMING SHALL BE WOOD TRUSSES DESIGNED BY A DELEGATED TRUSS ENGINEER PER DESIGN CRITERIA ON SHEET S-I.
- PROVIDE STRAPPING AT TRUSSES PER NOTES ON THIS
- FOR NAILING OF ROOF DECK, SEE I AND 2 ON S-I. 8F8-IB etc., DENOTES PRECAST LINTEL ABOVE
- DOOR/WINDOW OPENING PER SCHEDULE THIS SHEET. AT TRUSS BEARING, PROVIDE 8x8 MASONRY BOND BEAM W/ I #5 CONTINUOUS, SEE DETAIL I I/S-I.


2 HOUR FIREWALL USING 8" MASONRY PER FBC 72 "PRESCRIPTIVE FIRE RESISTANCE"										
F.B.C. TABLE 722.3.2										
MINIMUM EQUIVALENT THICKNESS (IN) BEARING OR NON-BEARING CONCRETE MASONRY WALLS										
TYPE OF AGGREGATE		FIRE - RESISTANCE RATING (HOURS)								
			2	HR						
I . PUMICE OR EXPANDED SLAG			3.2"							
2. EXPANDED SHALE, CLAY OR SLATE			3.6"							
3. LIMESTONE, CINDERS, OR UNEXPANDED SLAG			4.0"							
4. CALCAREOUS OR SILICEOUS GRAVEL			4.2"							


FOR THE 2 HOUR FIREWALL, PURCHASE ONLY BLOCK WITH 2 HOUR FIRE


RATED MARKING, LABEL OR DOCUMENTATION.

MODEL 1503: ATTIC VENTILATION FBCR R806

COORDINATE VENTING REQUIREMENTS WITH ENERGY CALCULATIONS											
			SOFFIT O (NO ROOF	NLY (1/150) F VENTS)	WITH ROOF VENTS (1/300) (R.V.)						
AREAS (SQ. FT.)		·	ILATION REQUIRED VI 50= I 4.55 SQ. FT.)	ATTIC VENTILATION REQUIRED (ATTIC AREA/300 = 7.28 SQ. FT.)							
MARK	ATTIC	SOFFIT	REQ'D AIR FLOW OF SOFFIT	QUAD 4 SOFFIT HAS	QUANTITY OF ROOF VENTS	MIN AIR FLOW OF SOFFIT					
	2183.0 SQ. FT.	148.0 SQ. FT.	9.83%	8.15%	4	2.7%					
	"SOFFIT ONLY" DOES NOT QUALIFY				ROOF VENTS ARE REQUIRED						
			SOFFIT MODEL ACM QUAD 4, FULL VENT, NARROW PATTERN, 8.15% FREE AIR FLOW		ROOF VENT MODEL 32" BASE 8/8/ 27 LOMANCO 770-D 0.97 SQ. FT. FREE AIR						

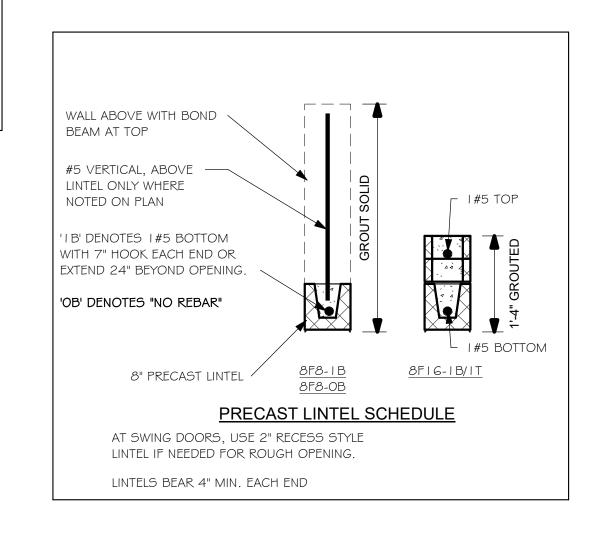

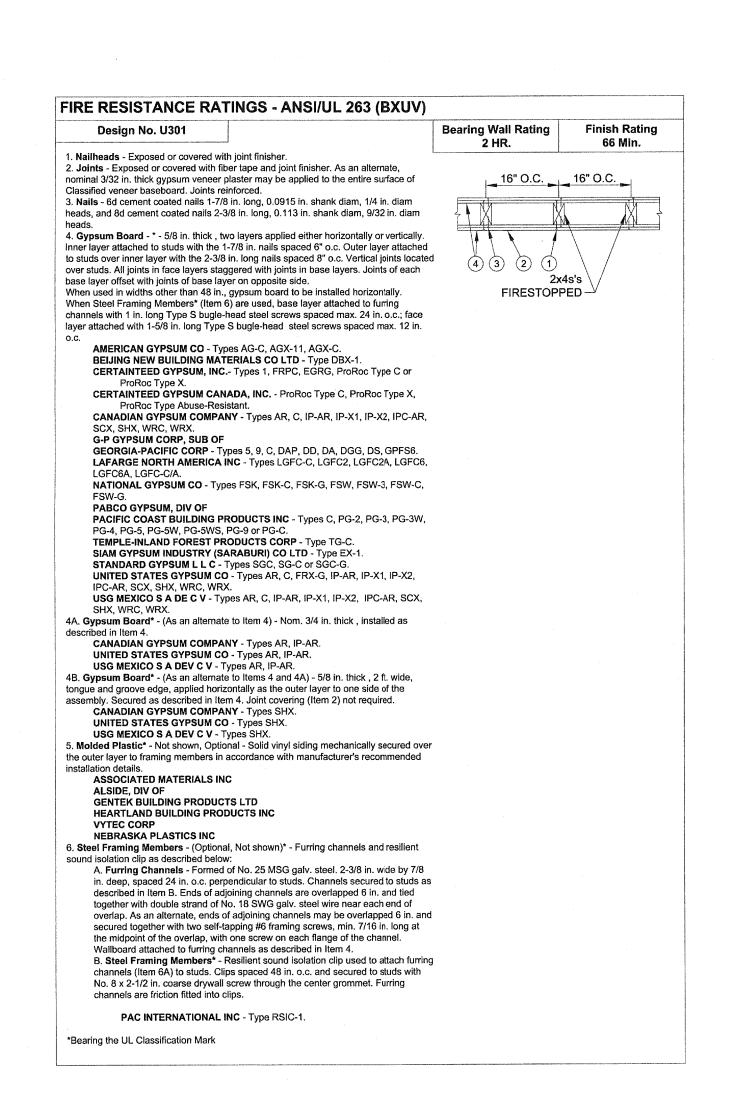

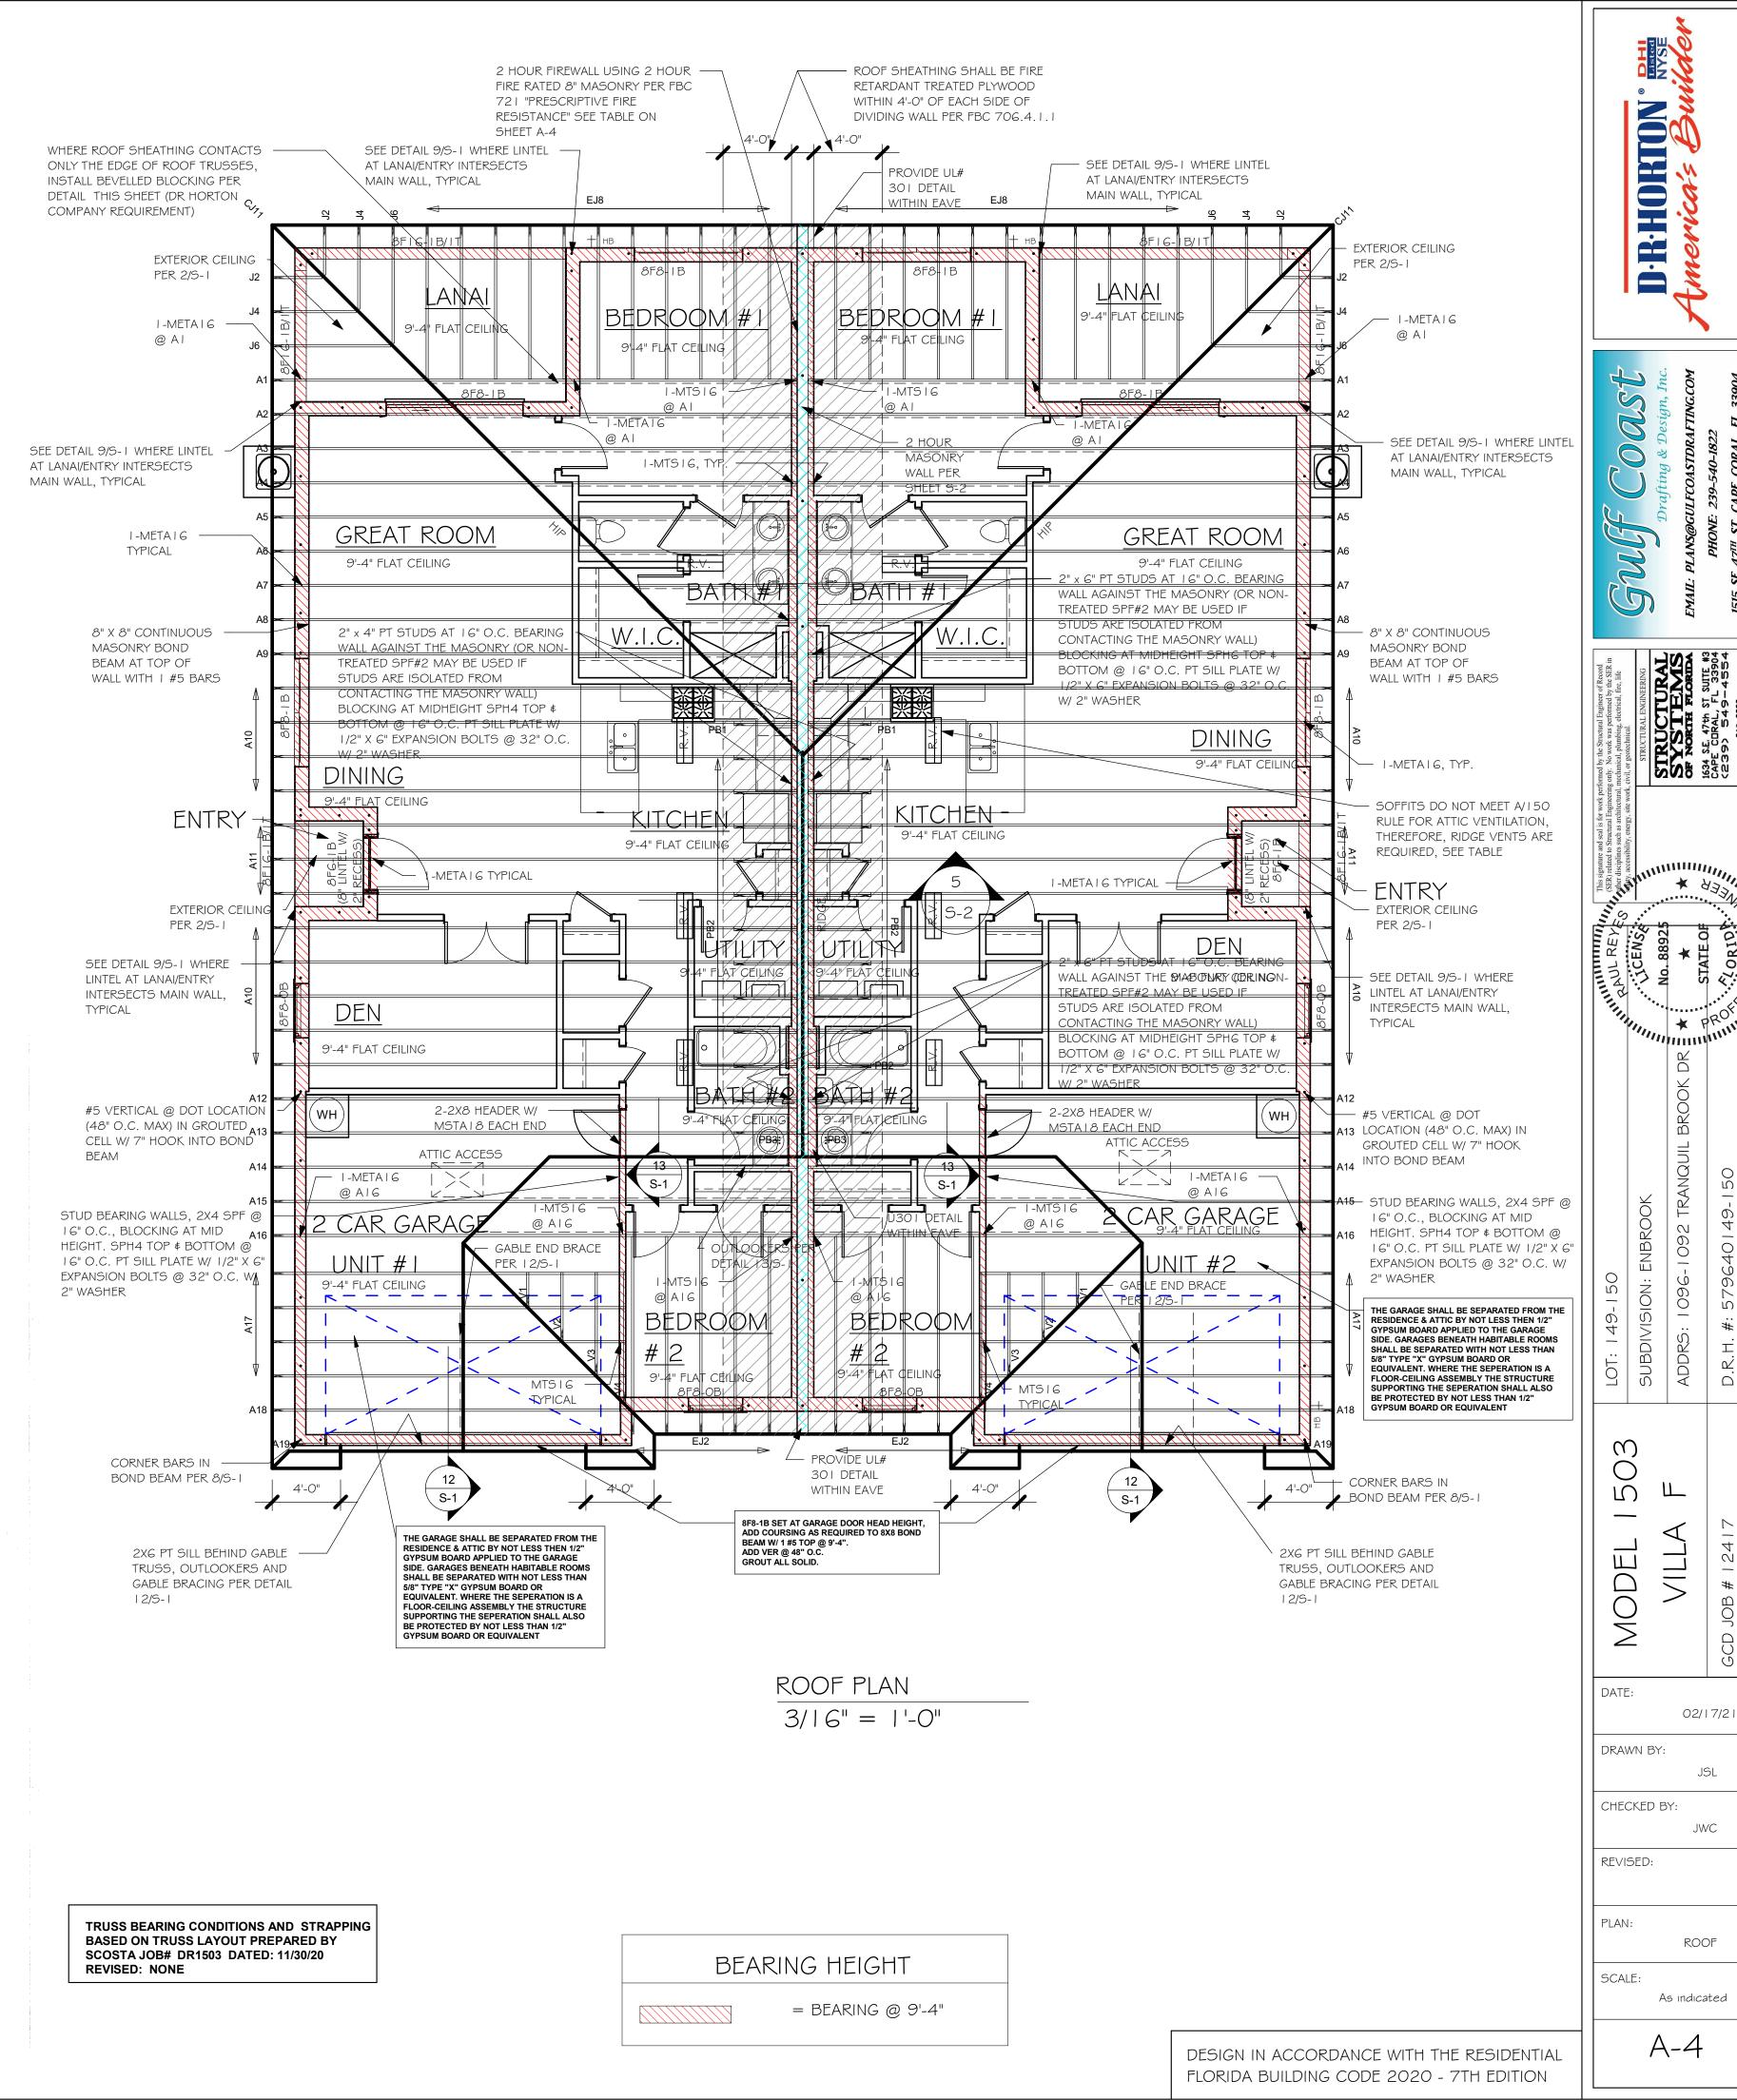


DATE: 02/17/21 DRAWN BY:

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JSL CHECKED BY: JWC REVISED:

ELECTRICAL SCALE: As indicated

FLORIDA BUILDING CODE 2020 - 7TH EDITION

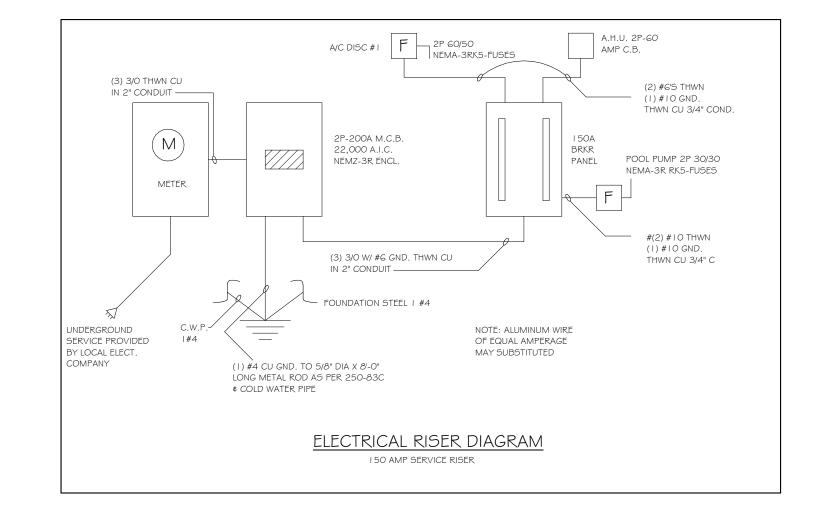

PRIOR TO ORDERING ROOF TRUSSES, THE CONTRACTOR SHALL WORK WITH THE AIR CONDITIONING SUB CONTRACTOR TO DESIGN/PLAN AND LAYOUT THE LOCATION OF AIR HANDLING EQUIPMENT, AIR DUCT SIZE AND LOCATION AND COORDINATE THAT DESIGN WITH THE TRUSSES FOR SPACE, CONNECTIVITY, AND POSITION REQUIREMENTS.

THE CONTRACTOR MUST ADVISE THE TRUSS COMPANY PRIOR TO ANY CONSTRUCTION OF TRUSSES OF THE AIR CONDITIONING/HANDLING EQUIPMENTS SIZES AND WEIGHT AND DUCT LAYOUT CONCERNS OR REQUIREMENTS THAT MAY HAVE THE POTENTIAL TO CHANGE OR MODIFY THE TRUSSES TO ACCOMODATE THE SAME. THE CONTRACTOR SHALL COORDINATE CONDENSATION DISCHARGE LINE LOCATION, AND ELECTRICAL SERVICE TO AIR EQUIPMENT, AND PROVIDE ANY LOCAL DISCONNECTS, LIGHTS AND SERVICE PLATFORMS THAT MAY BE REQUIRED.

ELECTRICAL NOTES FOR FIRE RATED WALLS

ELECTRICAL OUTLETS PLACED IN FIRE RATED WALLS SHALL BE IN CONFORMANCE WITH THE UNDERWRITERS LABORATORIES, INC., FIRE RESISTANCE DIRECTORY, CURRENT EDITION. THESE REQUIREMENTS INCLUDE, BUT ARE NOT LIMITED TO, THE FOLLOWING SPECIFIC ITEMS:

A) INDIVIDUAL OUTLET/SWITCH BOXES SHALL OT EXCEED (16) SQUARE INCHES IN AREA.

B) AGGREGATE AREA OF OUTLET/SWITCH BOXES SHALL NOT EXCEED (100) SQUARE INCHES WITHIN (100) SUARE FEET OF

C) OUTLET/SWITCH BOXES LOCATED ON OPPOSITE SIDE OF THE SAME WALL SHALL BE SEPERATED BY A MINIMUM OF (24)

D) ALL OUTLET/SWITCH BOXES SHALL BE SECURELY ATTACHED TO THE STUDS AND THE OPENING IN THE WALL BOARD FACING SHALL BE CUT SO THAT THE CLEARANCE BETWEEN THE BOX AND THE WALLBOARD DOES NOT EXCEED 1/8 INCH.

-TV TELEVISION RECEPTION OUTLET — SURFACE MOUNTED CEILING LIGHT FLUSH MOUNTED LIGHT WALL MTD. BRACKET LIGHT DUPLEX FLOOD LIGHT EXHAUST FAN _♥♥ TRACK MTD. LIGHTS ☐ A/C DISCONNECT PUSH BUTTON (PB) / DOOR BELL (DB)

(IC) INTERCOM

KEYPAD

4' FLUORESCENT LIGHT

2' UNDER COUNTER LIGHT NOTE: NOT ALL SYMBOLS ARE USED FOR THIS

ELECTRICAL LEGEND

120 V JUNCTION BOX

SINGLE RECEPTACLE OUTLET

220 V RECEPTACLE OUTLET

4-PLEX RECEPTACLE OUTLET

DUPLEX RECEPTACLE OUTLET

1/2 SWITCHED DUPLEX OUTLET


ELECTRICAL METER

ELECTRICAL PANEL

ELECTRICAL NOTES: ARC-FAULT CIRCUIT-INTERRUPTERS AND TAMPER

IN DWELLING UNITS PER N.E.C 210.12 AND 406.11 ALL ELECTRIC, ELECTRICAL EQUIPMENT AND APPLIANCES TO BE SET AT OR ABOVE BASE FLOOD ELEVATION PLUS 1'-0" FREEBOARD. ALL OUTLETS IN WET AREAS AND ALL

EXTERIOR OUTLETS TO BE GFI'S. INSTALL PHONE AND T.V PER CONTRACT. INSTALL ALL ELECTRICAL PER NEC 2014

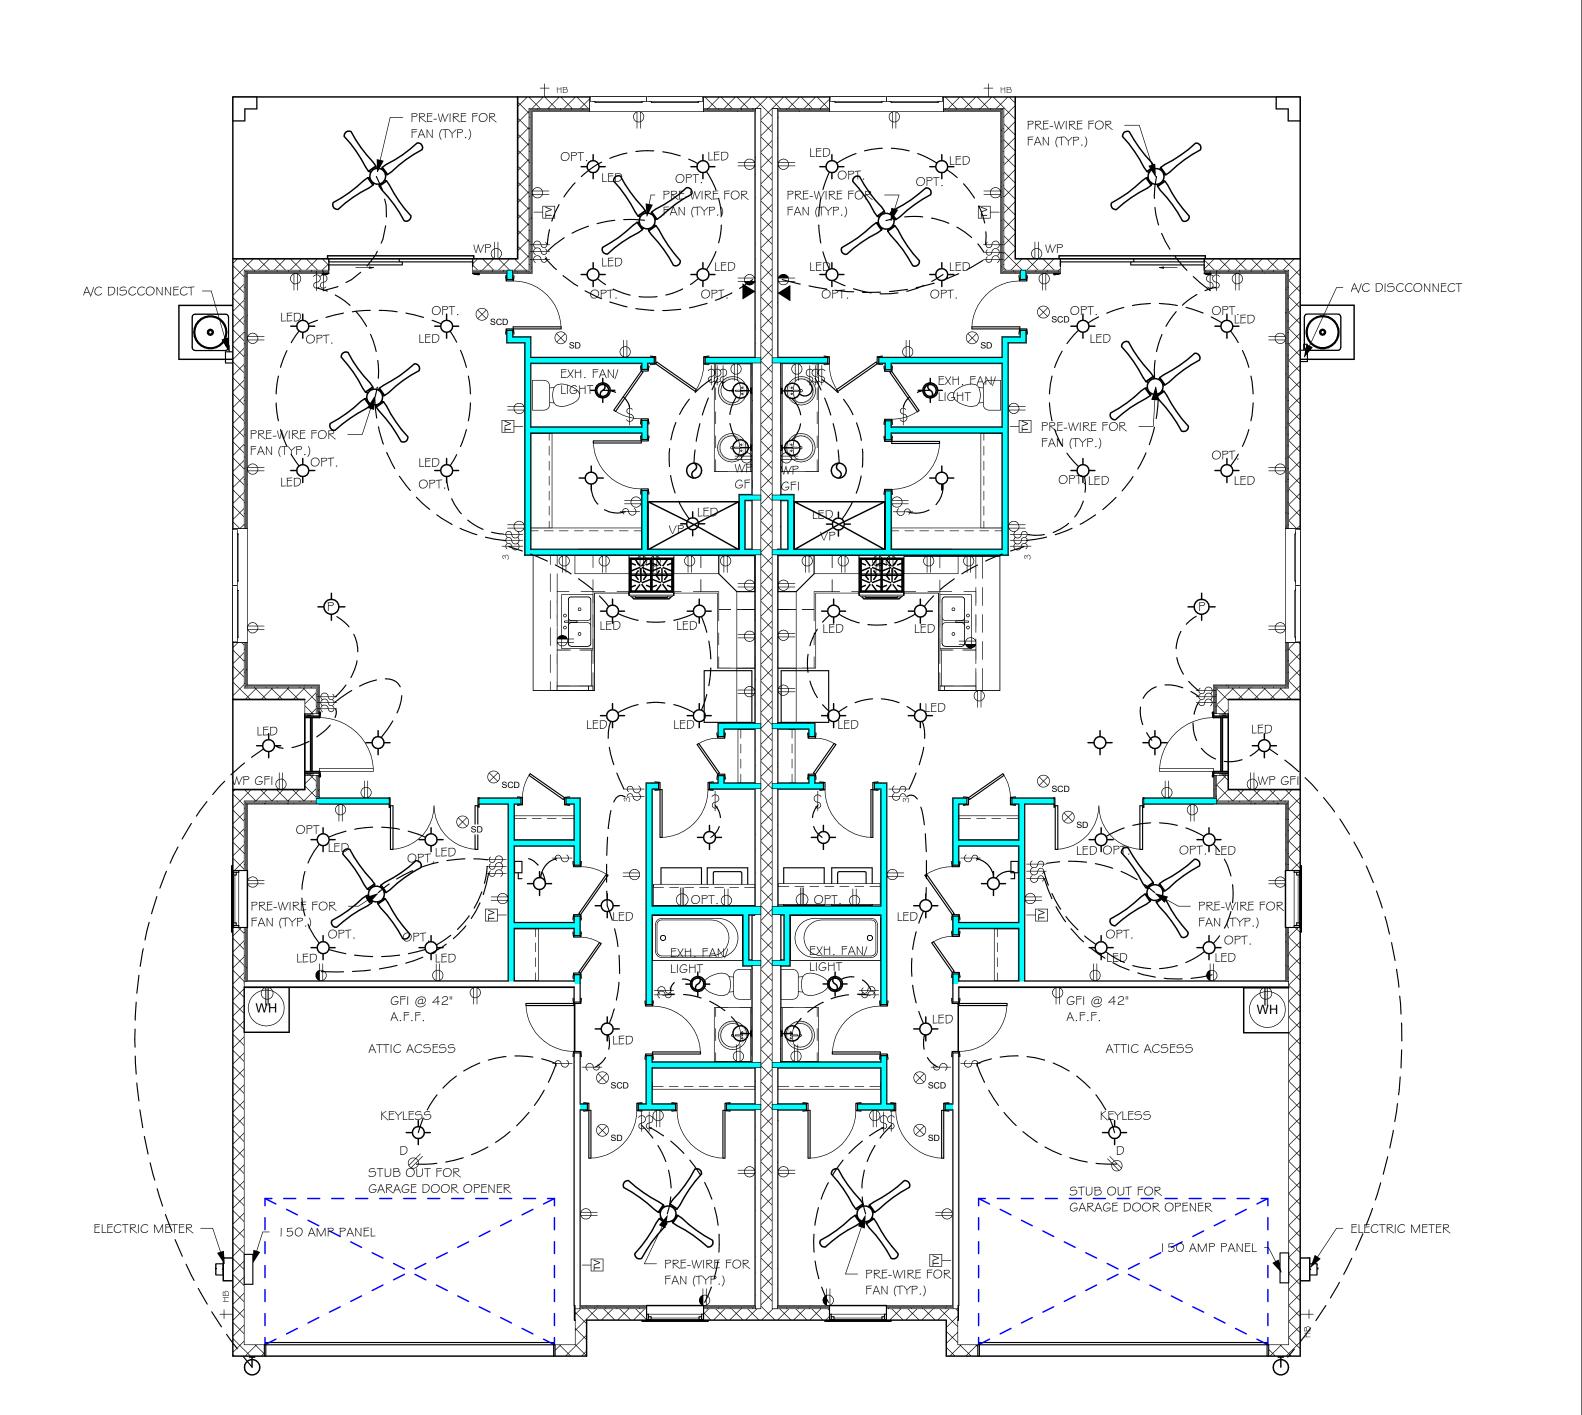

ELECTRCAL PLAN 3/16" = 1'-0"

DUPLEX RECEPTACLE AT ELEV. A.F.F. DUPLEX RECEPTACLE - ABOVE COUNTER SINGLE POLE SWITCH 3 WAY SWITCH DIMMER SWITCH MS | MOTION SENSOR SWITCH AC/DC SMOKE DETECTOR TO BE INTERCONNECTED ANY RESIDENT HAVING A FOSSIL-BURNING HEATER OR APPLIANCE, A FIREPLACE, OR AN ATTACHED GARAGE SHALL HAVE AN OPERATIONAL CARBON MONOXIDE ALARM INSTALLED WITHIN 10 FEET OF EACH ROOM USED FOR SLEEPING PERPOSES. PER RULE 9B-3.04.72 SD (SMOKE DETECTOR) SCD (CARBON MONOXIDE/ SMOKE DETECTOR) TELEPHONE OUTLET PROJECT. RESISTANT RECEPTACLES SHALL BE INSTALLED

DESIGN IN ACCORDANCE WITH THE RESIDENTIAL

GENERAL NOTES

- THE CONTRACTOR SHALL VERIFY ALL CONDITIONS AND DIMENSIONS AT THE JOB SITE PRIOR TO COMMENCING WORK. THE CONTRACTOR SHALL REPORT ALL DISCREPENCIES BETWEEN THE DRAWINGS AND EXISTING CONDITIONS TO THE DESIGNER PRIOR TO COMMENCING WORK.
- THE CONTRACTOR SHALL SUPPLY, LOCATE AND BUILD INTO THE WORK ALL INSERTS, ANCHORS, ANGLES, PLATES, OPENINGS, SLEEVES, HANGERS, SLAB DEPRESSIONS AND PITCHES AS MAY BE REQUIRED TO ATTACH AND ACCOMMODATE OTHER WORK.
- ALL DETAILS AND SECTIONS SHOWN ON THE DRAWINGS ARE INTENDED TO BE TYPICAL AND SHALL BE CONSTRUCTED TO APPLY TO ANY SIMILAR SITUATION ELSEWHERE IN THE WORK EXCEPT WHERE A DIFFERENT DETAIL IS SHOWN.
- FOR REQUIRED SOIL BEARING, SEE STRUCTURAL. THE CONTRACTOR SHALL REPORT ANY DIFFERING CONDITIONS TO THE DESIGNER PRIOR TO COMMENCING WORK.
- STRUCTURAL DRAWINGS SHALL BE USED IN CONJUCTION WITH JOB SPECIFICATION AND HOUSE PLANS, MECHANICAL, ELECTRICAL, PLUMBING, AND SITE DRAWINGS, CONSULT THESE DRAWINGS FOR SLEEVES, DEPRESSIONS AND OTHER DETAILS NOT SHOWN ON STRUCTURAL DRAWINGS.
- ALL SPECIFIED FASTENERS MAY ONLY BE SUBSTITUTED IF APPROVED BY THE ENGINEER IN WRITING, THE INSTALLATION OF THE FASTENERS SHALL BE IN ACCORDANCE WITH THE MANUFACTURER'S SPECIFICATIONS. SIMPSON FASTENERS SPECIFIED MAY BE SUBSTITUTED WITH THE SAME QUANTITY AND EQUIVALENT STRENGTH PRODUCT.
 - ALL BOLTS, NUTS, WASHERS, STRAPS AND FASTENERS INCLUDING NAILS, SHALL BE HOT MOPED DIPPED GALVANIZED OR STAINLESS STEEL CONTINUOUS ANCHORAGE SHALL BE PROVIDED BETWEEN ALL TRUSSES, WALL SECTIONS, BEAMS, POSTS AND FOOTINGS WITH USE OF STRAPS AND CONNECTORS AS SPECIFIED HEREIN.
- TREATED WOOD REQUIREMENTS: ALL TREATED WOOD EXPOSED TO WEATHER SHALL BE PROTECTED, PRESSURE TREATED, OR NATURALLY RESISTANT TO DECAY. ALL WOOD TOUCHING MASONRY OR CONCRETE SHALL BE ISOLATED, OR PRESSURE TREATED.
- THE STRUCTURE IS DESIGNED TO BE SELF SUPPORTING AND STABLE AFTER THE BUILDING IS COMPLETE. IT IS THE CONTRACTOR'S SOLE RESPONSIBILTY TO DETERMINE ERECTION PROCEDURES AND SEQUENCES TO ENSURE SAFETY OF THE BUILDING AND ITS COMPONENTS DURING ERECTION. THIS INCLUDES THE NECESSARY SHORING, SHEETING, TEMPORARY BRACING, GUYS, OR TIE DOWNS.
- CEILING DRYWALL INSTALLED WITHIN THE HOUSE TO TRUSSES SPACED 24" O.C. SHALL BE 5/8" DRYWALL OR 1/2" SAG RESISTANT PER SEC. 702.3.5
- 10. LANAI CEILINGS & COVERED ENTRY CEILINGS IX4 STRIPPING @ 16" O.C. FASTENED WITH 2-8d NAILS TO EACH TRUSS. 5/8" EXTERIOR GYP. BOARD CEILING FASTENED WITH 8d NAILS OR 1-5/8" DRYWALL SCREWS @ 6" O.C. EDGE AND FIELD.

DOOR AND WINDOW ANCHORAGE

ANCHORAGE REQUIRMENTS- ALL PASS AND SLIDING GLASS DOORS AND ALL WINDOW ASSEMBLIES SHALL BE ANCHORED TO THE MAIN WIND FORCE RESISTING SYSTEM IN A MANNER SPECIFIED BY THE PUBLISHED MANUFACTURERS LITERATURE. THERE SHALL BE NO SUBSTITUTION OF ALTERNATE FASTENINGS UNLESS PROVIDED BY THE MANUFACTURER AND APPROVED BY THE BUILDING DESIGN ENGINEER.

MASONRY OPENING

WHERE WINDOW FRAME IS DESIGN TO FASTEN WITH SCREWS THROUGH THE FRAME AND INTO THE MSANORY, THE BUCK MATERIAL IS SIMPLY A SPACER. THE BUCK MAY BE FASTENED WITH THE T NAILS OR ANY SUITABLE FASTENER TO TACK IT INTO POSITION PRIOR TO WINDOW INSTALLATION, FASTEN WINDOW FRAME PER MFR INSTRUCTIONS. A WINDOW FASTENER SHALL PENETRATE MASONRY BY 2 1/4" MIN.

WHERE WINDOW FRAME IS DESIGNED TO FASTEN ONLY TO THE WOOD BUCK (IE, FLANGED FRAME WITH WOOD SCREWS) THE BUCKS SHALL BE 2X WOOD WITH STRUCTURAL FASTENING TO THE MASNORY WITH 1/4 X 3 3/4 MASONRY SCREWS @ 24" OC AND 6" FROM EACH END.

WOOD FRAMED OPENING- ALL DOORS AND WINDOWS SHALL BE INSTALLED ACCORDING TO THE PUBLISHED MANUFACTURERS LITERATURE OF THE ASSEMBLY BEING INSTALLED TO THE ROUGH SUBSTRATE OPENING. SHIMS SHALL BE MADE OF MATERIALS CAPABLE OF RESISTING THE APPLIED LOADS AND SHALL BE LOCATED NEAR EACH FRAME FASTENER TO MINIMIZE DISTORTION OF THE FRAME AS THE FASTENERS ARE TIGHTENED .

GENERAL ROOF ASSEMBLY

ROOF SHEATHING FBCR TABLE R803.2.2 SHALL BE 19/32 APA RATED SHEATHING, EXPOSURE 1, SPAN RATING 40/20 OR

INSTALL PANELS WITH LONG DIMENSION PLACED PERPENDICULAR TO TRUSSES. A 1/8" SPACE BETWEEN ADJACENT SHEETS SHALL BE MAINTAINED . INSTALL "H" CLIPS AT UNSUPPORTED PANEL EDGES. FOR FASTENING, SEE STRUCTURAL.

FLASHING SHALL BE ALUMINUM, ALUMINUM ZINC COATED STEEL 0.0179" THICK, 26 GAUGE AZ50 ALUM ZINC, OR GALVANIZED STEEL 0.0179" THICK, 26 GAUGE ZINC COATED G90. FLASHING SHALL BE INSTALLED IN ACCORDANCE WITH THE ZIP SYSTEM ROOF SHEATHING MANUFACTURES PUBLISHED REQUIREMENTS. ALL FLASHING AND INSTALLATION SHALL CONFORM TO SECTION R905.2.8 (1 TO 5).

DRIP EDGE SHALL BE PROVIDED AT ALL EAVES AND GABLES OF SHINGLES ROOFS. LAPPED A MINIMUM OF 3" @ JOINTS. THE OUTSIDE EDGE SHALL EXTEND A

OF 1/2" BELOW SHEATHING AND THE INSIDE EDGE SHALL EXTEND BACK A MINMUM OF 2". DRIP EDGE SHALL BE FASTENED AT NO MORE THAN 4" CENTERS. THERE

BE A MINIMUM OF 4" WIDTH OF ROOF CEMENT INSTALLED OVER THE DRIP EDGE FLANGE.

ASPHALT SHINGLE ROOF SPEC'S

30# FELT SHALL BE INSTALLED UNDER ASPHALT SHINGLES. ALL ASPHALT SHINGLES SHALL HAVE SELF-SEALING STRIPS OR BE INTERLOCKING AND COMPLY WITH ASTM D 225 OR D 3462. FOR FASTENING, SEE STRUCTURAL. INSTALLATION SHALL COMPLY WITH MANUFACTURES REQUIREMENTS FOR INSTALLATION IN THE GIVEN FLORIDA WIND ZONE, AS DETERMINED BY ASTM D 3161.

CLAY AND CONCRETE ROOF TILE SPECS

INSTALL PEEL AND STICK UNDERLAYMENT APPROVED FOR SINGLE

LAYER APPLICATION UNDER TILE ROOF. THE INSTALLATION OF CLAY AND CONCRETE TILE SHALL COMPLY

- WITH THE PROVISIONS OF R905.3 F.B.C.
- MARKING: EACH ROOF TILE SHALL HAVE A PERMANENT MANUFACTURER'S IDENTIFICATION MARK. APPLICATION SPECIFICATIONS: THE TILE MANUFACTURER'S WRITTEN


APPLICATION SPECIFICATIONS SHALL BE AVAILABLE AND SHALL

- INCLUDED BUT NOT BE LIMITED TO THE FOLLLOWING: I. TILE PLACEMENT AND SPACING,
- 2. ATTACHMENT SYSTEM NECESSARY TO COMPLY
- WITH CURRENT WIND CODE,
- A. AMOUNT AND PLACEMENT OF MORTAR B. AMOUNT AND PLACEMENT OF ADHESIVE
- C. TYPE, NUMBER, SIZE AND LENGTH OF FASTENERS AND CLIPS.

3. UNDERLAYMENT 4. SLOPE REQUIREMENT.

FLOOR SHEATHNG AT 2ND FLOOR

A.P.A. RATED STURDI-FLOOR, EXPOSURE I, TONGUE & GROOVE EDGES SPAN RATING 48/24 OR BETTER, SEE STRUCTURAL.

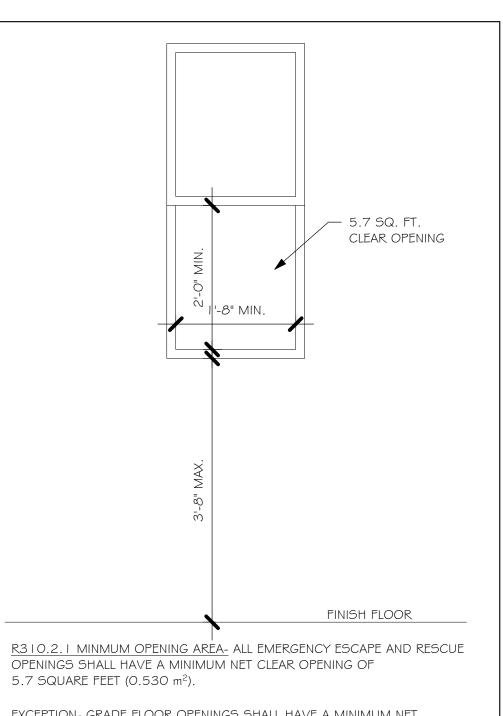

EXCEPTION- GRADE FLOOR OPENINGS SHALL HAVE A MINIMUM NET CLEAR OPENING OF 5 SQUARE FEET (0.465 m²).

R3 I O.2. I MINMUM OPENING HEIGHT- THE MINIMUM NET CLEAR OPENING HEIGHT SHALL BE 24 INCHES (610mm).


WIDTH SHALL BE 20 INCHES (508mm).

R310.1.1 OPERATIONAL CONSTRAINTS- EMERGENCY ESCAPE AND RESCUE OPENINGS SHALL BE OPERATIONAL FROM THE INSIDE OF THE ROOM WITHOUT THE USE OF KEYS OR TOOLS.

R3 | O.2. | MINMUM OPENING WIDTH- THE MINIMUM NET CLEAR OPENING


R3 I O.2.3 WINDOW WELLS- THE MINIMUM HORIZONTAL AREA OF THE WINDOW WELL SHALL BE 9 SQUARE FEET (0.84 m²), WITH A MINIMUM HORIZONTAL PROJECTION AND WIDTH OF 36 INCHES (914mm). THE AREA OF THE WINDOW WELL SHALL ALLOW THE EMERGENCY ESCAPE AND RESCUE OPENING TO BE FULLY OPENED.

MINIMUM EGRESS WINDOW DETAIL

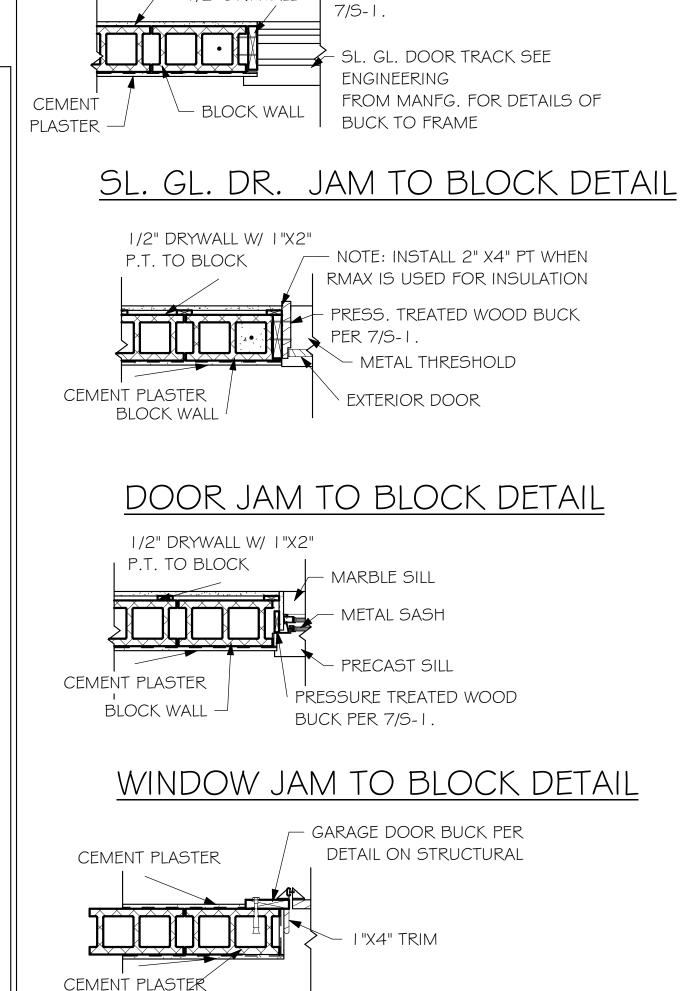

PRESSURE TREATED


WOOD BUCK PER

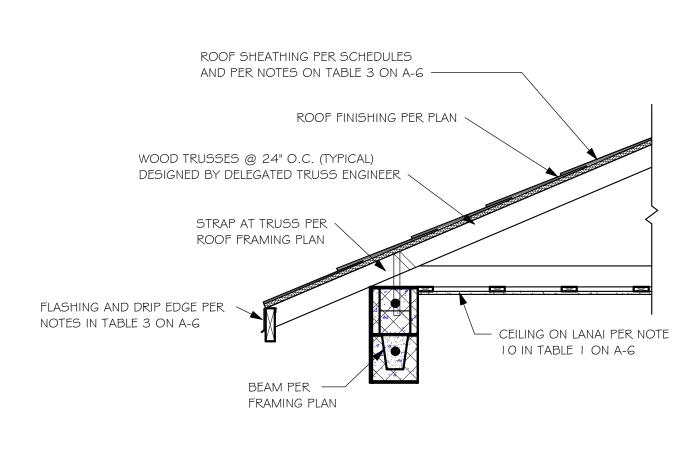

LANAI/ ENTRY ROOF ASSEMBLY 3/4" = 1'-0"

ROOF SHEATHING PER SCHEDULE 2/S-1. ——

AND PER NOTES IN TABLE 3 ON A-6

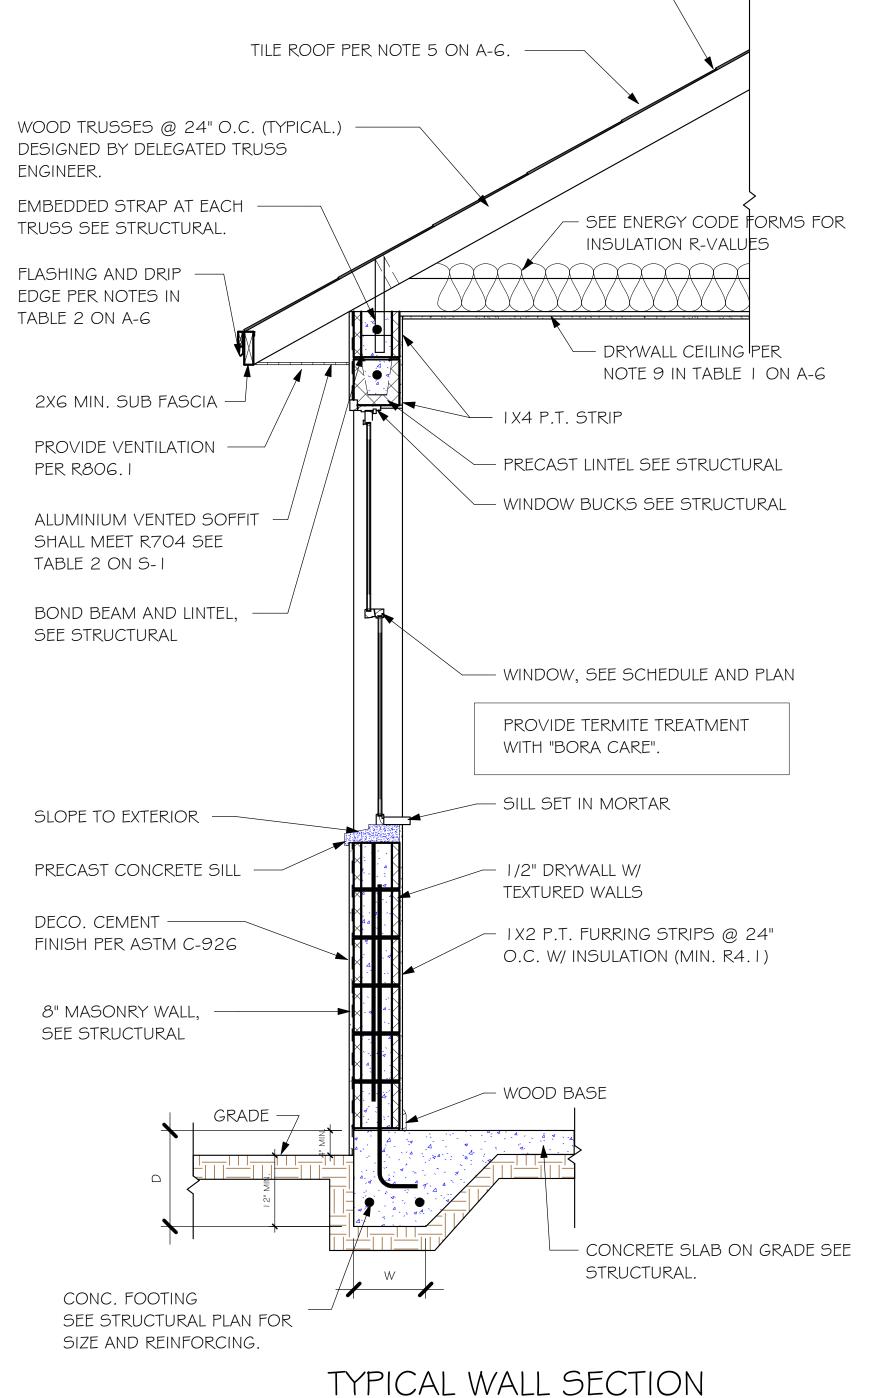



 \Box ODEL

DATE: 02/17/21 DRAWN BY: JSL CHECKED BY:

JWC **REVISED:**

SECTIONS


SCALE: As indicated

A-6

DESIGN IN ACCORDANCE WITH THE RESIDENTIAL FLORIDA BUILDING CODE 2020 - 7TH EDITION

GARAGE DOOR JAM DETAIL

BLOCK WALL

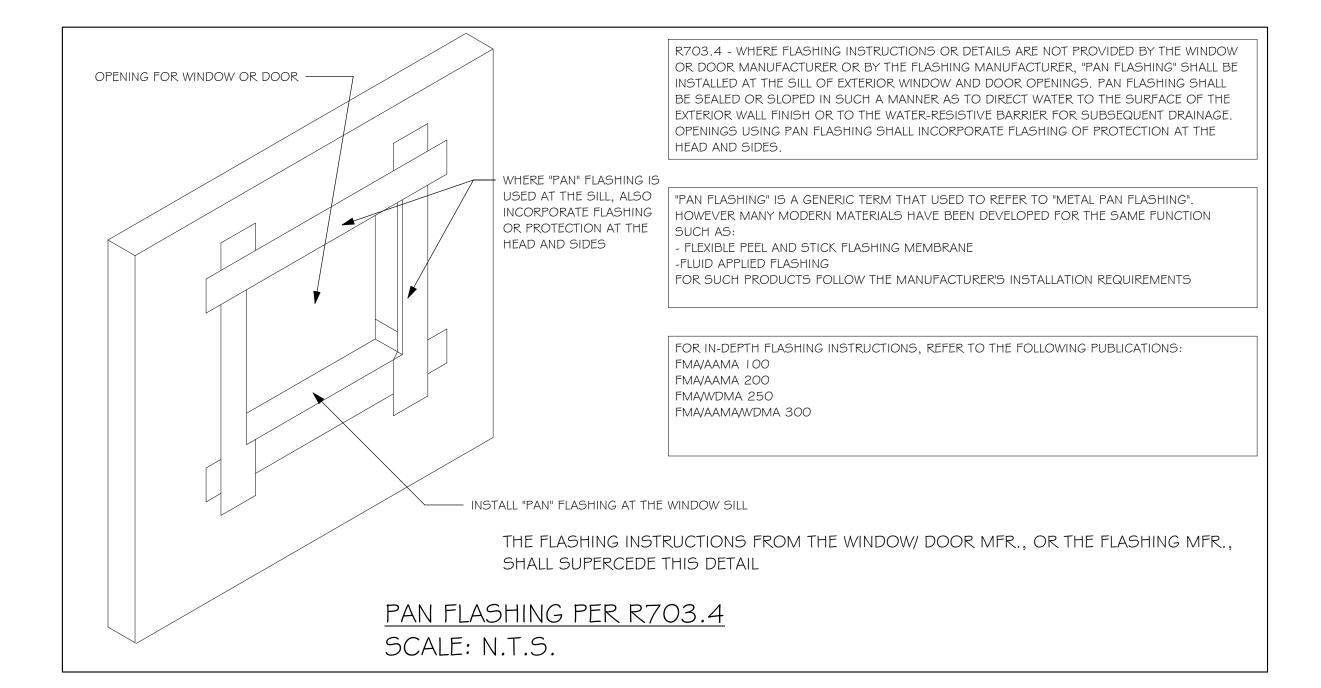



Drafting & Design, Inc.

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PHONE: 239-540-1822

1515 SE 47TH ST. CAPE CORAL, FL 33904

HEAD MADDEL 1503

SUBDIVISION: ENBROOK

SUBDIVISION: ENBROOK

ADDRS: 1096-1092 TRANQUIL BROOK DR

ADDRS: 1096-1092 TRANQUIL BROOK DR

D.R.H. #: 579640149-150

REVISED:


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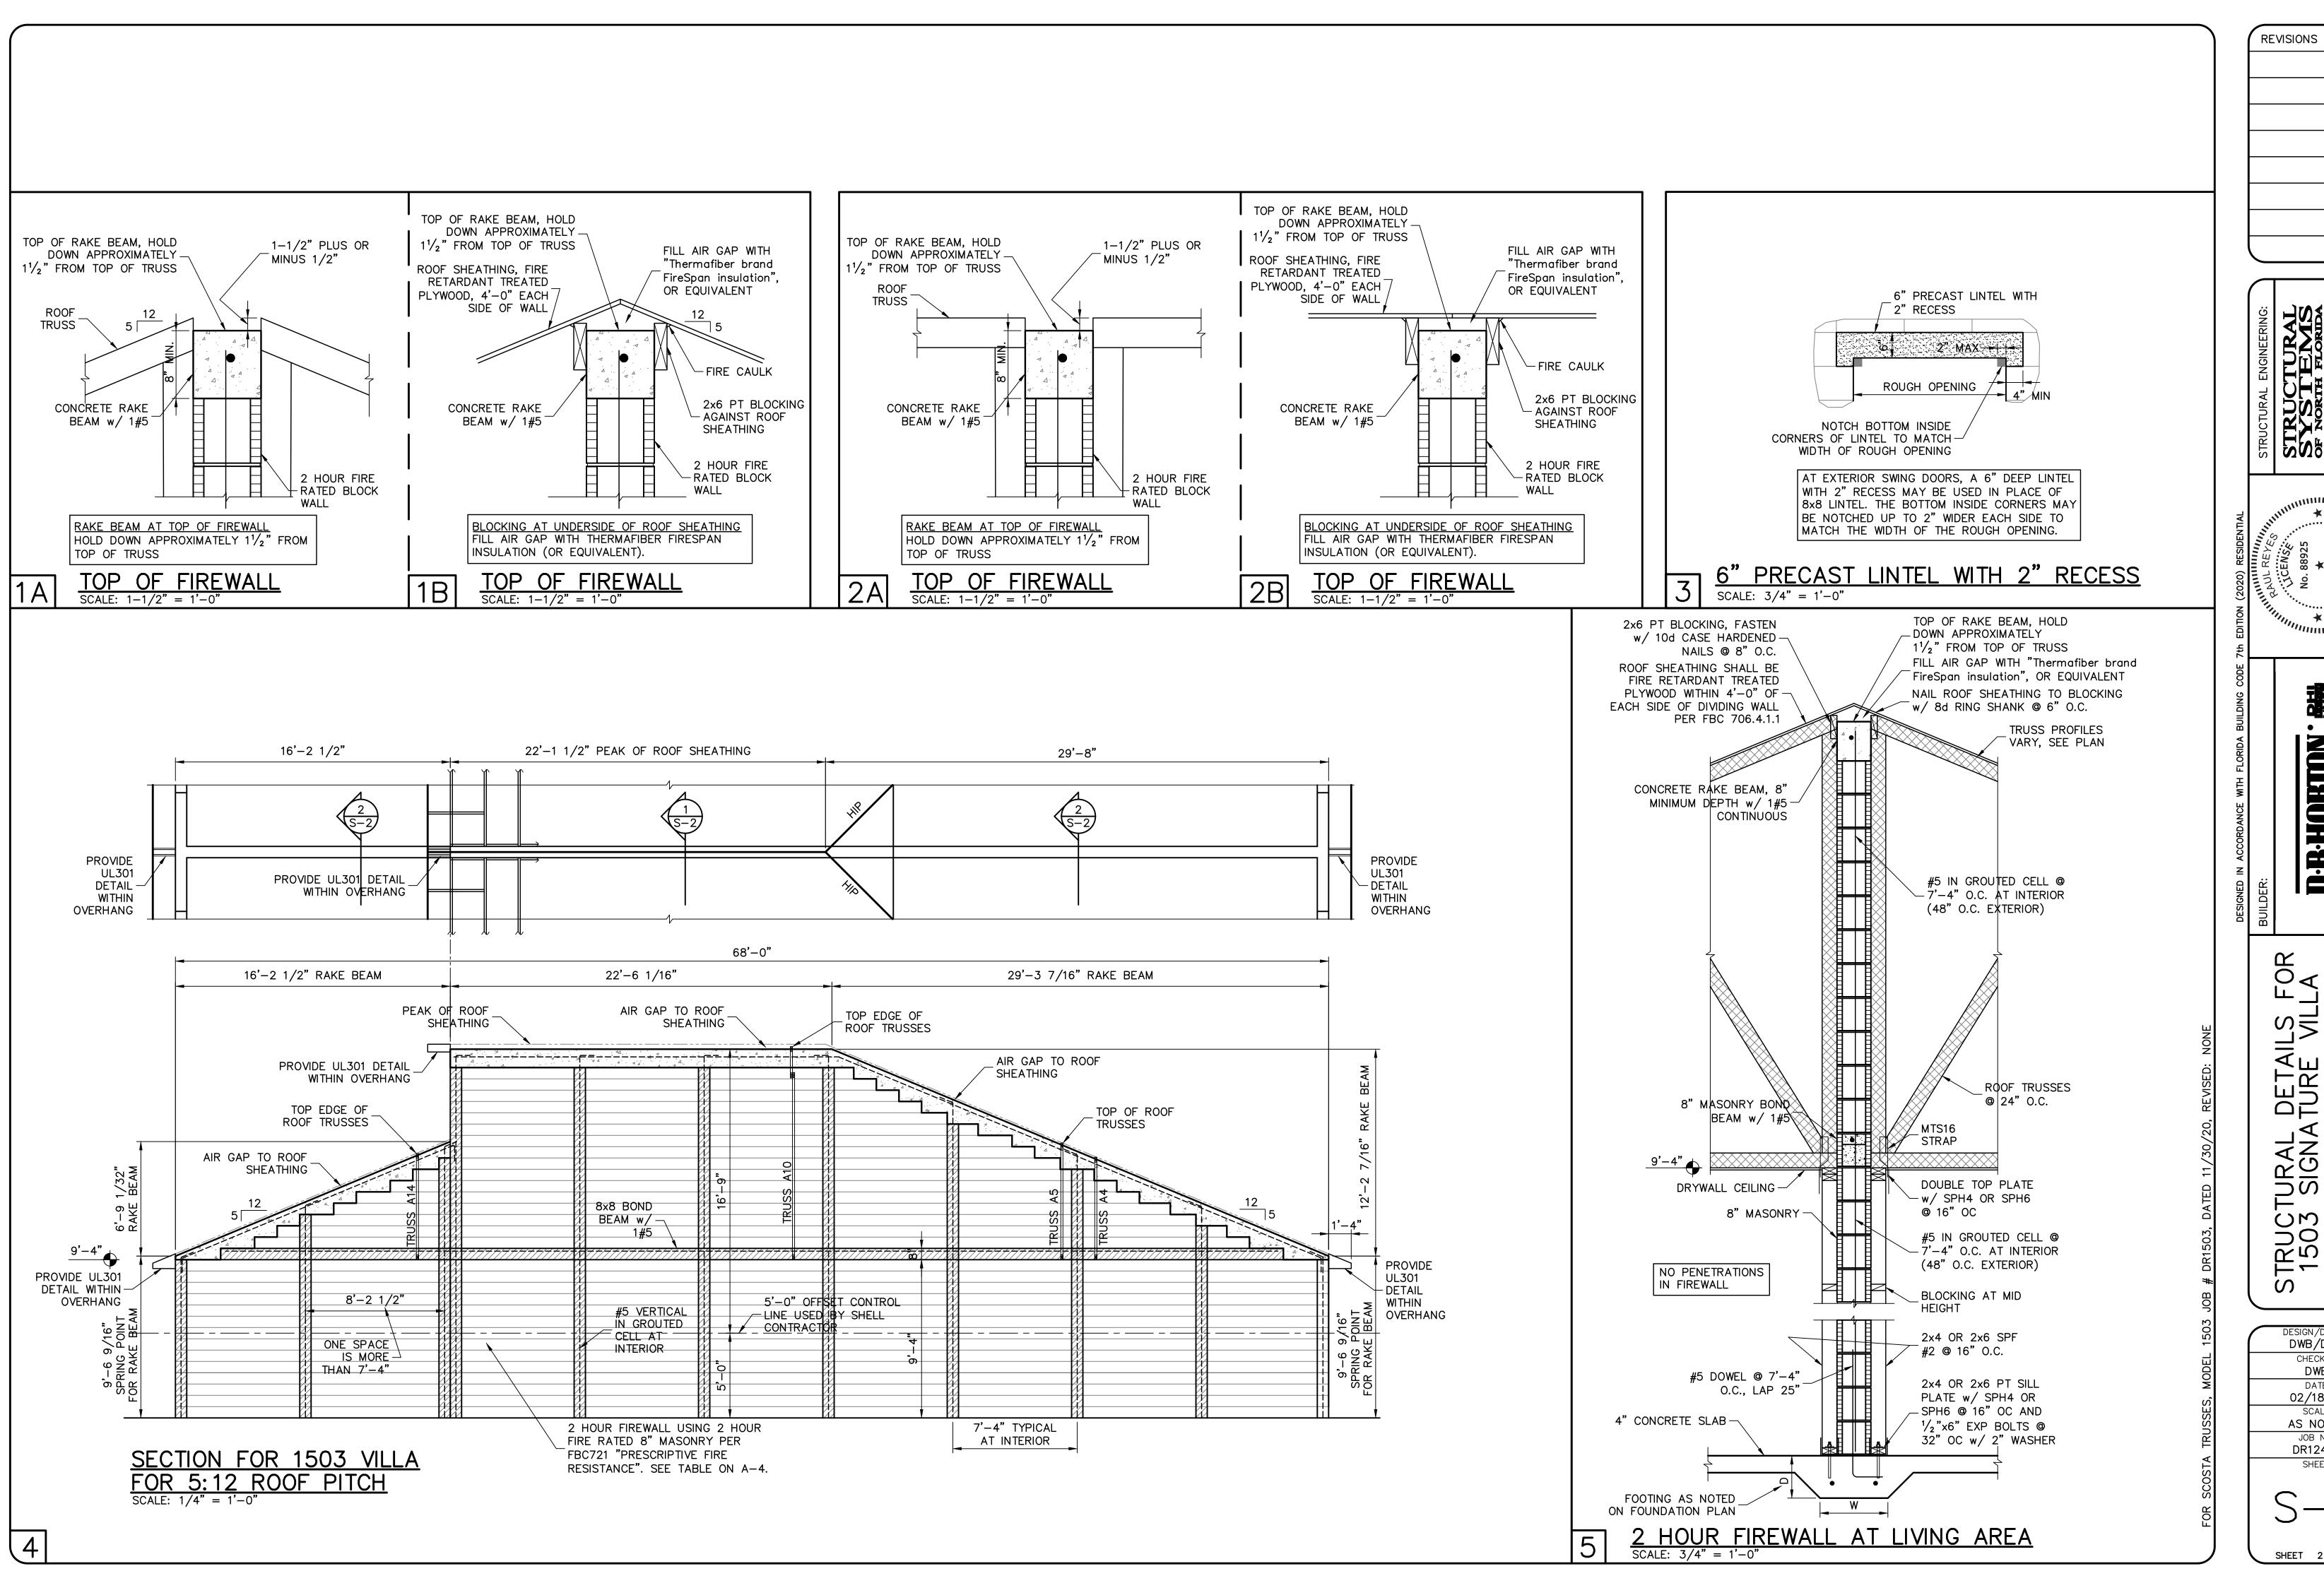
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INTERIOR WALL
____SECTIONS_

As indicated

DESIGN IN ACCORDANCE WITH THE RESIDENTIAL FLORIDA BUILDING CODE 2020 - 7TH EDITION



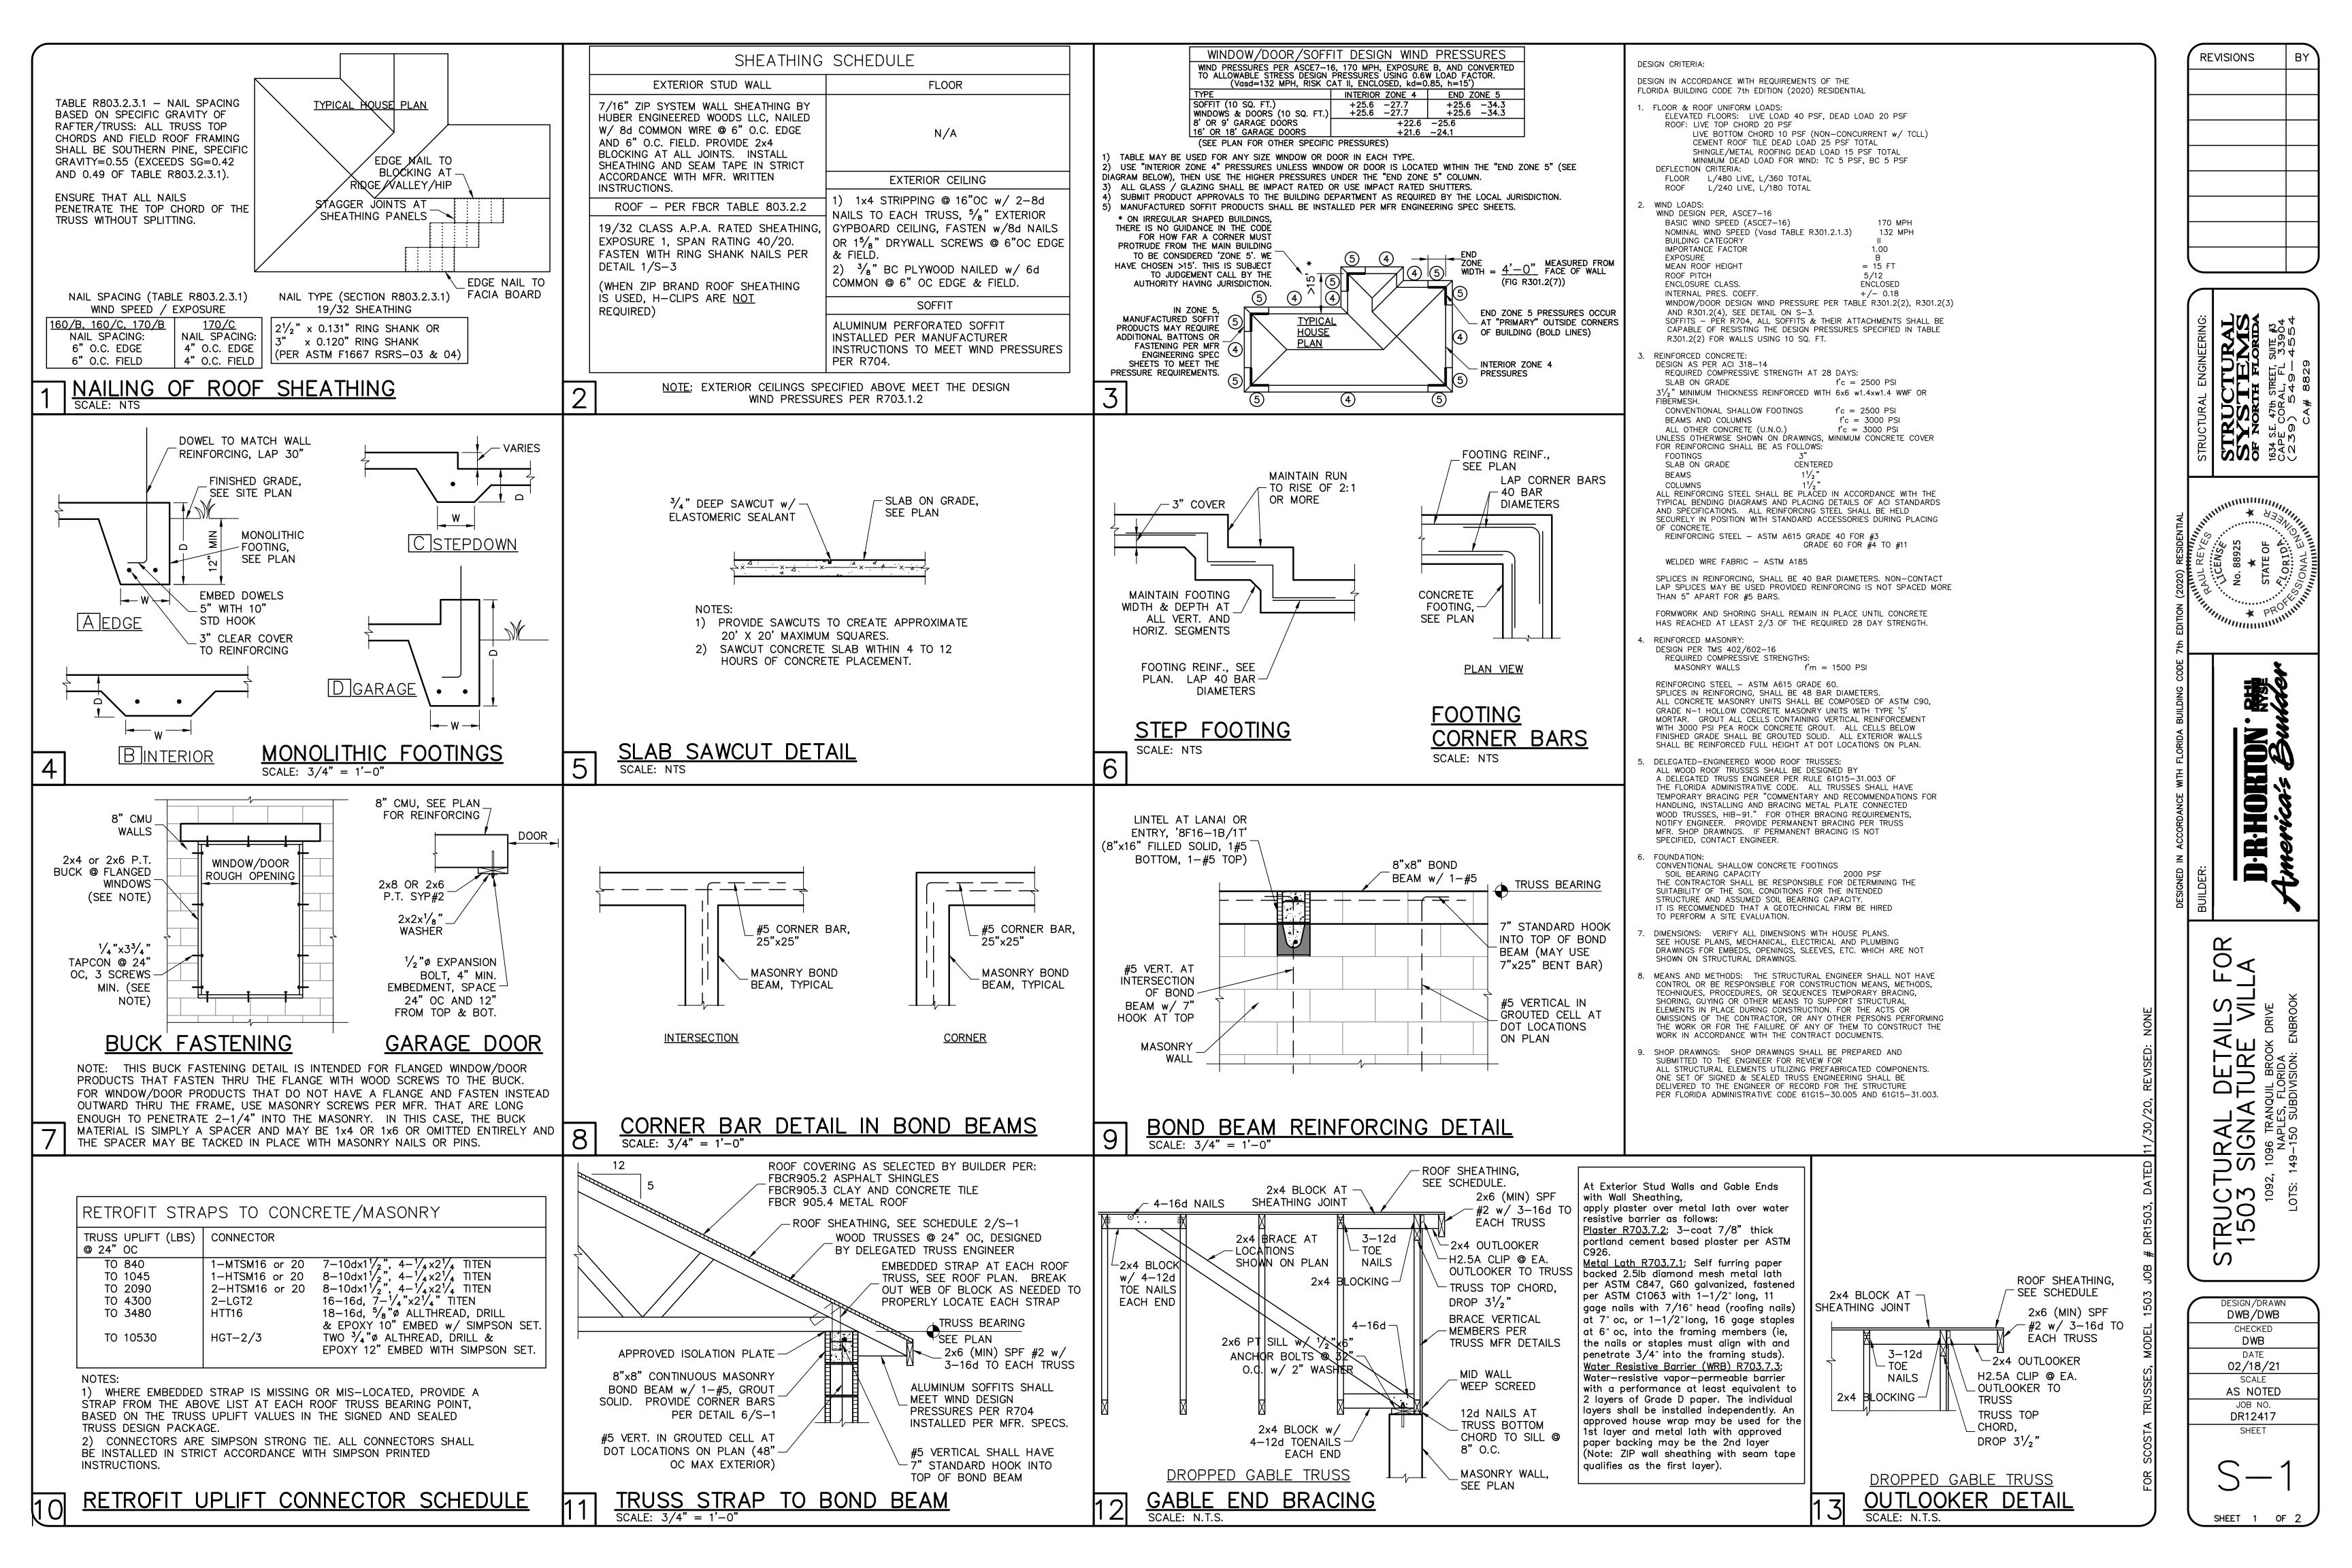

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STRUCTURAL SYSTEMS OF NORTH FLORIDA 1634 S.E. 47th STRET, SUITE #3 CAPE CORAL, FL 33904 (239) 549-4554

OKTON 1 D-R-H

DWB/DWB 02/18/21 AS NOTED