

SLAB & PLUMBING PLAN: SCALE: 3/16"=1'-0"

D-R-HORTON : Water | America's Builde


Gulf Coast Drafting
& Design
Phone (239) 540-1822
Fax (239) 540-7759

MODEL:	UNIT 2451	RESIDENCE FOR:	SPEC
LOT: 103 BLOCK:	SUBDIV: BARRINGTON COVE	ADDRESS: 16281 ABERDEEN WAY	G.C.D.#: 9260 D.R.H.#: 578140103
DATE:		2-29-1	.6

CHECKED BY:



Gulf Coast Drafting & Design Design (239) 540-1822 (39) 540-7759

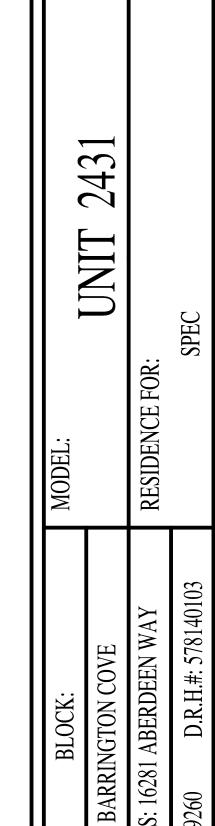

02-29-16

CWL

DRAWN BY:

CHECKED BY:

REVISED:


PLAN:

SCALE:

FLOOR


3/16"=1'-0"

A-3M

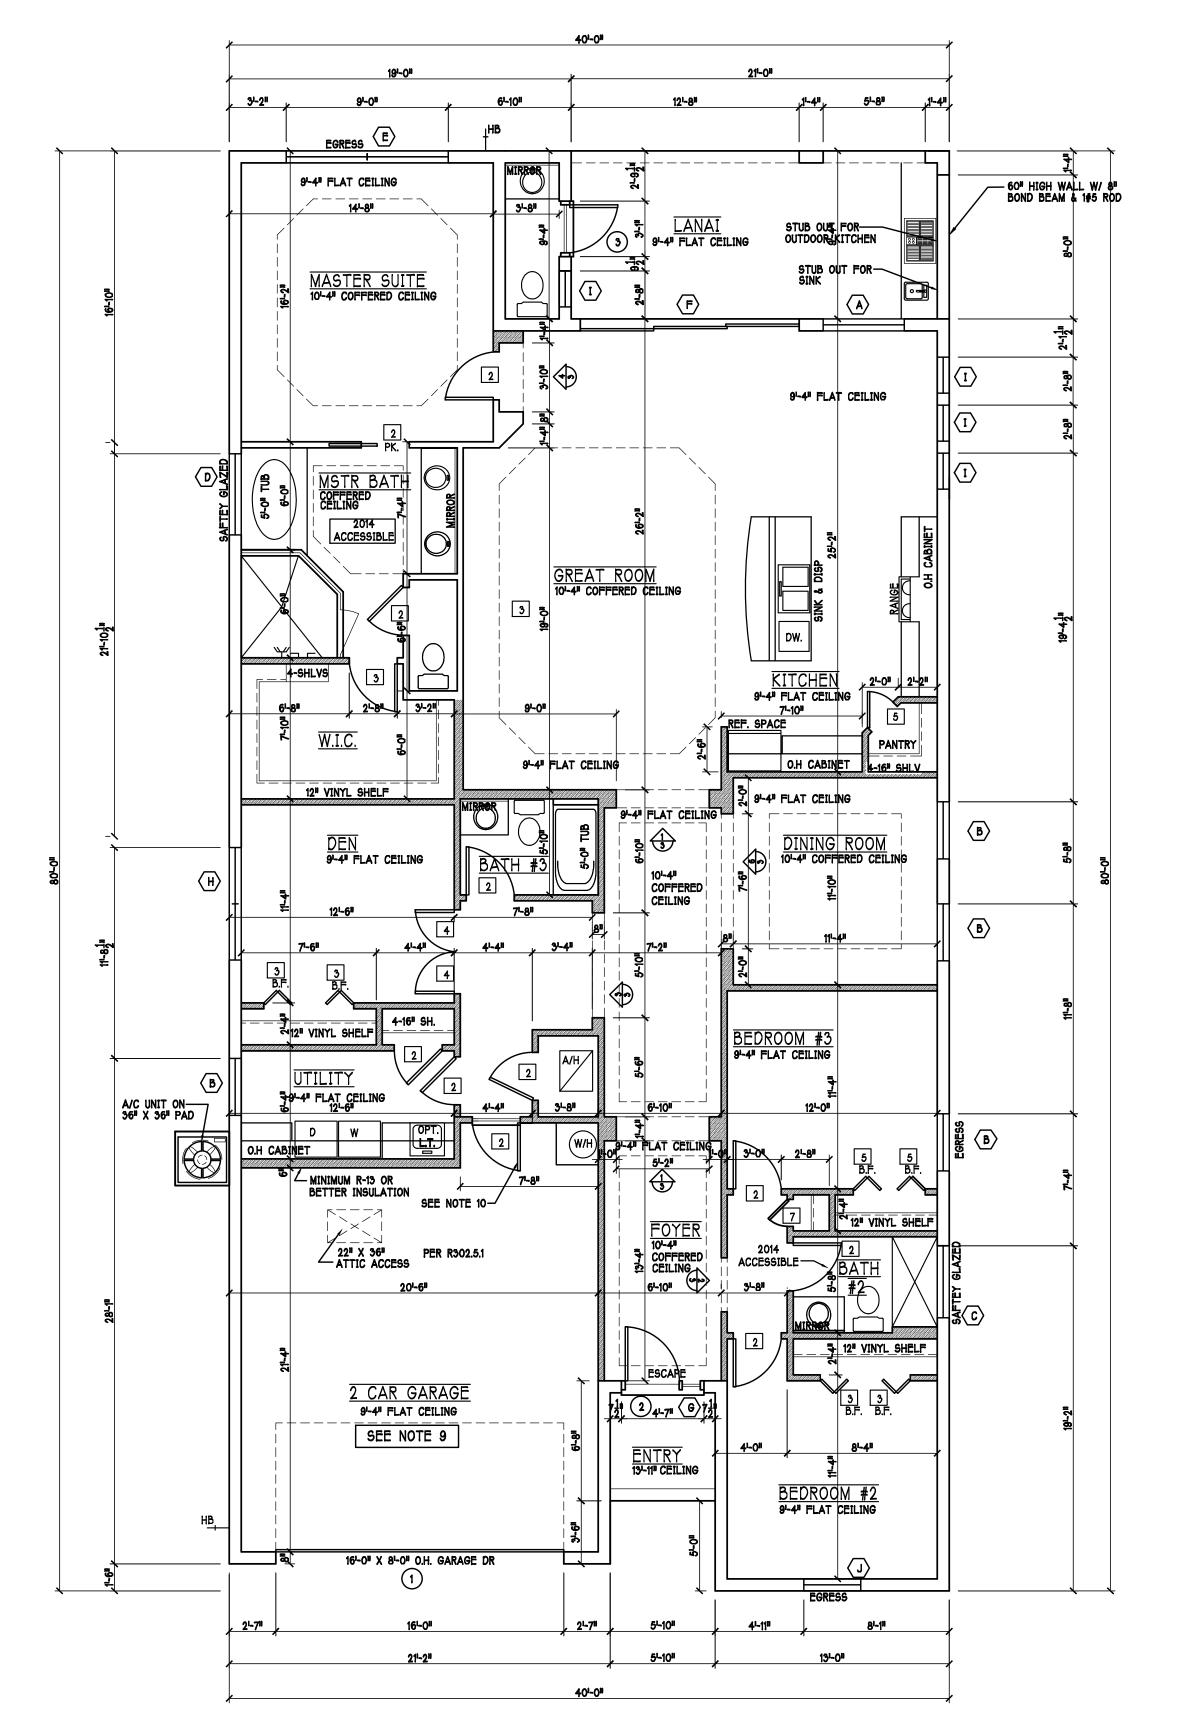


1st FLOOR PLAN:


SCALE: 3/16" = 1'-0"

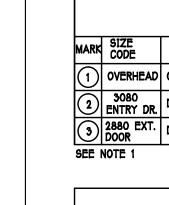





FOYER CEILING

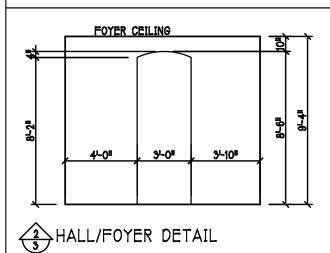


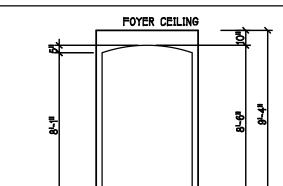



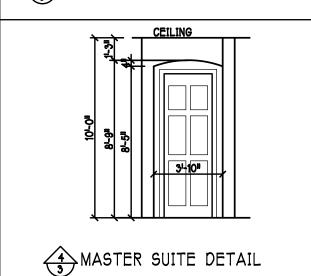


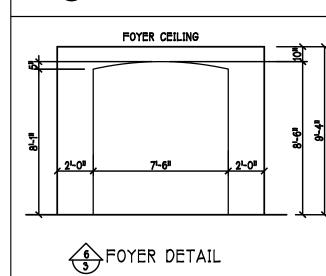

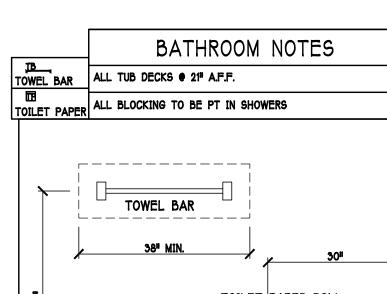


D R HORTON									
MARK	SIZE CODE	PRODUCT DESCRIPTION	DOC WIDTH	OR HEIGHT	COMMENTS	QTY			
1	OVERHEAD	GARAGE DOOR	192	96		1			
2	3080 Entry Dr.	DISTINCTION	36	96		1			
3	2880 EXT. DOOR	DISTINCTION	30	96		1			
SEE NOTE 1									

MARK	SIZE CODE	PRODUCT DESCRIPTION		OOR H HEIGHT	COMMENTS	QTY
$\langle \rangle$	35 SH		54	63		1
B	25 SH		38	63		3
(c)	48" X 12" F.G.	FIXED GLASS	48	12	TEMPERED	1
(e)	34 SH		54	51		1
(E)	2-35 SH		108	63		1
(F)	3-4080 SL. GL. DR.	SL. GL. DOOR	108	96		1
(G)	12" X 96" SIDE LITE		12	96		1
E	2-25 SH		76	63		1
$\overline{(1)}$	2'-0" X 2'-0"	FIXED GLASS	24	24		3
(C)	26 SH		38	78		1
SEE	NOTE 1					15

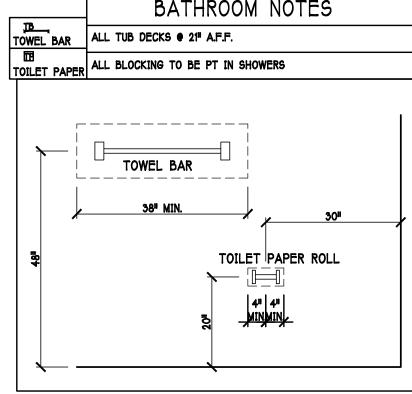

ITERIOR (OOR SCHEDULE
DOOR WIDTH	NOTES
31-011	PK. = POCKET DOOR
21-811	B.F. = BI-FOLD DOOR
21-611	B.P. = BI-PASS DOOR
21-411	LV. = LOUVERED DOOR
21-011	
11-811	
11-611	
	DOOR WIDTH 3'-0" 2'-8" 2'-6" 2'-4" 2'-0"

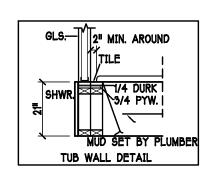

SQUA	RE FOOTAGE	
LIVING AREA	***************************************	243
GARAGE AREA	***************************************	47€
LANAI AREA		196
ENTRY AREA		35
TOTAL AREA		3138

BASE TOP @35"

DOOR HEADERS

HEADER HEIGHT

PLAN NOTES

VERILY ALL ROUDH OPENING DIMENSIONS FOR ALL WINDOWS AND DOORS

2) PROVIDE SAFETY GLAZING WITHIN 24" FROM EXIT PER FLORIDA BUILDING CODE R 308.3.1.

3) PROVIDE SAFETY GLAZING AT BATH / SHOWER.

4) NON BEARING INTERIOR FRAME WALLS SHALL BE

5) PROVIDE DEAD WOOD IN ATTIC FOR OVERHEAD GARAGE DOOR HARDWARE

6) KITCHEN KNEE WALL TO BE FRAMED W/ TOP • 41 1/2" A.F.F. W/ RAISED BAR TOP

7) INSTALL SMOOTH WALLS IN KITCHEN AND ALL

8) WHERE DRYWALL CEILING IS APPLIED TO TRUSSES AT 24" O.C. USE 5/8" DRYWALL OR 1/2" SAG

RESIDENCE & ATTIC BY NOT LESS THEN 1/2" GYPSUM

BOARD APPLIED TO THE GARAGE SIDE. GARAGES BENEATH HABITABLE ROOMS SHALL BE SEPARATED WITH NOT LESS THAN 5/8" TYPE "X" GYPSUM BOARD OR EQUIVALENT. WHERE THE SEPARATION IS A

PROTECTED BY NOT LESS THAN 1/2" GYPSUM BOARD

R302.5.1, DOOR SHALL BE SELF CLOSING PER R302.5.1

9) THE GARAGE SHALL BE SEPARATED FROM THE

FLOOR - CEILING ASSEMBLY THE STRUCTURE SUPPORTING THE SEPARATION SHALL ALSO BE

10) INSTALL 1 3/8" THICK SOLID WOOD DOOR BETWEEN LIVING AND GARAGE PER FLORIDA BUILDING CODE

11) ALL WINDOWS INSTALL 72" ABOVE GRADE MUST COMPLY WITH R 612.2 MIN 24" SILL HEIGHT OR PROVIDED WITH AN APPROVED WINDOW FALL PREVENTION DEVICE

12) STUB OUT FOR GAS @ OUTDOOR KITCHEN, RANGE,

WATER HEATER, AND DRYER. VERIFY WITH CONTRACTOR AND SUBDIV. SPECS. A SEPARATE PERMIT IS REQUIRED FOR GAS PIPING.

13) ALL CLOSET SHELVES TO BE 12". ALL PANTRY & LINEN TO BE (4)-16" SHELVES 18" O.F.F. WITH 15" INCREMENT.

CABINET BACKING

UPPER TOP ● 84"

KITCHEN

MASTER BATH UPPER

GUEST BATH UPPER

LAUNDRY RM. UPPER TOP @84"

BATHROOM AREAS

RESISTANT PER SEC. 702.3.5

FRAMED W/ WOOD OR METAL STUDS. SPACING SHALL NOT EXCEED 24" O.C. (NON BEARING WALLS ONLY)

PER FLORIDA BUILDING CODE R 308.3.1.


82" A.F.F.

82 1/2" A.F.F.

98 1/2" A.F.F.

6'-8" BIFOLD HEADER HEIGHT

8'-0" SWING HEADER HEIGHT

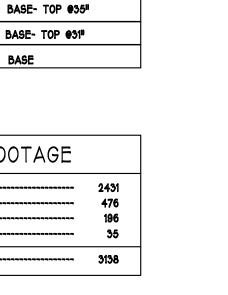


SOFFIT VENTS AROUND FULL PERIMETER NO FIRE RATED SOFFITS

	ATTIC VENTILATION								
verify vent	ting requirements y calculations	WITHOUT OFF	RIDGE VENTS	WITH OFF RIC	OGE VENTS (O.R.V.)				
	C AREA R806)	VENTILATION REQUIRED (ATTIC AREA 1/150)		VENTILATION REQUIRED (ATTIC AREA 1/300 INSTALL PER FBC R806.2 MINIMUM AREA REQUIREMENTS)					
mark	square footage	soffit vents	MIN AIR FLOW OF SOFFIT	total ventilation off	ridge vents MIN AIR FLOW OF SOFFIT				
1 3138 SQ. FT.		20.9 SQ. FT. 6.0%		O.R.V. NOT USED					
		ATTIC VENTILATION CALCULATION: attic eq. ft. / 150 = vented eq. ft.		ATTIC VENTILATION CALCULATION: attic eq. ft. / 300 = vented eq. ft					
;	P-0" B/	ASE	25" BASE	18" BASE					
	1.45 SQ. FREE A			1 SQ. FT. FREE AREA	.38 SQ. FT. Free Area				
OFF RIDGE EXHAUST VENT SIZES (AREA NET FREE SQUARE FEET) SCALE: 1/4#=1'-0"									

SOFFIT VENTS ALONG FRONT & REAR ONLY WITH FIRE RATED SOFFITS, BOTH SIDES OF HOUSE.


			-					
ATTIC VENTILATION								
verify venti with energy	ng requirements calculations	WITHOUT OFF	RIDGE VENTS	WITH OFF RIDGE VENTS				
ATTIC (FBC I	AREA R806)	VENTILATION REQUIRED (ATTIC AREA 1/150)		VENTILATION REQUIRED (ATTIC AREA 1/300 INSTALL PER FBC R806.2 MINIMUM AREA REQUIREMENTS)				
mark	square footage	soffit vents	MIN AIR FLOW OF SOFFIT	total ventilation	off ridge vents			
1)	3138 SQ. FT.	DOES NOT		10.5 SQ. FT.	5.2 SQ. FT.	3.3%		
ATTIC VENTILATION CALCULATION: attic eq. ft. / 150 = vented eq. ft.			ATTIC VENTILATION CALCULATION: attic eq. ft. / 300 = vented eq. ft					
7	6'-0" BA	ASE	25" PASE	25" BASE	BASE 	BASE		
	1.45 SQ. Free Ai	FT. REA		1 SQ. FT. FREE AREA	.38 Fre	SQ. FT. E AREA		
OFF RIDGE EXHAUST VENT SIZES [AREA NET FREE SQUARE FEET] SCALE: 1/4"=1"-0"								

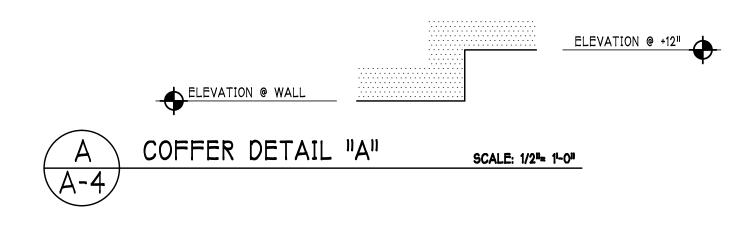

BEARING HEIGHTS

= BEARING @ 9'-4" A.F.F.

= BEARING @ 13'-11"

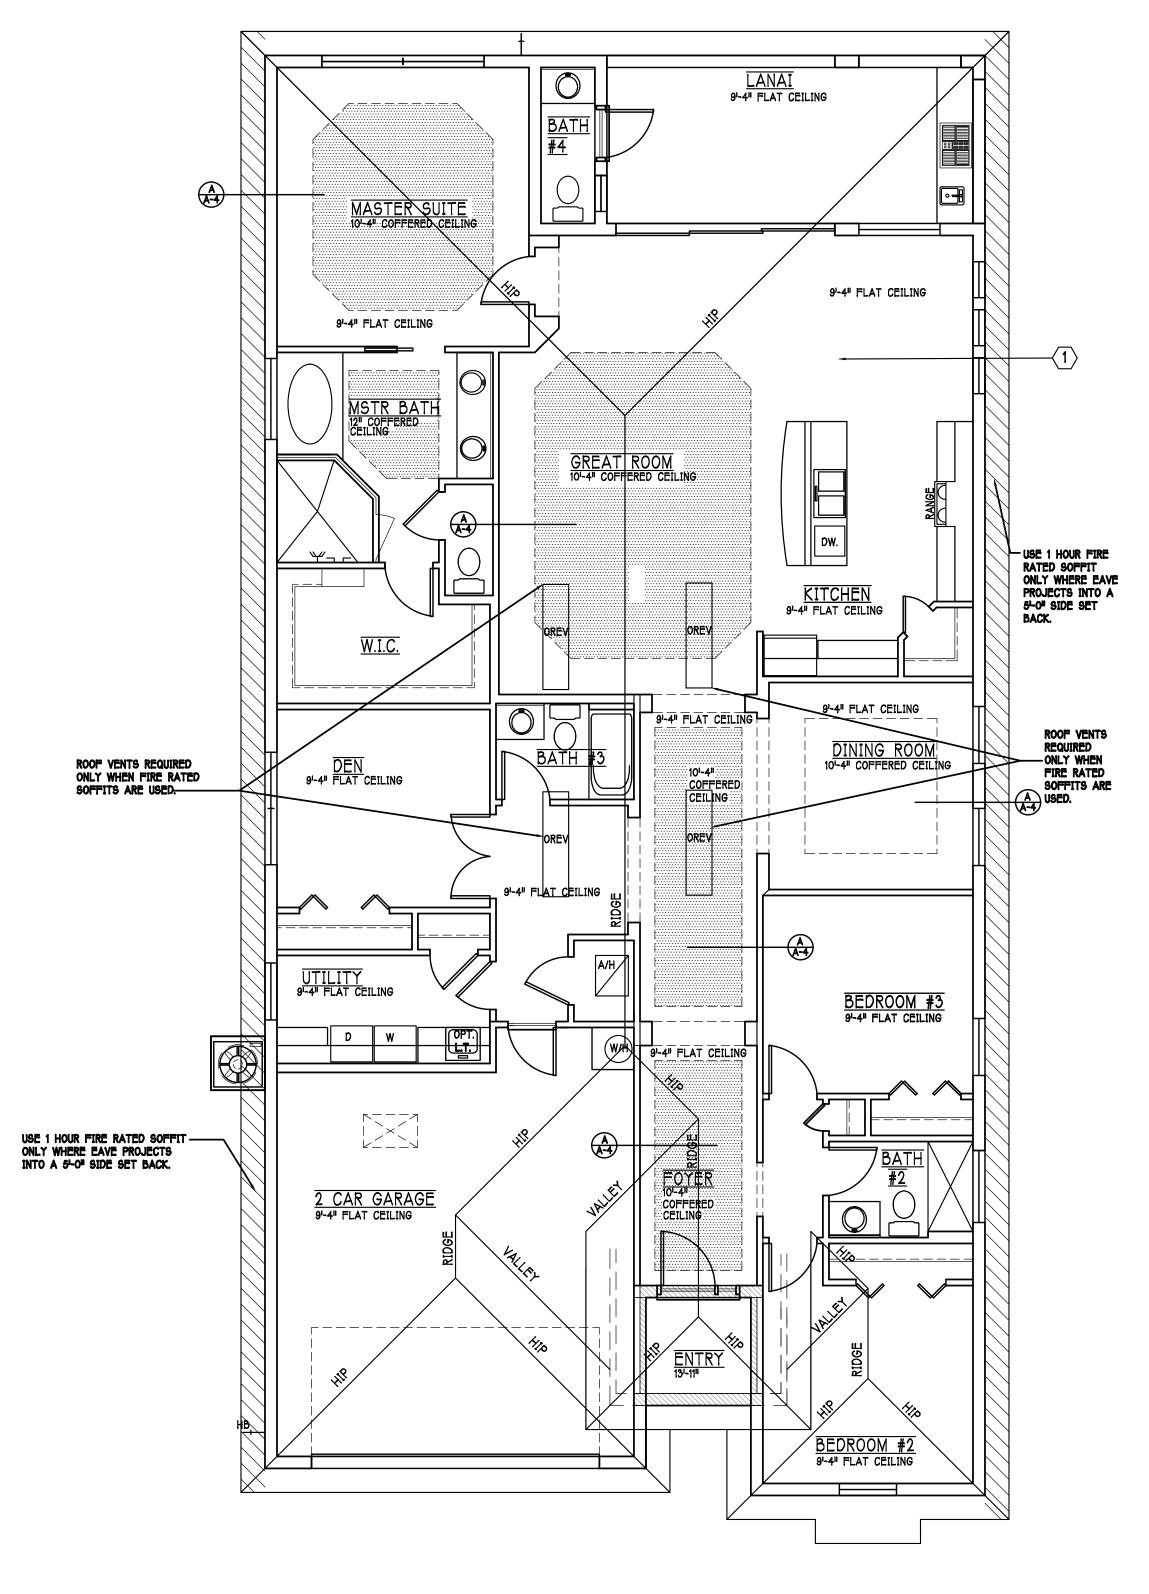

CEILING PLAN: "M" SCALE: 3/16" = 1'-0"

D.R.HORTON : 課 America's Budger

Gulf Coast Drafting & Design Phone (239) 540-1822 Fax (239) 540-7759

LOT: 103 BLOCK:

SUBDIV: BARRINGTON COVE

ADDRESS: 16281 ABERDEEN WAY

G.C.D.#: 9260 D.R.H.#: 578140103

MODEL:

UNIT 2431

SHEC

ROOF & CEILING

SCALE:

3/16"=1'-0"

SHEET#

DRAWN BY:

CHECKED BY:

CWL

DESIGN IN ACCORDANCE W/ THE 2014 RESIDENTIAL FLORIDA BUILDING CODE- 5TH EDITION

OPTIONAL ELECTRICAL PLAN 2431

200 Amp Service									
 TAG	QUANTITY	PRODUCT	PRODUCT #						
A	(38)	Recessed Cans							
В	(4)	Vapors							
С	(1)	Pendant/Nook	P4070-09						
D	(X)	10" Mushrooms	P3410-30						
E	(3)	24" Avalon 3 LT	P3268-09						
F	(2)	36" Avalon 4 LT	P3269-09						
G	(X)	NOT USED	NOT USED						
Н	(3)	Coach Lights	P5815-30						
J	(X)	Coach Lights	P5683-30						
K	(X)	J BOX							
L	(4)	4 ¹ Fluorescent	P7186-30						
М	(3)	2 ¹ Fluorescent	P7183-30						
N	(X)	5lt Chandelier	P4068-09						
0	(1)	3 LT Avalon	P3773-09						
р	(3)	Pendant Light	P-5068-09						
		-							

E	LECTRICAL LEGEND
	ELECTRICAL METER
	ELECTRICAL PANEL
0	120 V JUNCTION BOX
$\overline{\Diamond}$	SINGLE RECEPTACLE OUTLET
\blacksquare	220 V RECEPTACLE OUTLET
\bigoplus	4-PLEX RECEPTACLE OUTLET
Ш	DUPLEX RECEPTACLE OUTLET
ф	1/2 SWITCHED DUPLEX OUTLET
\Rightarrow	DUPLEX RECETACLE ● ELEV. A.F.F.
₩T	TIMER SWITCH
⊘ eFi	GFI SWITCH
₩D	DIMMER SWITCH
႘ှ3	3 WAY SWITCH
⇔	SINGLE POLE SWITCH
⊗ _{SD}	AC/DC SMOKE DETECTOR TO BE INTERCONNECTED ANY RESIDENT HAVING A FOSSIL-BURNING HEATER OR APPLIANCE, A FIREPLACE, OR AN ATTACHED GARAGE SHALL HAVE AN OPERATIONAL CARBON MONOXIDE ALARM INSTALLED WITHIN 10 FEET OF EACH ROOM USED FOR SLEEPING PERPOSES. PER RULE 98-3.04.72
\Box	TELEPHONE OUTLET
₽	TELEVISION RECEPTION OUTLET
ф-	SURFACE MOUNTED CEILING LIGHT
O	RECESSED LIGHT
Ю	WALL MTD. BRACKET LIGHT
44	DUPLEX FLOOD LIGHT
9	EXHAUST FAN

Electrical Notes

4' FLUORESCENT LIGHT

2 UNDER COUNTER LIGHT

□ TRACK MTD. LIGHTS
□ A/C DISCONNECT
□ PUSH BUTTON

DB DOOR BELL


KEYPAD


Install Arc-Fault circuit-Interrupters & Tamper-Resistant Receptacles shall be installed in dwelling unit. per NEC 210.12 & 406.11

All electrical equipment to be set at or above base flood elevation.

All outlets in wet areas and all exterior outlets to be GFI's Install Phone & T.V per contract.

INSTALL ALL ELECTRICAL PER NEC 2011

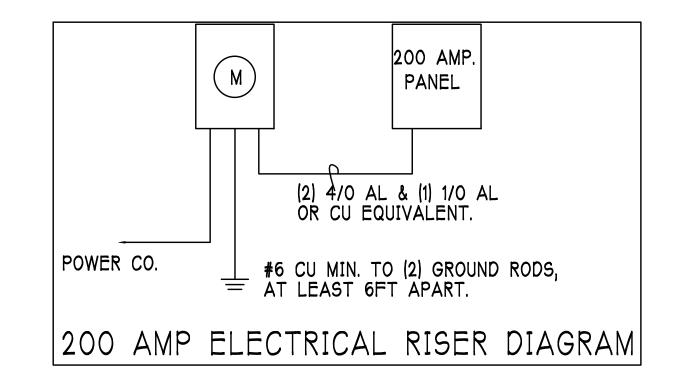

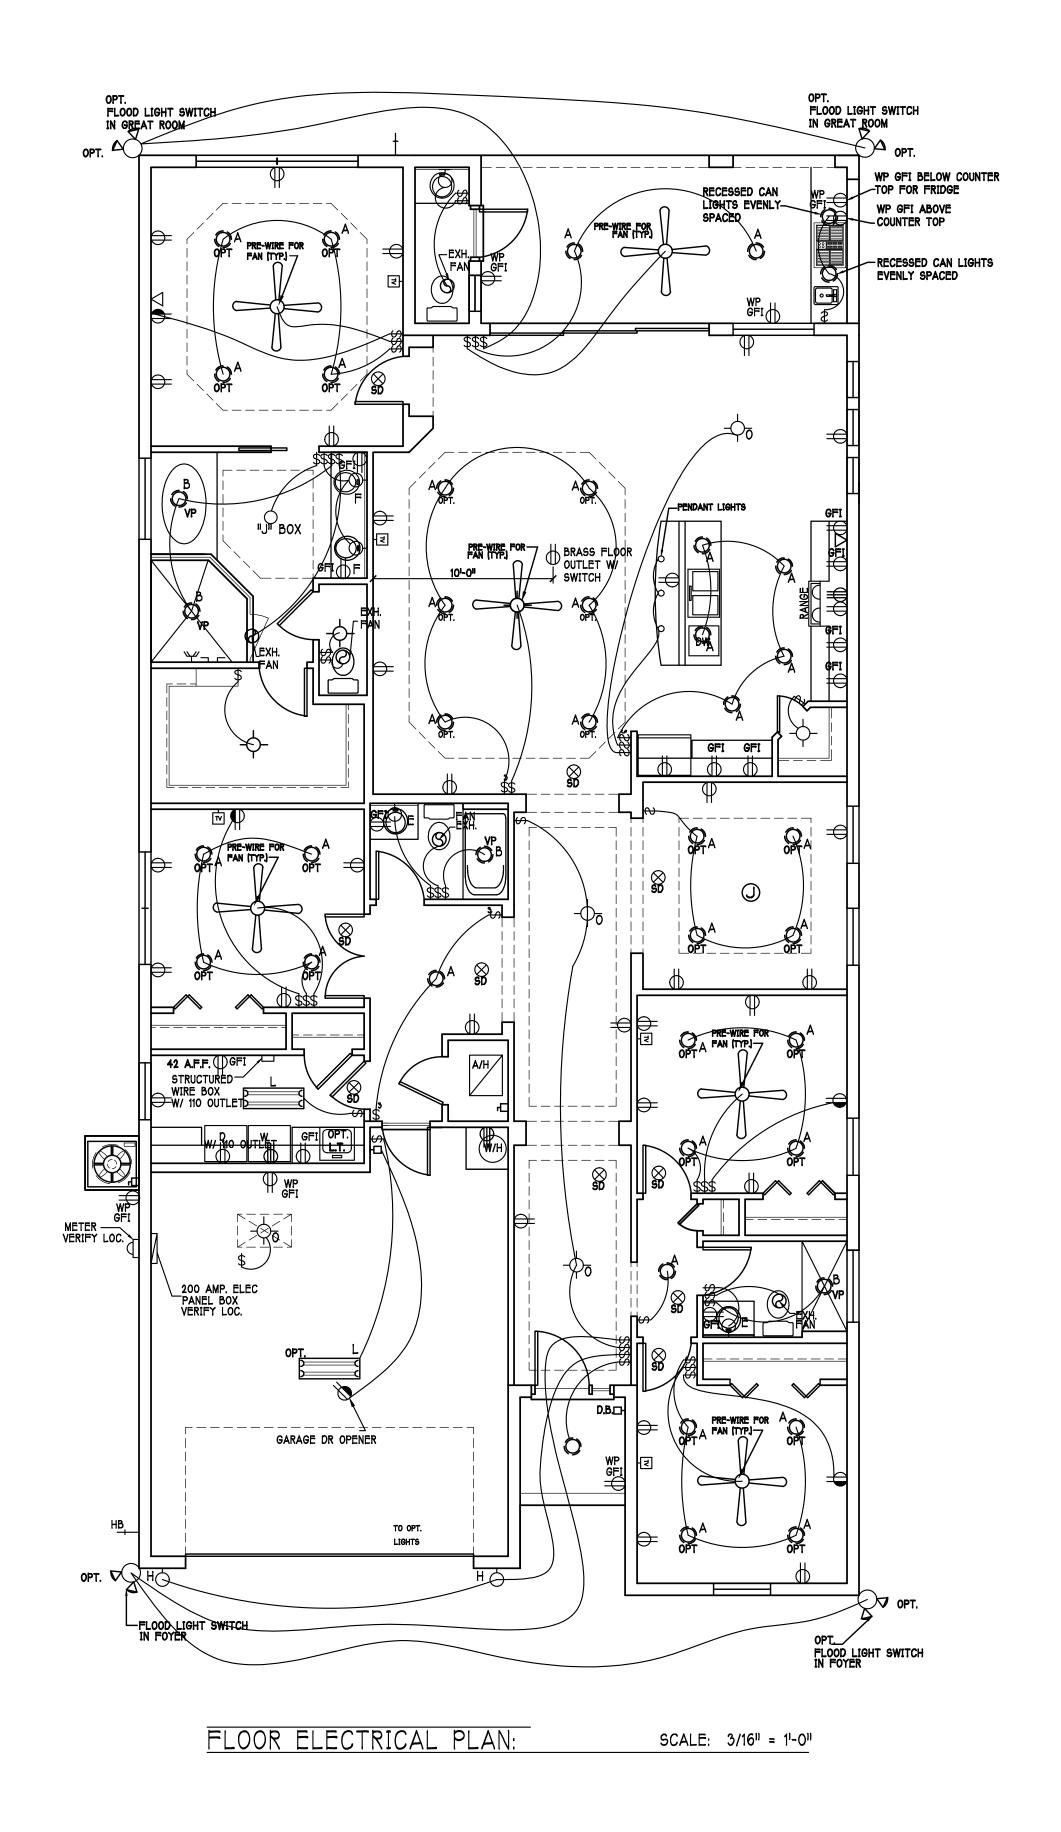

D.R.HORTON : 器 America's Buider

Gulf Coast Drafting
& Design
Phone (239) 540-1822
Fax (239) 540-7759

LOT: 103 BLOCK:

SUBDIV: BARRINGTON COVE

ADDRESS: 16281 ABERDEEN WAY

RESIDENCE FOR:
CODE A 2000 DE 11 AL 5701 40102

02-29-16

CWL

ELECTRICAL

A-5 M


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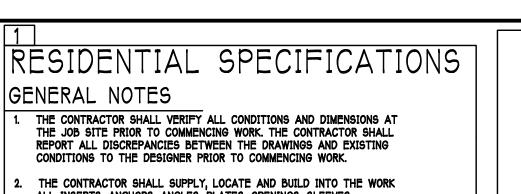
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REVISED:

DESIGN IN ACCORDANCE W/ THE 2014 RESIDENTIAL FLORIDA BUILDING CODE- 5TH EDITION





THE CONTRACTOR SHALL SUPPLY, LOCATE AND BUILD INTO THE WORK ALL INSERTS, ANCHORS, ANGLES, PLATES, OPENINGS, SLEEVES, HANGERS, SLAB DEPRESSIONS AND PITCHES AS MAY BE REQUIRED TO ATTACH AND ACCOMMODATE OTHER WORK.

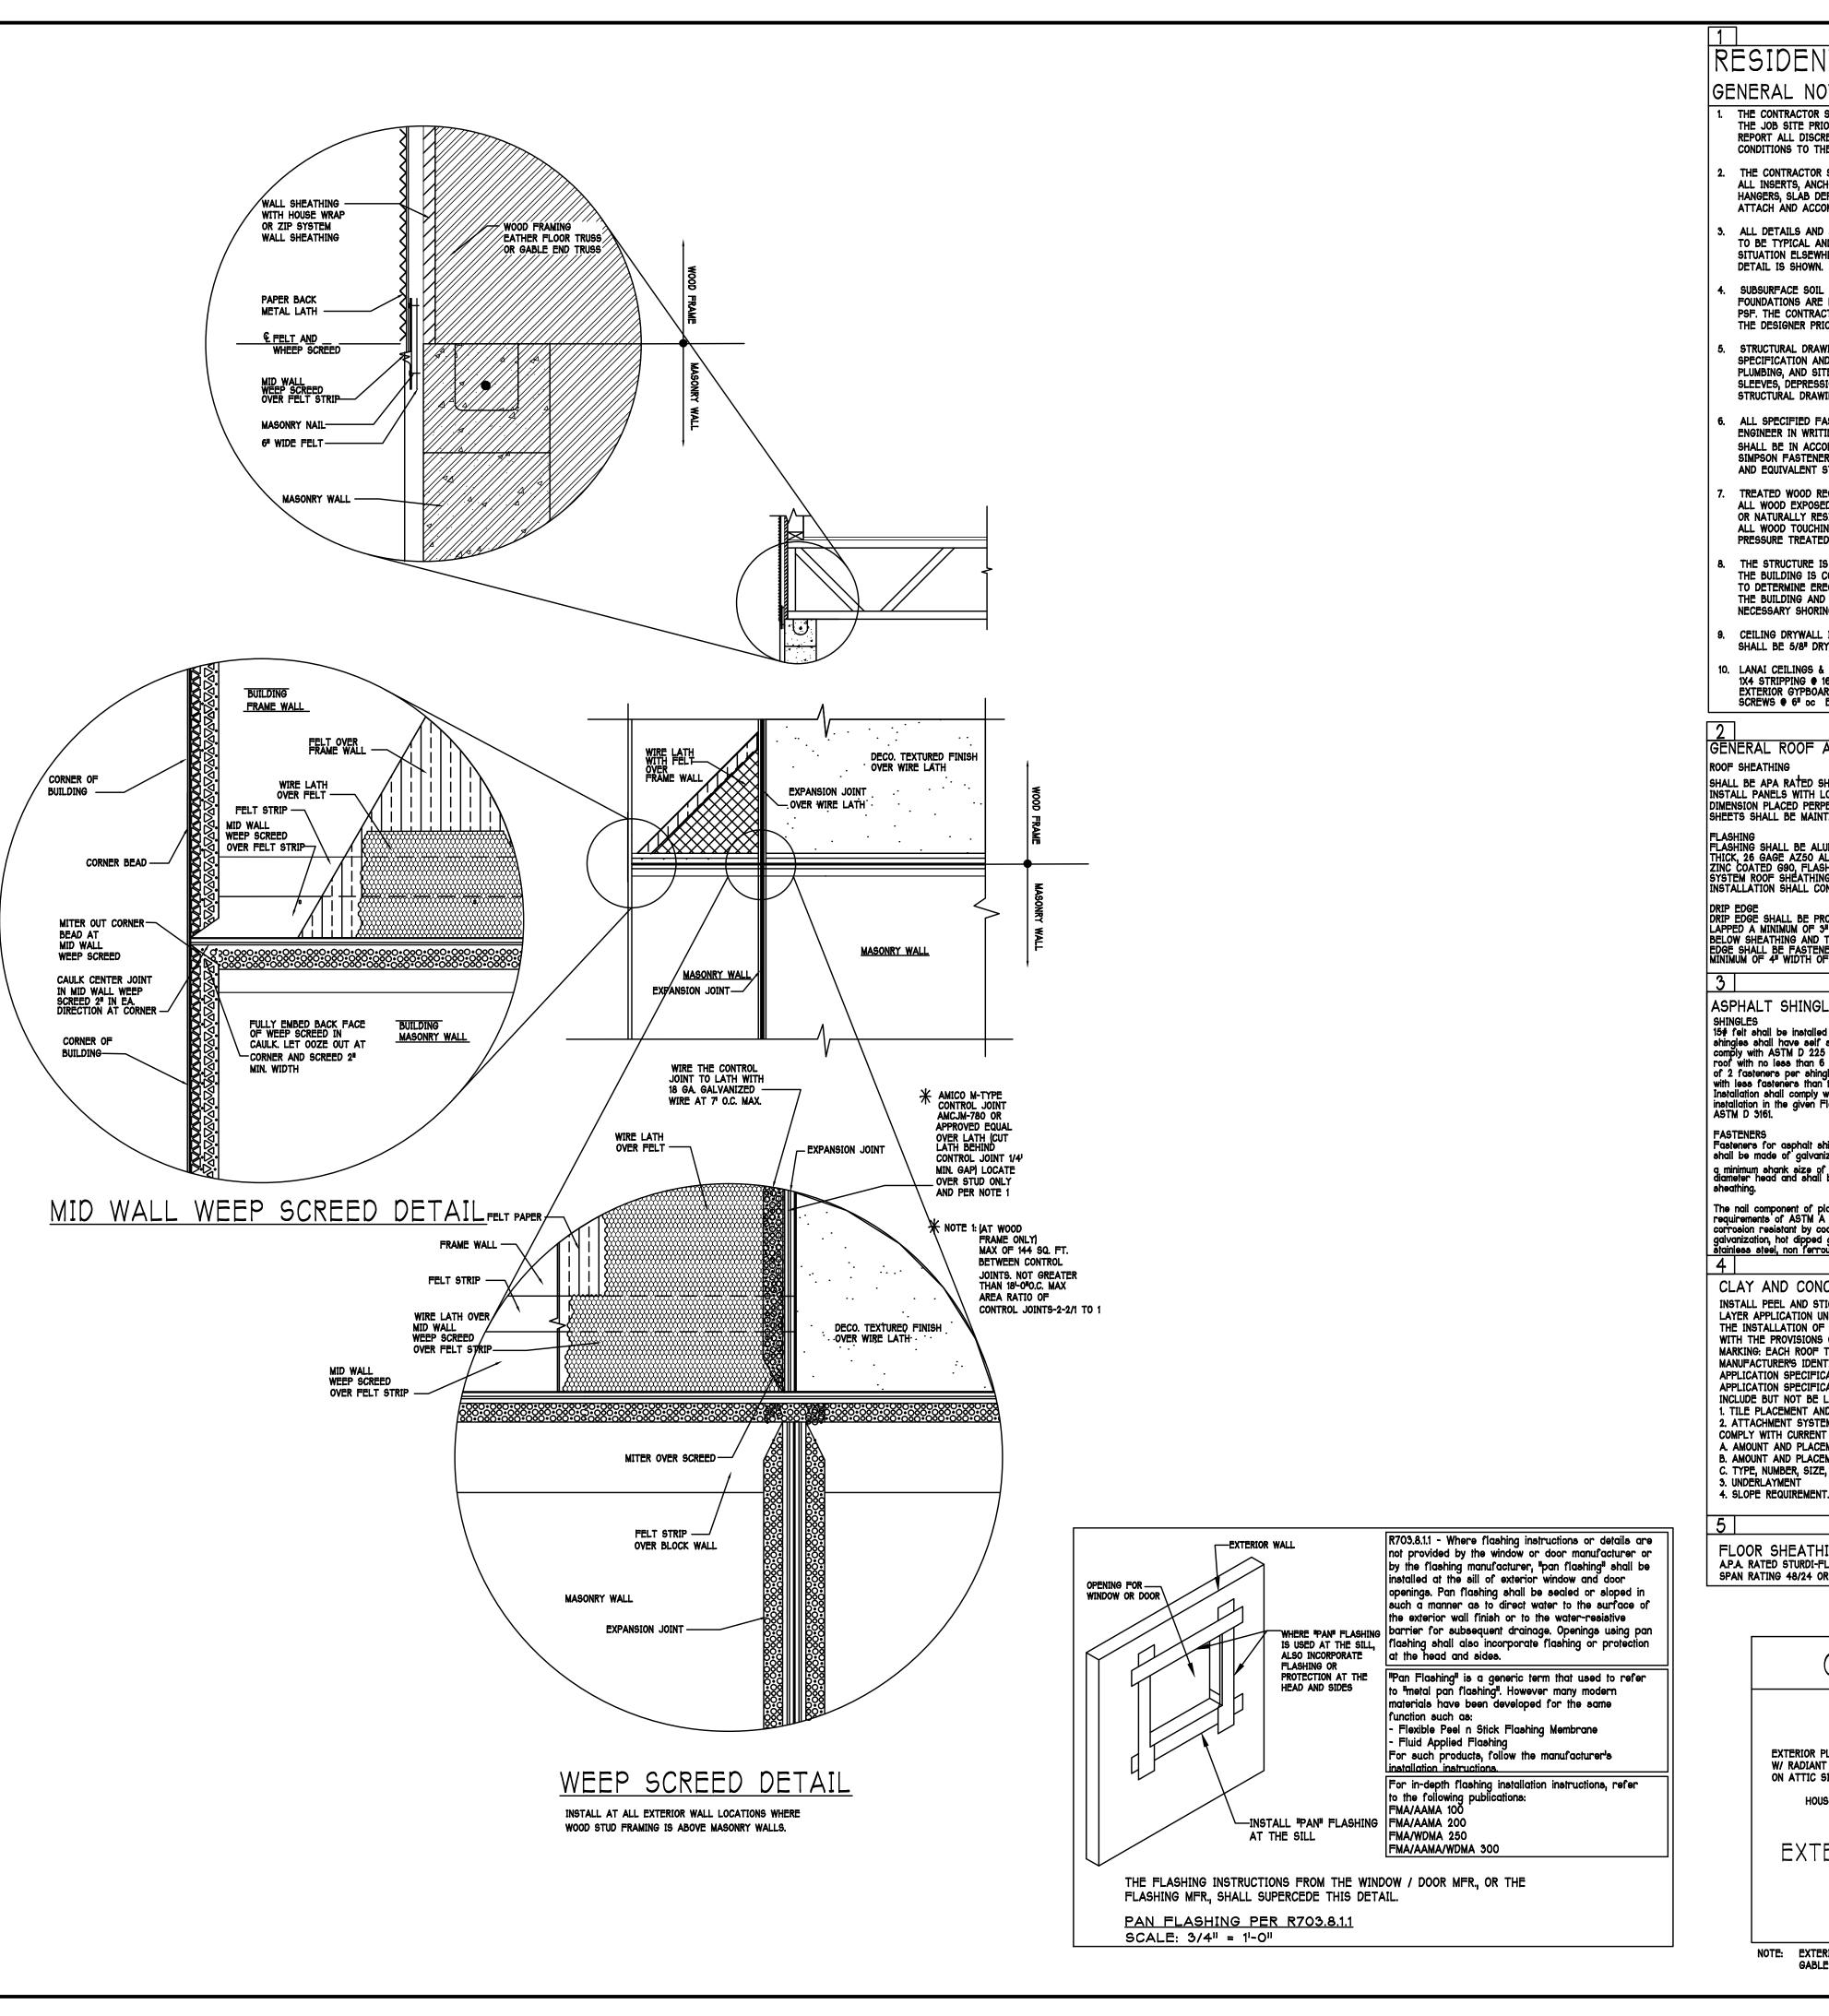ALL DETAILS AND SECTIONS SHOWN ON THE DRAWINGS ARE INTENDED TO BE TYPICAL AND SHALL BE CONSTRUCTED TO APPLY TO ANY SIMILAR SITUATION ELSEWHERE IN THE WORK EXCEPT WHERE A DIFFERENT

SUBSURFACE SOIL CONDITION INFORMATION IS NOT AVAILABLE FOUNDATIONS ARE DESIGNED FOR A SOIL BEARING CAPACITY OF 2,000 PSF. THE CONTRACTOR SHALL REPORT ANY DIFFERING CONDITIONS TO THE DESIGNER PRIOR TO COMMENCING WORK.

STRUCTURAL DRAWINGS SHALL BE USED IN CONJUNCTION WITH JOB SPECIFICATION AND HOUSE PLANS, MECHANICAL, ELECTRICAL, PLUMBING, AND SITE DRAWINGS, CONSULT THESE DRAWINGS FOR SLEEVES, DEPRESSIONS AND OTHER DETAILS NOT SHOWN ON STRUCTURAL DRAWINGS.

ALL SPECIFIED FASTENERS MAY ONLY BE SUBSTITUTED IF APPROVED BY THE ENGINEER IN WRITING, THE INSTALLATION OF THE FASTENERS SHALL BE IN ACCORDANCE WITH THE MANUFACTURER'S SPECIFICATIONS.
SIMPSON FASTENERS SPECIFIED MAY BE SUBSTITUTED WITH THE SAME QUANTITY AND EQUIVALENT STRENGTH PRODUCT.

TREATED WOOD REQUIREMENTS:-ALL WOOD EXPOSED TO WEATHER SHALL BE PROTECTED, PRESSURE TREATED, OR NATURALLY RESISTANT TO DECAY. ALL WOOD TOUCHING MASONRY OR CONCRETE SHALL BE ISOLATED, OR

THE STRUCTURE IS DESIGNED TO BE SELF SUPPORTING AND STABLE AFTER THE BUILDING IS COMPLETE. IT IS THE CONTRACTOR'S SOLE RESPONSIBILITY TO DETERMINE ERECTION PROCEDURES AND SEQUENCES TO ENSURE SAFETY OF THE BUILDING AND ITS COMPONENTS DURING ERECTION. THIS INCLUDES THE NECESSARY SHORING, SHEETING, TEMPORARY BRACING, GUYS, OR TIE DOWNS.

CEILING DRYWALL INSTALLED WITHIN THE HOUSE TO TRUSSES SPACED 24" O.C. SHALL BE 5/8" DRYWALL OR 1/2" SAG RESISTANT PER SEC. 702.3.5

1X4 STRIPPING @ 16" O.C. FASTENED WITH 2-8d NAILS TO EACH TRUSS. 5/8" EXTERIOR GYPBOARD CEILING FASTENED WITH 8d NAILS OR 1-5/8" DRYWALL SCREWS @ 6" oc EDGE AND FIELD.

GENERAL ROOF ASSEMBLY

PRESSURE TREATED.

ROOF SHEATHING SHALL BE APA RATED SHEATHING, EXPOSURE 1, SPAN RATING 24/16 OR BETTER INSTALL PANELS WITH LONG DIMENSION PLACED PERPENDICULAR TO TRUSSES. A 1/8" SPACE BETWEEN ADJACENT SHEETS SHALL BE MAINTAINED. INSTALL "H" CLIPS AT UNSUPPORTED PANEL EDGES.

FLASHING SHALL BE ALUMINUM, ALUMINUM ZINC COATED STEEL .0179 INCHES THICK, 26 GAGE AZ50 ALUM ZINC, OR GALVANIZED STEEL .0179 INCHES THICK, 26 GAGE ZINC COATED G90, FLASHING SHALL BE INSTALLED IN ACCORDANCE WITH THE ZIP SYSTEM ROOF SHEATHING MANUFACTURERS PUBLISHED REQUIREMENTS. ALL FLASHING AND INSTALLATION SHALL CONFORM TO SECTION R905.2.8 (1 TO 5).

DRIP EDGE
DRIP EDGE SHALL BE PROVIDED AT ALL EAVES AND GABLES OF SHINGLE ROOFS,
LAPPED A MINIMUM OF 3" • JOINTS. THE OUTSIDE EDGE SHALL EXTEND A MINIMUM OF 1/2"
BELOW SHEATHING AND THE INSIDE EDGE SHALL EXTEND BACK A MINIMUM OF 2". DRIP
EDGE SHALL BE FASTENED AT NO MORE THAN 4" CENTERS. THERE SHALL BE A
MINIMUM OF 4" WIDTH OF ROOF CEMENT INSTALLED OVER THE DRIP EDGE FLANGE.

ASPHALT SHINGLE ROOF SPEC'S

15# felt shall be installed under asphalt shingles. All asphalt shingles shall have self sealing strips or be interlocking and comply with ASTM D 225 or D3462, and shall be secured to the roof with no less than 6 fasteners per shingle strip, or a minimum of 2 fasteners per shingle tab. And shall in no case be fastened with less fasteners than that required by the manufacture. Installation shall comply with the manufactures requirements for installation in the given Florida wind zone, as determined by ASTM D 3161.

Fasteners for asphalt shingles shall comply with ASTM F 1667, and shall be made of galvanized steel, stainless steel or aluminum with g minimum shank size of 12 gags (0.105 inches) with a minimum 3/8 inch diameter head and shall be of a length to penetrate the

The nail component of plastic cap nails shall meet or exceed the requirements of ASTM A 641, Class I, or equal, and shall be corrosion resistant by coating electro galvanization, mechanical galvanization, hot dipped galvanization or shall be made of stainless steel, non ferrous metal.

CLAY AND CONCRETE TILE ROOF SPECS INSTALL PEEL AND STICK UNDERLAYMENT APPROVED FOR SINGLE LAYER APPLICATION UNDER TILE ROOF. THE INSTALLATION OF CLAY AND CONCRETE TILE SHALL COMPLY WITH THE PROVISIONS OF R905.3 F.B.C.
MARKING: EACH ROOF TILE SHALL HAVE A PERMANENT MANUFACTURER'S IDENTIFICATION MARK. APPLICATION SPECIFICATIONS: THE TILE MANUFACTURER'S WRITTEN APPLICATION SPECIFICATIONS SHALL BE AVAILABLE AND SHALL INCLUDE BUT NOT BE LIMITED TO THE FOLLOWING: 1. TILE PLACEMENT AND SPACING, 2. ATTACHMENT SYSTEM NECESSARY TO COMPLY WITH CURRENT WIND CODE, A. AMOUNT AND PLACEMENT OF MORTAR B. AMOUNT AND PLACEMENT OF ADHESIVE, C. TYPE, NUMBER, SIZE, AND LENGTH OF FASTENERS AND CLIPS. 3. UNDERLAYMENT

FLOOR SHEATHING AT 2ND FLOOR
A.P.A. RATED STURDI-FLOOR, EXPOSURE 1, TONGUE & GROOVE EDGES
SPAN RATING 48/24 OR BETTER, GLUED AND NAILED


GABLE WALL


EXTERIOR PLYWOOD -W/ RADIANT BARRIER

HOUSE WRAP-

EXTERIOR

ON ATTIC SIDE

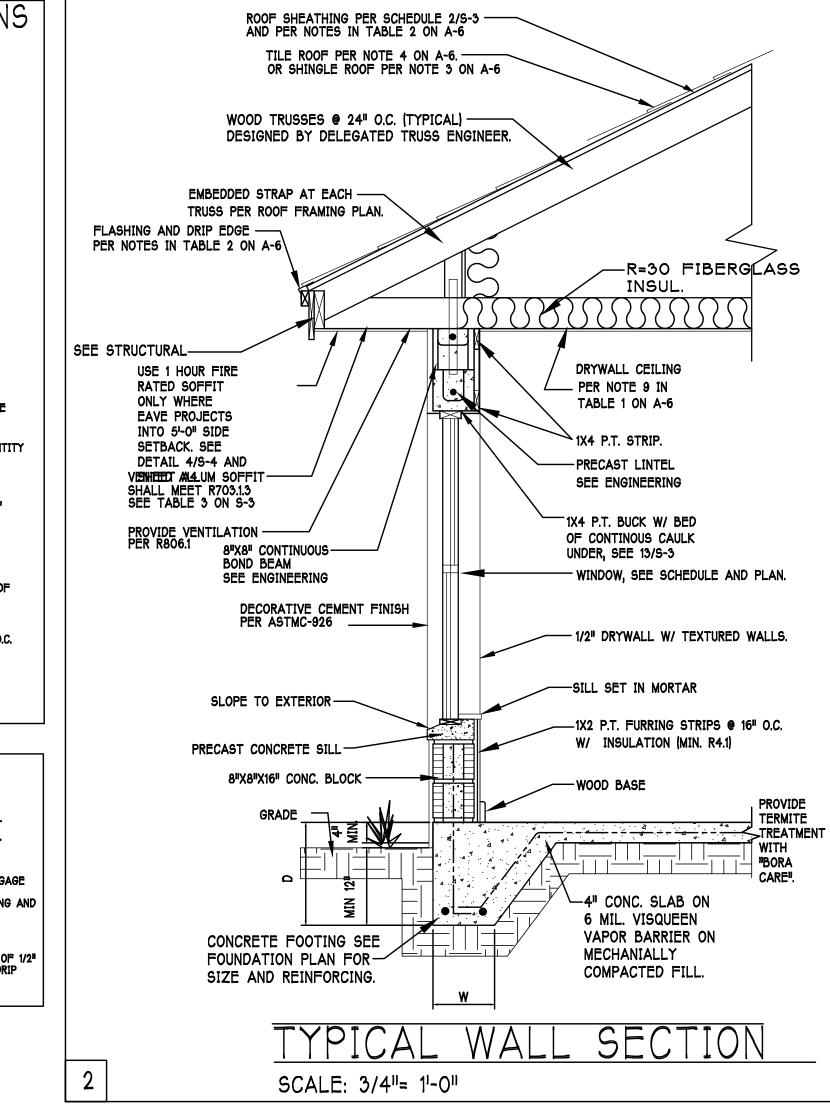

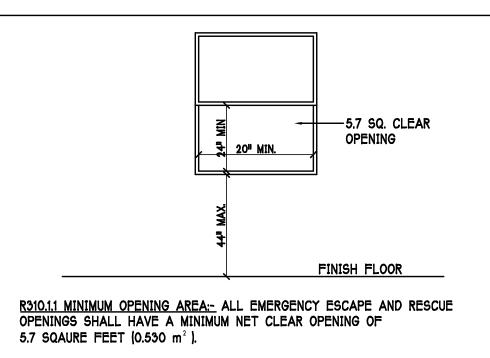

NOTE: EXTERIOR WALLS ADJACENT TO ATTIC SPACE, INCLUDING KNEEWALLS AND GABLE END WALLS, MUST HAVE RADIANT BARRIER AND HOUSE WRAP.

STUD WALL

OR TRUSS

EXTERIOR

-RADIANT BARRIER

RADIANT BARRIER:

GLUED TO PLYWOOD

ATTIC

∠TOP CHORD

SCALE: N.T.S.

DESIGN IN ACCORDANCE W/ THE 2014 RESIDENTIAL FLORIDA BUILDING CODE- 5TH EDITION

	MODEL	
5.7 SQ. CLEAR OPENING	BLOCK:	CITEDITY, DAPPINCTON COLLE
R310.1.1 MINIMUM OPENING AREA:- ALL EMERGENCY ESCAPE AND RESCUE OPENINGS SHALL HAVE A MINIMUM NET CLEAR OPENING OF 5.7 SQAURE FEET (0.530 m²).	LOT: 103	ות א ת ./זזרות זוי
EXCEPTION:- GRADE FLOOR OPENINGS SHALL HAVE A MINIMUM NET CLEAR OPENING OF 5 SQUARE FEET (0.465 m ²). R310.1.2 MINIMUM OPENING HEIGHT:- THE MINIMUM NET CLEAR OPENING	DATE:	
HEIGHT SHALL BE 24 INCHES (610mm). R310.1.3 MINIMUM OPENING WIDTH:- THE MINIMUM NET CLEAR OPENING WIDTH SHALL BE 20 INCHES (508mm).	DRAWN	N B
R310.1.4 OPERATIONAL CONSTRAINTS:- EMERGENCY ESCAPE AND RESCUE OPENINGS SHALL BE OPERATIONAL FROM THE INSIDE OF THE ROOM WITHOUT THE USE OF KEYS OR TOOLS.	CHECK	ED
R310.2 WINDOW WELLS:- THE MINIMUM HORIZONTAL AREA OF THE WINDOW WELL SHALL BE 9 SQUARE FEET (0.84 m²), WITH A MINIMUM HORIZONTAL PROJECTION AND WIDTH OF 36 INCHES (914mm). THE AREA OF THE WINDOW WELL SHALL ALLOW THE EMERGENCY ESCAPE AND RESCUE OPENING TO BE FULLY OPENED.	REVISE PLAN:	ED:
MINIMUM EGRESS WINDOW DETAIL	SCALE:	,

82 ign 540-1 540-77 Design (239) 5 (39) 54

RESIDENCE 1 BARRINGTON COVE

02-29-16

CWL JWC

SECTION

3/16"=1'-0"

A-6M

SCALE: 3/16" = 1'-0"

1) TOP OF GROUND FLOOR SLAB DATUM ELEVATION 0'-0".

2) 'F#' DENOTES CONTINUOUS WALL FOOTING TYPE PER SCHEDULE THIS SHEET.

3) (#) DENOTES PAD FOOTING AT CONCENTRATED LOADS PER SCHEDULE THIS SHEET.

4) PROVIDE #5 VERTICAL REINFORCING AT DOT LOCATIONS SHOWN ON PLAN FROM FOOTING

TÓ BOND BEAM.


5) ALL DIMENSIONS ARE TO OUTSIDE FACE OF MASONRY WALLS. SOME SLAB EDGES MAY EXTEND BEYOND FACE OF WALL.


6) FOR DIMENSIONS OF ROUGH OPENINGS IN MASONRY WALLS, COORDINATE WITH WINDOW/DOOR SUPPLIER.


7) PROVIDE PRESSURE TREATED BUCKS AT WINDOWS / DOORS PER DETAIL 7/S-3.

_									
וופנט	TYPE	TYPE LENGTH WIDTH DEPTH BOTTOM REINF. LONG WAY SHORT WAY					REMARKS		
		2'-6"	2'-6"	1'-0"	3-#5	3-#5	1		
	B	3'-0"	3'-0"	1'-0"	4-#5	4-#5	1		
	©	3'-6"	3'-6"	1'-0"	4-#5	4-#5	ı		
	(D)	4'-0"	4'-0"	1'-2"	5-#5	5-#5	-		
Γ	(E)	5'-0"	5'-0"	1'-2"	6-#5	6-#5	_		

USED	TYPE	LENGTH	WIDTH	DEPTH	BOTTOM REINFORCING	SHAPE	
X	F1	CONT.	1'-4"	0'-8"	2-#5	Щ	
	F2	CONT.	1'-8"	0'-10"	2-#5	柦	ADD
X	F3	CONT.	1'-0"	1'-8"	2-#5	P	GAR
	F4	CONT.	1'-4"	1'-8"	2-#5	P	DET
	F5	CONT.	1'-4"	1'-0"	2-#5	[]	
	F6	CONT.	1'-4"	1'-0"	2-#5	1	
X	F6A	CONT.	8"	8"	1-#5	[}	
	TE	CONT.	0'-8"	0'-8"	1-#5	1	

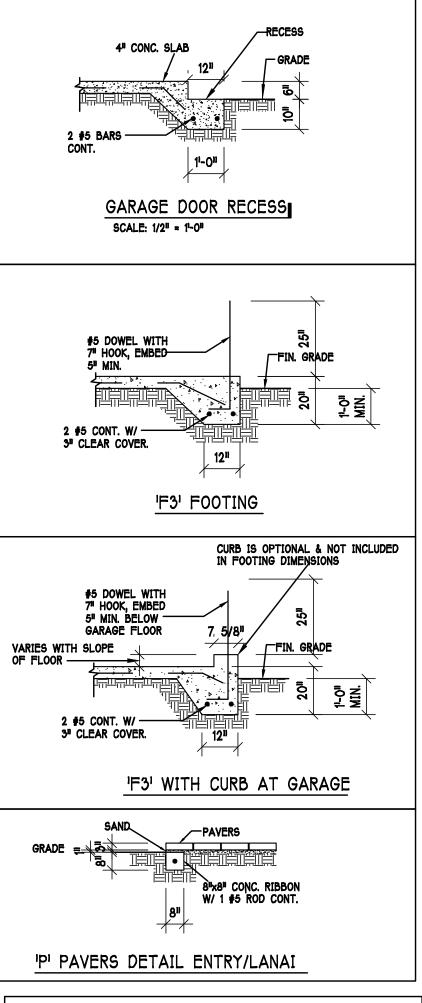

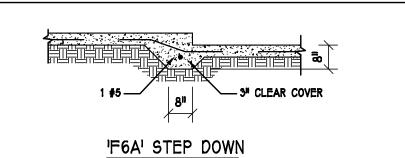

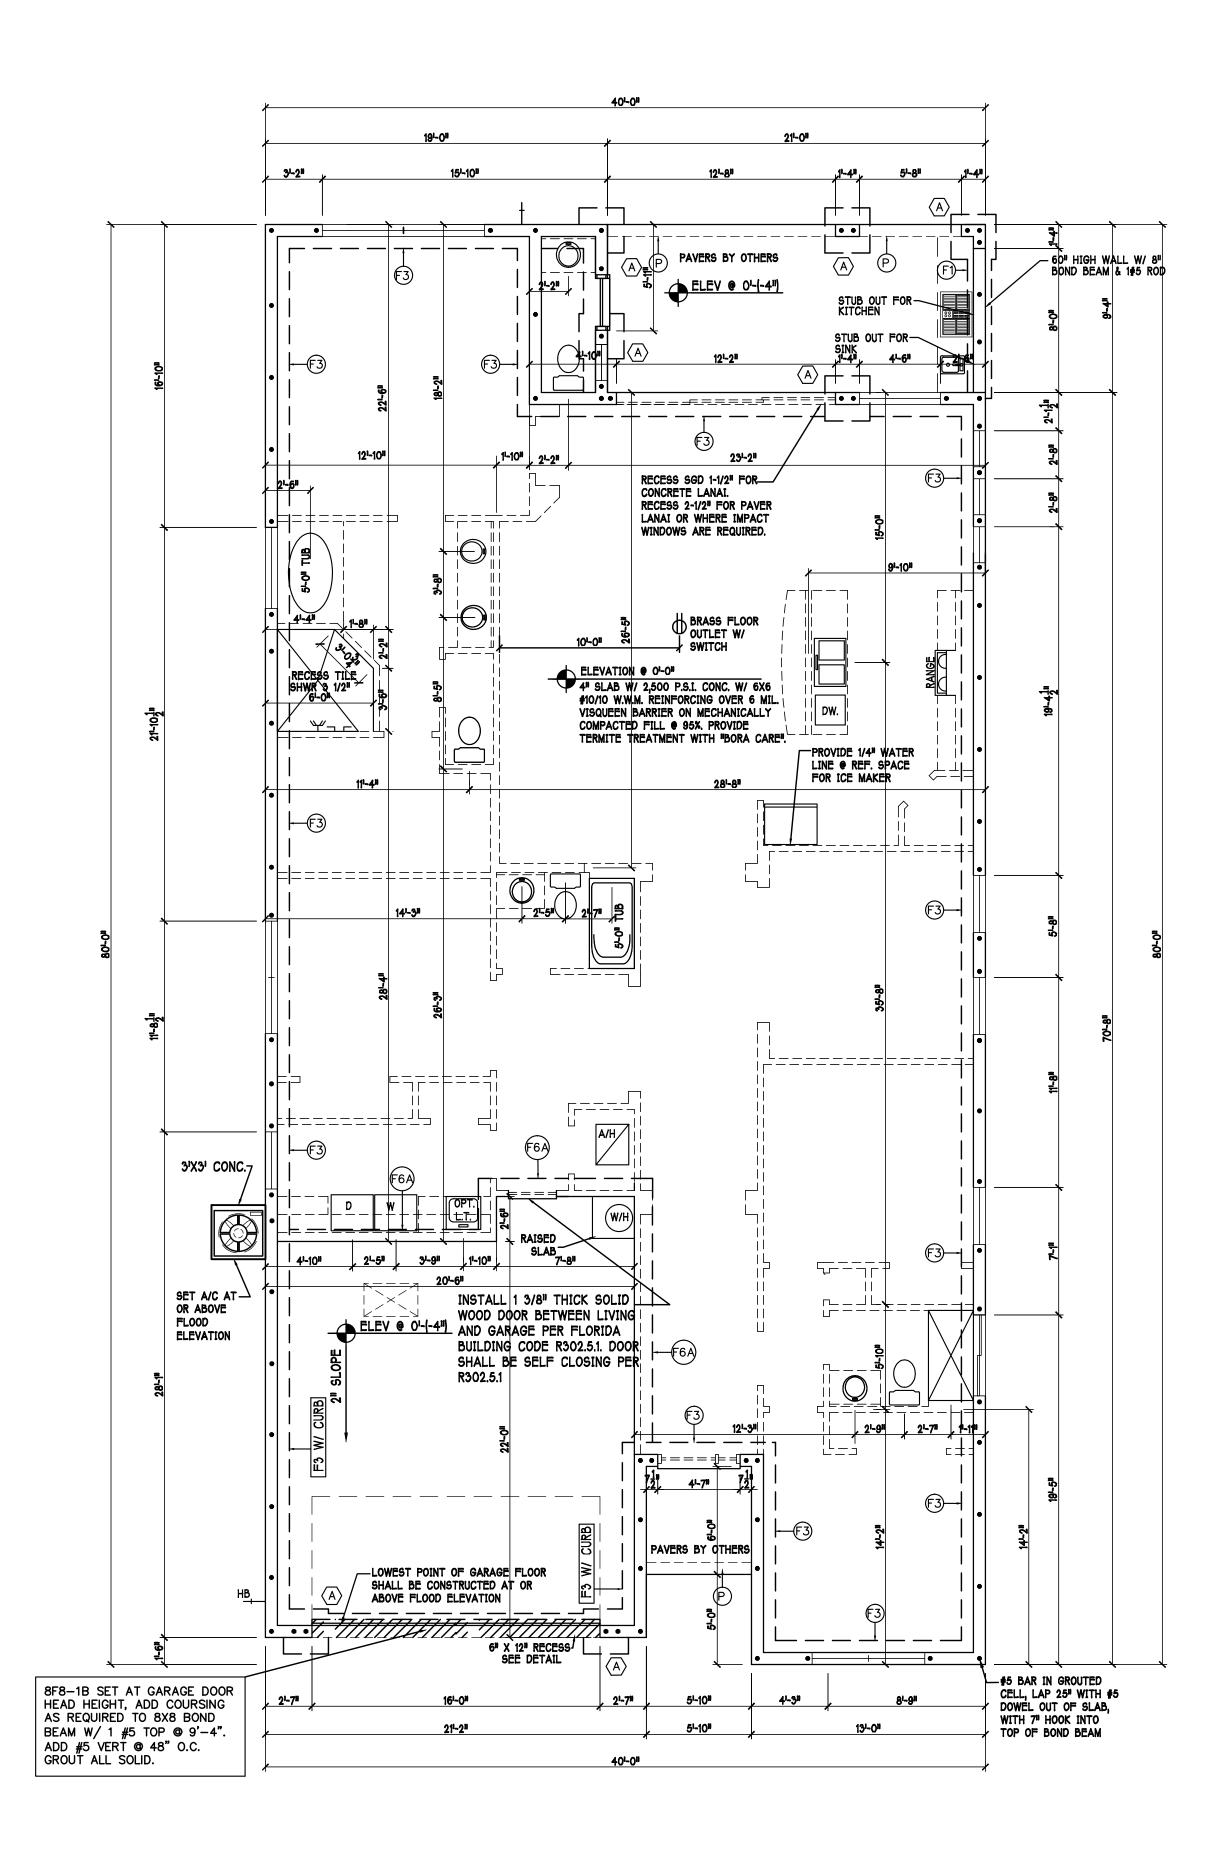

FOUNDATION PLAN: SCALE: 3/16"=1'-0" D.R.HORTON.

(239) 540-1822 (39) 540-7759

STRUCTURAL SYSTEMS OF NORTH FLORIDA 1634 SE. 47th ST SUITE #3 CAPE CORAL, FL 33904 (239) 549-4554 02-29-16

DRAWN BY:

CHECKED BY:

FOUNDATION

3/16" = 1'-0'

REVISED:

DESIGN IN ACCORDANCE W/ THE 2014 RESIDENTIAL FLORIDA BUILDING CODE- 5TH EDITION

1) PROVIDE A STRAP FROM THE ABOVE LIST AT EACH ROOF TRUSS BEARING POINT, BASED ON THE TRUSS UPLIFT VALUES IN THE SIGNED AND SEALED TRUSS DESIGN PACKAGE AND SUITABLE FOR THE GEOMETRY. EMBED STRAP ON © OF WALL.

2) CONNECTORS ARE SIMPSON STRONG TIE. ALL CONNECTORS SHALL BE INSTALLED IN STRICT ACCORDANCE WITH SIMPSON PRINTED INSTRUCTIONS. SUBSTITUTIONS MUST BE APPROVED IN WRITING BY THE ENGINEER OF RECORD.

3) WHERE EMBEDDED STRAPS ARE MISSING, OR MIS-LOCATED, INSTALL RETROFIT

REV 2

PLAN NOTES:

1) ROOF TRUSS BEARING ELEVATION VARIES, SEE LEGEND.


2) ROOF FRAMING SHALL BE WOOD TRUSSES DESIGNED BY A DELEGATED TRUSS ENGINEER PER DESIGN CRITERIA ON SHEET S-3.

3) PROVIDE STRAPPING AT TRUSSES PER NOTES ON THIS SHEET.

4) FOR NAILING OF ROOF DECK, SEE 1 AND 2 ON S-3.

5) 8F8-1B etc., DENOTES PRECAST LINTEL ABOVE DOOR/WINDOW OPENING PER SCHEDULE THIS SHEET.

6) AT TRUSS BEARING, PROVIDE 8x8 MASONRY BOND BEAM W/ 1 \$5 CONTINUOUS, SEE DETAIL 2/A-6.

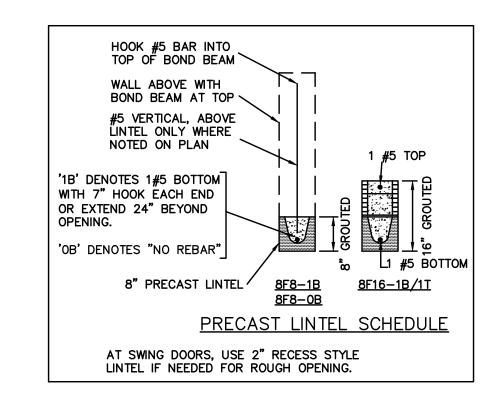


STRAP PER 10/S-3.

TRUSS BEARING CONDITIONS AND STRAPPING IS BASED ON TRUSS LAYOUT PREPARED BY RAYMOND, JOB #: 13050802M8, DATED: 06/17/2014, REVISED: NONE

BEARING HEIGHTS

= BEARING @ 9'-4" A.F.F.

= BEARING @ 13'-11"

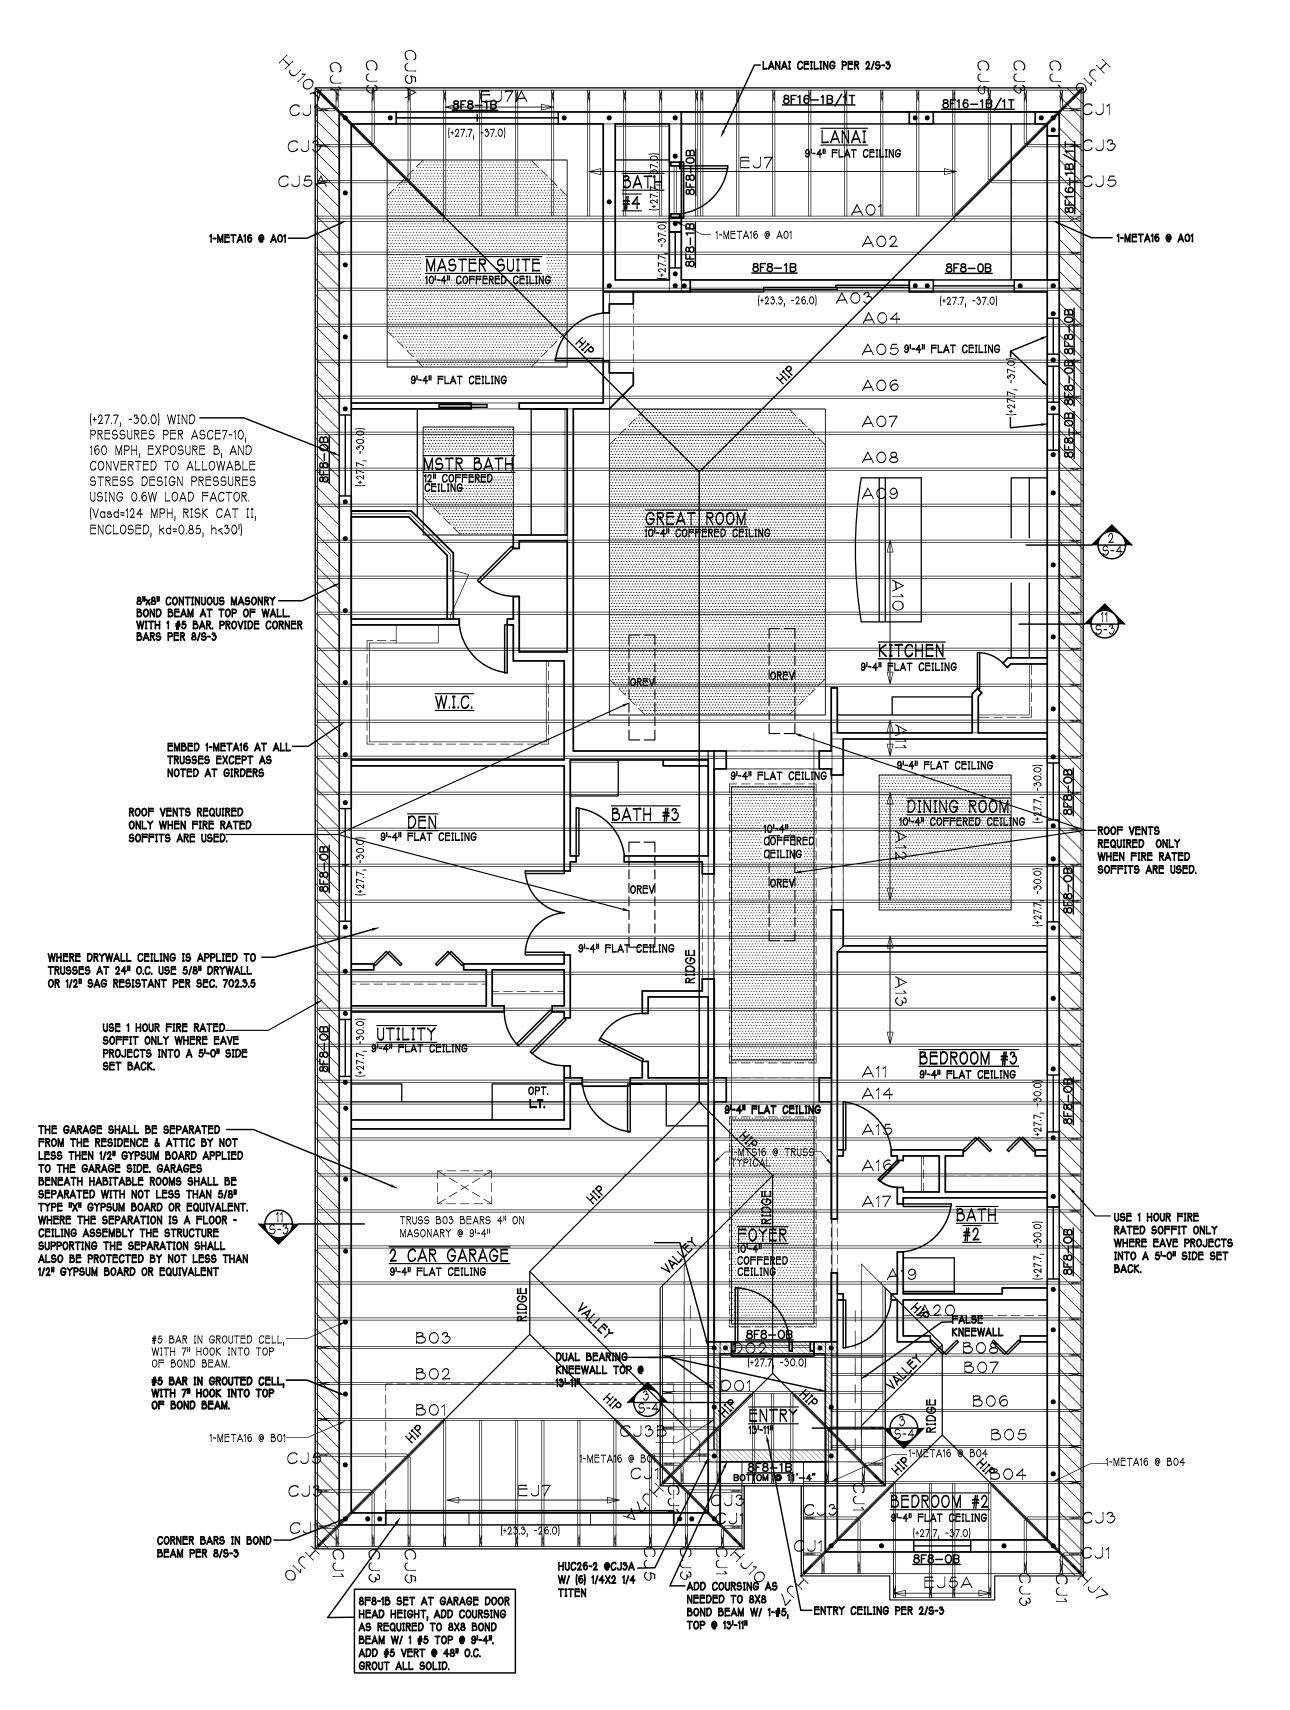

ROOF PLAN: "M" SCALE: 3/16" = 11-0"


D-R-HORTON : 除 America's Swider

Gulf Coast Drafting & Design Phone (239) 540-1822 Fax (239) 540-7759


| Color | 103 | BLOCK; | MODEL: | Carbo lated to shroutenal Engineer of Record only. No work sperformed by the Structural Engineer of Record only. No work as performed by the Structural Engineer of Record only. No work as performed by the Structural Engineer of Record only. No work as performed by the Structural Engineer of Record only. SUBDIV: BARRINGTON COVE | UNIT 2431 | STRUCTURAL ENGINEERING STRUCTURAL EN


REVISED:


3/16"=1'-0"

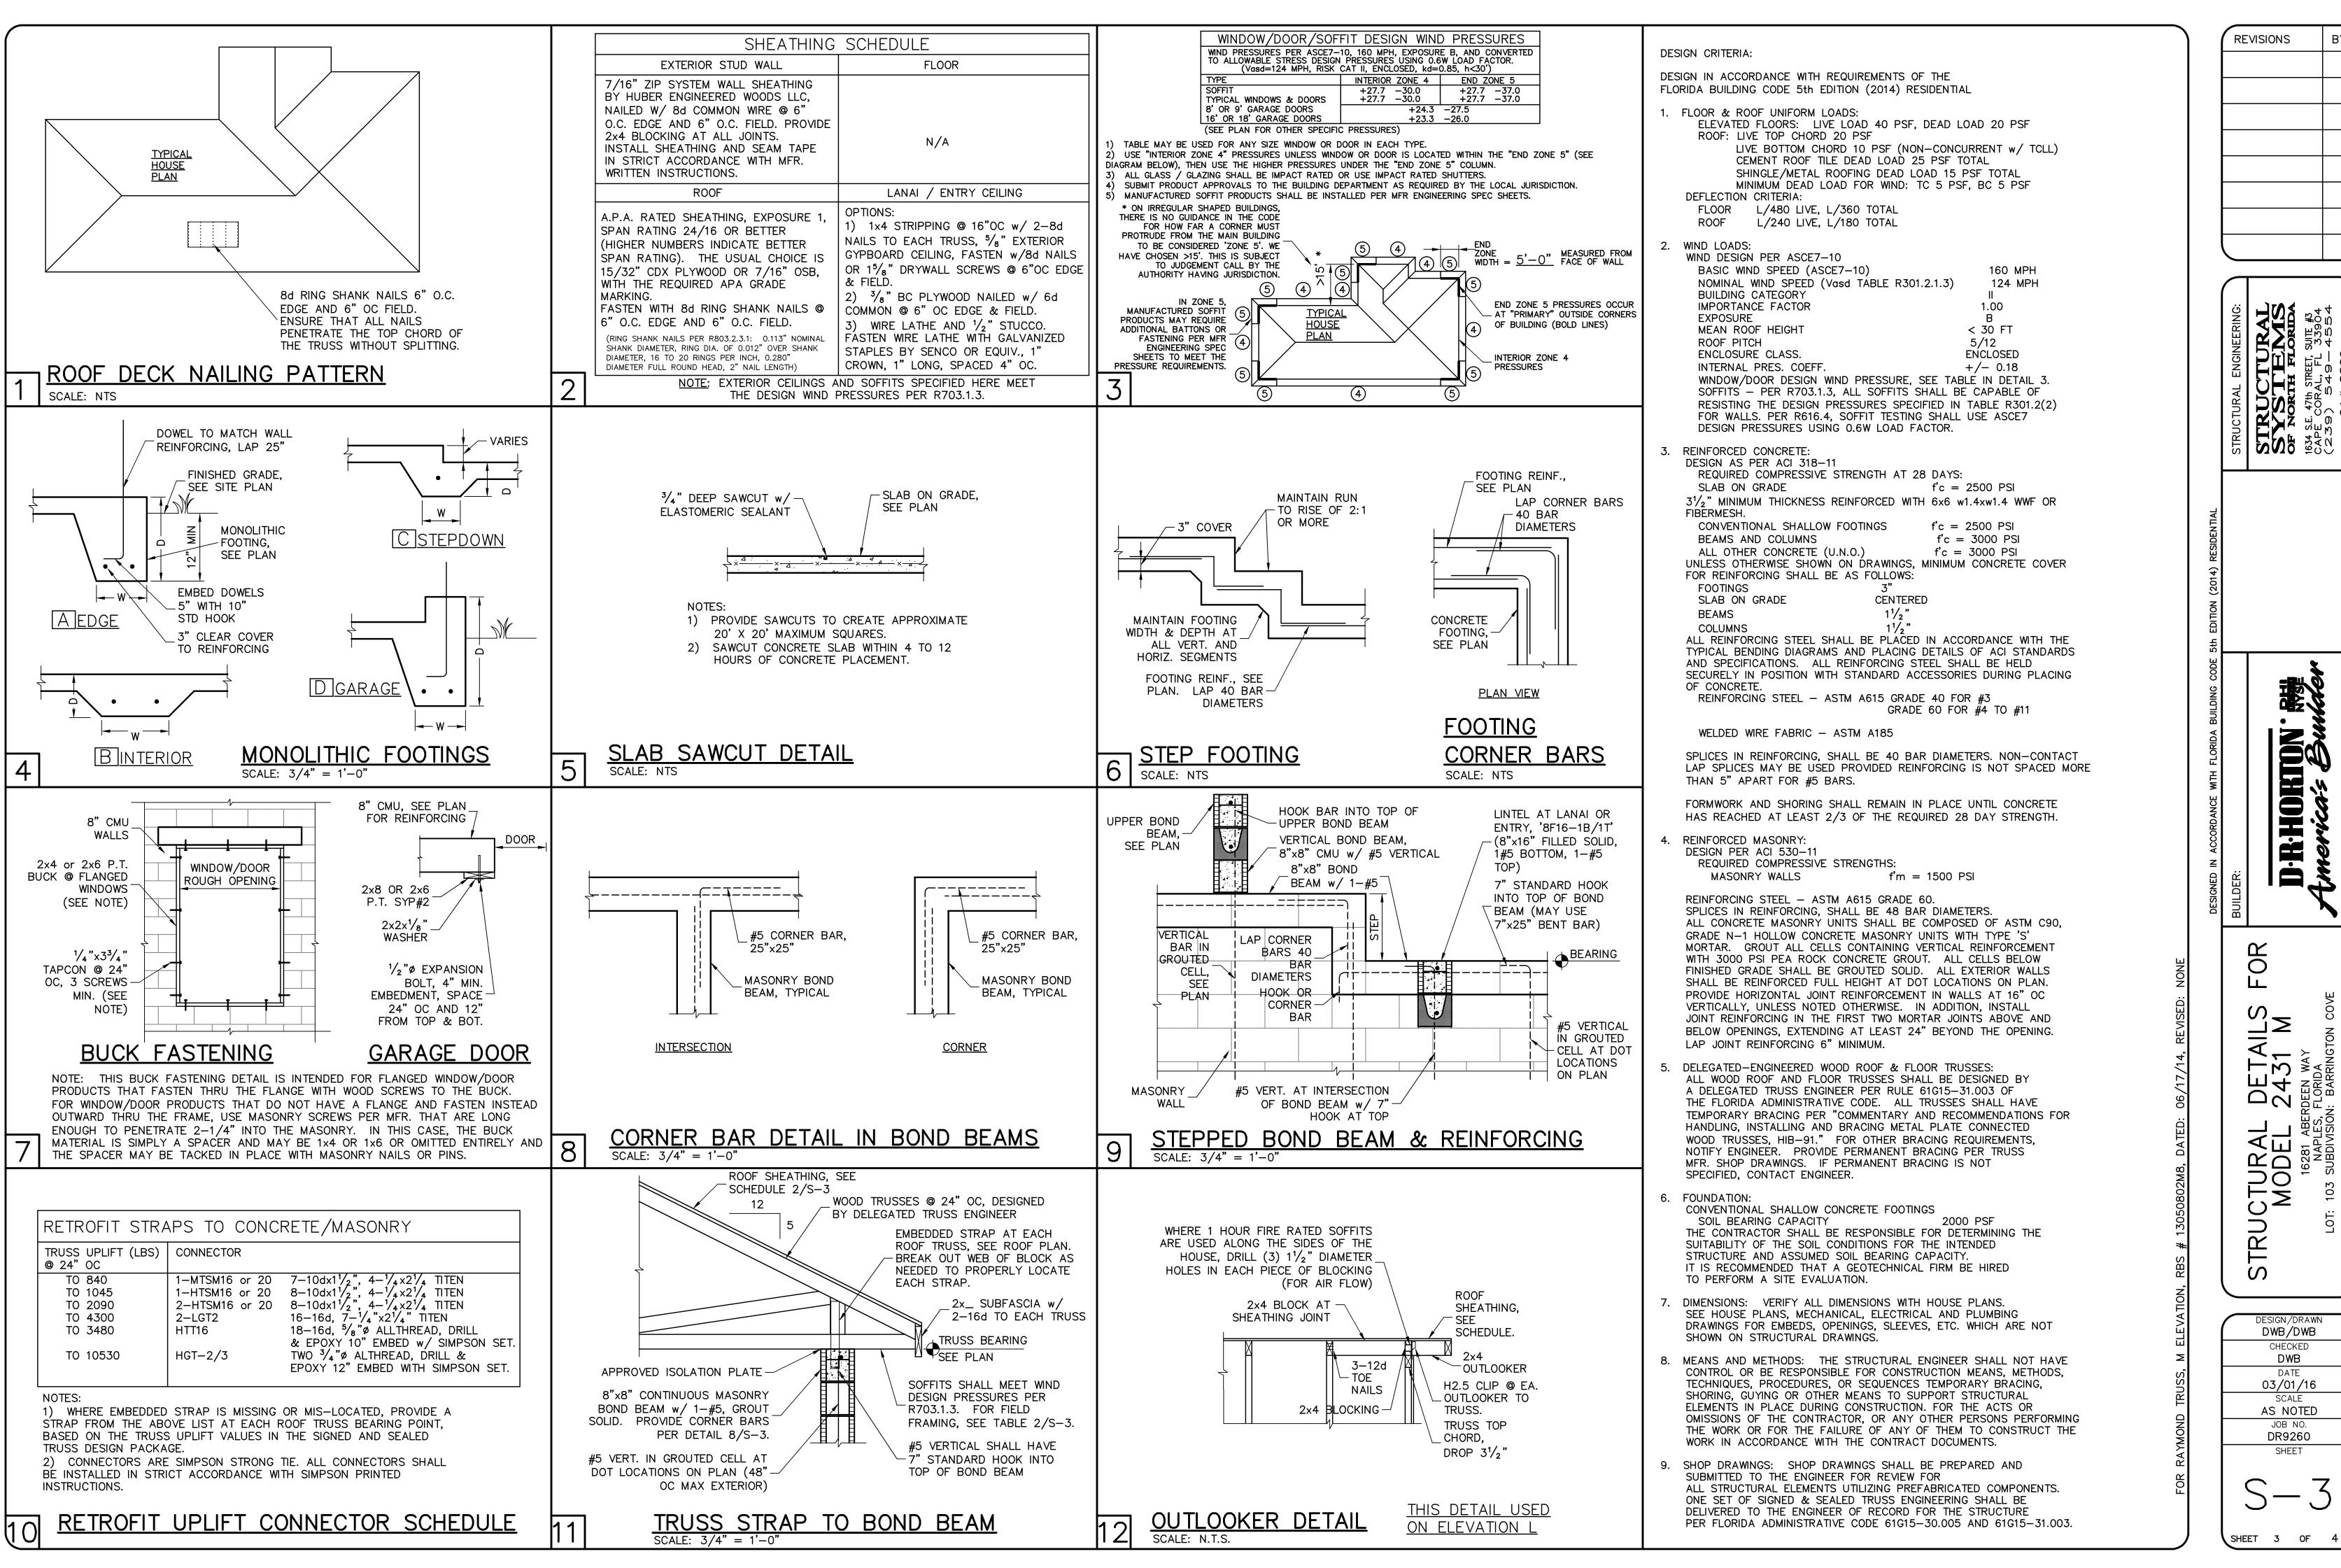

DESIGN/DRAWN

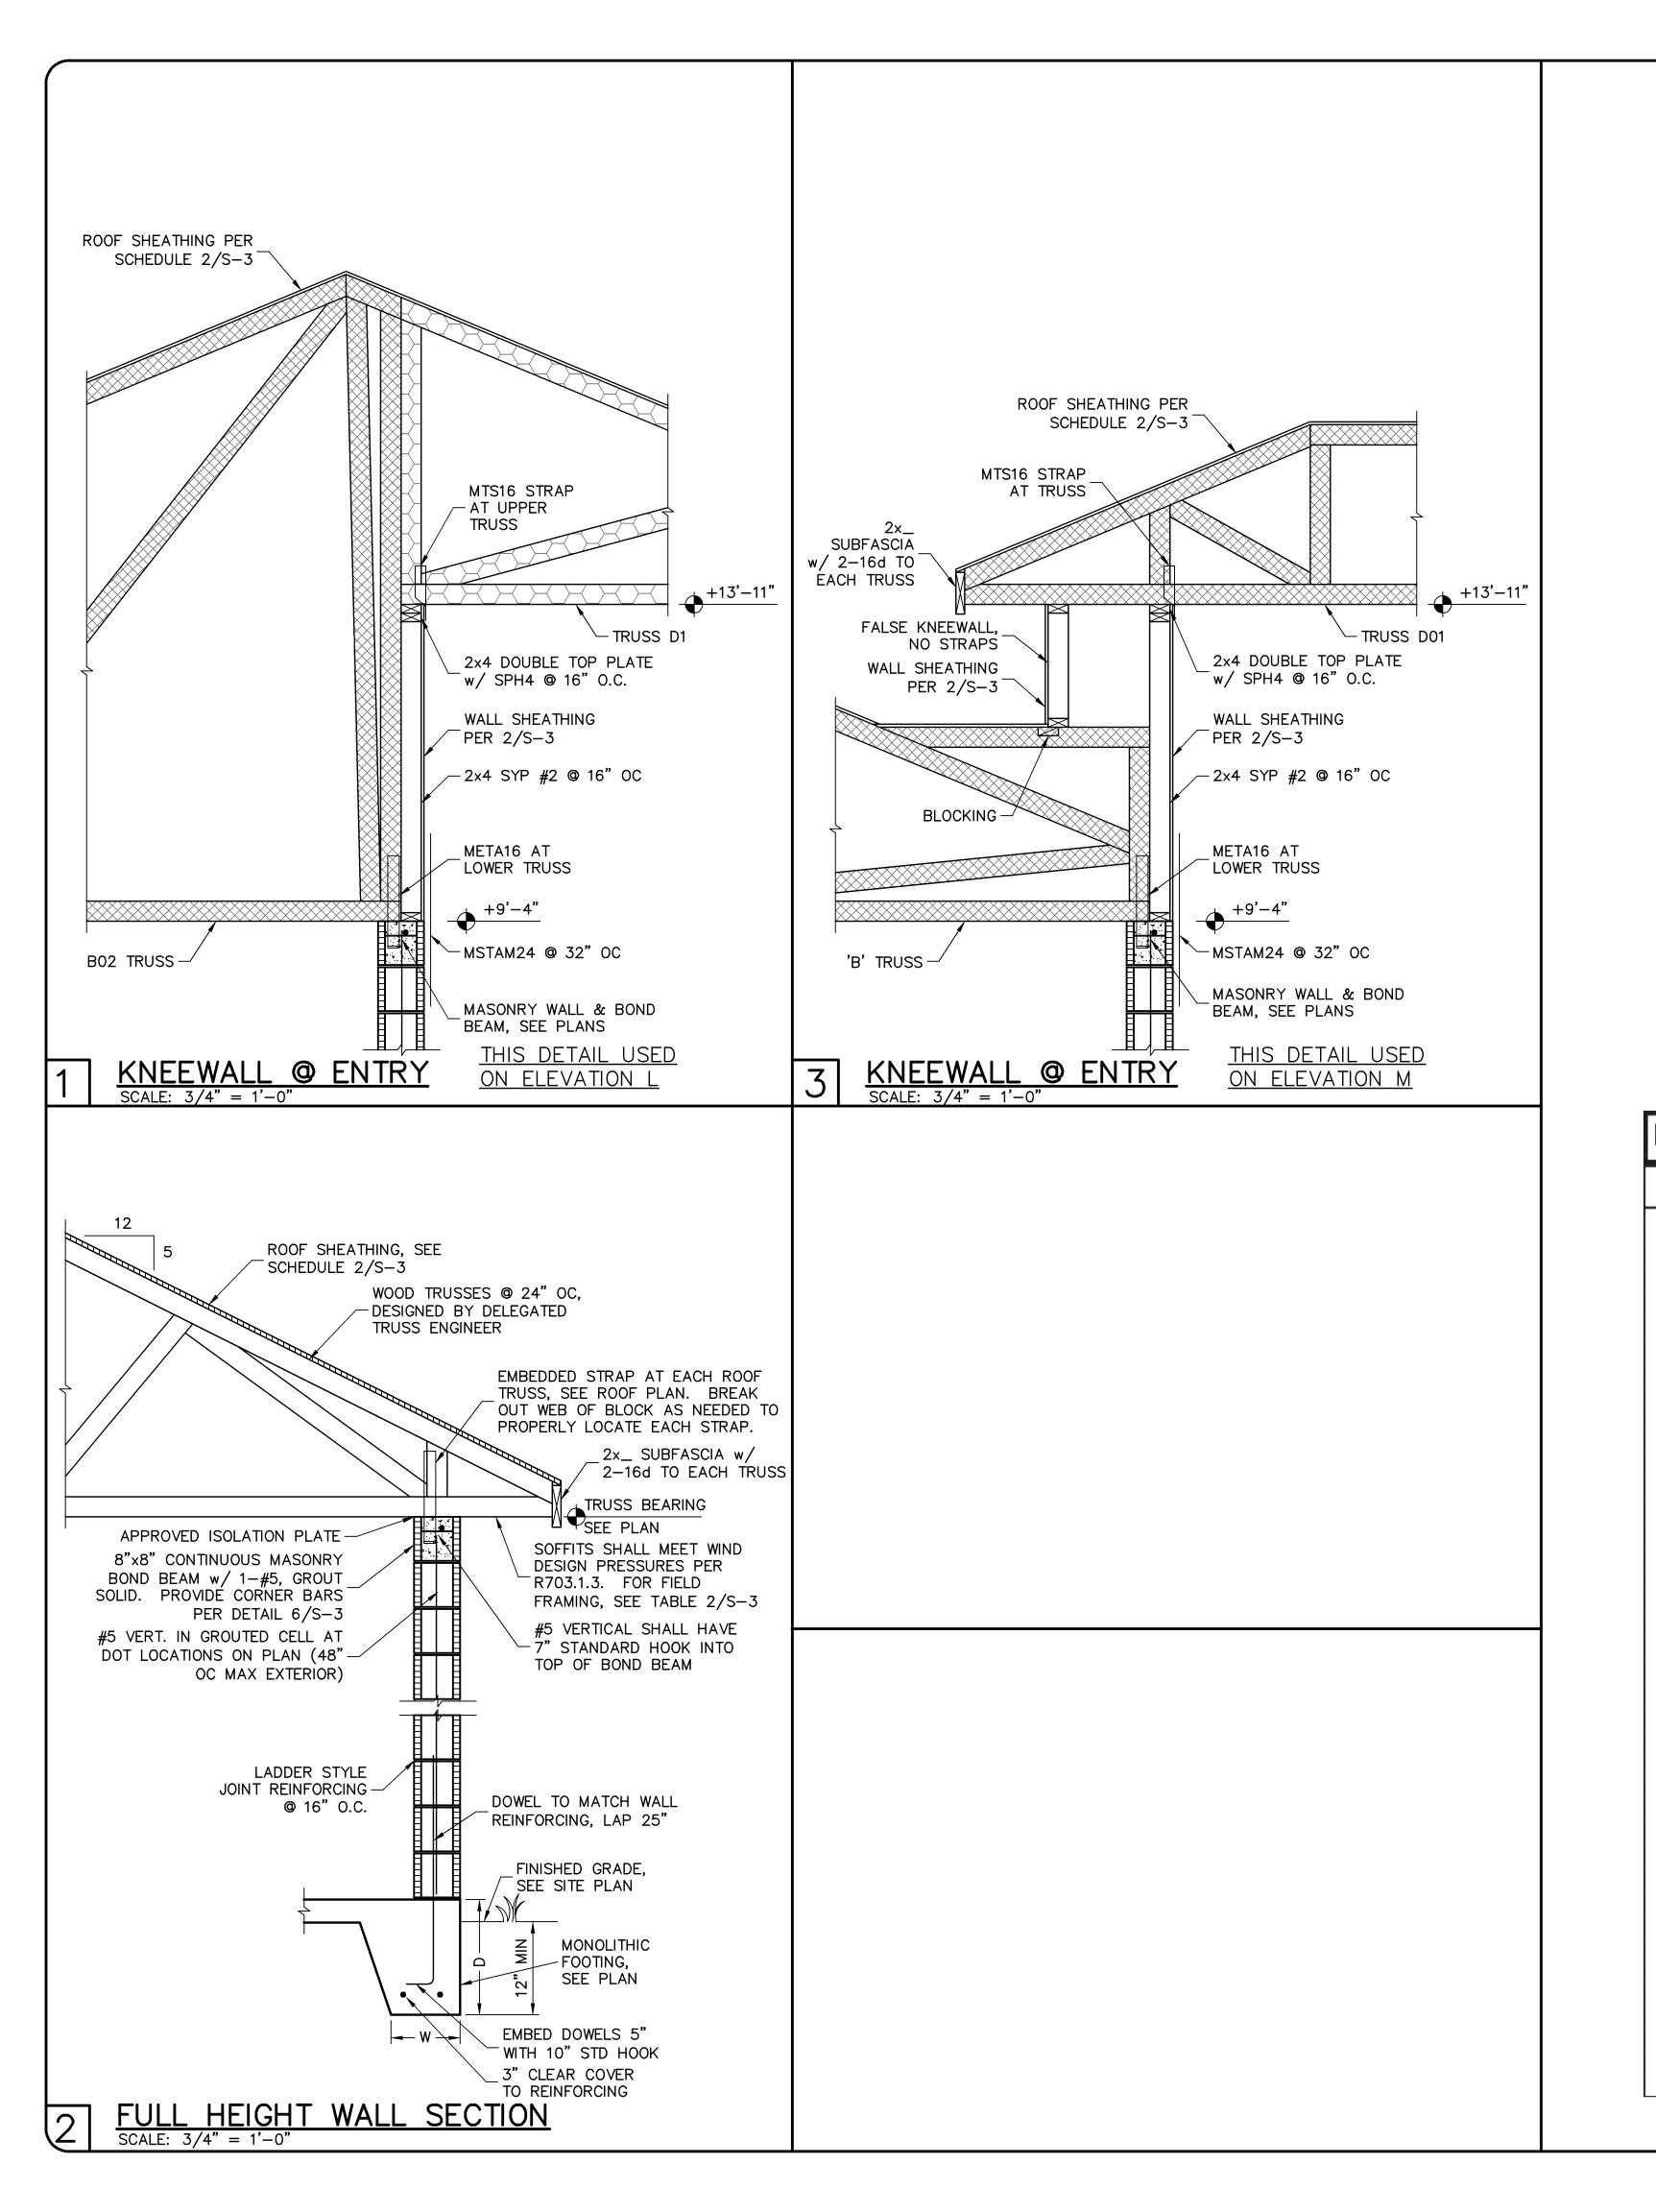

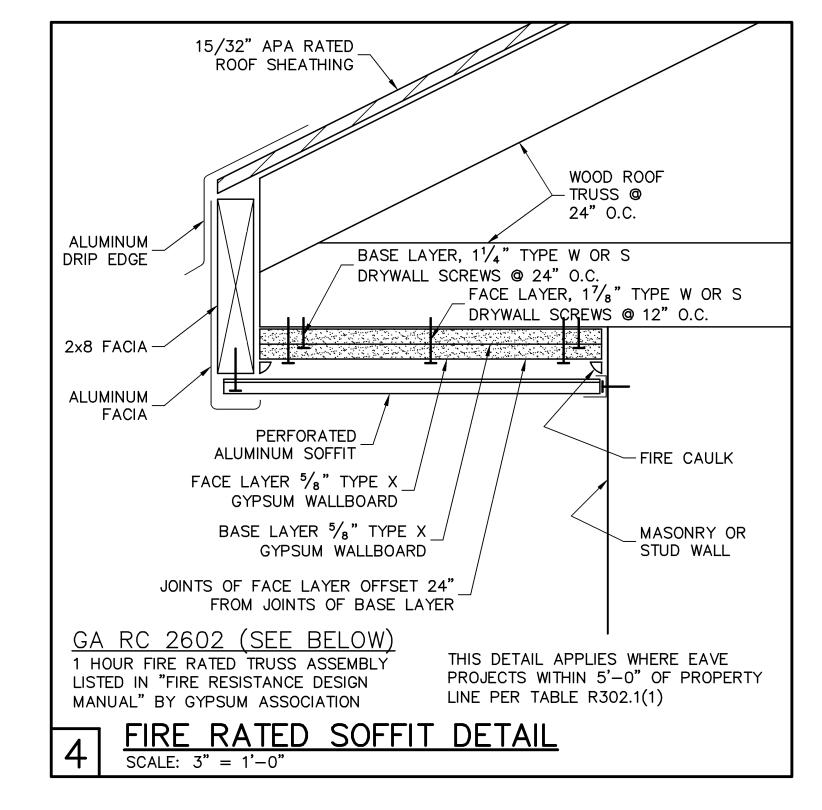

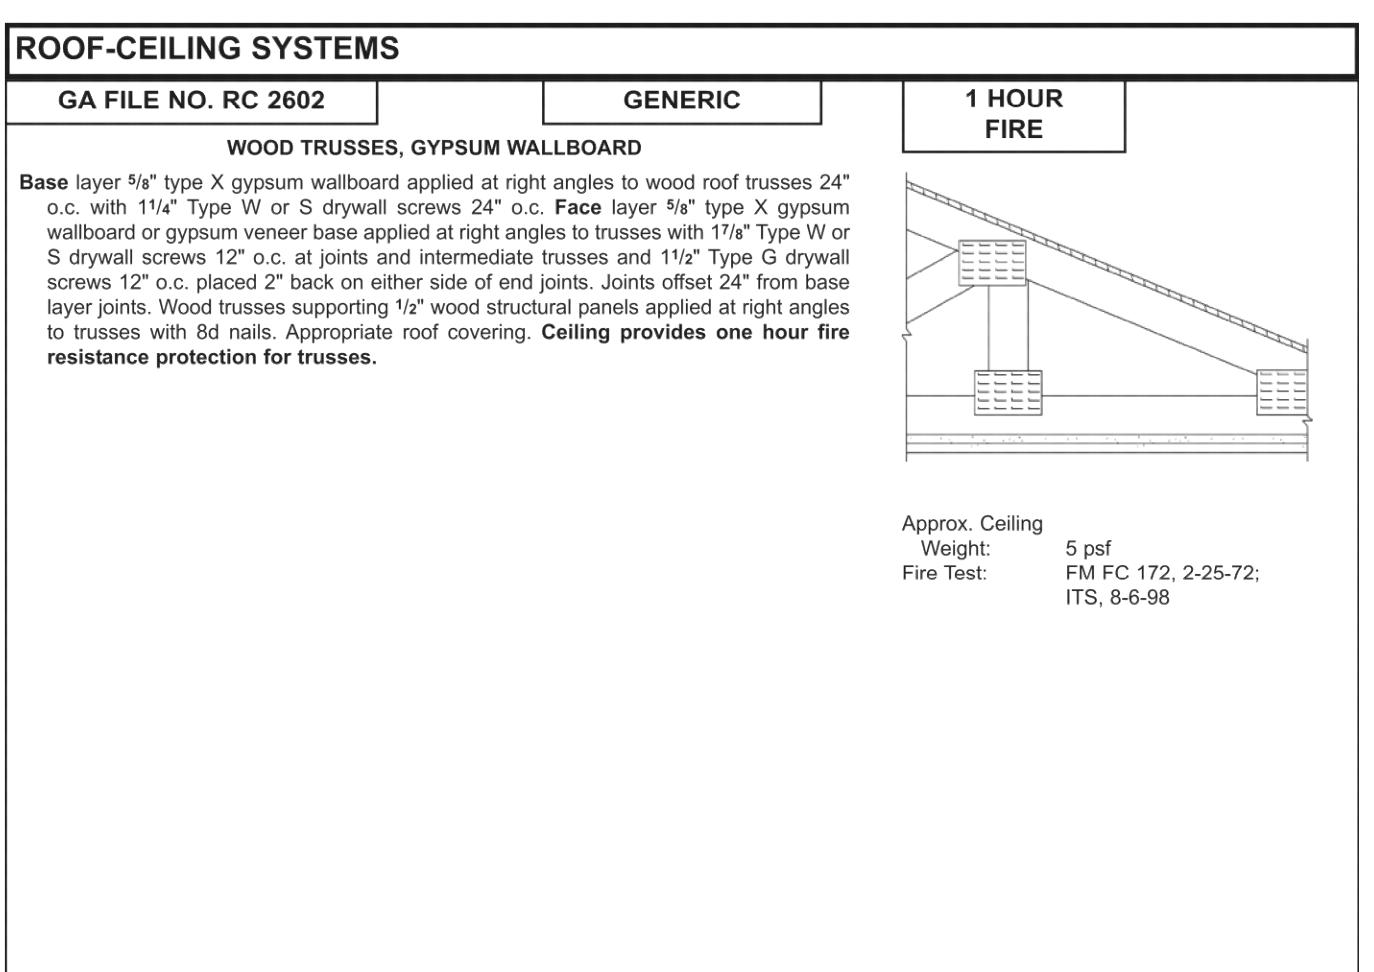

D-R-H OR AILS 1 M STRU

REVISIONS

DESIGN/DRAWN
DWB/DWB
CHECKED
DWB
DATE
03/01/16
SCALE
AS NOTED
JOB NO.
DR9260
SHEET

S-4
SHEET 4 OF 4