



JOB No.	MASTER
DATE DRAWN	10/31/2016
DATE PRINTED	10/31/2016
·	

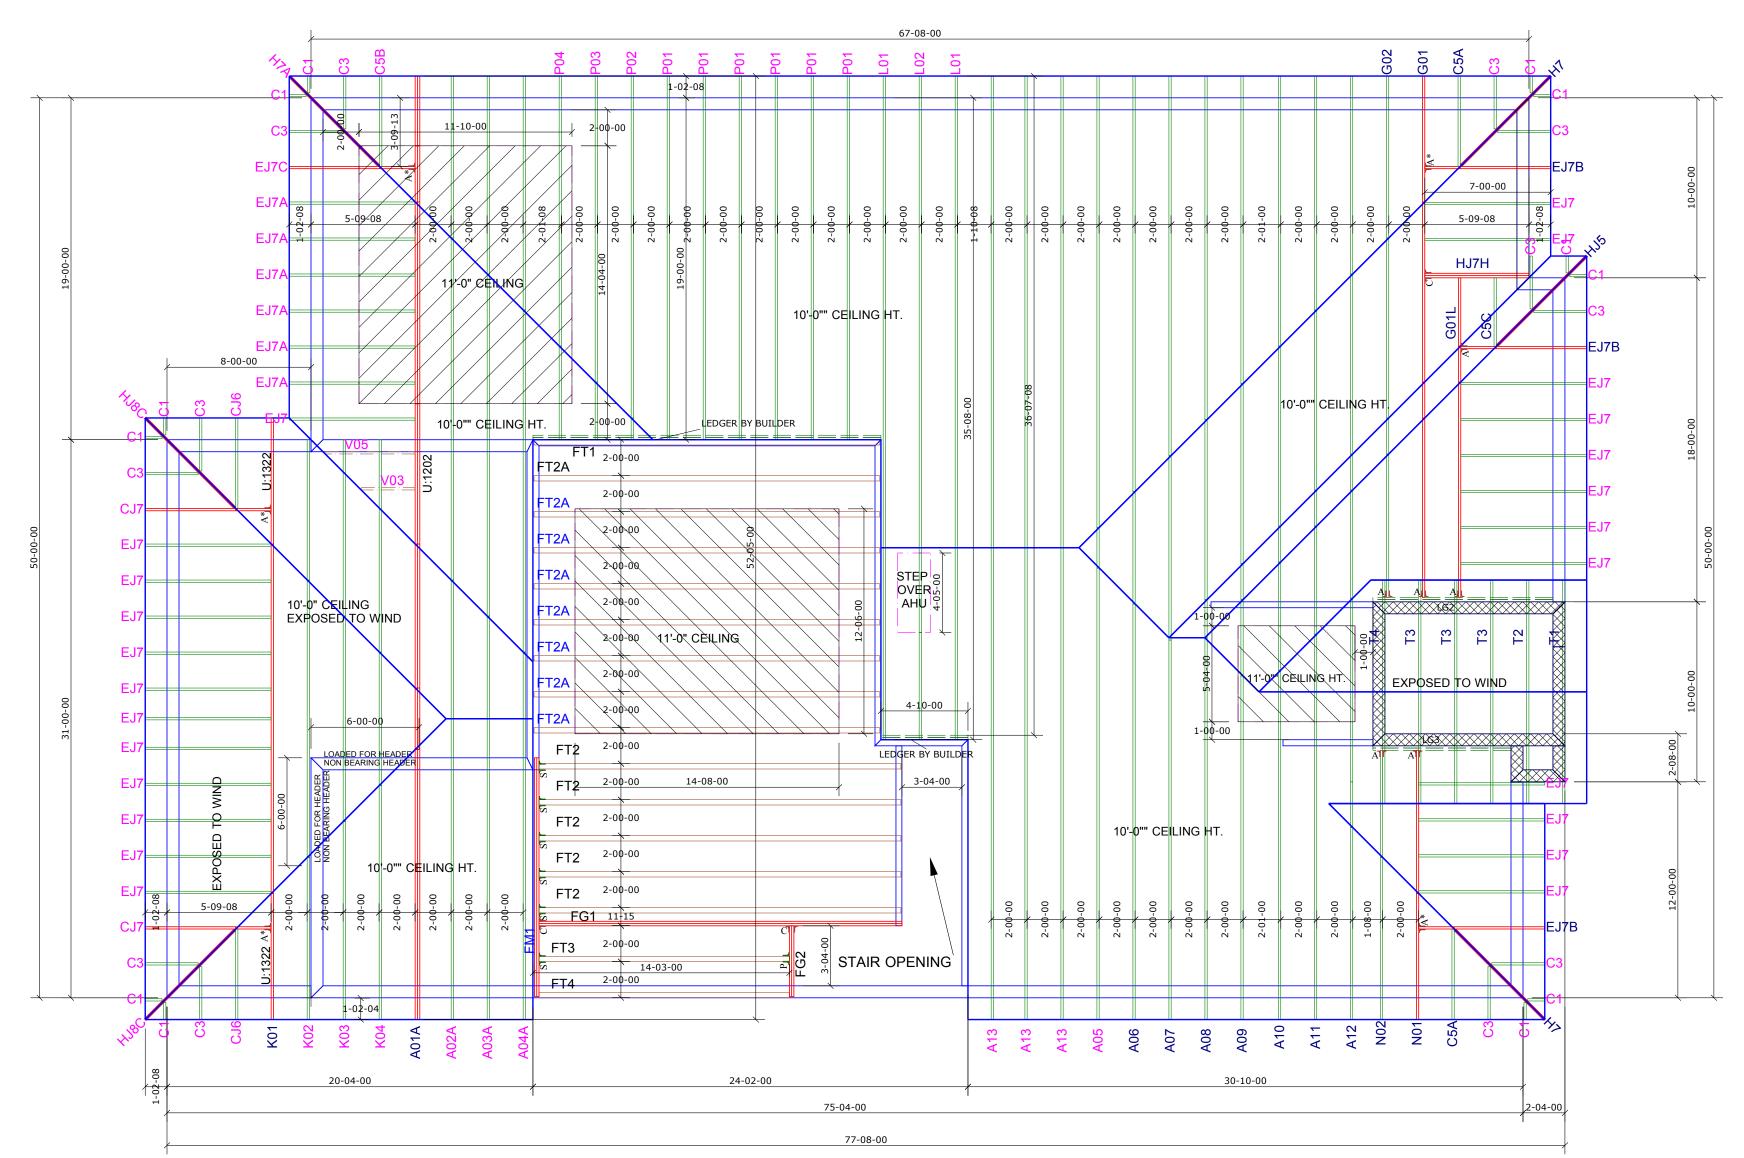

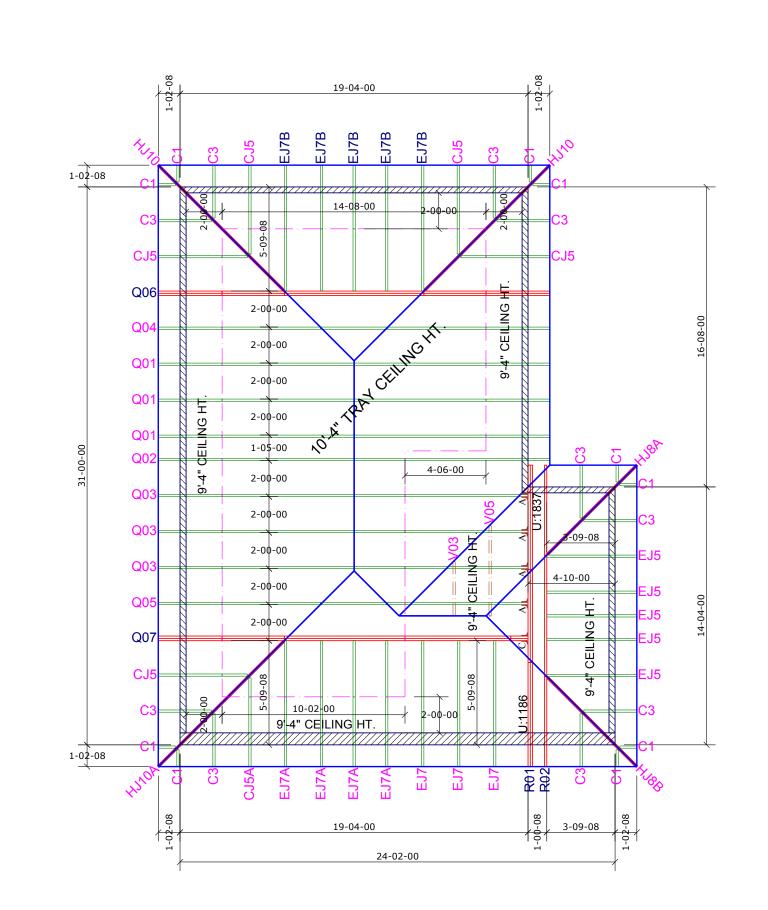

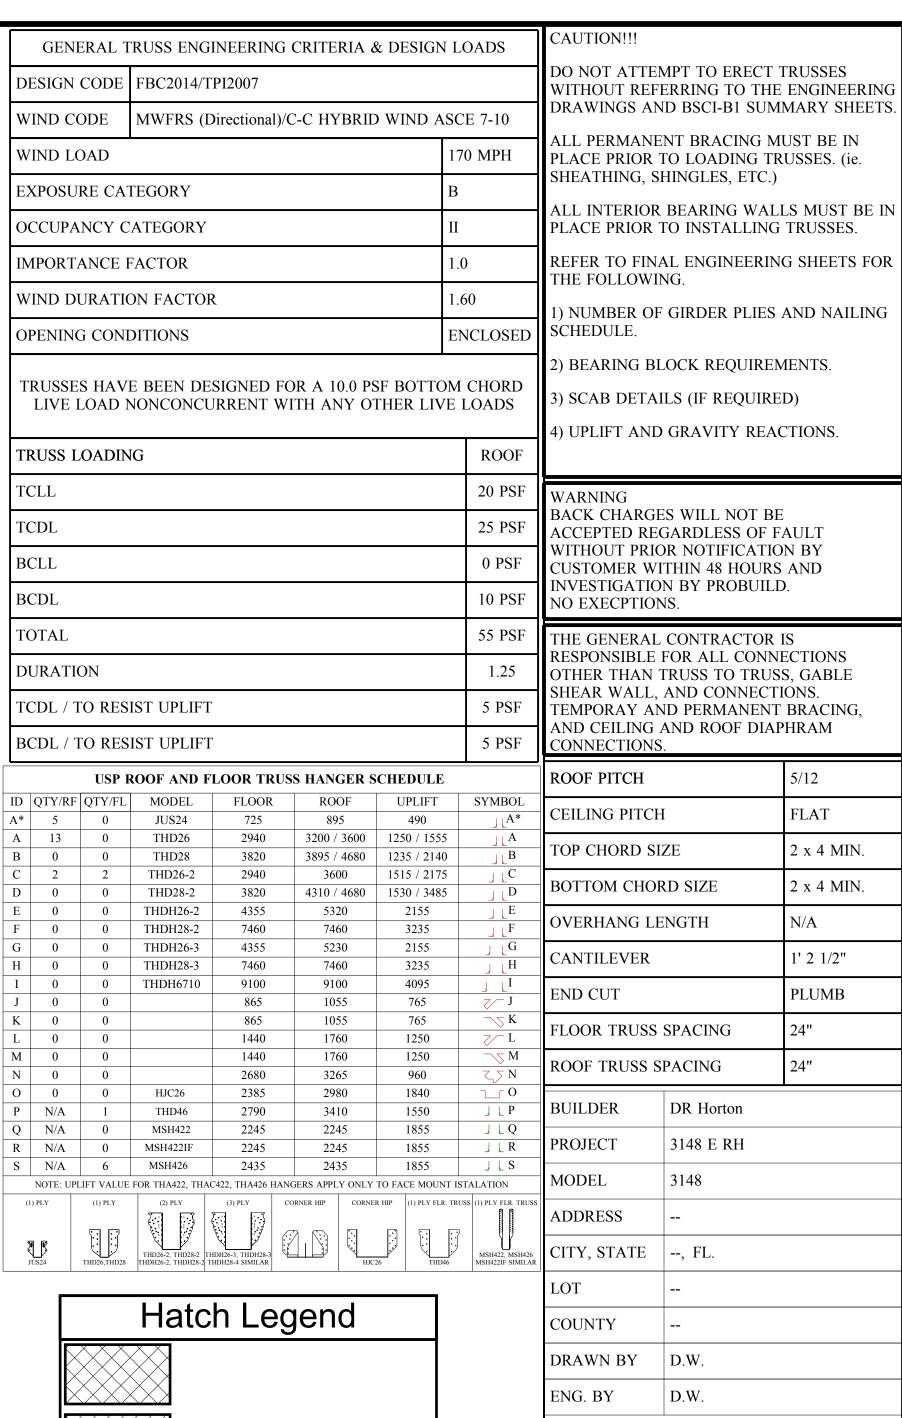

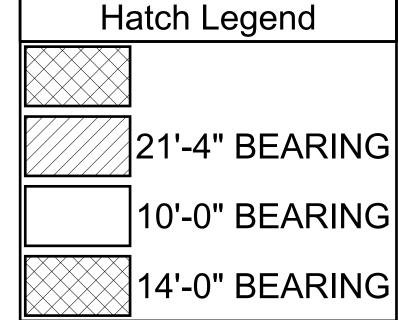

TILE ROOF COVERING

IMPORTANT

REVISIONS

NOTES

DATE


This Drawing Must Be Approved And Returned Before Fabrication Will Begin. For Your Protection Check All Dimensions And Conditions Prior To Approval Of Plan. SIGNATURE BELOW INDICATES ALL NOTES


AND DIMENSIONS HAVE BEEN ACCEPTED.



6850 Taylor Road Punta Gorda, Fl. 33950 Phone: 941-575-2250 / Fax:941-575-0319



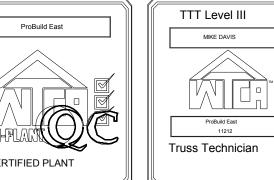

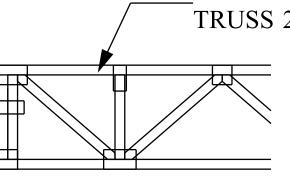

_24" DEEP FLOOR TRUSS 24" O.C.

1) ALL DIMENSIONS ARE FEET-INCHES-SIXTEENTHS.


2X8 SUBFASCIA


2) DO NOT CUT OR ALTER TRUSSES IN ANY WAY.


CANTILEVER


3) ALL REACTIONS ARE UNDER 5000 LBS. UNLESS NOTE OTHERWISE. ALL UPLIFTS ARE UNDER 1000 LBS. UNLESS NOTED OTHERWISE.

) FRAMING REQUIRED BELOW TRUSSES TO GET DESIRED CEILING CONDITIONS. 6) ONLY TRUSS TO TRUSS CONNECTIONS SUPPLIED W/ TRUSS PACKAGE.

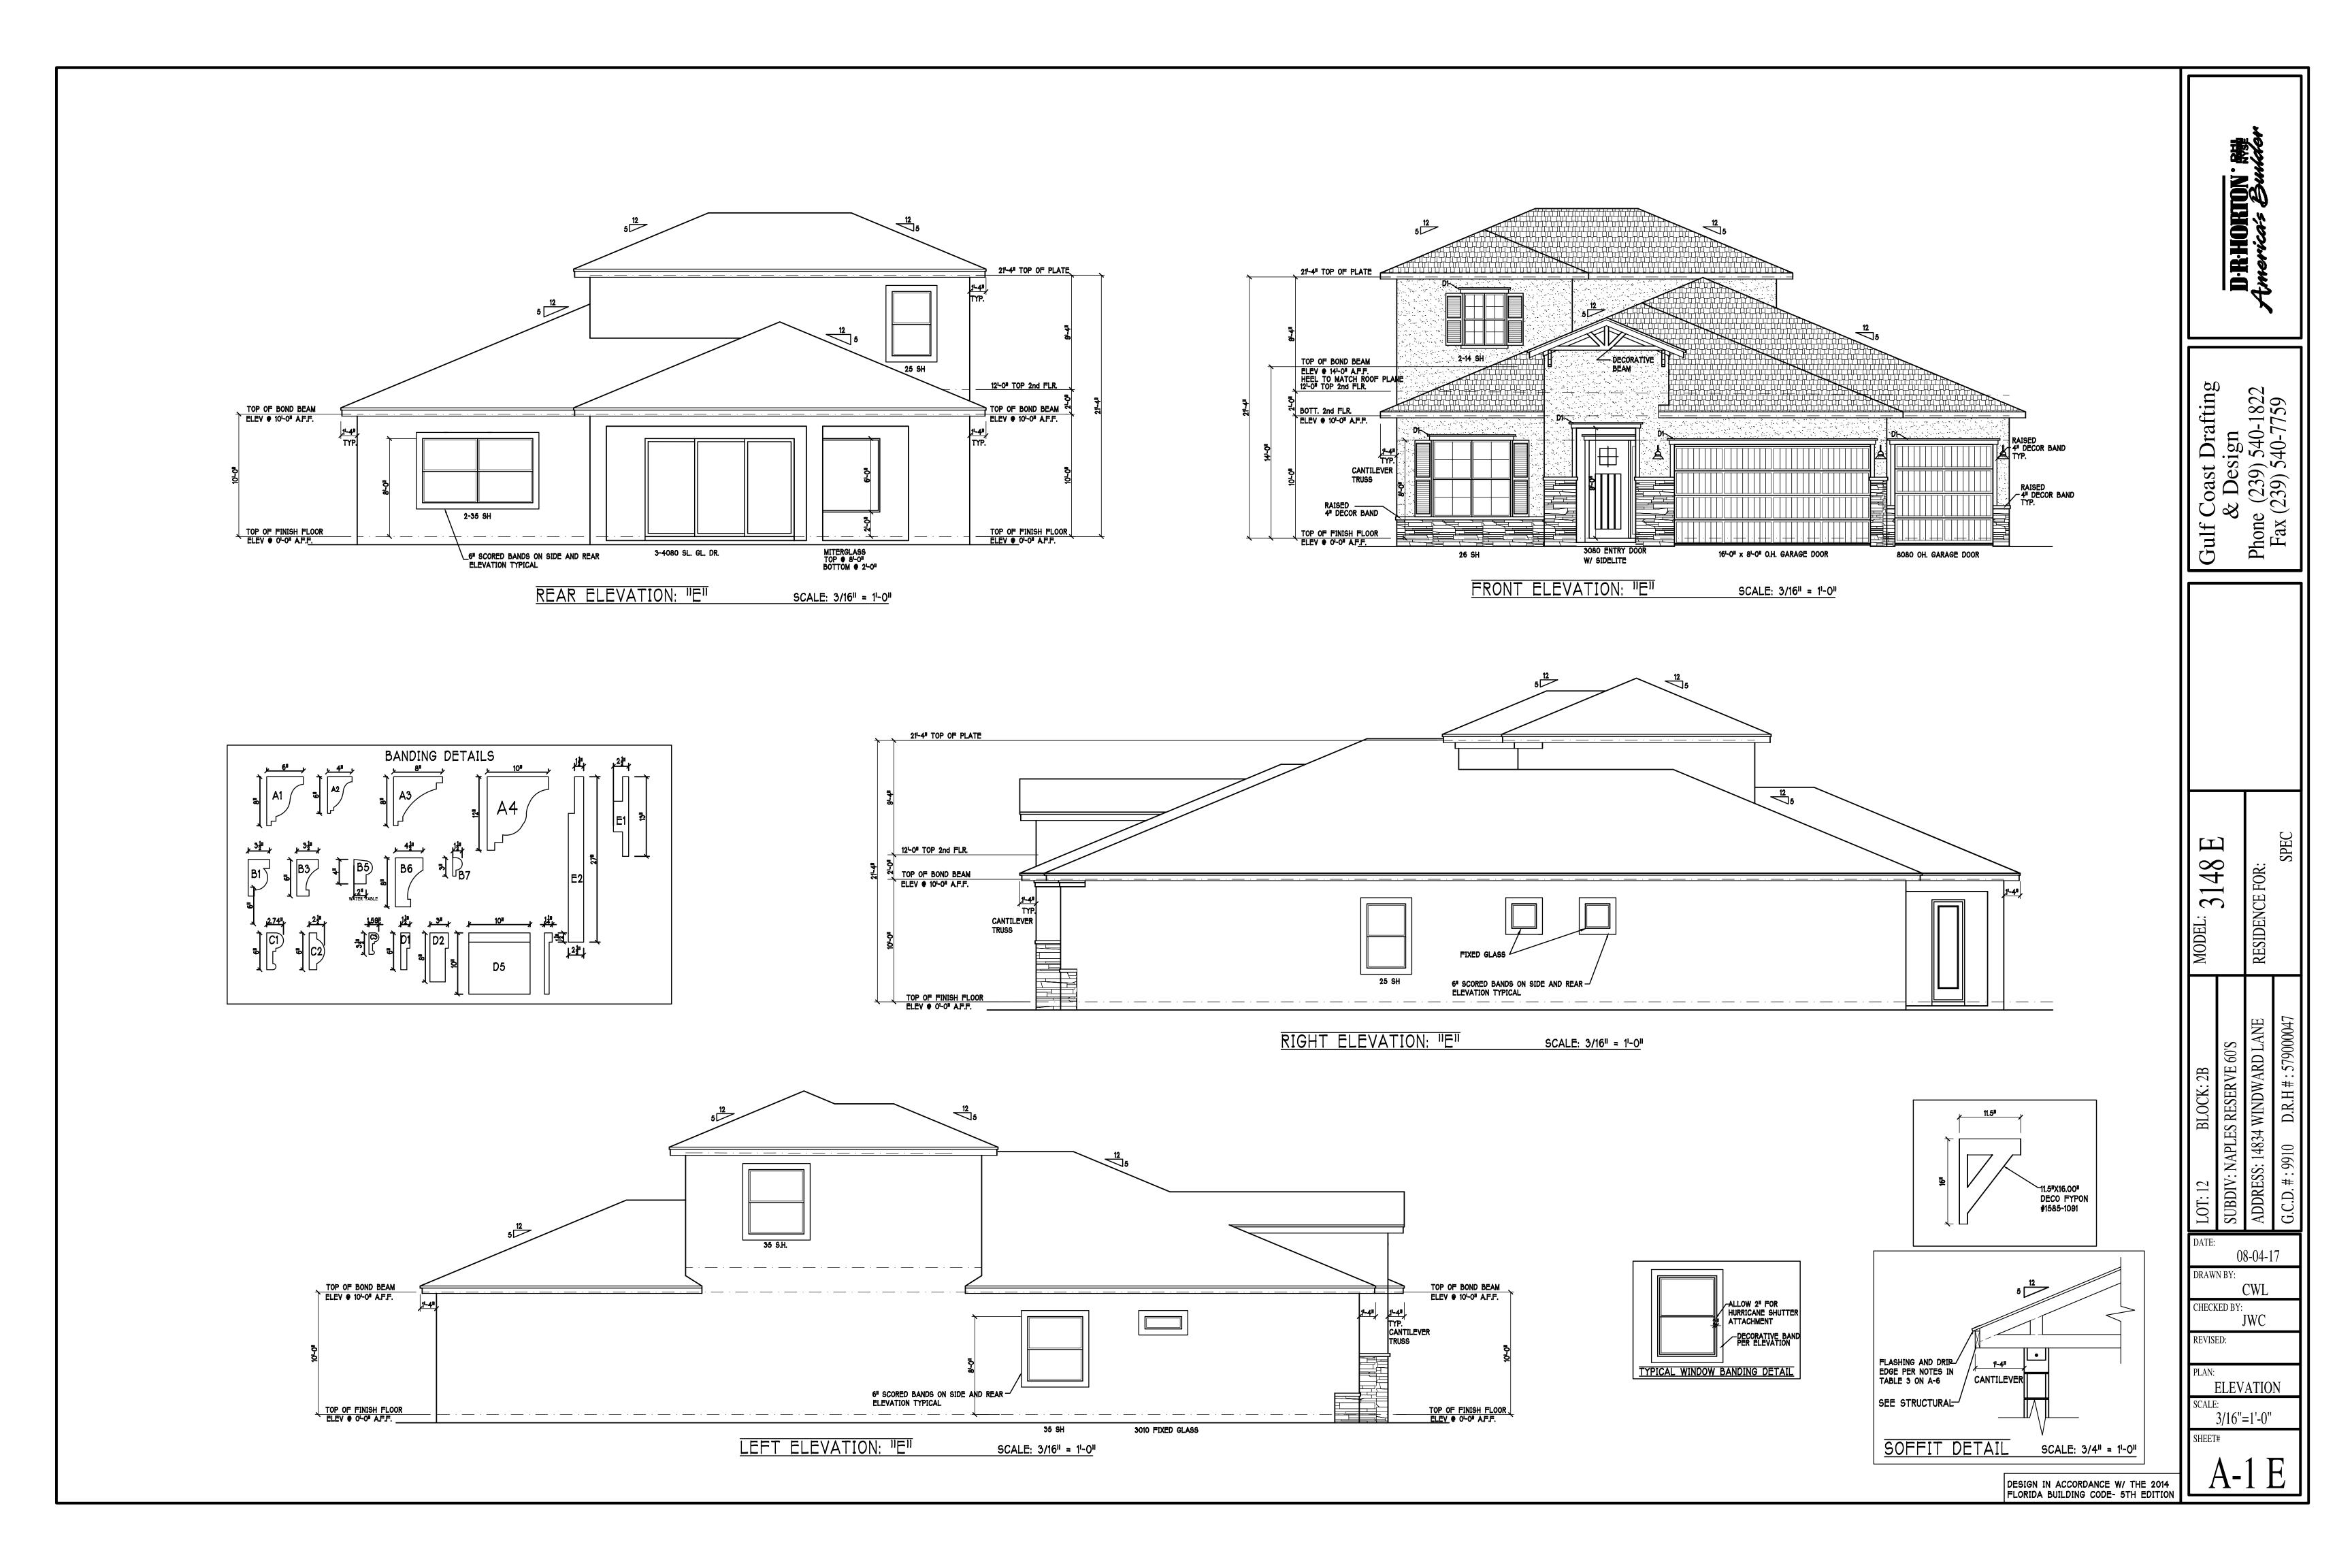

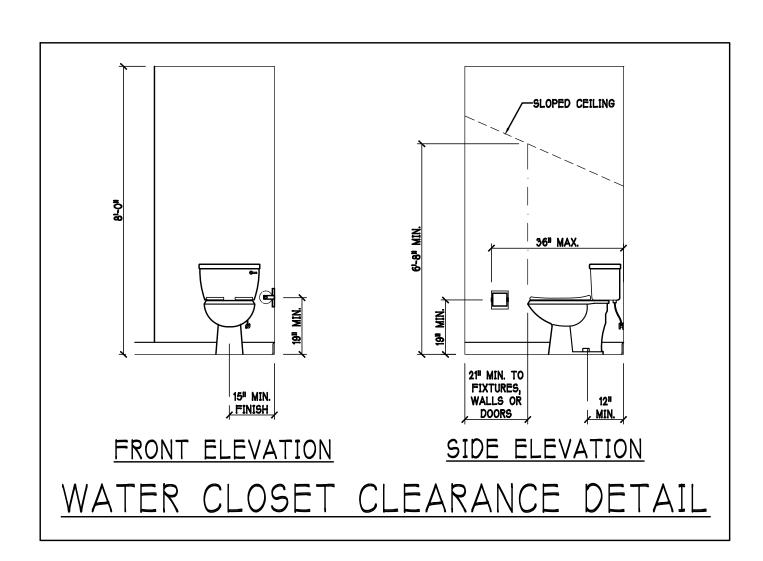

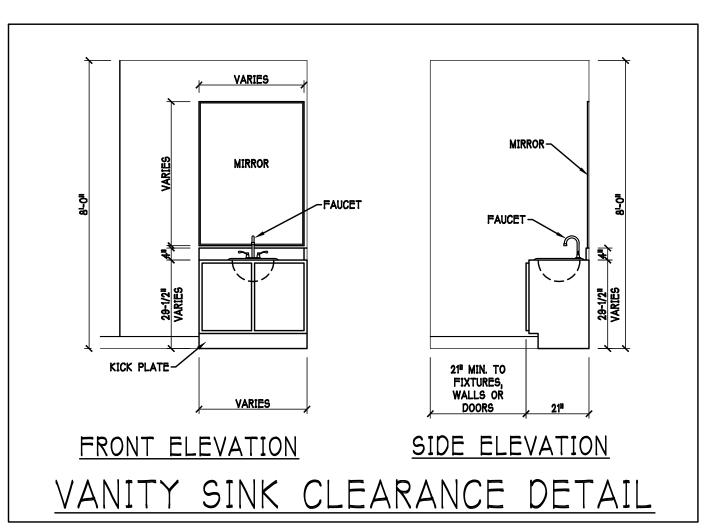

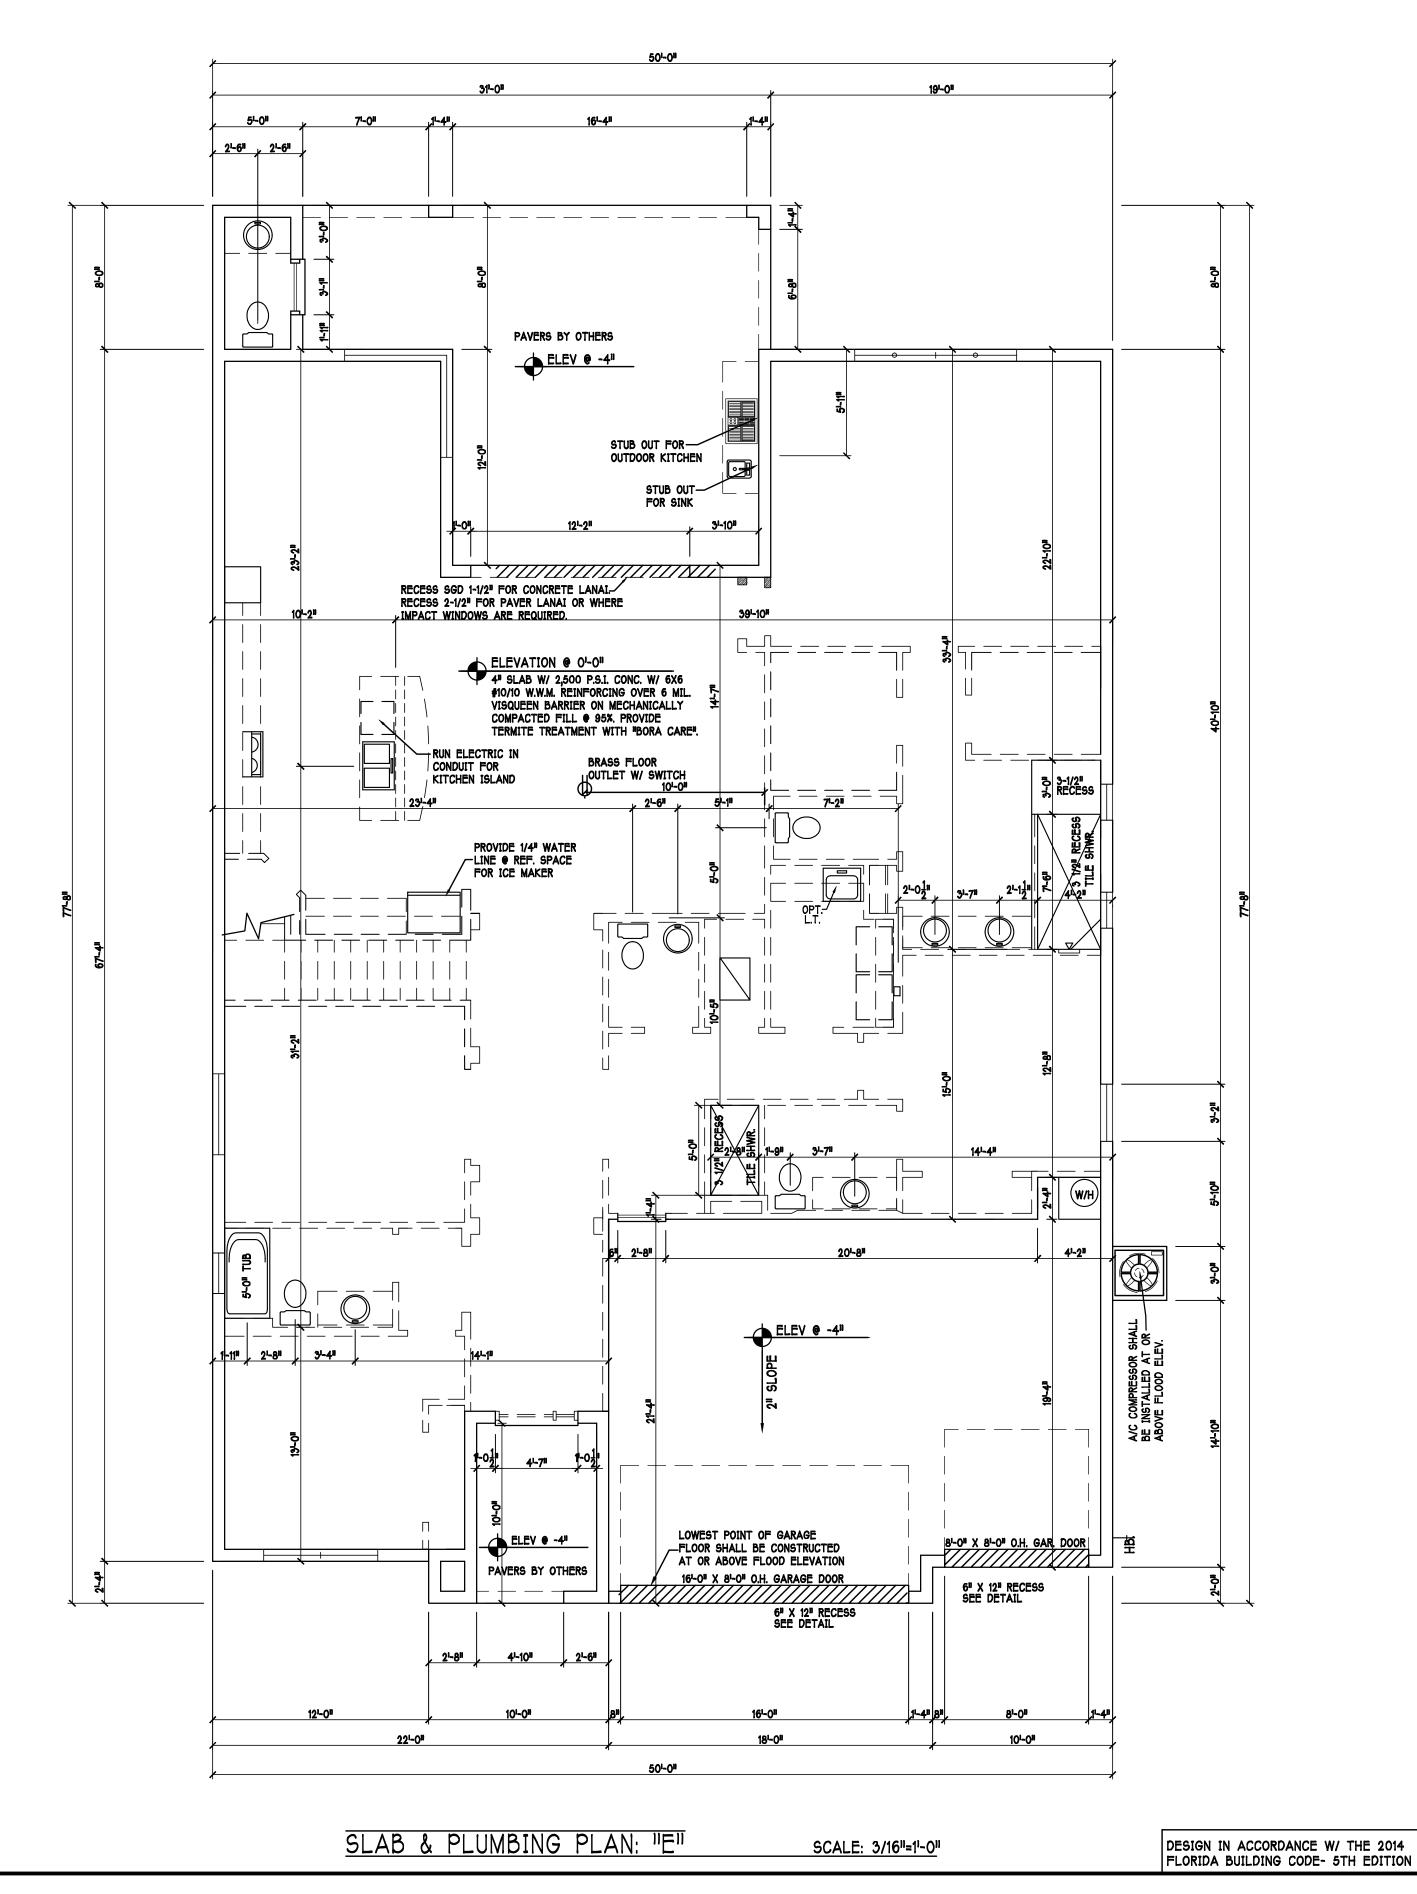

D.R.HORTON : 器 America's Suuder

Gulf Coast Drafting & Design
Phone (239) 540-1822
Fax (239) 540-7759

SUBDIV: NAPLES RESERVE 60'S


SUBDIV: NAPLES RESERVE 60'S


ADDRESS: 14834 WINDWARD LANE

G.C.D. #: 9910 D.R.H #: 579000047


SPEC

3/16"=1'-0"

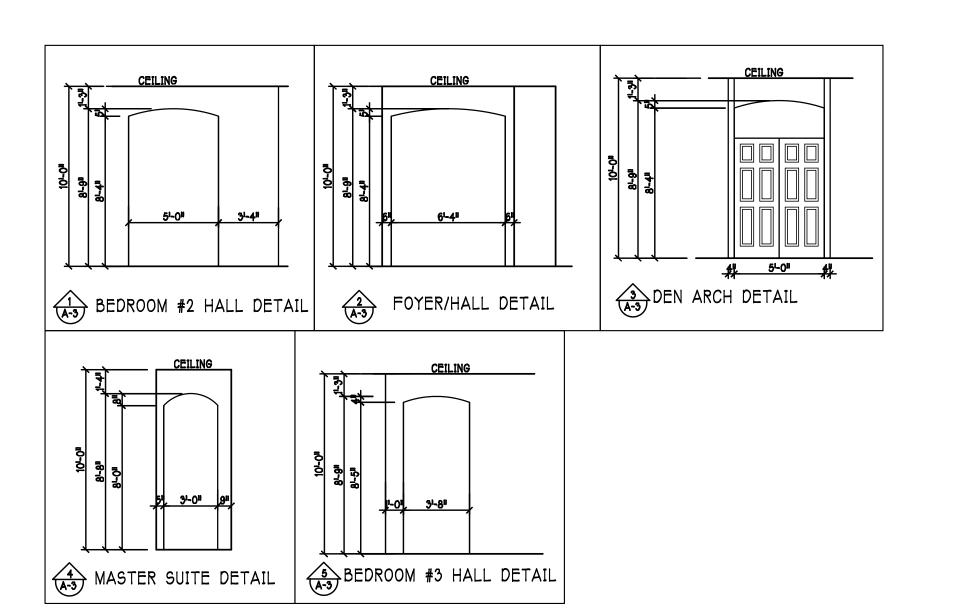

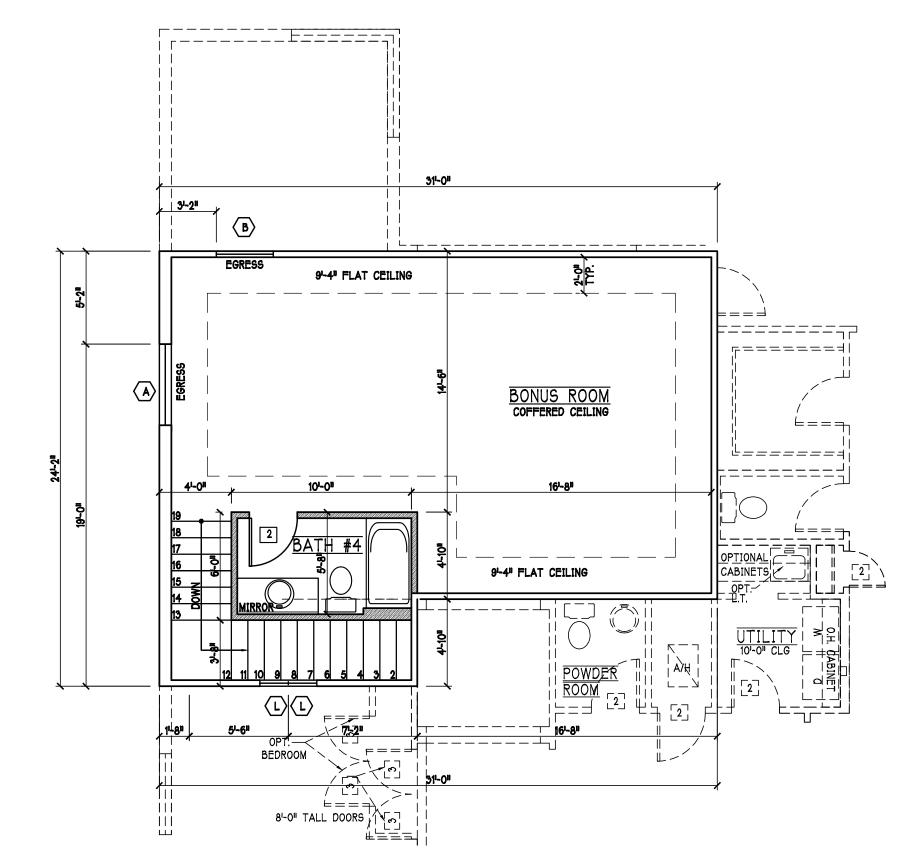



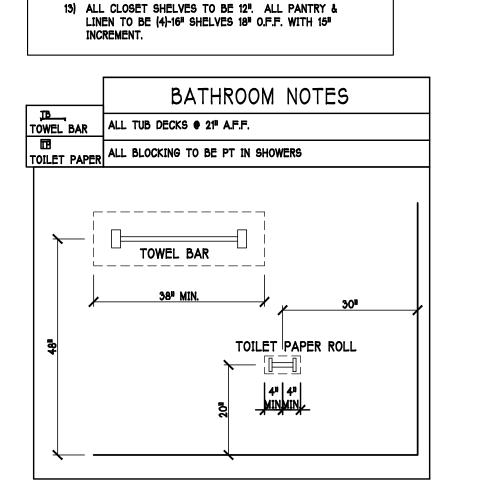

PLAN NOTES

1) VERIFY ALL ROUGH OPENING DIMENSIONS FOR ALL WINDOWS AND DOORS

2) PROVIDE SAFETY GLAZING WITHIN 24" FROM EXIT PER FLORIDA BUILDING CODE R 308.3.1.

PROVIDE SAFETY GLAZING AT BATH / SHOWER . PER FLORIDA BUILDING CODE R 308.3.1.

4) NON BEARING INTERIOR FRAME WALLS SHALL BE

5) PROVIDE DEAD WOOD IN ATTIC FOR OVERHEAD

6) KITCHEN KNEE WALL TO BE FRAMED W/ TOP ●
41 1/2" A.F.F. W/ RAISED BAR TOP

7) INSTALL SMOOTH WALLS IN KITCHEN AND ALL

8) WHERE DRYWALL CEILING IS APPLIED TO TRUSSES AT 24" O.C. USE 5/8" DRYWALL OR 1/2" SAG

9) THE GARAGE SHALL BE SEPARATED FROM THE

RESIDENCE & ATTIC BY NOT LESS THEN 1/2" GYPSUM BOARD APPLIED TO THE GARAGE SIDE. GARAGES

BENEATH HABITABLE ROOMS SHALL BE SEPARATED WITH NOT LESS THAN 5/8" TYPE "X" GYPSUM BOARD OR EQUIVALENT. WHERE THE SEPARATION IS A FLOOR - CEILING ASSEMBLY THE STRUCTURE SUPPORTING THE SEPARATION SHALL ALSO BE PROTECTED BY NOT LESS THAN 1/2" GYPSUM BOARD

10) INSTALL 1 3/8" THICK SOLID WOOD DOOR BETWEEN

11) ALL WINDOWS INSTALL 72" ABOVE GRADE MUST

PREVENTION DEVICE

COMPLY WITH R 312.2.1 MIN 24" SILL HEIGHT OR

PROVIDED WITH AN APPROVED WINDOW FALL

12) STUB OUT FOR GAS ● OUTDOOR KITCHEN, RANGE, WATER HEATER, AND DRYER. VERIFY WITH

PERMIT IS REQUIRED FOR GAS PIPING.

CONTRACTOR AND SUBDIV. SPECS. A SEPARATE

LIVING AND GARAGE PER FLORIDA BUILDING CODE R302.5.1. DOOR SHALL BE SELF CLOSING PER R302.5.1

GARAGE DOOR HARDWARE

RESISTANT PER SEC. 702.3.5


BATHROOM AREAS

FRAMED W/ WOOD OR METAL STUDS. SPACING SHALL NOT EXCEED 24" O.C. (NON BEARING WALLS ONLY)

MARK	SIZE CODE	PRODUCT DESCRIPTION	WIDTH	HEIGHT	COMMENTS	QTY
A	35 SH		54	63		2
B	25 SH		38	63		2
<u></u>	36 ^{ll} X 12 ^{ll} F.G.		36	12		1
回	24 SH		38	51	TEMPERED	1
E	3-4080	POCKET SL. GL. DOOR	144	96		1
F	21-011 X 21-011		24	24	FIXED GLASS	2
6	72" X 72"		72	72	MITERED GLASS	1
H	36" X 12"	TRANSOM	36	12	MITERED GLASS	1
1	2-35 SH		108	63		1
<u></u>	12" X 96" SIDE LITE		12	96		1
K	2-26 SH		74	76		1
	14 SH		19	51		2
SEE	NOTE 1					13


D R HORTON						
MARK	SIZE CODE	PRODUCT DESCRIPTION	WIDTH	HEIGHT	COMMENTS	QTY
\odot	OVERHEAD	GARAGE DOOR	192	96		1
2	OVERHEAD	GARAGE DOOR	96	96		1
3	3080 Entry Dr.	DISTINCTION	36	96		1
4	2880 ENTRY DR.	DISTINCTION	32	96		1
SEE I	NOTE 1					4

SQUARE FOOTAGE	
1ST FL LIVING AREA	2554
2ND FL LIVING AREA	594
TOTAL LIVING AREA	3148
GARAGE AREA	594
LANAI AREA	452
ENTRY AREA	67

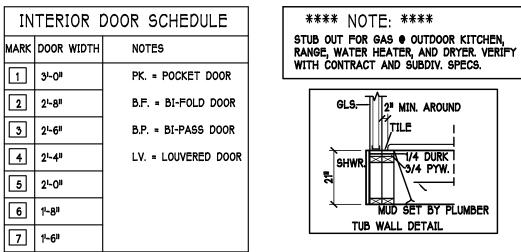

		DOOR HEADE	RS
۲	61-81 BIFOLD	HEADER HEIGHT	82" A.F.F.
	61-811 SWING	HEADER HEIGHT	82 1/2" A.F.F.
	81-011 SWING	HEADER HEIGHT	98 1/2" A.F.F.
	C	ABINET BACK	CING
	KITCHEN	UPPER TOP @ 84"	BASE TOP @35"

KITCHEN	UPPER TOP @ 84"	BASE TOP @35"
MASTER BATH	UPPER	BASE- TOP @35"
GUEST BATH	UPPER	BASE- TOP @31"
LAUNDRY RM.	UPPER TOP @84"	BASE

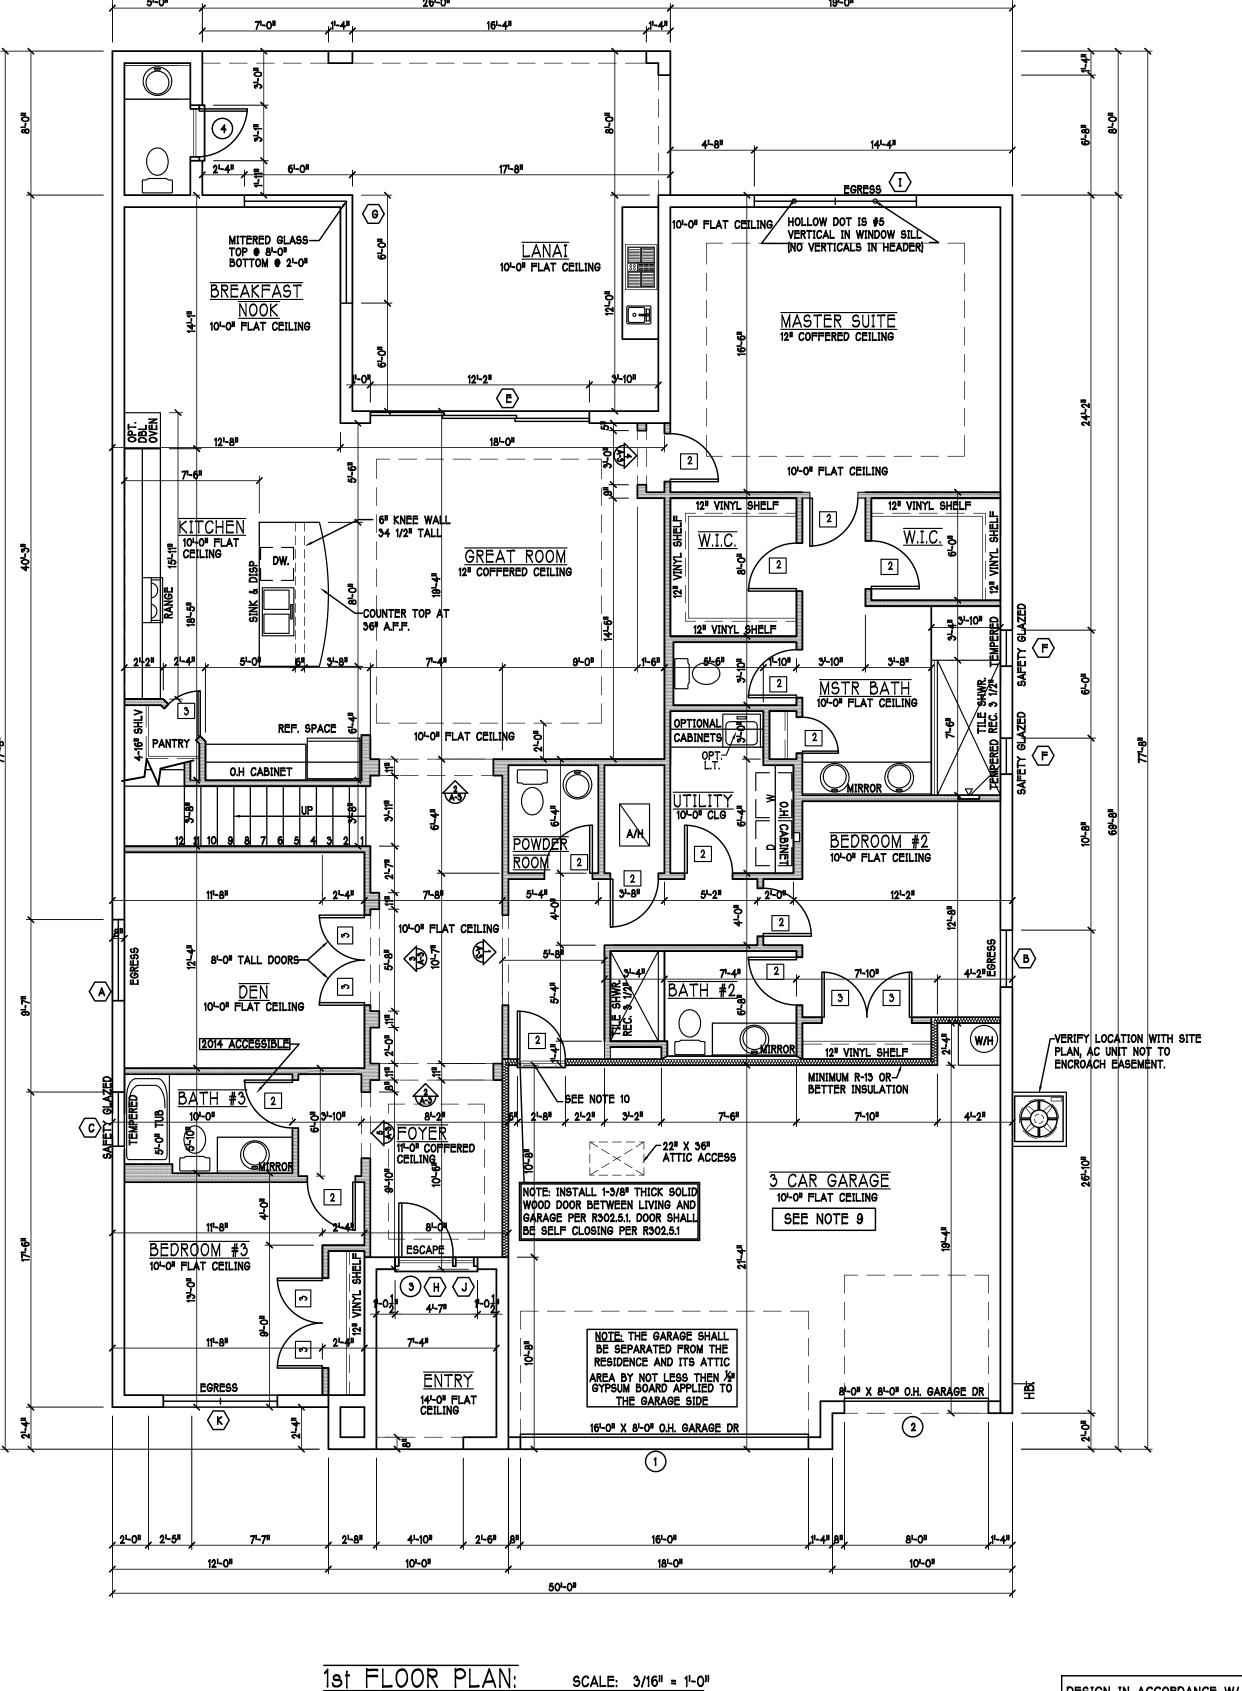

D-R-HORTON : Water State of the state of th

Gulf Coast Drafting & Design
Phone (239) 540-1822

LOT: 12 BLOCK: 2B

SUBDIV: NAPLES RESERVE 60'S

ADDRESS: 14834 WINDWARD LANE

RESIDENCE FOR:

RESIDENCE FOR:

CWL

FLOOR

CHECKED BY:

REVISED:

SCALE: 3/16" = 1'-0" SHEET#

DESIGN IN ACCORDANCE W/ THE 2014
FLORIDA BUILDING CODE- 5TH EDITION



Gulf Coast Drafting & Design Phone (239) 540-1822 Fax (239) 540-7759

MODEL: 3148 F	J 0717	RESIDENCE FOR:	Specific
)T: 12 BLOCK: 2B	JBDIV: NAPLES RESERVE 60'S	ODRESS: 14834 WINDWARD LANE	7.0000001 # . \$70000047

LOT SUF ADJ G.C 08-04-17 DRAWN BY: CWL

CHECKED BY: REVISED:

CEILING PLAN

3/16" = 1'-0" DESIGN IN ACCORDANCE W/ THE 2014 FLORIDA BUILDING CODE- 5TH EDITION

1st FLOOR ROOF & CEILING PLAN: "E" SCALE: 3/16" = 1'-0"

10'-0" FLAT CEILING


DEN OF FLAT CEILING

101-011 FLAT CEILING

M. BATH

BEDROOM #2

GARAGE 10-0" FLAT CEILING

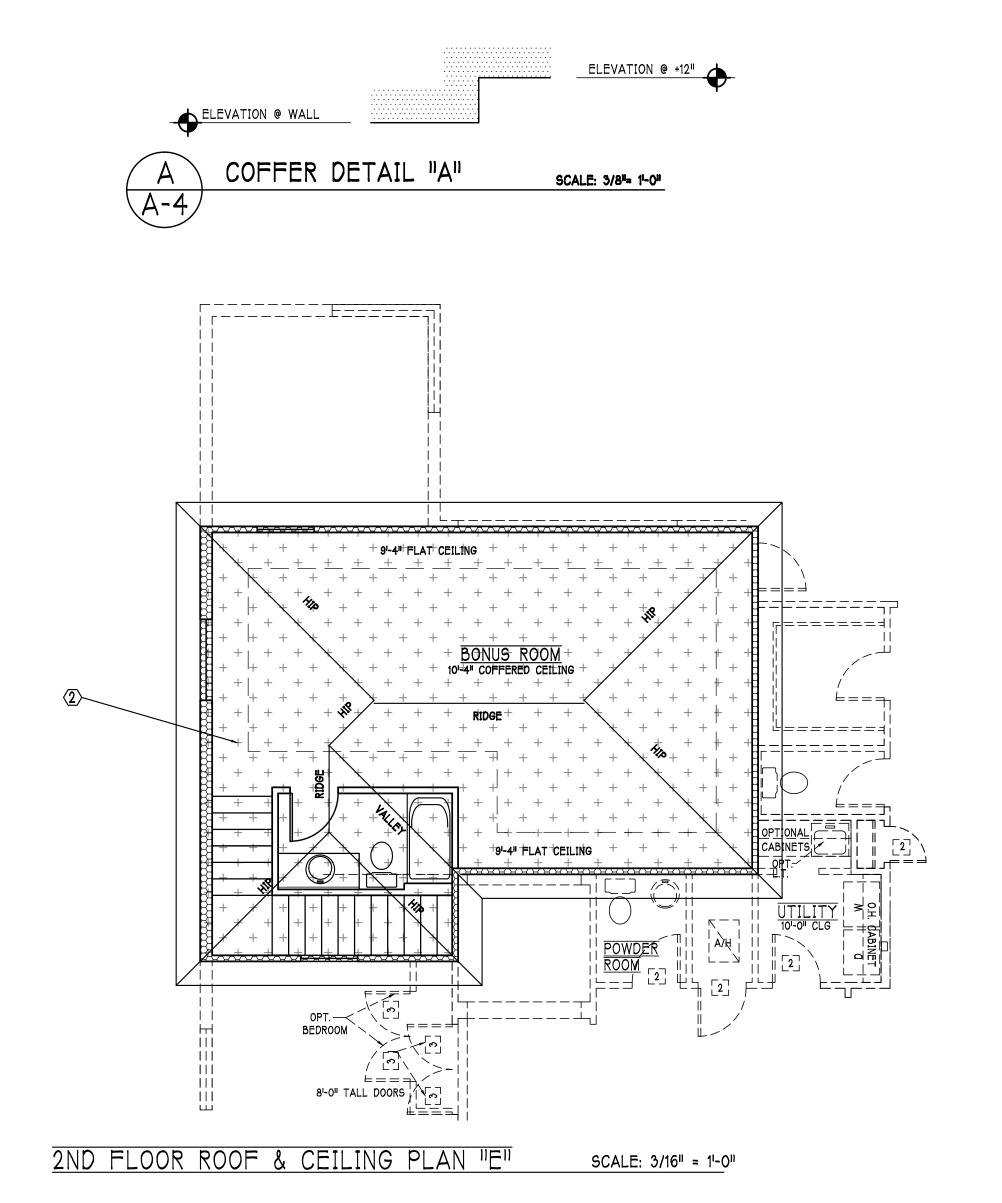

BEARING HEIGHT = BEARING @ 101-011 A.F.F. = INTERIOR BEARING • 10'-O" A.F.F. = BEARING ● 14'-0" A.F.F. BEARING ● 21-4" A.F.F.

BEARING ● 21-4" A.F.F.

		ATTIC	VENTI	LATION		
verify venting requirements with energy calculations				WITH OFF	RIDGE VENTS	
ATTIC (FBC	AREA R806)	VENTILATION (ATTIC AREA		(ATTIC A	ION REQUIRED REA 1/300 INSTALL IINIMUM AREA REQUIR	
mark	square footage	soffit vents	MIN AIR FLOW OF SOFFIT	total ventilation	off ridge vents	MIN AIR FLOW OF SOFFIT
	3026.9 SQ. FT	. 20.17 SQ. FT.	6.1%	O.R.V NOT US	SED	
2 + + +	668.6 SQ. FT.	4.4 SQ. FT.	3.2%	O.R.V NOT U	SED	
		ATTIC VENTILATION of the sq. ft. / 150			LATION CALCULATION 300 = vented sq. ft	<u>\.</u>
21-0" BASE	6'-0" BASE 1.45 SQ. FT. FREE AREA		호 XHAUST VENT SIZE FREE SQUARE FEET		38. BASE T	BASE BASE B SQ. FT. EE AREA

		ATTIC	VENTI	LATION		
verify vent	ting requirements y calculations	T		WITH OFF RI	DGE VENTS	
ATTIC (FBC F	CAREA R806)	VENTILATION (ATTIC AREA		VENTILATION (ATTIC AREA FBC R806.2 MINIM	1/300 INSTALL MUM AREA REQUIR	EMENTS)
mark	square footage	soffit vents	MIN AIR FLOW OF SOFFIT	total ventilation of	f ridge vents	MIN AIR FLOW OF SOFFIT
① 0000	3026.9 SQ. FT.	20.17 SQ. FT.		O.R.V NOT USED)	
2 + + +	668.6 SQ. FT.	4.4 SQ. FT.	3.2%	O.R.V NOT USED		
		ATTIC VENTILATI attic sq. ft. / 150	ON CALCULATION: = vented sq. ft.		ION CALCULATION O = vented aq. ft	<u>\t</u>
2-0" BASE +	6'-0" BASE	—∤ ■ 	25"	ب لنبينا	PASE	BASE
	1.45 SQ. FT.	OFF RIDGE E	EXHAUST VENT SIZE FREE SQUARE FEET	S 1 SQ. FT. TREE AREA	.38 FR	SQ. FT. EE AREA

D.R.HORTON 器

Cull Coast Draiting & Design
Phone (239) 540-1822
Fay (230) 540 7750

MODEL: 3148 F	JITUL	RESIDENCE FOR:	SPEC
BLOCK: 2B	S RESERVE 60'S	WINDWARD LANE	D.R.H #: 579000047

08-04-17

CWL

ELECTRICAL

3/16" = 1'-0"

DRAWN BY:

CHECKED BY:

REVISED:

OPT.— FLOOD LIGHT SWITCH IN FOYER

DESIGN IN ACCORDANCE W/ THE 2014 FLORIDA BUILDING CODE- 5TH EDITION

SCALE: 3/16" = 1'-0"

STILD OUT THE PRODUCTION KITCHEN
OUTDOOK KITCHEN
OFT.

A STITE TWY SWITCH
OFT.

A STITE TWY SWIT

FLOOD LIGHT SWETCH IN GREAT ROOM OPT.

WITTER

WOTE VEHICL LOCATION

FINANCE OF OWNERS

ANALYSIS OF FOR IFER

NOTE VEHICLE

TO OUT.

THE COLLISIT SUFFER

TO OUT.

THE COLLISIT SUFFER

THE COLLISION SUFFER

THE COLL

1ST FLOOR ELECTRICAL PLAN: "E"

ELECTRICAL LEGEND

ELECTRICAL METER

ELECTRICAL PANEL

0	ELECTRICAL PANEL						
·	120 V JUNCTION BOX						
ф	SINGLE RECEPTACLE OUTLET						
\blacksquare	220 V RECEPTACLE OUTLET						
₩	4-PLEX RECEPTACLE OUTLET						
Ш	DUPLEX RECEPTACLE OUTLET						
ф	1/2 SWITCHED DUPLEX OUTLET						
Ш	DUPLEX RECETACLE ● ELEV. A.F.F.						
₩T	TIMER SWITCH						
₩e⊨i	GFI SWITCH						
₽D	DIMMER SWITCH						
မှ3	3 WAY SWITCH						
↔	SINGLE POLE SWITCH						
& ⊗ ⊗ × ⊗	AC/DC SMOKE DETECTOR TO BE INTERCONNECTED ANY RESIDENT HAVING A FOSSIL-BURNING HEATER OR APPLIANCE, A FIREPLACE, OR AN ATTACHED GARAGE SHALL HAVE AN OPERATIONAL CARBON MONOXIDE ALARM INSTALLED WITHIN 10 FEET OF EACH ROOM USED FOR SLEEPING PERPOSES. PER RULE 9B-3.04.72 SD (SMOKE DETECTOR) SCD (CARBON MONOXIDE/SMOKE DETECTOR						
D	TELEPHONE OUTLET						
	TELEVISION RECEPTION OUTLET						
₽	I TEEL TIOIN NEOFI TION OOTEET						
卓	SURFACE MOUNTED CEILING LIGHT						
$ + \bigcirc$							
$_{\mathbb{P}} \Leftrightarrow \mathfrak{O}_{ \lozenge} $	SURFACE MOUNTED CEILING LIGHT						
	SURFACE MOUNTED CEILING LIGHT RECESSED LIGHT						
$\phi \phi_{\phi}$	SURFACE MOUNTED CEILING LIGHT RECESSED LIGHT WALL MTD. BRACKET LIGHT						
$\phi \phi_{\phi}$	SURFACE MOUNTED CEILING LIGHT RECESSED LIGHT WALL MTD. BRACKET LIGHT DUPLEX FLOOD LIGHT EXHAUST FAN						
$ \rightarrow \bigcirc \bigcirc \Rightarrow \bigcirc $	SURFACE MOUNTED CEILING LIGHT RECESSED LIGHT WALL MTD. BRACKET LIGHT DUPLEX FLOOD LIGHT EXHAUST FAN						
	SURFACE MOUNTED CEILING LIGHT RECESSED LIGHT WALL MTD. BRACKET LIGHT DUPLEX FLOOD LIGHT EXHAUST FAN TRACK MTD. LIGHTS						
	SURFACE MOUNTED CEILING LIGHT RECESSED LIGHT WALL MTD. BRACKET LIGHT DUPLEX FLOOD LIGHT EXHAUST FAN TRACK MTD. LIGHTS A/C DISCONNECT						
	SURFACE MOUNTED CEILING LIGHT RECESSED LIGHT WALL MTD. BRACKET LIGHT DUPLEX FLOOD LIGHT EXHAUST FAN TRACK MTD. LIGHTS A/C DISCONNECT PUSH BUTTON						
	SURFACE MOUNTED CEILING LIGHT RECESSED LIGHT WALL MTD. BRACKET LIGHT DUPLEX FLOOD LIGHT EXHAUST FAN TRACK MTD. LIGHTS A/C DISCONNECT PUSH BUTTON DB= DOOR BELL						

Electrical Notes

Install Arc-Fault circuit-Interrupters & Tamper-Resistant Receptacles shall be installed in dwelling unit. per NEC 210.12 & 406.11


All electrical equipment to be set at or above base flood elevation.

All outlets in wet areas and all exterior outlets to be GFI's


Install Phone & T.V per contract .

Install Phone & T.V per contract .

INSTALL ALL ELECTRICAL PER NEC 2011

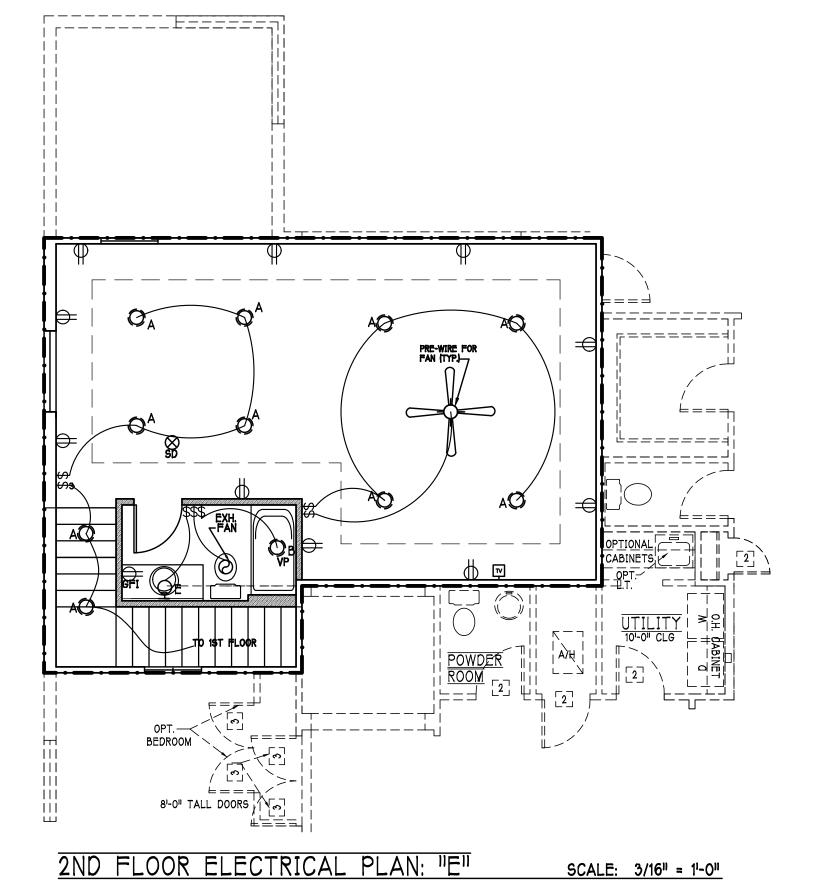

200	Amp Servi	ce	
TAG	QUANTITY	PRODUCT	PRODUCT #
Α	(29)	Recessed Cans	
В	(3)	Vapors	
C	(1)	Pendant/Nook	P4070-09
D	(X)	10 ¹¹ Mushrooms	P3410-30
E	(1)	24" Avalon 3 Lt	P3268-09
F	(2)	36" Avalon 4 Lt	P3269-09
G	(X)	NOT USED	NOT USED
H	(3)	Coach Lights	35003EB
J	(X)	Coach Lights	P5683-30
K	(1)	J BOX	
L	(2)	41 Fluorescent	P7186-30
M	(2)	21 Fluorescent	P7183-30
N	(1)	5lt Chandelier	P4068-09
0	(X)	3 Lt Avalon	P3773-09
Р	(3)	Pendant Light	P-5068-09

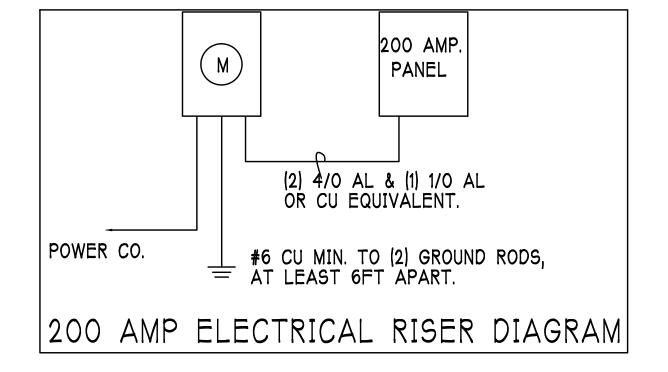

© Coast Drafting & Design (239) 540-1822 (239) 540-7759

148 \sim SS: 14834 WINDWARD LAN

08-04-17

CWL

AS NOTED

1/4'' = 1'-0''

DRAWN BY:

CHECKED BY:

REVISED:

GENERAL ROOF ASSEMBLY ROOF SHEATHING

1. THE CONTRACTOR SHALL VERIFY ALL CONDITIONS AND DIMENSIONS AT THE JOB SITE PRIOR TO COMMENCING WORK, THE CONTRACTOR SHALL

REPORT ALL DISCREPANCIES BETWEEN THE DRAWINGS AND EXISTING CONDITIONS TO THE DESIGNER PRIOR TO COMMENCING WORK. THE CONTRACTOR SHALL SUPPLY, LOCATE AND BUILD INTO THE WORK ALL INSERTS, ANCHORS, ANGLES, PLATES, OPENINGS, SLEEVES, HANGERS, SLAB DEPRESSIONS AND PITCHES AS MAY BE REQUIRED TO

ALL DETAILS AND SECTIONS SHOWN ON THE DRAWINGS ARE INTENDED TO BE TYPICAL AND SHALL BE CONSTRUCTED TO APPLY TO ANY SIMILAR SITUATION ELSEWHERE IN THE WORK EXCEPT WHERE A DIFFERENT

SUBSURFACE SOIL CONDITION INFORMATION IS NOT AVAILABLE FOUNDATIONS ARE DESIGNED FOR A SOIL BEARING CAPACITY OF 2,000 PSF. THE CONTRACTOR SHALL REPORT ANY DIFFERING CONDITIONS TO THE DESIGNER PRIOR TO COMMENCING WORK.

RESIDENTIAL SPECIFICATIONS

GENERAL NOTES

ATTACH AND ACCOMMODATE OTHER WORK.

STRUCTURAL DRAWINGS SHALL BE USED IN CONJUNCTION WITH JOB SPECIFICATION AND HOUSE PLANS, MECHANICAL, ELECTRICAL, PLUMBING, AND SITE DRAWINGS, CONSULT THESE DRAWINGS FOR SLEEVES, DEPRESSIONS AND OTHER DETAILS NOT SHOWN ON STRUCTURAL DRAWINGS.

ALL SPECIFIED FASTENERS MAY ONLY BE SUBSTITUTED IF APPROVED BY THE ENGINEER IN WRITING, THE INSTALLATION OF THE FASTENERS SHALL BE IN ACCORDANCE WITH THE MANUFACTURER'S SPECIFICATIONS SIMPSON FASTENERS SPECIFIED MAY BE SUBSTITUTED WITH THE SAME QUANTITY AND EQUIVALENT STRENGTH PRODUCT.

TREATED WOOD REQUIREMENTS:-ALL WOOD EXPOSED TO WEATHER SHALL BE PROTECTED, PRESSURE TREATED, OR NATURALLY RESISTANT TO DECAY. ALL WOOD TOUCHING MASONRY OR CONCRETE SHALL BE ISOLATED, OR PRESSURE TREATED.

THE STRUCTURE IS DESIGNED TO BE SELF SUPPORTING AND STABLE AFTER THE BUILDING IS COMPLETE. IT IS THE CONTRACTOR'S SOLE RESPONSIBILITY TO DETERMINE ERECTION PROCEDURES AND SEQUENCES TO ENSURE SAFETY OF THE BUILDING AND ITS COMPONENTS DURING ERECTION. THIS INCLUDES THE NECESSARY SHORING, SHEETING, TEMPORARY BRACING, GUYS, OR TIE DOWNS.

CEILING DRYWALL INSTALLED WITHIN THE HOUSE TO TRUSSES SPACED 24" O.C. SHALL BE 5/8" DRYWALL OR 1/2" SAG RESISTANT PER SEC. 702.3.5

1X4 STRIPPING • 16" O.C. FASTENED WITH 2-8d NAILS TO EACH TRUSS. 5/8" EXTERIOR GYPBOARD CEILING FASTENED WITH 8d NAILS OR 1-5/8" DRYWALL SCREWS • 6" oc EDGE AND FIELD.

SHALL BE APA RATED SHEATHING, EXPOSURE 1, SPAN RATING 24/16 OR BETTER. INSTALL PANELS WITH LONG

DIMENSION PLACED PERPENDICULAR TO TRUSSES. A 1/8" SPACE BETWEEN ADJACENT SHEETS SHALL BE MAINTAINED. INSTALL "H" CLIPS AT UNSUPPORTED PANEL EDGES.

FLASHING
FLASHING SHALL BE ALUMINUM, ALUMINUM ZINC COATED STEEL .0179 INCHES
THICK, 26 GAGE AZ50 ALUM ZINC, OR GALVANIZED STEEL .0179 INCHES THICK, 26 GAGE
ZINC COATED G90, FLASHING SHALL BE INSTALLED IN ACCORDANCE WITH THE ZIP
SYSTEM ROOF SHEATHING MANUFACTURERS PUBLISHED REQUIREMENTS. ALL FLASHING AND
INSTALLATION SHALL CONFORM TO SECTION R905.2.8 (1 TO 5).

DRIP EDGE
DRIP EDGE SHALL BE PROVIDED AT ALL EAVES AND GABLES OF SHINGLE ROOFS,
LAPPED A MINIMUM OF 3" • JOINTS. THE OUTSIDE EDGE SHALL EXTEND A MINIMUM OF 1/2"
BELOW SHEATHING AND THE INSIDE EDGE SHALL EXTEND BACK A MINIMUM OF 2". DRIP
EDGE SHALL BE FASTENED AT NO MORE THAN 4" CENTERS. THERE SHALL BE A
MINIMUM OF 4" WIDTH OF ROOF CEMENT INSTALLED OVER THE DRIP EDGE FLANGE.

CLAY AND CONCRETE TILE ROOF SPECS

MARKING: EACH ROOF TILE SHALL HAVE A PERMANENT

INCLUDE BUT NOT BE LIMITED TO THE FOLLOWING:

FLOOR SHEATHING AT 2ND FLOOR

SPAN RATING 48/24 OR BETTER, GLUED AND NAILED

LAYER APPLICATION UNDER TILE ROOF.

WITH THE PROVISIONS OF R905.3 F.B.C.

MANUFACTURER'S IDENTIFICATION MARK.

2. ATTACHMENT SYSTEM NECESSÁRY TO

A. AMOUNT AND PLACEMENT OF MORTAR

B. AMOUNT AND PLACEMENT OF ADHESIVE,

1. TILE PLACEMENT AND SPACING,

3. UNDERLAYMENT 4. SLOPE REQUIREMENT.

ROOF SHEATHING PER SCHEDULE 2/S-3 — AND PER NOTES IN TABLE 2 ON A-6

EMBEDDED STRAP AT EACH TRUSS PER ROOF FRAMING PLAN.

PER NOTES IN TABLE 2 ON A-6

SHEATHING PER 2/S-3 —

SHALL MEET R703.1.3 SEE TABLE 3 ON S-3

PROVIDE VENTILATION ——PER R806.1

DECORATIVE CEMENT FINISH PER ASTMC-926 ON PAPER BACKED METAL LATHE ON WALL

STRAP @ 32" O.C. AT
BOTTOM OF STUD TO TRUSS
WITH MSTA24 OR WHERE STUD
DOES NOT ALIGN WITH FLOOR TRUSS

USE MSTAM36 TO MASONRY WALL
SEE DETAIL 10/9-3

NOTCH END OF TRUSS FOR 2x4 BAND BOARD

HOLD TRUSS BACK 3/4" FOR — PLYWOOD AND STUCCO.

8"X8" CONTINUOUS -BOND BEAM W/ 1 #5, GROUT SOLID

DECORATIVE CEMENT FINISH PER ASTMC-926

SLOPE TO EXTERIOR -

PRECAST CONCRETE SILL

CONCRETE FOOTING SEE

FOUNDATION PLAN FOR

TYPICAL WALL SECTION

SIZE AND REINFORCING.

SCALE: N.T.S.

SEE STRUCTURAL-

WOOD TRUSSES ● 24" O.C. (TYPICAL) ___ DESIGNED BY DELEGATED TRUSS ENGINEER.

COMPLY WITH CURRENT WIND CODE.

INSTALL PEEL AND STICK UNDERLAYMENT APPROVED FOR SINGLE

THE INSTALLATION OF CLAY AND CONCRETE TILE SHALL COMPLY

APPLICATION SPECIFICATIONS: THE TILE MANUFACTURER'S WRITTEN

APPLICATION SPECIFICATIONS SHALL BE AVAILABLE AND SHALL

C. TYPE, NUMBER, SIZE, AND LENGTH OF FASTENERS AND CLIPS.

A.P.A. RATED STURDI-FLOOR, EXPOSURE 1, TONGUE & GROOVE EDGES

-R=30 FIBERGLASS

INSUL.

DRYWALL CEILING — PER NOTE 9 IN TABLE 1 ON A-6

STRAP ● 16" O.C.

DRYWALL CEILING — PER NOTE 9 IN TABLE 1 ON A-6

-PRECAST LINTEL SEE FRAMING PLAN

WINDOW BUCKS SEE 13/S-3 -1X4 P.T. BUCK W/ BED

OF CONTINOUS CAULK

W/ INSULATION (MIN. R4.1)

- WINDOW, SEE SCHEDULE AND PLAN.

4" CONC. SLAB ON 6 MIL.

WITH "BORA CARE".

ISQUEEN VAPOR BARRIER ON

MECHANIALLY COMPACTED FILL

PROVIDE TERMITE TREATMENT

---- 1/2" DRYWALL W/ TEXTURED WALLS.

--- DOUBLE TOP PLATE WITH SPH4

-HEADER, SEE FRAMING PLAN

- 1/2" DRYWALL W/ TEXT. FINISH

- WINDOW, SEE SCHEDULE AND PLAN.

WOOD STUDS PER FRAMING PLAN

---3/4" PLYWOOD FLOORING ON FLOOR TRUSSES, SEE TABLE 5 ON A-6

FASTENERS
Fasteners for asphalt shingles shall comply with ASTM F 1667, and shall be made of galvanized steel, stainless steel or aluminum with a minimum shank size of 12 gage (0.105 inches) with a minimum 3/8 inch diameter head and shall be of a length to penetrate the sheathing.

The nail component of plastic cap nails shall meet or exceed the requirements of ASTM A 641, Class I, or equal, and shall be corrosion resistant by coating electro galvanization, mechanical galvanization, hot dipped galvanization or shall be made of stainless steel, non ferrous metal.

ASPHALT SHINGLE ROOF SPEC'S

SHINGLES

15# felt shall be installed under asphalt shingles. All asphalt shingles shall have self sealing strips or be interlocking and comply with ASTM D 225 or D3462, and shall be secured to the roof with no less than 6 fasteners per shingle strip, or a minimum of 2 fasteners per shingle tab. And shall in no case be fastened with less fasteners than that required by the manufacture. Installation shall comply with the manufactures requirements for installation in the given Florida wind zone, as determined by ASTM D 3161.

GABLE WALL EXTERIOR EXTERIOR PLYWOOD -W/ RADIANT BARRIER ON ATTIC SIDE STUD WALL OR TRUSS -RADIANT BARRIER ∠TOP CHORD GLUED TO PLYWOOD EXTERIOR RADIANT BARRIER: SCALE: N.T.S. NOTE: EXTERIOR WALLS ADJACENT TO ATTIC SPACE, INCLUDING KNEEWALLS AND GABLE END WALLS, MUST HAVE RADIANT BARRIER AND HOUSE WRAP.

VALL SHEATHING -WITH HOUSE WRAP OR ZIP SYSTEM WALL SHEATHING

PAPER BACK METAL LATH -

R310.1.1 MINIMUM OPENING AREA:- ALL EMERGENCY ESCAPE AND RESCUE OPENINGS SHALL HAVE A MINIMUM NET CLEAR OPENING OF 5.7 SQAURE FEET (0.530 m²).

EXCEPTION:- GRADE FLOOR OPENINGS SHALL HAVE A MINIMUM NET CLEAR OPENING OF 5 SQUARE FEET (0.465 m2).

R310.1.2 MINIMUM OPENING HEIGHT:- THE MINIMUM NET CLEAR OPENING


HEIGHT SHALL BE 24 INCHES (610mm). R310.1.3 MINIMUM OPENING WIDTH:- THE MINIMUM NET CLEAR OPENING

WIDTH SHALL BE 20 INCHES (508mm).


R310.1.4 OPERATIONAL CONSTRAINTS:- EMERGENCY ESCAPE AND RESCUE OPENINGS SHALL BE OPERATIONAL FROM THE INSIDE OF THE ROOM WITHOUT THE USE OF KEYS OR TOOLS.

R310.2 WINDOW WELLS:- THE MINIMUM HORIZONTAL AREA OF THE WINDOW WELL SHALL BE 9 SQUARE FEET (0.84 m2), WITH A MINIMUM HORIZONTAL PROJECTION AND WIDTH OF 36 INCHES (914mm). THE AREA OF THE WINDOW WELL SHALL ALLOW THE EMERGENCY ESCAPE AND RESCUE OPENING TO BE FULLY OPENED.

MINIMUM EGRESS WINDOW DETAIL

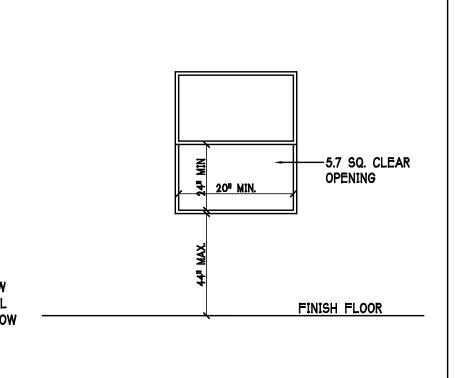



DESIGN IN ACCORDANCE W/ THE 2014 FLORIDA BUILDING CODE- 5TH EDITION

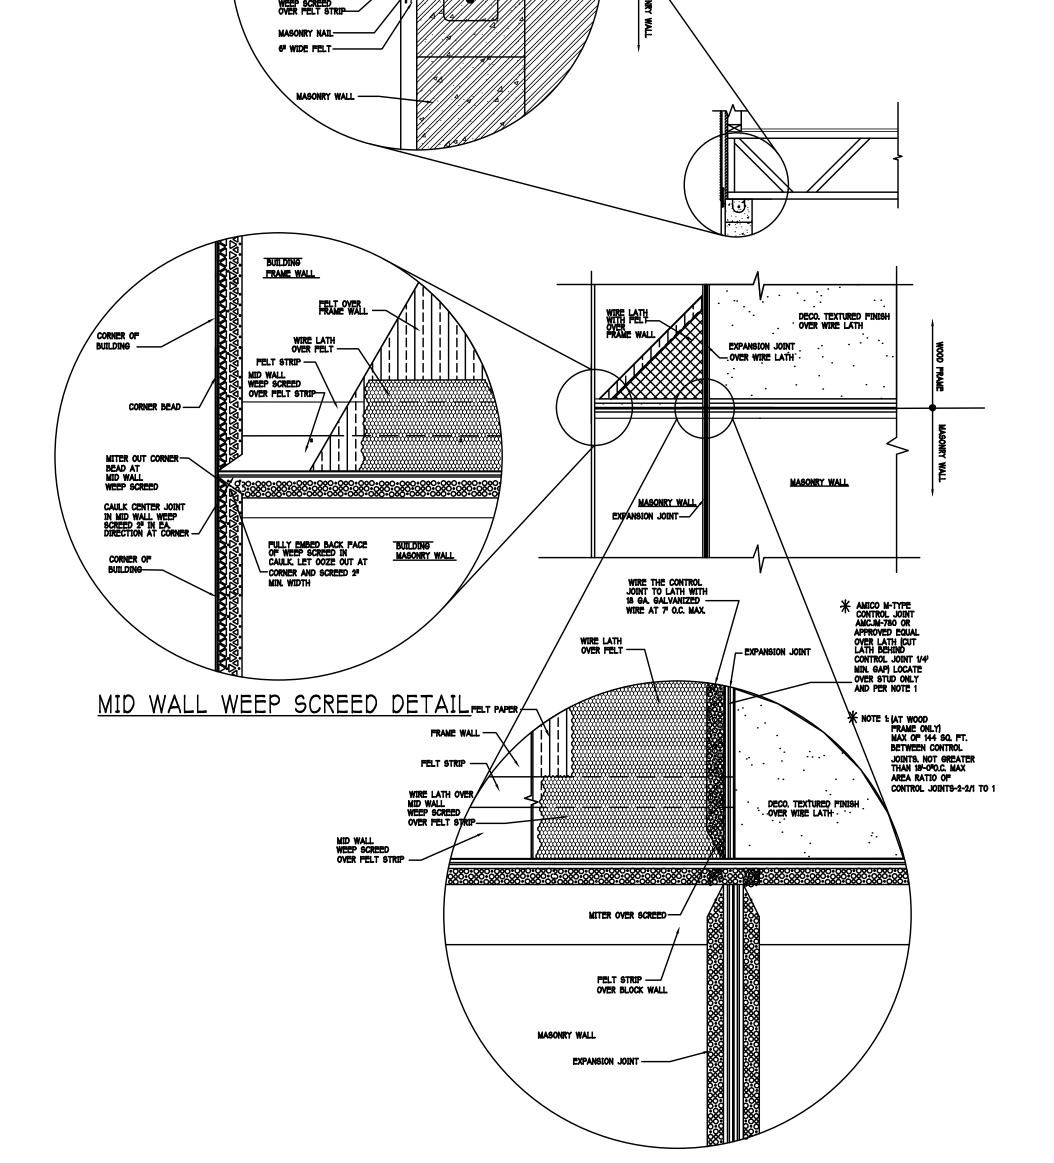


WEEP SCREED DETAIL

INSTALL AT ALL EXTERIOR WALL LOCATIONS WHERE WOOD STUD FRAMING IS ABOVE MASONRY WALLS.

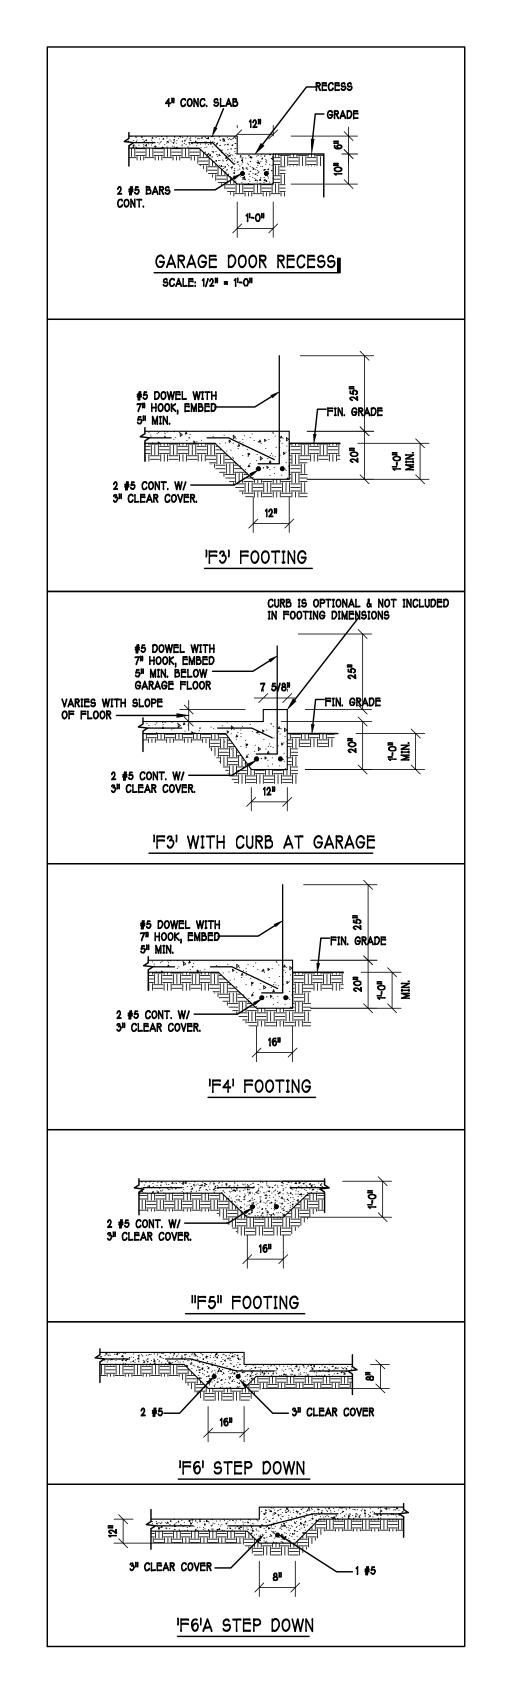

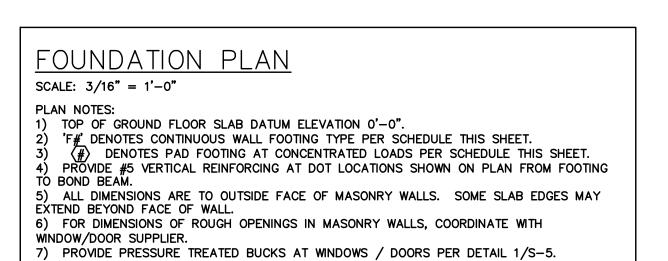

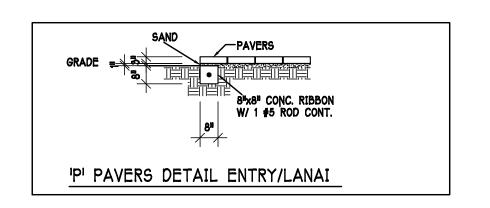

	PAD FOOTING SCHEDULE										
USED	TYPE	LENGTH	WIDTH	DEPTH	BOTTO		REMARKS				
	_				LONG WAY	SHORT WAY					
X	$\langle A \rangle$	2'-6"	2'-6"	1'-0"	3-#5	3-#5	_				
X	(B)	3'-0"	3'-0"	1'-0"	4- <i>#</i> 5	4- <i>#</i> 5	ı				
X	0	3'-6"	3'-6"	1'-0"	4-#5	4-#5	ı				
	0	4'-0"	4'-0"	1'-0"	5-#5	5-#5	ı				
X	(E)	2'-6"	5'-0"	1'-0"	3-#5	6-#5	_				
	F	2'-6"	4'-0"	1'-0"	3-#5	5-#5	_				
							·				

							_
		WALL					
USED	TYPE	LENGTH	WIDTH	DEPTH	BOTTOM REINFORCING	SHAPE	
	F1	CONT.	1'-4"	0'-8"	2-#5	Щ	
	F2	CONT.	1'-8"	0'-10"	2-#5	坦	ADD CURB TO
X	F3	CONT.	1'-0"	1'-8"	2-#5	ļ	GARAGE, SEE
X	F4	CONT.	1'-4"	1'-8"	2-#5	P	DETAIL
X	F5	CONT.	1'-4"	1'-0"	2-#5	1	
X	F6	CONT.	1'-4"	1'-0"	2-#5	1	
X	F6A	CONT.	8"	8"	1-#5	Ţ	
	TE	CONT.	0'-8"	0'-8"	1-#5	1	

