




**A** WALL SECTION  
SCALE: 1/2" = 1'-0"

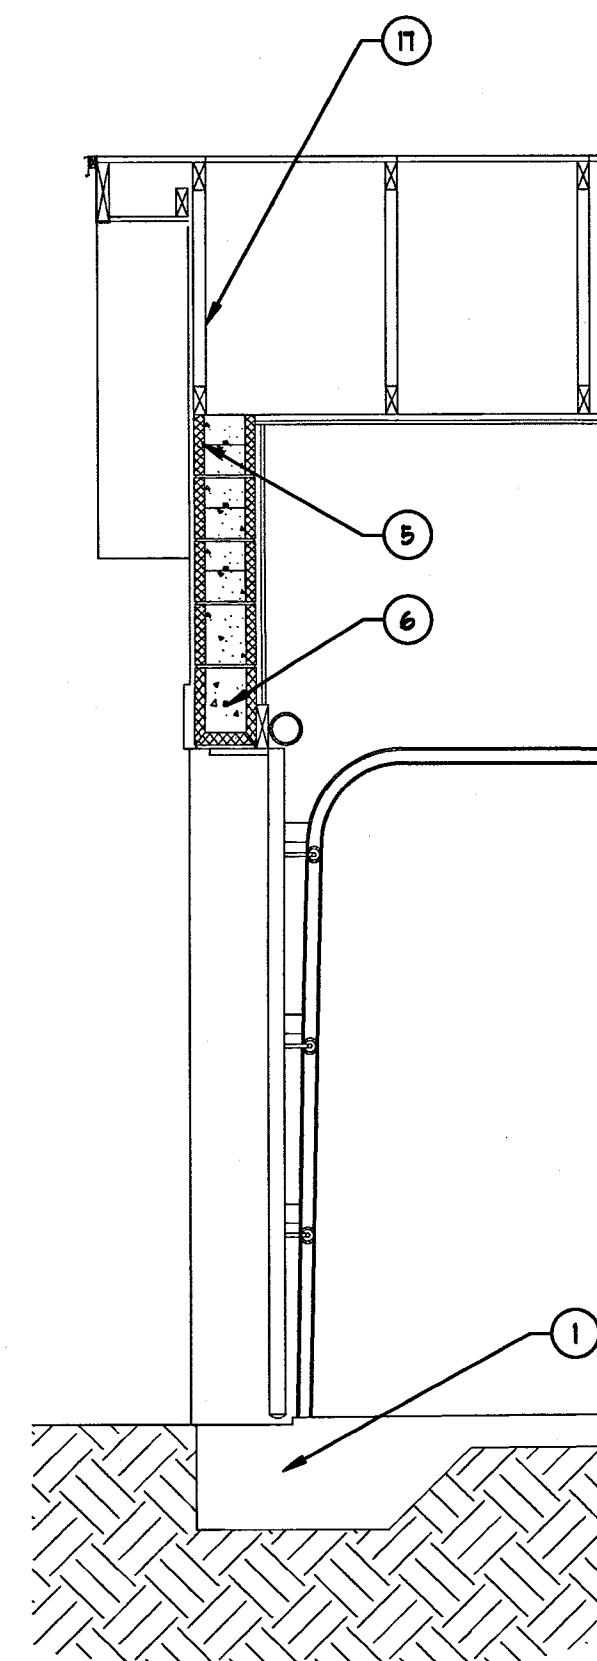


**B** WALL SECTION  
SCALE: 1/2" = 1'-0"

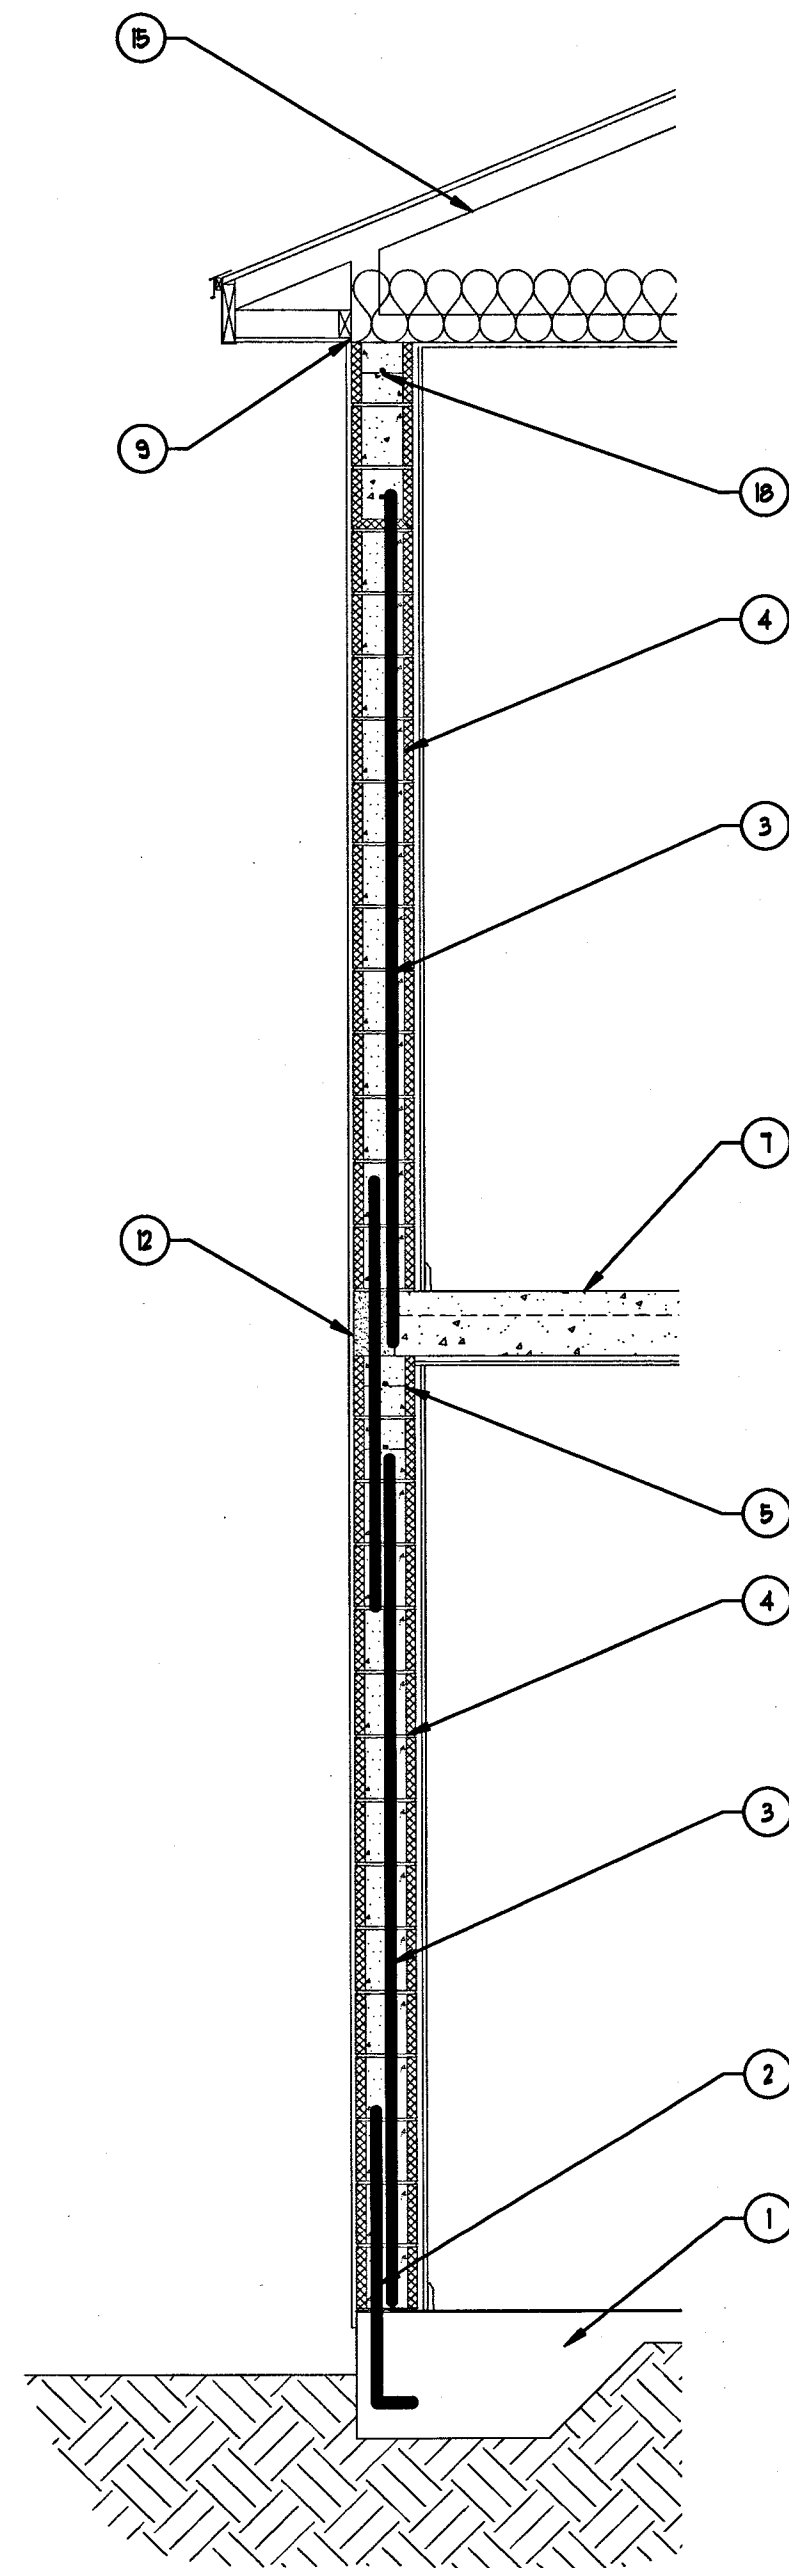


**C** WALL SECTION  
SCALE: 1/2" = 1'-0"

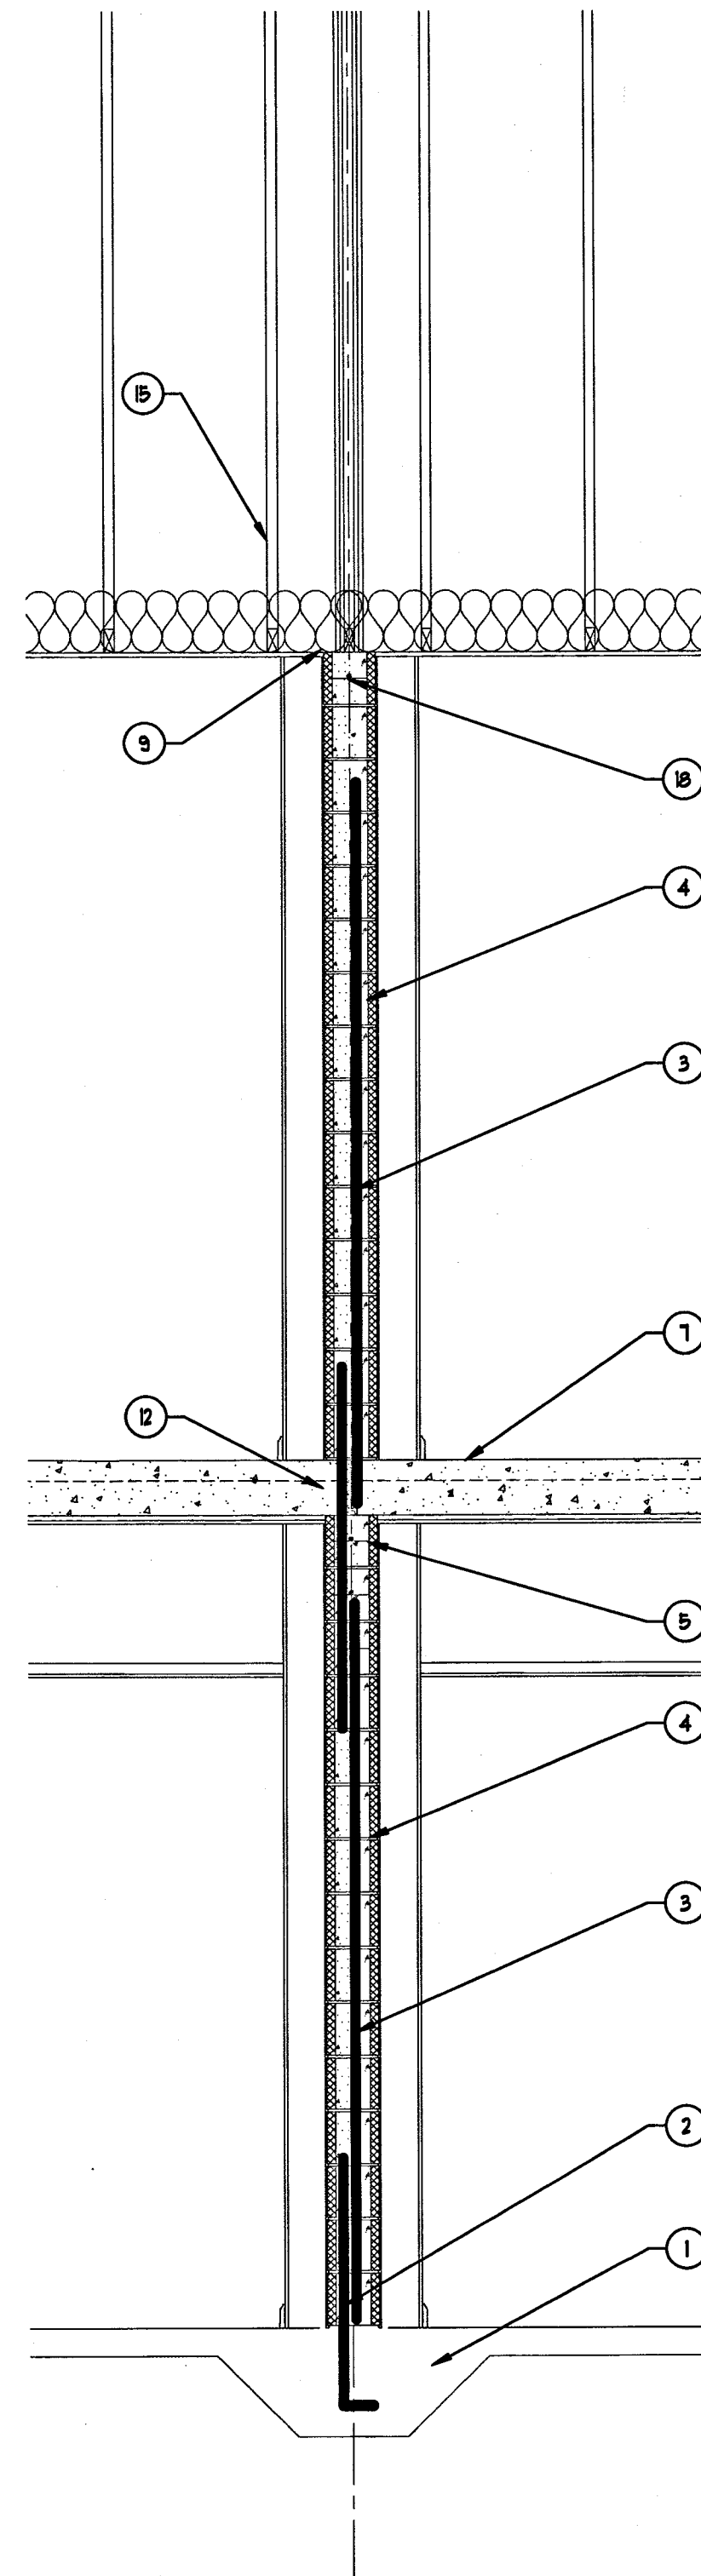

**D** WALL SECTION  
SCALE: 1/2" = 1'-0"

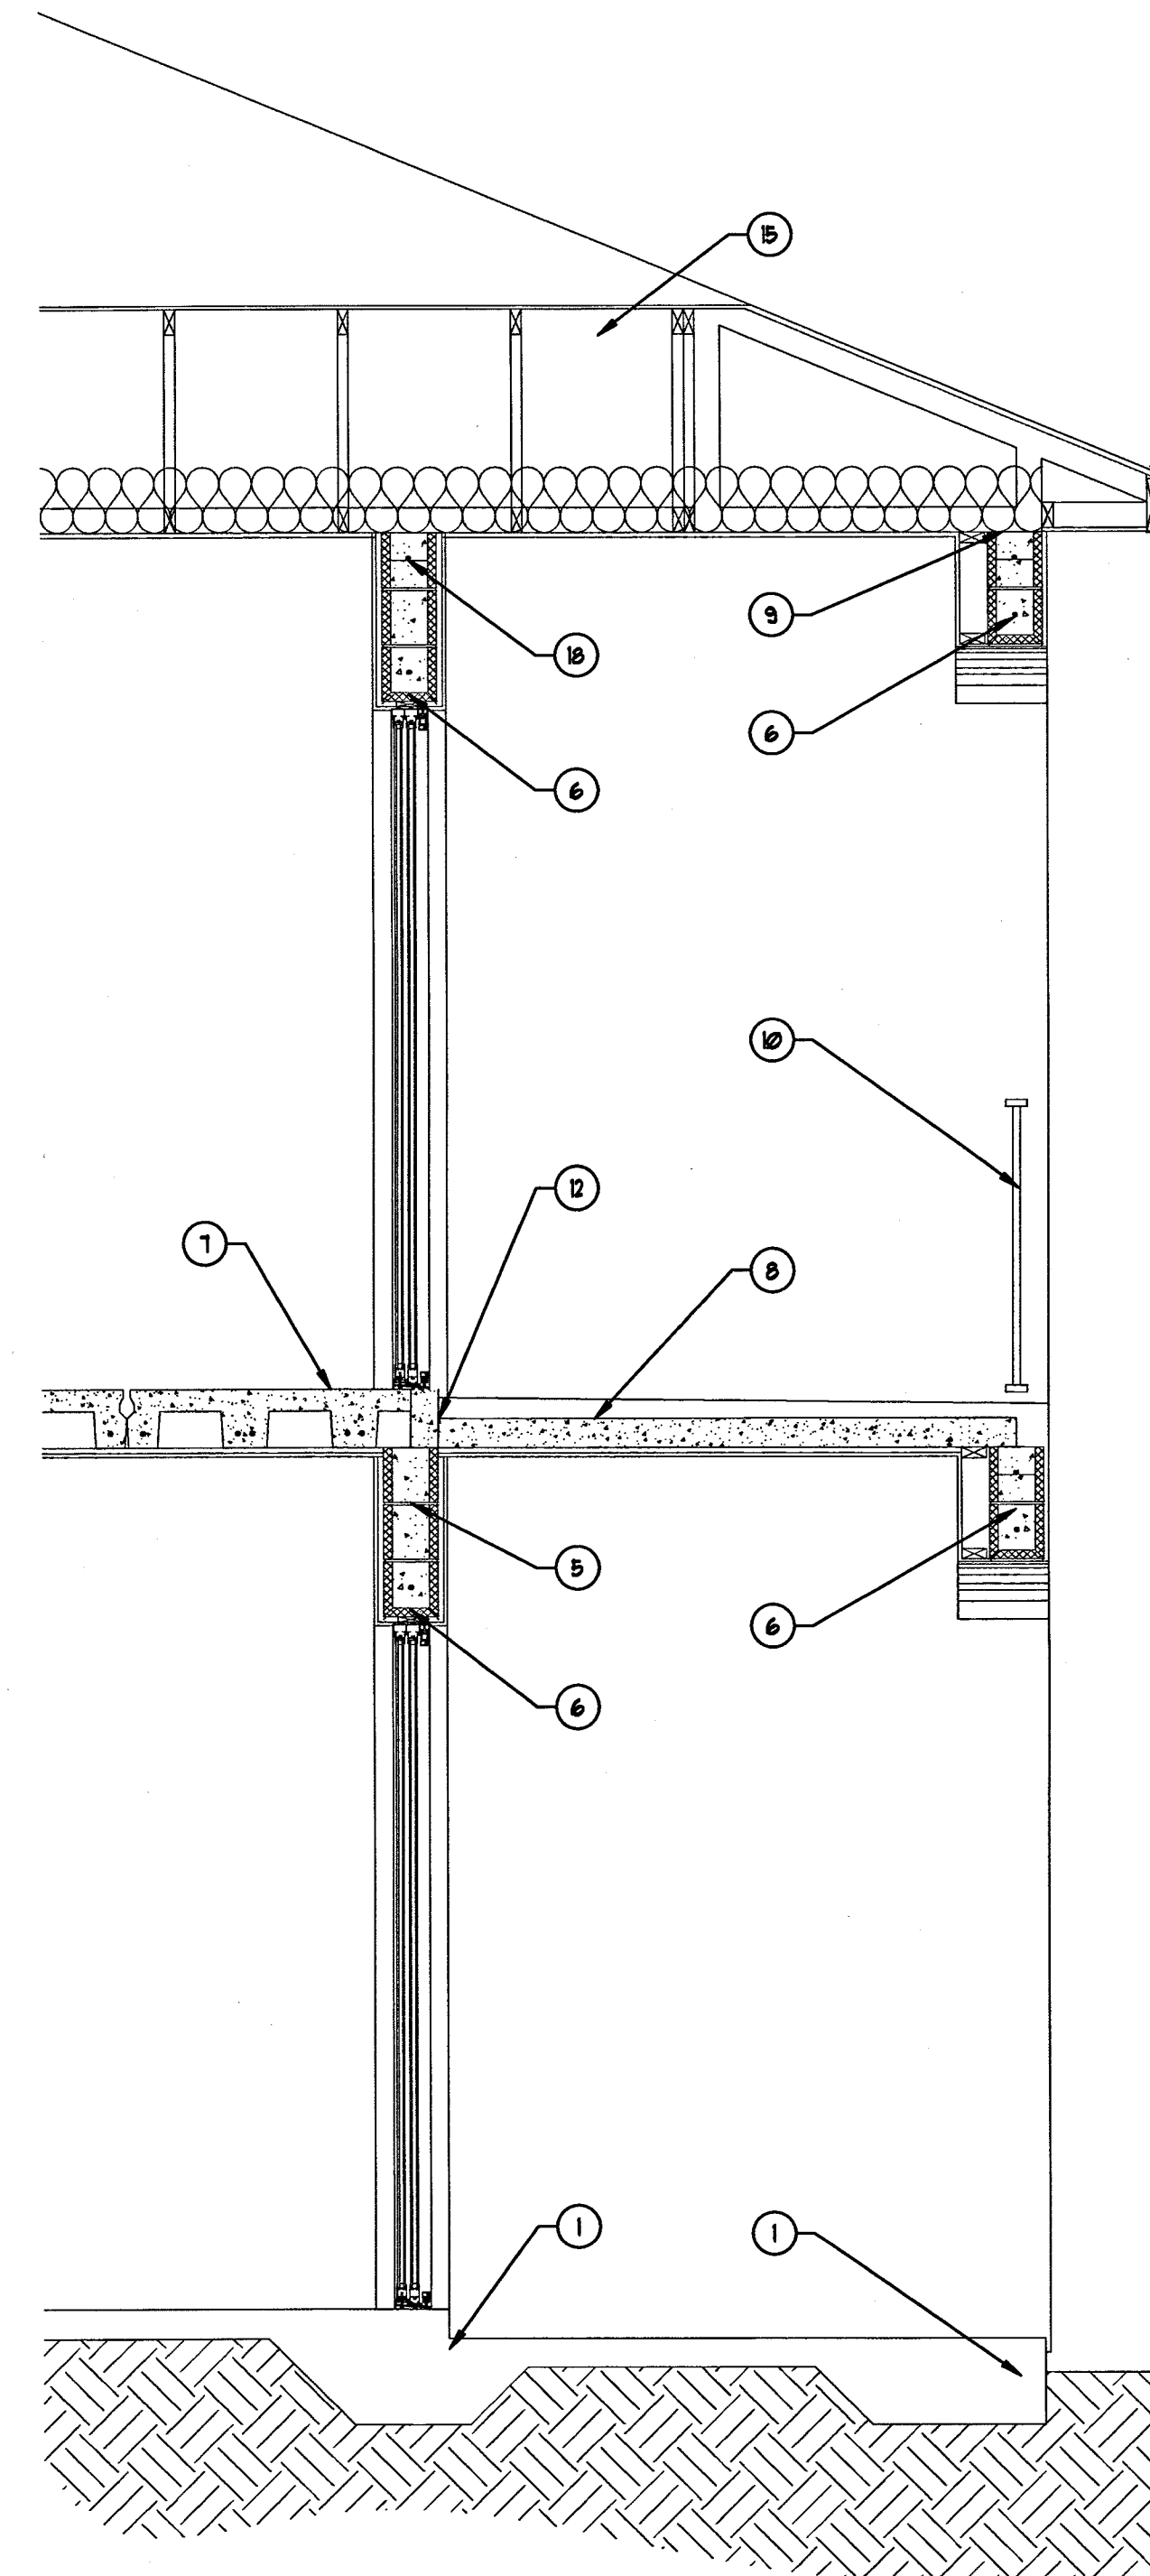

**E** WALL SECTION  
SCALE: 1/2" = 1'-0"

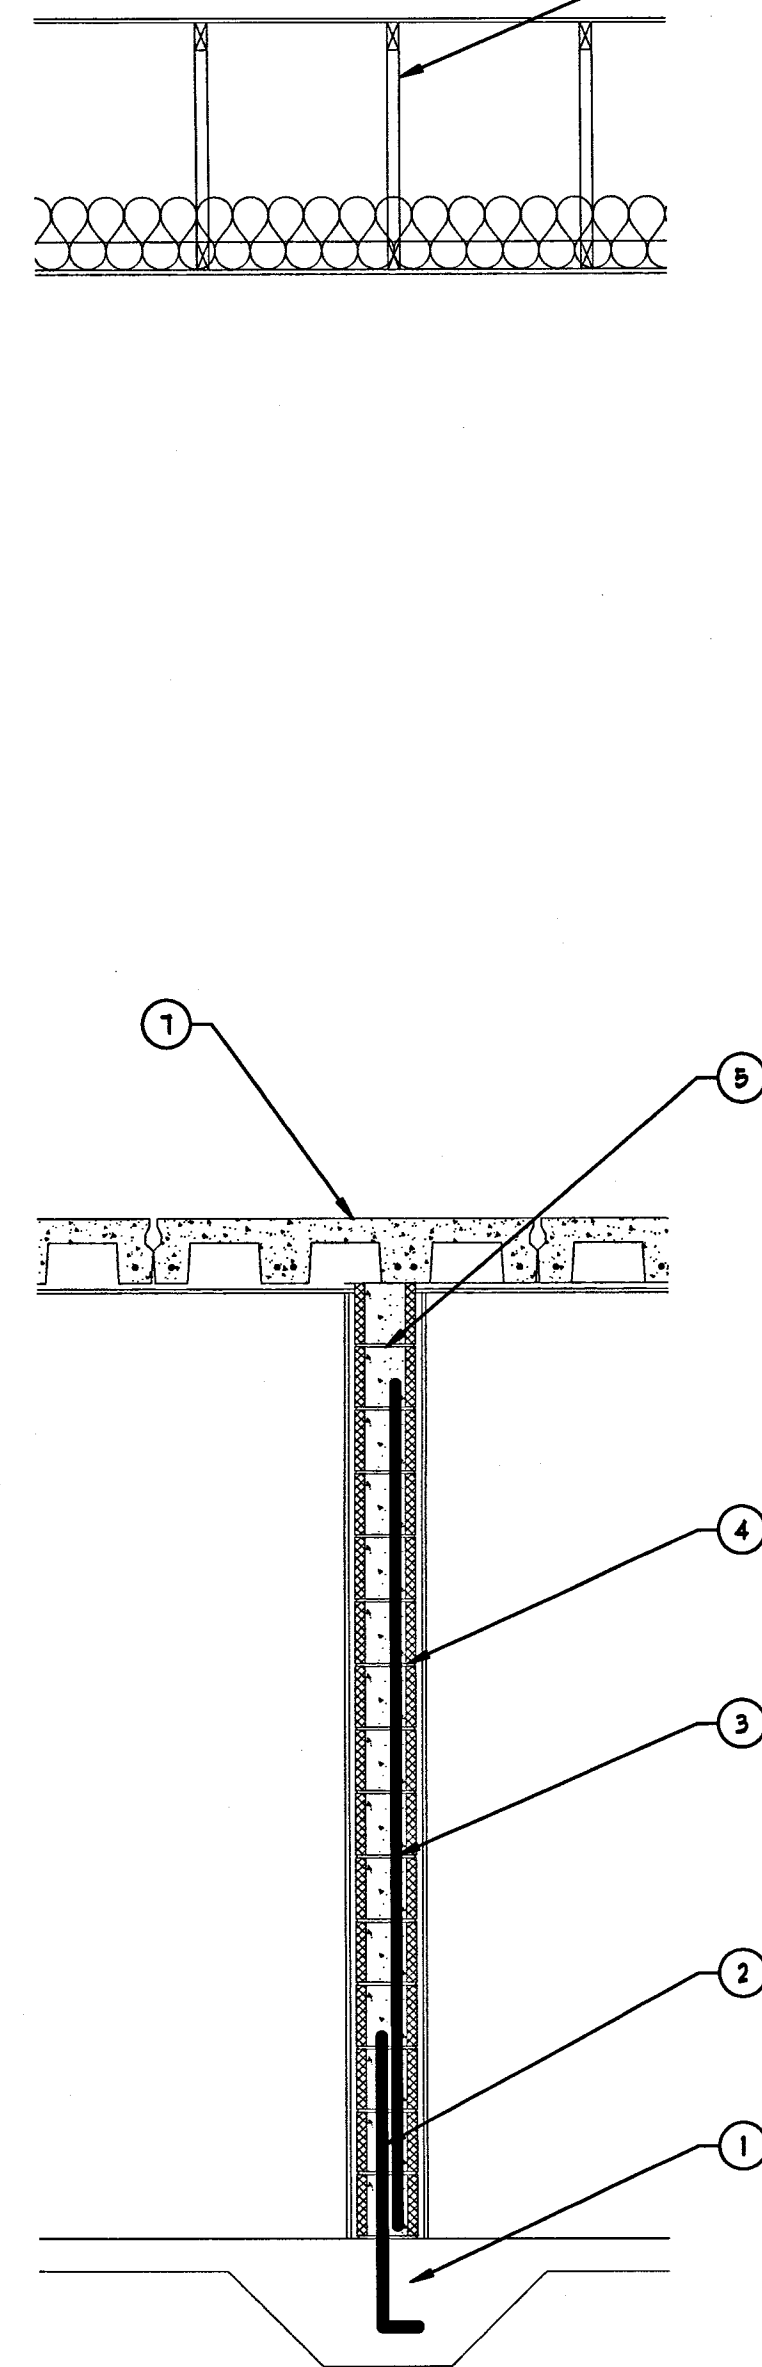

**F** WALL SECTION  
SCALE: 1/2" = 1'-0"

**KEY NOTES**

- SEE FOUNDATION PLAN FOR FOOTING DETAILS AND ARCHITECTURAL PLANS FOR ELEVATIONS
- 5 DOUEL W/ STANDARD HOOK AND MIN 25" LAP SPLICE AT LOCATIONS OF REINFORCED FILLED CELLS ABOVE
- 5 CONT VERT BAR IN GROUT FILLED CELL - SEE FLOOR PLANS S2.0 AND S4.0 FOR LOCATIONS.
- 8"x8"x16" CMU WALL - SEE ARCHITECTURAL DRAWINGS FOR REQUIRED FINISHES
- DOUBLE 8" K.O. BLOCK TIE BEAM W/ (2) 5 HOR CONTINUOUS BAR ALL GROUT FILLED.
- PRECAST CONCRETE LINTEL ASSEMBLY AS PER FLOOR PLANS IN SHEETS S2.0 AND S4.0

- 8" QUAD TEE PRECAST CONCRETE FLOOR SYSTEM AS PER FRAMING PLANS IN SHEET S3.0
- 4" PRECAST CONCRETE FLOOR SYSTEM AS PER FRAMING PLANS IN SHEET S3.0
- CONNECT TRUSS USING DOUBLE 2"x4"x16" LONG BLOCK AT 4'-0" O.C. W/ 3-1/2" BLOCK TO BLOCK AND 3-1/2" BLOCK TO TRUSS. CONNECT BLOCKING TO TIE BEAM W/ SIMPSON RBC CLIP W/ 3-1/4"x2-1/4" TITENS TO TIE BEAM AND 6-1/2" NAILS TO WOOD BLOCK AT 4'-0" O.C.
- SEE ARCHITECTURAL DRAWINGS AND STRUCTURAL SPECIFICATIONS FOR REQUIRED HANDRAILS AND GUARDRAILS.
- WALL FINISH AS PER ARCHITECTURAL DRAWINGS.

- 5 HORIZONTAL BAR WITH MIN 2-1/2" COVER - FILL EDGES W/ CONCRETE
- PRECAST CONCRETE SILL UNDER WINDOWS - PROVIDE 5 CONT HOR BAR IN 8" K.O. BLOCK ALL GROUT FILLED CELL BELOW SILL
- PROVIDE NON-BEARING PARTITION FRAMING FOR CHASE OPENING
- PRE-MANUFACTURED WOOD ROOF TRUSSES AS PER SHEET S5.0. SEE STRUCTURAL NOTES IN SDI FOR ROOF SHEATHING REQUIREMENTS.
- SEE SECTION I IN SHEET S3.0 FOR REQUIRED AWNING FRAMING CONSTRUCTION.
- SEE STRUCTURAL DETAILS FOR GABLE END DETAILS.

- SINGLE 8" K.O. BLOCK TIE BEAM W/ (1) 5 HOR CONTINUOUS BAR ALL GROUT FILLED.

07-28-15 Master Permit Set



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Safety Harbor, FL 34695  
813-644-8239

JOB NO: 02712032 PROJ MGR: LCC  
DRAWN: LCC CHECKED:


SECTIONS  
STRUCTURAL

**S6.0**

**Sorrento**  
4-Unit Condominium Building  
Bonita Beach Rd.  
Bonita Beach, Florida 34135

**DR-HORTON**  
America's Builder  
10541 Six Mile Cypress Pkwy  
Fort Myers, FL 33966

**INTEGRAL**  
ENGINEERING, INC.  
AUG 05 2015  
LUIS C. CORREA, P.E., S.E.  
#89018

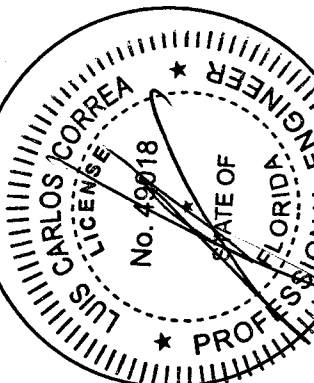

ISSUE DATE:  
REVISIONS

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